AN ENCROACHMENT PERMIT IS REQUIRED BEFORE ANY WORK BEGIN IN/OR NEAR THE STATE RIGHT OF WAY.

ALL WORK WITHIN THE STATE RIGHT OF WAY SHALL COMFORM TO THE LATEST STATE STANDARD PLANS AND SPECIFICATIONS OR AS DIRECTED BY THE STATE'S REPRESENTATIVE NO EQUIPMENT OR MATERIALS MAY BE STORED ON THE STATE

RIGHT OF W

ALL DISTURBED AREAS IN THE STATE RIGHT OF WAY MUST BE TREATED FOR EROSION CONTROL (HYDROSEEDING OR EQUIVALENT, OR AS DIRECTED BY THE STATE'S REPRESENTATIVE). THE RESPONSIBILITY FOR MAINTAINING EROSION CONTROL RELEASED UNTIL THE SEEDING IS WELL ESTABLISHED. THE CONTRACTOR WILL BE RESPONSIBLE FOR THE COST OF CALTRANS CLEANING ANY DRAINAGE STRUCTURES AND CHANNELS WHICH HAVE BECOME CLUTTERED WITH DEBRIS AND OR SILT AS A RESULT OF. OR

CAUSED BY, THE CONSTRUCTION PROJECT. ACCESS CONTROL ON THE FREEWAY WILL BE MAINTAINED A FENCED OFF WITH NO ACCESS TO WORK AREA FROM FREEWAY).

NO FREEWAY RAMPS OR FREEWAY LANES MAY BE CLOSED OR OBSTRUCTED AT ANYTIME. UNLESS SPECIFICALLY ALLOWED PER THE ENCROACHMENT PERMIT AND/OR AS DIRECTED BY THE STATE'S REPRESENTATIVE.

FEMCE RELOCATED TO FACILITATE CONSTRUCTION OF THIS PROJECT INSIDE STATE RIGHT OF WAY SHALL BE REPLACED WITH CL-6 FENCE. AS SHOWN IN THE STATE'S STANDARD PLANS, OR BLOCK WALL IN ACCORDANCE WITH CCEPTABLE LOCAL AGENCY STANDARDS.

ALL STATE DRAINAGE STRUCTURES MUST FIRST BE COMPLETELY CLEANED OF DEBRIS, AND/OR SILT, BY THE CONTRACTOR PRIOR TO MAKING THE CONNECTION.

THE CONTRACTOR SHALL BE RESPONSIBLE FOR INSURING THAT ANY STATE DRAINAGE FACILITY WHICH IS CONNECTED TO OR DIRECTLY AFFECTED BY CONTRACTORS OPERATION SHALL BE CLEAN AND OPERATIONAL PRIOR TO FINAL ACCEPTANCE OF PERMIT WORK BY STATE. ADEQUATE CLEAN OUTS AND ACCESS OPENINGS SHALL BE PROVIDED IN ANY CONSTRUCTION WITHIN THE STATE'S RIGHT OF WAY FOR FUTURE MAINTENANCE AND REPAIR WORK, AS NEEDED. THIS WORK SHALL BE FURNISHED AT NO COST TO THE STATE.


WHERE SURVEY MONUMENTS EXIST, SUCH MONUMENTS SHALL BE PROTECTED OR SHALL BE REFERENCED AND RESET, PURSUANT TO BUSINESS AND PROFESSIONS CODE, SECTIONS 8700 TO 8805 (LAND SURVEYOR'S ACT)

THE EXISTENCE AND LOCATION OF ANY UNDERGROUND UTILITY PIPES OR STRUCTURE SHOWN ON THESE PLANS WERE OBTAINED BY A SEARCH OF AVAILABLE RECORDS. THESE LOCATIONS ARE APPROXIMATE AND SHALL BE CONFIRMED IN THE FIELD BY THE CONTRACTOR, SO THAT ANY NECESSARY ADJUSTMENT CAN BE MADE IN ALIGNMENT AND/OR GRADE OF THE PROPOSED IMPROVEMENT. THE CONTRACTOR IS REQUIRED TO TAKE DUE PRECAUTIONARY MEASURES TO PROTECT ANY UTILITY LINES SHOWN AND ANY OTHER LINES NOT OF RECORD OR NOT SHOWN ON THESE PLANS.



TRACT 22408

STORM DRAIN IMPROVEMENT PLANS

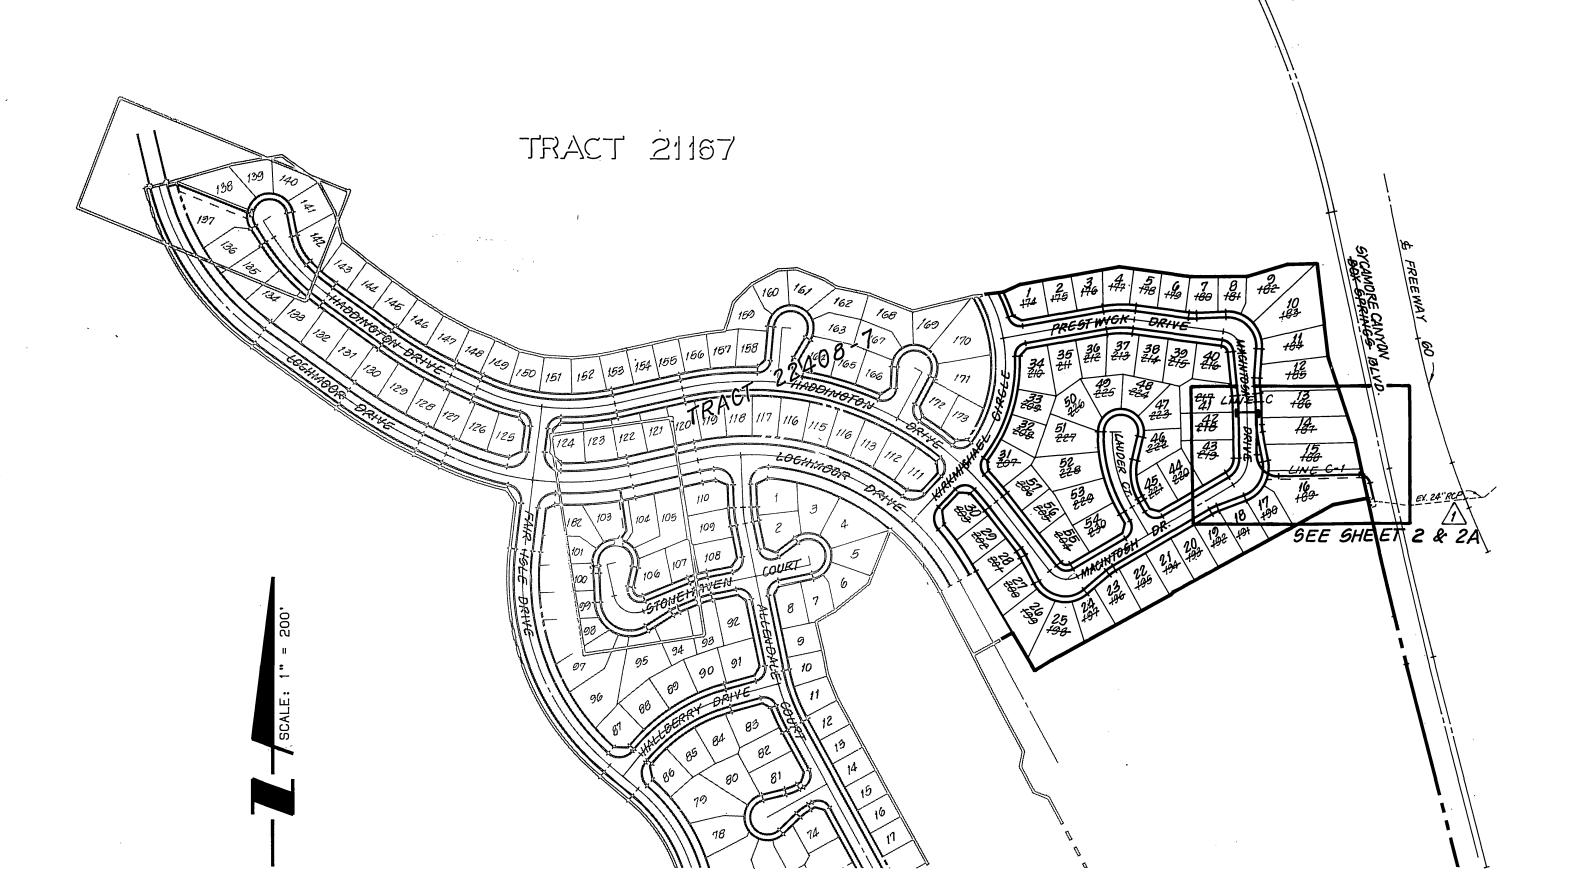

- IT SHALL BE THE RESPONSIBILITY OF THE CONTRACTOR TO CLEAR THE RIGHT-OF-WAY IN ACCORDANCE WITH THE PROVISIONS OF LAW AS IT AFFECTS EACH UTILITY INCLUDING IRRIGATION LINES AND APPURTENANCES AND AT NO COST TO THE CITY OR WELLS FARGO BANK
- CONSTRUCTION SHALL BE IN ACCORDANCE WITH THE CITY OF RIVERSIDE DEPARTMENT OF PUBLIC WORKS, STD. DWGS., IT'S SUPPLEMENTAL NOTES, STD. SPECIFICATIONS FOR PUBLIC WORKS CONSTRUCTION, CURRENT EDITION, AND CALIFORNIA DEPARTMENT OF TRANSPORTATION STANDARD PLANS DATED JULY, 1992.
- 3. THE PRIVATE ENGINEER SIGNING THESE PLANS IS RESPONSIBLE FOR ASSURING THE ACCURACY AND ACCEPTABILITY OF THE WORK HEREON. IN THE EVENT OF DISCREPANCIES ARISING DURING CONSTRUCTION, THE PRIVATE ENGINEER SHALL BE RESPONSIBLE FOR DETERMINING AN ACCEPTABLE SOLUTION, AND REVISING THE PLANS FOR APPROVAL BY
- QUANTITIES SHOWN ARE FOR INFORMATION ONLY. WELLS FARGO BANK AND/OR CITY OF RIVERSIDE IS NOT RESPONSIBLE FOR THEIR
- THE CONTRACTOR SHALL BE RESPONSIBLE FOR PRESERVING OR RE-ESTABLISHING AND REFERENCING SURVEY MONUMENTS DESTROYED, DISTURBED OR BURIED AS A RESULT OF CONSTRUCTION SHOWN HEREON.
- ON ALL AREAS WITHIN PUBLIC RIGHT-OF-WAY, WHERE THE FILL IS ONE (1) FOOT OR GREATER, A LETTER WILL BE REQUIRED FROM THE SOILS ENGINEER, CERTIFYING THE COMPACTION OF THE FILL BELOW SUBGRADE, PRIOR TO ISSUANCE OF THE CONSTRUCTION PERMIT/CUT
- 7. THE CONTRACTOR SHALL CALL IN A LOCATION REQUEST TO UNDERGROUND SERVICE ALERT (USA), PHONE 1-800-227-2600, TWO WORKING DAYS BEFORE DIGGING. NO CONSTRUCTION PERMIT WILL BE ISSUED BY THE PUBLIC WORKS DEPARTMENT INVOLVING EXCAVATION FOR UNDERGROUND FACILITIES UNLESS THE APPLICANT HAS BEEN PROVIDED AN INQUIRY IDENTIFICATION NUMBER BY U.S.A.
- B. THE STORM DRAIN CONTRACTOR SHALL ADJUST MANHOLES TO FINAL GRADE AFTER PAVING IS COMPLETED.
- CONTRACTOR TO VERIFY EXISTING STORM DRAIN ELEVATION PRIOR TO CONSTRUCTION.
- 10. BEFORE THE RIP RAP IS ACCEPTED, AS PLACED, AT THE OUTLET OF ANY DRAINAGE STRUCTURE, IT SHALL BE TESTED UNDER FLOWS AS - CLOSE AS POSSIBLE TO DESIGN CONDITIONS WITH WATER OBTAINED FROM FIRE HYDRANTS IN THE IMMEDIATE AREA.
- 11. ALL CROSS SECTIONS ARE TAKEN LOOKING DOWNSTREAM.
- 12. NO PERSON SHALL PERFORM ANY CONSTRUCTION ACTIVITY OR INSTALL ANY OBJECTS WITHIN THE PUBLIC RIGHTS-OF-WAY OR EASEMENTS OF THE CITY OF RIVERSIDE WITHOUT A VALID CONSTRUCTION PERMIT OR, A STREET OPENING PERMIT OR AN ENCROACHMENT PERMIT ISSUED BY THE CITY'S PUBLIC WORKS DEPARTMENT.
- 13. ALL FLAGGED ELEVATIONS SHALL BE STAKED IN THE FIELD BY THE PRIVATE ENGINEER.
- 14. TRIM EDGE OF EXISTING PAVEMENT WHERE NEW PAVEMENT JOINS TO A SMOOTH, STRAIGHT LINE. CONSTRUCT MATCH-UP PAVING AS SHOWN ON PLAN AND OVERLAY PAVING AS DIRECTED IN THE FIELD TO PRODUCE A SMOOTH SECTION.
- 15. IN PAVEMENT OVERLAY AREAS, DISTRESSED EXISTING PAVEMENT SHALL BE REMOVED AND REPLACED AS DIRECTED BY THE INSPECTOR PRIOR TO OVERLAYING WITH A.C. PAVEMENT.
- ANY TRAFFIC CONTROL STRIPING OBLITERATED AND/OR BADLY WORN DURING CONSTRUCTION SHALL BE RESTORED BY THE CONTRACTOR WITHIN FIVE DAYS AFTER NOTIFICATION FROM THE CITY INSPECTORS
- 17. PIPE BEDDING SHALL BE PER CITY OF RIVERSIDE STD. DWG. NO. 452, CASE I, UNLESS OTHERWISE SPECIFIED.

TRACT 22408

SCALE : 1" = 200'


PROJECT SITE

VICINITY MAP

CONSTRUCTION NOTES AND QUANTITY ESTIMATE (1)—RFMOVE EXISTING BULKHEAD AND JOIN EXISTING 24" R.C.P. INTO EXIGT 24" CONSTRUCT CATCH BASINIPER CITY OF RIVER (2)—CONSTRUCT 24" R.C.P. (1850-D) 3)--CONSTRUCT 15" R.C.P. (2000-0) 4)-CONSTRUCT CATCH BASIN PER CITY OF RIVERSIDE STD. DWG No. 405 OF RIVERSIDE STD. DWG. NO 452 CASE IV CONSTRUCT MODIFIED CONCRETE COLLAR 6)—CONSTRUCT PIPE SLOPE ANCHOR PER OCEMA STD PLAN No. 1333 PER CITY OF RIVERSIDE STD. DWG NO. 424 PROVIDE CONCRETE THICKNESS ("T")-8")—CONSTRUCT MANHOLE EZ PER CITY OF RIVERSIDE STD. DWG No. 431 CONSTRUCT CURB OUTLET PER CITY OF RIVERSIDE STD. DWG. NO. 41

DWG: NO. 405 W=4.0' Y=4.0 MODIFY BASIN FLOOR TO TO SLOPE TO CORNER OUTLET FROM ALL DIRECTIONS. CONSTRUCT CORNER CONNECTION PER RIVERSIDE COUNTY FLOOR AND WATER CONSERVATION DISTRICT STD. DWG NO CBIOD PER DETAIL SHOWN ON SHEET 3 CONSTRUCT CONCRETE BACKFILL PER CITY 6.4 CY. B.Q.2 (8)- REMOVE & REPLACE EXISTING SIDEWALK PER CITY STD. DWG. 325 270 S.F.

UNDERGROUND SERVICE **ALERT** I-800**-**227-2600 CALL TWO WORKING DAYS BEFORE YOU DIG

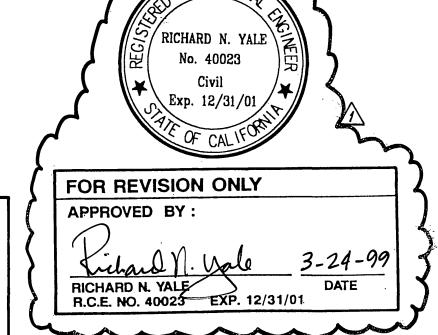

PRIVATE ENGINEER'S NOTICE TO CONTRACTOR

CONSTRUCTION CONTRACTOR AGREES THAT IN ACCORDANCE WITH GENERALLY ACCEPTED CONSTRUCTION PRACTICES, CONSTRUCTION CONTRACTOR WILL BE REQUIRED TO ASSUME SOLE AND COMPLETE RESPONSIBILITY FOR JOB SITE CONDITIONS DURING THE COURSE OF CONSTRUCTION OF THE PROJECT, INCLUDING SAFETY OF ALL PERSONS AND PROPERTY, THAT THIS REQUIREMENT SHALL BE MADE TO APPLY CONTINUOUSLY AND NOT BE LIMITED TO NORMAL WORKING HOURS. AND CONSTRUCTION CONTRACTOR FURTHER AGREES TO DEFEND, INDEMNIFY AND HOLD DESIGN PROFESSIONAL HARMLESS FROM ANY AND ALL LIABILITY, REAL OR ALLEGED, IN CONNECTION WITH THE PERFORMANCE OF WORK ON THIS PROJECT. EXCEPTING LIABILITY ARISING FROM THE SOLE NEGLIGENCE OF DESIGN PROFESSIONAL.

INDEXED 7-25-90 4H

THE KEITH 6296 RIVER CREST DRIVE

RIVERSIDE, CA 92507 (714) 653-0234

OF RIVERSIDE STORM DRAIN IMPROVEMENT PLAN APPROVED BY RINCIPAL ENGINEER

PUBLIC WORKS DEPARTMENT

TRACT 22408

D-582

ACCOUNT NO.

HORIZ. SCALE: 1" = AS SHOWNVERT. SCALE: 1" = AS SHOWN ●P● 前村正R4中 TSEORNIDBAID 25/50/50/50 TENDINGT 10/50/05/23/21PF 7/2/2000日 0/21 150-70-630 038-724 PM // 7/2/5/00日-5/302

FEET SOUTHEAST OF MILEPOST 6, SET VERTICALLY IN THE SOUTHWEST FACE OF A ROCK CUT 7 FEET NORTHEAST OF THE NORTHEAST RAIL, 1.9 FEET ABOVE THE GROUND, AND ABOUT 1 FOOT HIGHER THAN THE TRACK. BRASS DISK STAMPED D1144 1961 ELEVATION 1451.887 (BRASS DISK IS BROKEN OFF FOUND ORIGINAL SHANK OF BRASS DISK WITH P.K.

TEMP 2.5" A.C. PAVING

SANDBAGS
BENCHMARK:

NÁIL DRIVEN ALONG SIDE SHANK.

3.5 MILES NORTHWEST ALONG THE ATCHISON, TOPEKA AND SANTA FE RAILWAY FROM THE STATION AT MARCH FIELD, 76

COMPANIES

APPROVED BY: < BRIAN L. JENSEN REG CIVIL ENGINEER NO. 30534 DATE

REVISED PER TRACT MAP PHASING REVISIONS

PARK DEPARTMENT TRAFFIC DIVISION HIEF P. W. ENGINEER DESIGNED BY_____ DRAWN BY RR CHECKED BY CYA

Dan

TITLE SHEET

AN ENCROACHMENT PERMIT IS REQUIRED BEFORE ANY WORK M BEGIN IN/OR WEAR THE STATE RIGHT OF WAY. ALL WORK WITHIN THE STATE RIGHT OF WAY SHALL CONFORM

TO THE LATEST STATE STANDARD PLANS AND SPECIFICATIONS OR AS DIRECTED BY THE STATE'S REPRESENTATIVE NO EQUIPMENT OR MATERIALS MAY BE STORED ON THE STATE

ALL DISTURBED AREAS IN THE STATE RIGHT OF WAY MUST BE TREATED FOR EROSION CONTROL (HYDROSEEDING OR EQUIVALENT OR AS DIRECTED BY THE STATE'S REPRESENTATIVE). THE RESPONSIBILITY FOR MAINTAINING EROSION CONTROL RELEASED UNTIL THE SEEDING IS WELL ESTABLISHED. THE CONTRACTOR WILL BE RESPONSIBLE FOR THE COST OF CALTRANS CLEANING ANY DRAINAGE STRUCTURES AND CHANNELS WHICH HAVE BECOME CLUTTERED WITH DEBRIS AND OR SILT AS A RESULT OF, OR CAUSED BY, THE CONSTRUCTION PROJECT.

ACCESS CONTROL ON THE FREEWAY WILL BE MAINTAINED AT ALL TIMES (WORK INSIDE STATE RIGHT OF WAY MUST BE FENCED OFF WITH NO ACCESS TO WORK AREA FROM FREEWAY).

NO FREEWAY RAMP'S OR FREEWAY LANES MAY BE CLOSED OR OBSTRUCTED AT ANYTIME, UNLESS SPECIFICALLY ALLOWED PER THE ENCROACHMENT PERMIT AND OR AS DIRECTED BY T STATE'S REPRESENTATIVE.


FENCE RELOCATED TO FACILITATE CONSTRUCTION OF THIS PROJECT INSIDE STATE RIGHT OF WAY SHALL BE REPLACED WITH CL-6 FENCE. AS SHOWN IN THE STATE'S STANDARD PLANS, OR BLOCK WALL IN ACCORDANCE WITH ACCEPTABLE LOCAL AGENCY STANDARDS.

ALL STATE DRAINAGE STRUCTURES MUST FIRST BE COMPLETELY ELEANED OF DEBRIS, AND/OR SILT, BY THE CONTRACTOR PRIOR TO MAKING THE CONNECTION.

THE CONTRACTOR SHALL BE RESPONSIBLE FOR INSURING THAT ANY STATE DRAINAGE FACILITY WHICH IS CONNECTED TO OR DIRECTLY AFFECTED BY CONTRACTORS OPERATION SHALL BE CLEAN AND OPERATIONAL PRIOR TO FINAL ACCEPTANCE OF PERMIT WORK BY STATE. ADEQUATE CLEAN OUTS AND ACCESS OPENINGS SHALL BE PROVIDED IN ANY CONSTRUCTION WITHIN THE STATE'S RIGHT OF WAY FOR FUTURE MAINTENANCE AND REPAIR WORK, AS NEEDED. THIS WORK SHALL BE FURNISHED AT NO COST TO THE STATE AT NO COST TO THE STATE.

WHERE SURVEY MONUMENTS EXIST, SUCH MONUMENTS SHALL BE PROTECTED OR SHALL BE REFERENCED AND RESET, PURSUANT TO BUSINESS AND PROFESSIONS CODE, SECTIONS 8 00 TO 8805 (LAND SURVEYOR'S ACT).

THE EXISTENCE AND LOCATION OF ANY UNDERGROUND UTILITY PIPES OR STRUCTURE SHOWN ON THESE PLANS WERE OBTAINED BY A SEARCH OF AVAILABLE RECORDS. THESE LOCATIONS ARE APPROXIMATE AND SHALL BE CONFIRMED IN THE FIELD BY THE CONTRACTOR, SO THAT ANY NECESSARY ADJUSTMENT CAN BE MADE IN ALIGNMENT AND/OR GRADE OF THE PROPOSED IMPROVEMENT. THE CONTRACTOR IS REQUIRED TO TAKE DUE PRECAUTIONARY MEASURES TO PROTECT ANY UTILITY LINES SHOWN AND ANY OTHER LINES NOT OF RECORD OR NOT SHOWN ON THESE PLANS.

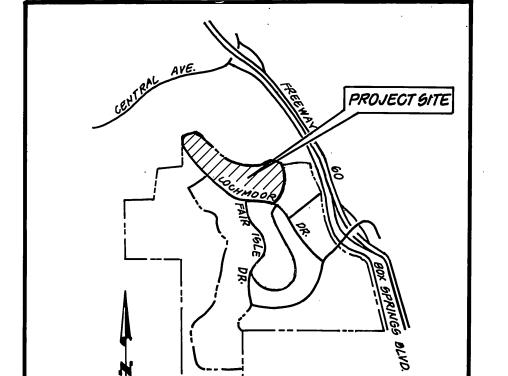


VICINITY MAP

NOT TO SCALE

TRACT 2240867

STORM DRAIN IMPROVEMENT PLANS

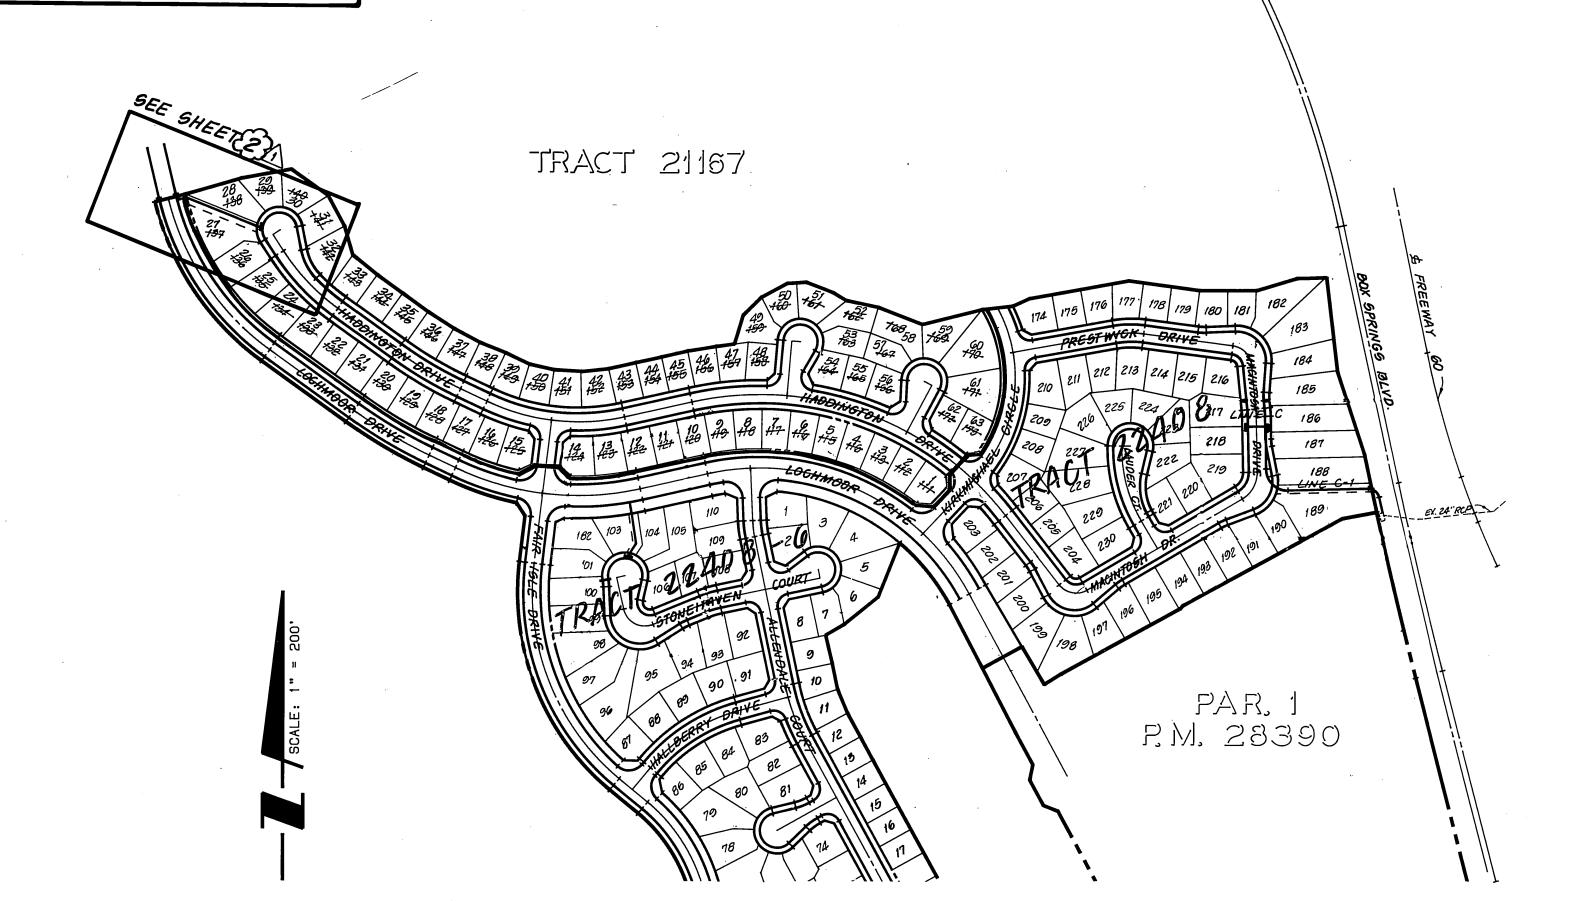

- 1. IT SHALL BE THE RESPONSIBILITY OF THE CONTRACTOR TO CLEAR THE RIGHT-OF-WAY IN ACCORDANCE WITH THE PROVISIONS OF LAW AS IT AFFECTS EACH UTILITY INCLUDING IRRIGATION LINES AND APPURTENANCES AND AT NO COST TO THE CITY OR WELLS FARGO BANK
- CONSTRUCTION SHALL BE IN ACCORDANCE WITH THE CITY OF RIVERSIDE DEPARTMENT OF PUBLIC WORKS STD. DWGS., ITS SUPPLEMENTAL FOR PUBLIC WORKS CONSTRUCTION, NOTES, STD. SPECIFICATIONS CURRENT EDITION, AND CALIFORNIA DEPARTMENT OF TRANSPORTATION STANDARD PLANS DATED JULY, 1992.
- THE PRIVATE ENGINEER SIGNING THESE PLANS IS RESPONSIBLE FOR ASSURING THE ACCURACY AND ACCEPTABILITY OF THE WORK HEREON. IN THE EVENT OF DISCREPANCIES ARISING DURING CONSTRUCTION, THE PRIVATE ENGINEER SHALL BE RESPONSIBLE FOR DETERMINING AN ACCEPTABLE SOLUTION, AND REVISING THE PLANS FOR APPROVAL BY
- QUANTITIES SHOWN ARE FOR INFORMATION ONLY. WELLS FARGO BANK AND/OR CITY OF RIVERSIDE IS NOT RESPONSIBLE FOR THEIR ACCURACY.
- THE CONTRACTOR SHALL BE RESPONSIBLE FOR PRESERVING OR RE-ESTABLISHING AND REFERENCING SURVEY MONUMENTS DESTROYED, DISTURBED OR BURIED AS A RESULT OF CONSTRUCTION SHOWN HEREON.
- ON ALL AREAS WITHIN PUBLIC RIGHT-OF-WAY, WHERE THE FILL IS ONE (1) FOOT OR GREATER, A LETTER WILL BE REQUIRED FROM THE SOILS ENGINEER, CERTIFYING THE COMPACTION OF THE FILL BELOW SUBGRADE, PRIOR TO ISSUANCE OF THE CONSTRUCTION PERMIT/CUT
- THE CONTRACTOR SHALL CALL IN A LOCATION REQUEST TO UNDERGROUND SERVICE ALERT (USA), PHONE 1-800-227-2600, TWO WORKING DAYS BEFORE DIGGING. NO CONSTRUCTION PERMIT WILL BE ISSUED BY THE PUBLIC WORKS DEPARTMENT INVOLVING EXCAVATION FOR UNDERGROUND FACILITIES UNLESS THE APPLICANT HAS BEEN PROVIDED AN INQUIRY IDENTIFICATION NUMBER BY U.S.A.
- THE STORM DRAIN CONTRACTOR SHALL ADJUST MANHOLES TO FINAL GRADE AFTER PAVING IS COMPLETED.
- CONTRACTOR TO VERIFY EXISTING STORM DRAIN ELEVATION PRIOR TO CONSTRUCTION.
- 10. BEFORE THE RIP-RAP IS ACCEPTED, AS PLACED, AT THE OUTLET OF ANY DRAINAGE STRUCTURE, IT SHALL BE TESTED UNDER FLOWS AS CLOSE AS POSSIBLE TO DESIGN CONDITIONS WITH WATER OBTAINED FROM FIRE HYDRANTS IN THE IMMEDIATE AREA.
- 11. ALL CROSS SECTIONS ARE TAKEN LOOKING DOWNSTREAM.
- 12. NO PERSON SHALL PERFORM ANY CONSTRUCTION ACTIVITY OR INSTALL ANY OBJECTS WITHIN THE PUBLIC RIGHTS-OF-WAY OR EASEMENTS OF THE CITY OF RIVERSIDE WITHOUT A VALID CONSTRUCTION PERMIT OR, A STREET OPENING PERMIT OR AN ENCROACHMENT PERMIT ISSUED BY THE CITY'S PUBLIC WORKS DEPARTMENT.
- 13. ALL FLAGGED ELEVATIONS SHALL BE STAKED IN THE FIELD BY THE PRIVATE ENGINEER.
- 14. TRIM EDGE OF EXISTING PAVEMENT WHERE NEW PAVEMENT JOINS TO A SMOOTH, STRAIGHT LINE. CONSTRUCT MATCH-UP PAVING AS SHOWN ON PLAN AND OVERLAY PAVING AS DIRECTED IN THE FIELD TO PRODUCE A SMOOTH SECTION.
- 15. IN PAVEMENT OVERLAY AREAS, DISTRESSED EXISTING PAVEMENT SHALL BE REMOVED AND REPLACED AS DIRECTED BY THE INSPECTOR PRIOR TO OVERLAYING WITH A.C. PAVEMENT.
- 16. ANY TRAFFIC CONTROL STRIPING OBLITERATED AND/OR BADLY WORN DURING CONSTRUCTION SHALL BE RESTORED BY THE CONTRACTOR WITHIN FIVE DAYS AFTER NOTIFICATION FROM THE CITY INSPECTORS
- 17. PIPE BEDDING SHALL BE PER CITY OF RIVERSIDE STD. DWG. NO. 452, CASE I, UNLESS OTHERWISE SPECIFIED.

TRACT 22408-5

6296 RIVER CREST DRIVE

RIVERSIDE, CA 92507

(714) 653-0234

BRIAN L. JENSEN REG CIVIL ENGINEER NO. 30534 DATE DESIGNED BY____

CONSTRUCTION NOTES AND QUANTITY ESTIMATE

REMOVE EXISTING BULKHEAD AND JOIN EXISTING 24" R.C.P. INTO EXIGT 24" (2)-CONSTRUCT 24" R.C.P. (1850-0) 3) construct 15" r.c.p.(*2000-0*) CONSTRUCT CONCRETE COLLAR PER CITY OF RIVERSIDE STD. DWG No 6) CONSTRUCT PIPE SLOPE ANCHOR PER OCEMA STD PLAN No. 1333 CONSTRUCT MANHOLE EZ PER GITY OF RIVERSIDE STD. DWG No. 431-(8) CONSTRUCT CURB OUTLET PER CITY OF RIVERSIDE STD, DWG. NO. 410 ___CONSTRUCT 18" R.C.P. (2000-0) 12:3-115 LF TEMP 2.5" A.C PAVING

3.5 MILES NORTHWEST ALONG THE ATCHISON. TOPEKA AND SANTA FE RAILWAY FROM THE STATION AT MARCH FIELD, 76 FEET SOUTHEAST OF MILEPOST 6. SET VERTICALLY IN THE SOUTHWEST FACE OF A ROCK CUT 7 FEET NORTHEAST OF THE NORTHEAST RAIL, 1.9 FEET ABOVE THE GROUND, AND ABOUT 1 FOOT HIGHER THAN THE TRACK. BRASS DISK STAMPED D1144 1961 ELEVATION 1451.887 (BRASS DISK IS BROKEN OFF FOUND ORIGINAL SHANK OF BRASS DISK WITH PK. NAIL DRIVEN ALONG SIDE SHANK.

-CONSTRUCT CATCH BASIN PER CITY OF RIVERSIDE STO. DWG. NO. 405 W=40' Y=40 MODIFY BASIN FLOOR TO-TO SLOPE TO CORNER OUTLET FROM ALL DIRECTIONS. COUNTY FLOOR AND WATER CONSERVATION DISTRICT ISTO. DWG NO CBIOG PER DETAIL SHOWN ON CHEET 3 - CONSTRUCT CONCRETE BACKFILL PER CITY G.4 CY. CONSTRUCT MODIFIED CONCRETE COLLAR PER CITY OF RIVERSIDE STO. DWG NO.

THE

KEITH

COMPANIES

UNDERGROUND SERVICE ALERT 1-800-422-4133 CALL TWO WORKING

DAYS BEFORE YOU DIG

REVISED PER TRACT MAP PHASING X000 14.6 6-29-11

DRAWN BY RR CHECKED BY CYAR

No. 40023 FOR REVISION ONLY APPROVED BY: RICHARD N. YALE R.C.E. NO. 40023 EXP. 12/31/01

APPROVED BY

ARK DEPARTMENT

TRAFFIC DIVISION

INCIPAL ENGINEER

HIEF P. W. ENGINEER

PUBLIC WORKS DEPARTMENT

DATE BY

1/12/20 5

7/13/90 An.6 7/12/90 WW

RICHARD N. YALE

PRIVATE ENGINEER'S NOTICE TO CONTRACTOR

CONSTRUCTION CONTRACTOR AGREES THAT IN ACCORDANCE WITH GENERALLY ACCEPTED CONSTRUCTION PRACTICES, CONSTRUCTION CONTRACTOR WILL BE REQUIRED TO ASSUME SOLE AND COMPLETE RESPONSIBILITY FOR JOB SITE CONDITIONS DURING THE COURSE OF CONSTRUCTION OF THE PROJECT, INCLUDING SAFETY OF ALL PERSONS AND PROPERTY, THAT THIS REQUIREMENT SHALL BE MADE TO APPLY CONTINUOUSLY AND NOT BE LIMITED TO NORMAL WORKING HOURS, AND CONSTRUCTION CONTRACTOR FURTHER AGREES TO DEFEND, INDEMNIFY AND HOLD DESIGN PROFESSIONAL HARMLESS FROM ANY AND ALL LIABILITY, REAL OR ALLEGED. IN CONNECTION WITH THE PERFORMANCE OF WORK ON THIS PROJECT. EXCEPTING LIABILITY ARISING FROM THE SOLE NEGLIGENCE OF DESIGN PROFESSIONAL.

INDEXED 7-25-90 4


STORM DRAIN IMPROVEMENT PLAN

TRACT 22408(-7)

TITLE SHEET

HORIZ. SCALE: 1" = AS SHOWNVERT. SCALE: 1" = AS SHOWN

● P ● MATIERAPPE TORORA TORORA TO 25 ASHEEF WHEF T 404 TO LOCATE PF 7/2180600 TO 121 1 150-FULLY-890 035-2024 PM // 7/200005-05300

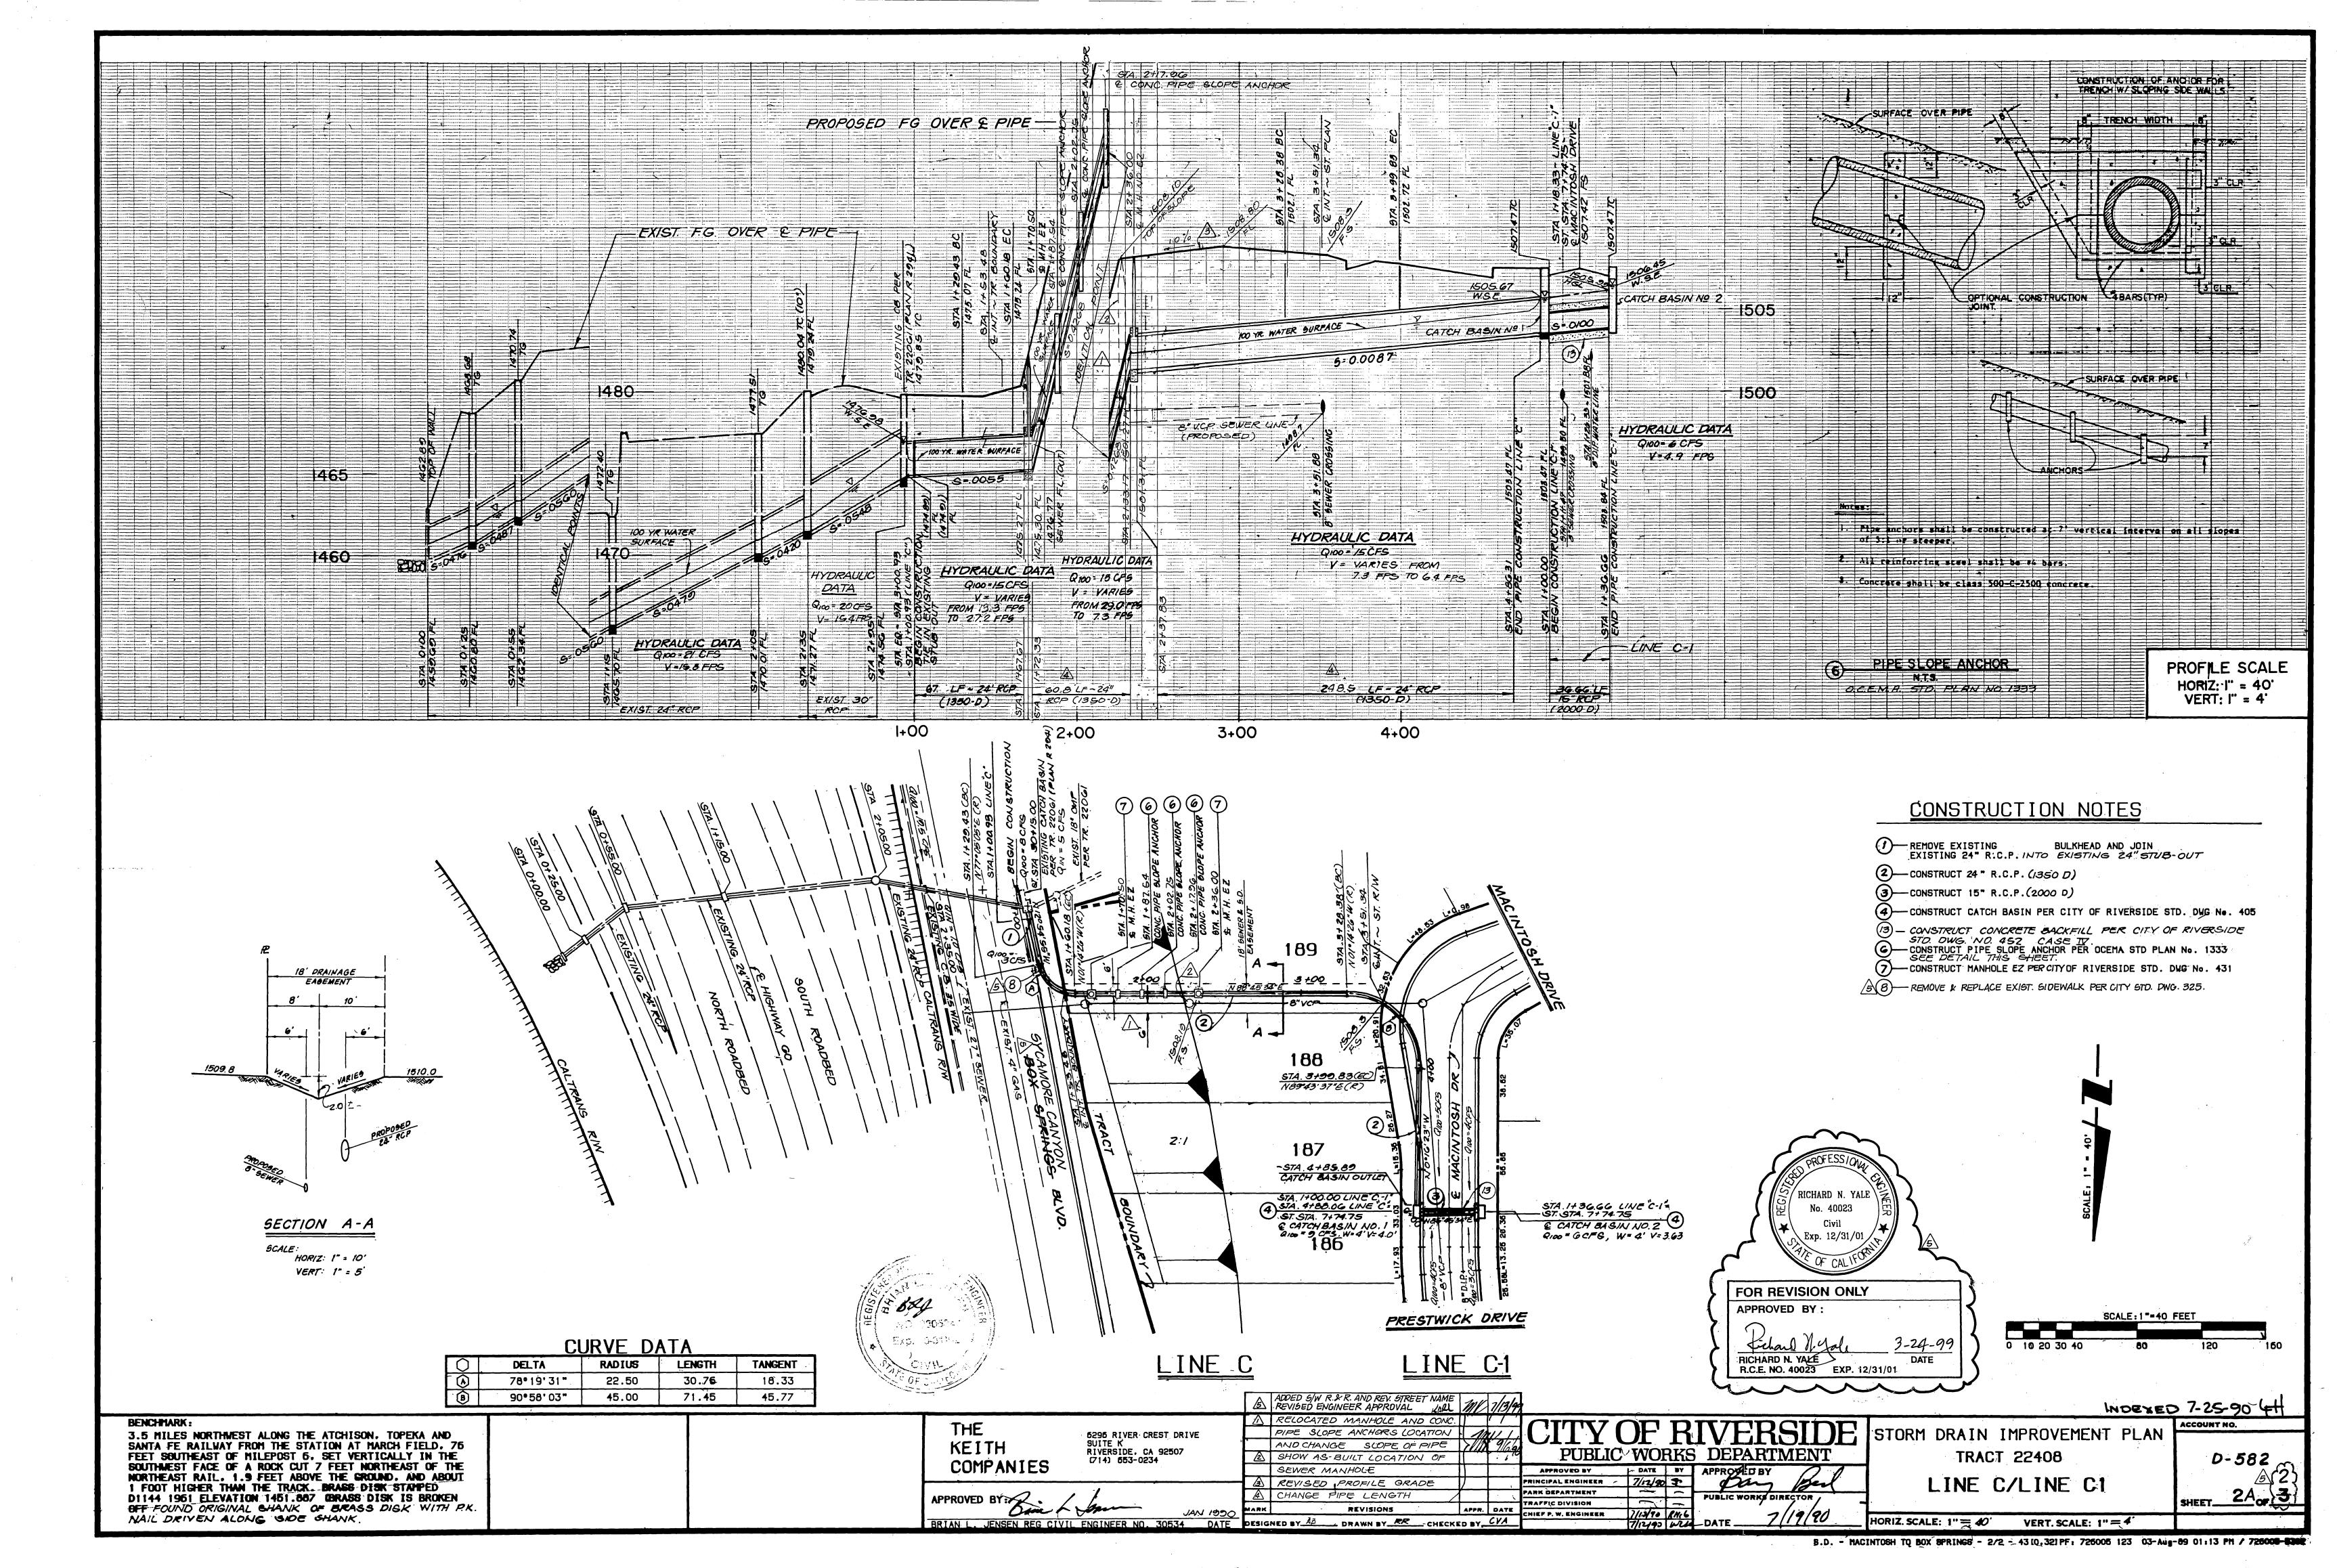

AN ENCROACHMENT PERMIT IS REQUIRED BEFORE ANY WORK MAY BEGIN IN/OR NEAR THE STATE RIGHT OF WAY.

ALL WORK WITHIN THE STATE RIGHT OF WAY SHALL CONFORM TO THE LATEST STATE STANDARD PLANS AND SPECIFICATIONS OR AS DIRECTED BY THE STATE'S REPRESENTATIVE.

NO EQUIPMENT OR MATERIALS MAY BE STORED ON THE STATE RIGHT OF WAY.

ALL DISTURBED AREAS IN THE STATE RIGHT OF WAY MUST BE TREATED FOR EROSION CONTROL (HYDROSEEDING OR EQUIVALENT. OR AS DIRECTED BY THE STATE'S REPRESENTATIVE). THE RESPONSIBILITY FOR MAINTAINING EROSION CONTROL RELEASED UNTIL THE SEEDING IS WELL ESTABLISHED. THE CONTRACTOR WILL BE RESPONSIBLE FOR THE COST OF CALTRANS CLEANING ANY DRAINAGE STRUCTURES AND CHANNELS WHICH HAVE BECOME CLUTTERED WITH DEBRIS AND/OR SILT AS A RESULT OF, OR CAUSED BY, THE CONSTRUCTION PROJECT.

ACCESS CONTROL ON THE FREEWAY WILL BE MAINTAINED AT ALL TIMES (WORK INSIDE STATE RIGHT OF WAY MUST BE FENCED OFF WITH NO ACCESS TO WORK AREA FROM FREEWAY).

NO FREEWAY RAMPS OR FREEWAY LANES MAY BE CLOSED OR OBSTRUCTED AT ANYTIME, UNLESS SPECIFICALLY ALLOWED PER THE ENCROACHMENT PERMIT AND/OR AS DIRECTED BY THE STATE'S REPRESENTATIVE.

ALL FENCE RELOCATED TO FACILITATE CONSTRUCTION OF THIS PROJECT INSIDE STATE RIGHT OF WAY SHALL BE REPLACED WITH CL-6 FENCE, AS SHOWN IN THE STATE'S STANDARD PLANS, OR BLOCK WALL IN ACCORDANCE WITH ACCEPTABLE LOCAL AGENCY STANDARDS.

ALL STATE DRAINAGE STRUCTURES MUST FIRST BE COMPLETELY CLEANED OF DEBRIS, AND/OR SILT, BY THE CONTRACTOR PRIOR TO MAKING THE CONNECTION.

THE CONTRACTOR SHALL BE RESPONSIBLE FOR INSURING THAT ANY STATE DRAINAGE FACILITY WHICH IS CONNECTED TO OR DIRECTLY AFFECTED BY CONTRACTORS OPERATION SHALL BE CLEAN AND OPERATIONAL PRIOR TO FINAL ACCEPTANCE OF PERMIT WORK BY STATE. ADEQUATE CLEAN OUTS AND ACCESS OPENINGS SHALL BE PROVIDED IN ANY CONSTRUCTION WITHIN THE STATE'S RIGHT OF WAY FOR FUTURE MAINTENANCE AND REPAIR WORK, AS NEEDED. THIS WORK SHALL BE FURNISHED AT NO COST TO THE STATE.

WHERE SURVEY MONUMENTS EXIST, SUCH MONUMENTS SHALL BE PROTECTED OR SHALL BE REFERENCED AND RESET, PURSUANT TO BUSINESS AND PROFESSIONS CODE, SECTIONS 8700 TO 8805 (LAND SURVEYOR'S ACT).

THE EXISTENCE AND LOCATION OF ANY UNDERGROUND UTILITY PIPES OR STRUCTURE SHOWN ON THESE PLANS WERE OBTAINED BY A SEARCH OF AVAILABLE RECORDS. THESE LOCATIONS ARE APPROXIMATE AND SHALL BE CONFIRMED IN THE FIELD BY THE CONTRACTOR, SO THAT ANY NECESSARY ADJUSTMENT CAN BE MADE IN ALIGNMENT AND/OR GRADE OF THE PROPOSED IMPROVEMENT. THE CONTRACTOR IS REQUIRED TO TAKE DUE PRECAUTIONARY MEASURES TO PROTECT ANY UTILITY LINES SHOWN AND ANY OTHER LINES NOT OF RECORD OR NOT SHOWN ON THESE PLANS.

CONSTRUCTION NOTES AND QUANTITY ESTIMATE

REMOVE EXISTING BULKHEAD AND JOIN EXISTING 24" R.C.P. INTO EXIST. 24"

-CONSTRUCT CATCH BASIN PER CITY OF RIVERSIDE STD. DWG No. 405

- CONSTRUCT PIPE SLOPE ANCHOR PER OCEMA STD PLAN No. 1333

CONSTRUCT MANHOLE EZ PER CITY OF RIVERSIDE STD. DWC-No. 43


CONSTRUCT CURB OUTLET PER CITY OF RIVERSIDE STD, DWG. NO. 410

(2) CONSTRUCT 24" R.C.P. (1350- D)


) -construct 15" r.c.p. (*2000-0)*

-construct 18" r.c.p. *(2000 - D)*

TEMP 2.5" A.C PAVING

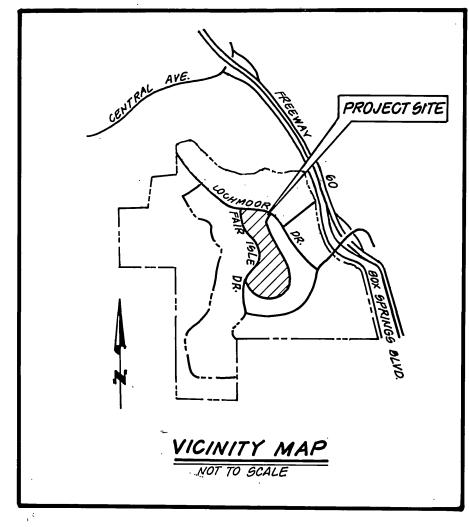

STORM DRAIN IMPROVEMENT PLANS

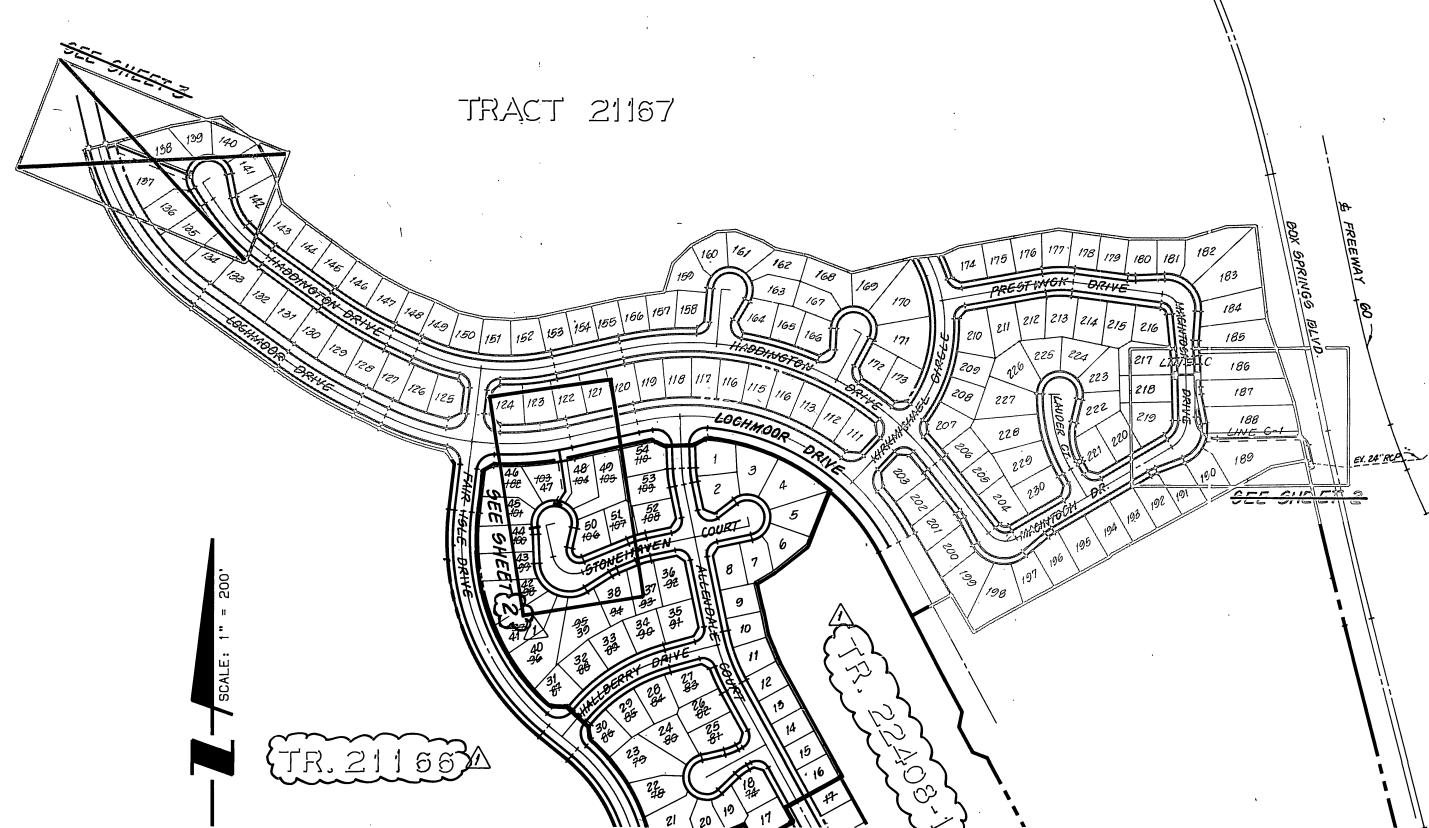

PRIVATE ENGINEER'S NOTICE TO CONTRACTOR

CONSTRUCTION CONTRACTOR AGREES THAT IN ACCORDANCE WITH GENERALLY ACCEPTED CONSTRUCTION PRACTICES, CONSTRUCTION CONTRACTOR WILL BE REQUIRED TO ASSUME SOLE AND COMPLETE RESPONSIBILITY FOR JOB SITE CONDITIONS DURING THE COURSE OF CONSTRUCTION OF THE PROJECT, INCLUDING SAFETY OF ALL PERSONS AND PROPERTY, THAT THIS REQUIREMENT SHALL BE MADE TO APPLY CONTINUOUSLY AND NOT BE LIMITED TO NORMAL WORKING HOURS. AND CONSTRUCTION CONTRACTOR FURTHER AGREES TO DEFEND, INDEMNIFY AND HOLD DESIGN PROFESSIONAL HARMLESS FROM ANY AND ALL LIABILITY, REAL OR ALLEGED. IN CONNECTION WITH THE PERFORMANCE OF WORK ON THIS PROJECT. EXCEPTING LIABILITY ARISING FROM THE SOLE NEGLIGENCE OF DESIGN

IT SHALL BE THE RESPONSIBILITY OF THE CONTRACTOR TO CLEAR THE RIGHT-OF-WAY IN ACCORDANCE WITH THE PROVISIONS OF LAW AS

IT AFFECTS EACH UTILITY INCLUDING IRRIGATION LINES AND APPURTENANCES AND AT NO COST TO THE CITY OR THE LUSK COMPANY.

RIVERSIDE DEPARTMENT OF PUBLIC WORKS, STANDARD DRAWINGS,

STANDARD SPECIFICATIONS FOR PUBLIC WORKS CONSTRUCTION,

CURRENT EDITION, AND CALIFORNIA DEPARTMENT OF TRANSPORTATION

THE PRIVATE ENGINEER SIGNING THESE PLANS IS RESPONSIBLE FOR

ASSURING THE ACCURACY AND ACCEPTABILITY OF THE WORK HEREON.

IN THE EVENT OF DISCREPANCIES ARISING DURING CONSTRUCTION,

THE PRIVATE ENGINEER SHALL BE RESPONSIBLE FOR DETERMINING AN

ACCEPTABLE SOLUTION, AND REVISING THE PLANS FOR APPROVAL BY

QUANTITIES SHOWN ARE FOR INFORMATION ONLY. THE LUSK COMPANY

AND/OR CITY OF RIVERSIDE IS NOT RESPONSIBLE FOR THEIR

ESTABLISHING AND REFERENCING SURVEY MONUMENTS DESTROYED, DISTURBED OR BURIED AS A RESULT OF CONSTRUCTION SHOWN HEREON.

ONE (1) FOOT OR GREATER, A LETTER WILL BE REQUIRED FROM THE SOILS ENGINEER, CERTIFYING THE COMPACTION OF THE FILL BELOW

SUBGRADE, PRIOR TO ISSUANCE OF THE CONSTRUCTION PERMIT/CUT

UNDERGROUND SERVICE ALERT (USA), PHONE 1-800-227-2600, TWO

WORKING DAYS BEFORE DIGGING. NO CONSTRUCTION PERMIT WILL BE ISSUED BY THE PUBLIC WORKS DEPARTMENT INVOLVING EXCAVATION FOR UNDERGROUND FACILITIES UNLESS THE APPLICANT HAS BEEN

7. THE CONTRACTOR SHALL CALL IN A LOCATION REQUEST TO

8. IF STREET IS TO BE RAISED, LOWERED OR OVERLAID, "ADJUST-

9. CONTRACTOR TO VERIFY EXISTING STORM DRAIN ELEVATION PRIOR TO-

10. BEFORE THE RIP-RAP IS ACCEPTED, AS PLACED, AT THE OUTLET OF ANY DRAINAGE STRUCTURE, IT SHALL BE TESTED UNDER FLOWS AS -CLOSE AS POSSIBLE TO DESIGN CONDITIONS WITH WATER OBTAINED

13. ALL FLAGGED ELEVATIONS SHALL BE STAKED IN THE FIELD BY THE

14. TRIM EDGE OF EXISTING PAVEMENT WHERE NEW PAVEMENT JOINS TO A

15. IN PAVEMENT OVERLAY AREAS, DISTRESSED EXISTING PAVEMENT SHALL

16. ANY TRAFFIC CONTROL STRIPING OBLITERATED AND/OR BADLY WORN DURING

ENCROACHMENT PERMIT ISSUED BY THE CITY'S PUBLIC WORKS DEPARTMENT.

SMOOTH, STRAIGHT LINE. CONSTRUCT MATCH-UP PAVING AS SHOWN ON

PLAN AND OVERLAY PAVING AS DIRECTED IN THE FIELD TO PRODUCE A

BE REMOVED AND REPLACED AS DIRECTED BY THE INSPECTOR PRIOR TO

CONSTRUCTION SHALL BE RESTORED BY THE CONTRACTOR WITHIN FIVE DAYS AFTER NOTIFICATION FROM THE CITY INSPECTORS

17. NO PERSON SHALL PERFORM ANY CONSTRUCTION ACTIVITY OR INSTIALL ANY OBJECTS WITHIN THE PUBLIC RIGHTS-OF-WAY OR EASEMENTS OF THE CITY OF RIVERSIDE WITHOUT A VALID CONSTRUCTTION PERMIT OR, A STREET OPENING PERMIT OR AN

PROVIDED AN INQUIRY IDENTIFICATION NUMBER BY U.S.A.

FROM FIRE HYDRANTS IN THE IMMEDIATE AREA.

TO BE THE RESPONSIBILITY OF THE DEVELOPER.

11. ALL CROSS SECTIONS ARE TAKEN LOOKING DOWNSTREAM.

12. FINAL STRIPING FOR TRAFFIC CONTROL AND/OR PAVEMENT MARKING

5. THE CONTRACTOR SHALL BE RESPONSIBLE FOR PRESERVING OR RE-

6. ON ALL AREAS WITHIN PUBLIC RIGHT-OF-WAY, WHERE THE FILL IS

2. CONSTRUCTION SHALL BE IN ACCORDANCE WITH THE CITY OF

STANDARD DRAWINGS.

MANHOLE TO CRADE".

CONSTRUCTION.

PRIVATE ENGINEER.

SMOOTH SECTION.

OVERLAYING WITH A.C. PAVEMENT.

Bar

PUBLIC WORKS DIREC

UNDERGROUND SERVICE ALERT

> WORKS DEPARTMENT APPROVED, BY APPROVED BY DATE BY

STORM DRAIN IMPROVEMENT PLAN TRACT 22408(-6)

THE KEITH COMPANIES APPROVED BY:

6296 RIVER CREST DRIVE SUITE K RIVERSIDE, CA 92507 (714) 653-0234

BRIAN L. JENSEN REG CIVIL ENGINEER NO. 30534 DATE

INCIPAL ENGINEER 7/12/20 30 ARK DEPARTMENT REVISED PER TRACT MAP PHASING. TRAFFIC DIVISION HIEF P. W. ENGINEER 13/90 An.

TITLE SHEET HORIZ. SCALE: 1" = AS SHOWNVERT. SCALE: 1" = AS SHOWN

SOUTHWEST FACE OF A ROCK CUT 7 FEET NORTHEAST OF THE NORTHEAST RAIL, 1.9 FEET ABOVE THE GROUND, AND ABOUT 1 FOOT HIGHER THAN THE TRACK. BRASS DISK STAMPED D1144 1961 ELEVATION 1451.887 (BRASS DISK IS BROKEN OFF FOUND ORIGINAL SHANK OF BRASS DISK WITH PK NAIL DRIVEN ALONG SIDE SHANK.

3.5 MILES NORTHWEST ALONG THE ATCHISON, TOPEKA AND

SANTA FE RAILWAY FROM THE STATION AT MARCH FIELD, 76

FEET SOUTHEAST OF MILEPOST 6. SET VERTICALLY IN THE

3130!

INDEX MAF SCALE : 1" = 200'

(12) - CONSTRUCT CATCH BASIN PER CITY OF RIVERSIDE STO.

DWG. NO. 405 W = 4.0' Y = 4.0 MODIFY BASIN FLOOR TO TO SLOPE TO CORNER OUTLET FROM ALL DIRECTIONS. CONSTRUCT CORNER CONNECTION PER RIVERSIDE COUNTY FLOOR AND WATER CONSERVATION DISTRICT STD. DWG NO CBIOD PER DETAIL SHOWN ON SHEET 3 CONSTRUCT CONCRETE BACKFILL PER CITY G.4 CY. DE RIVERSIDE STD. DWG. NO 452 CASE IN

CONSTRUCT MODIFIED CONCRETE COLLAR-PER CITY OF RIVERSIDE STO. DWG NO. 424 PROVIDE CONCRETE THICKNESS ("T") -8"

1-800-227-2600 CALL TWO WORKING DAYS BEFORE YOU DIG

DESIGNED BY__

FOR REVISION ONLY APPROVED BY: RICHARD N. YALE (R.C.E. NO. 40023 EXP. 12/31/01

RICHARD N. YALE No. 40023

PROFESSIONAL.

INDEXED 7-25-90 4H

