


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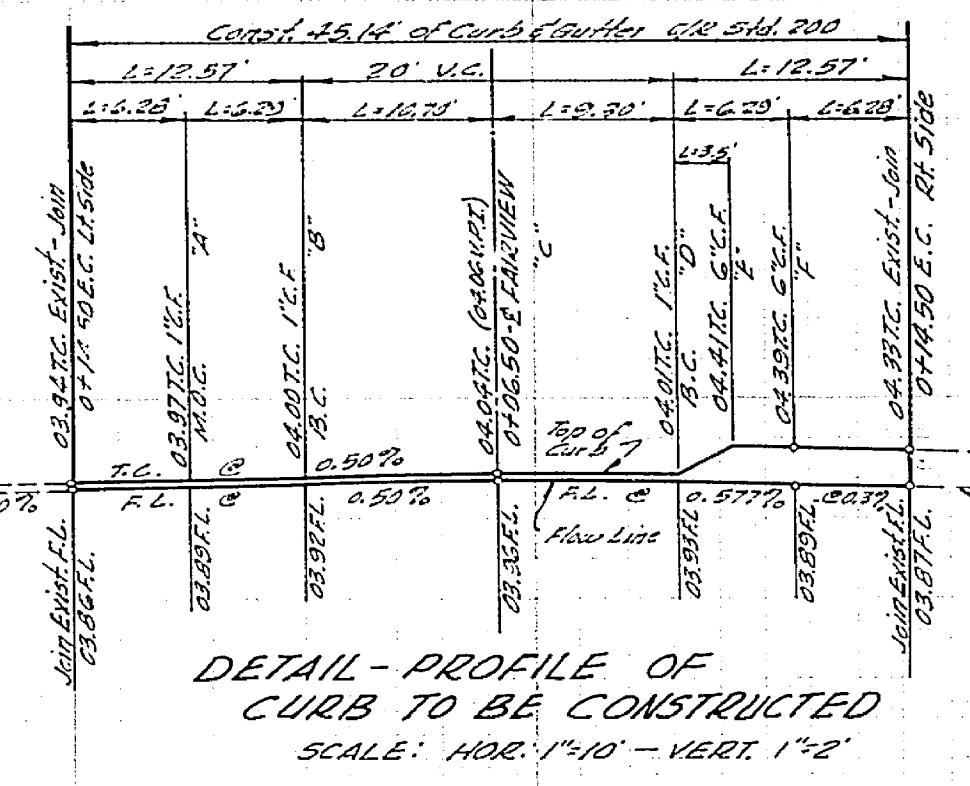
NOTE: SEE DETAIL AT LEFT FOR PROFILE OF CURB TO BE CONSTRUCTED

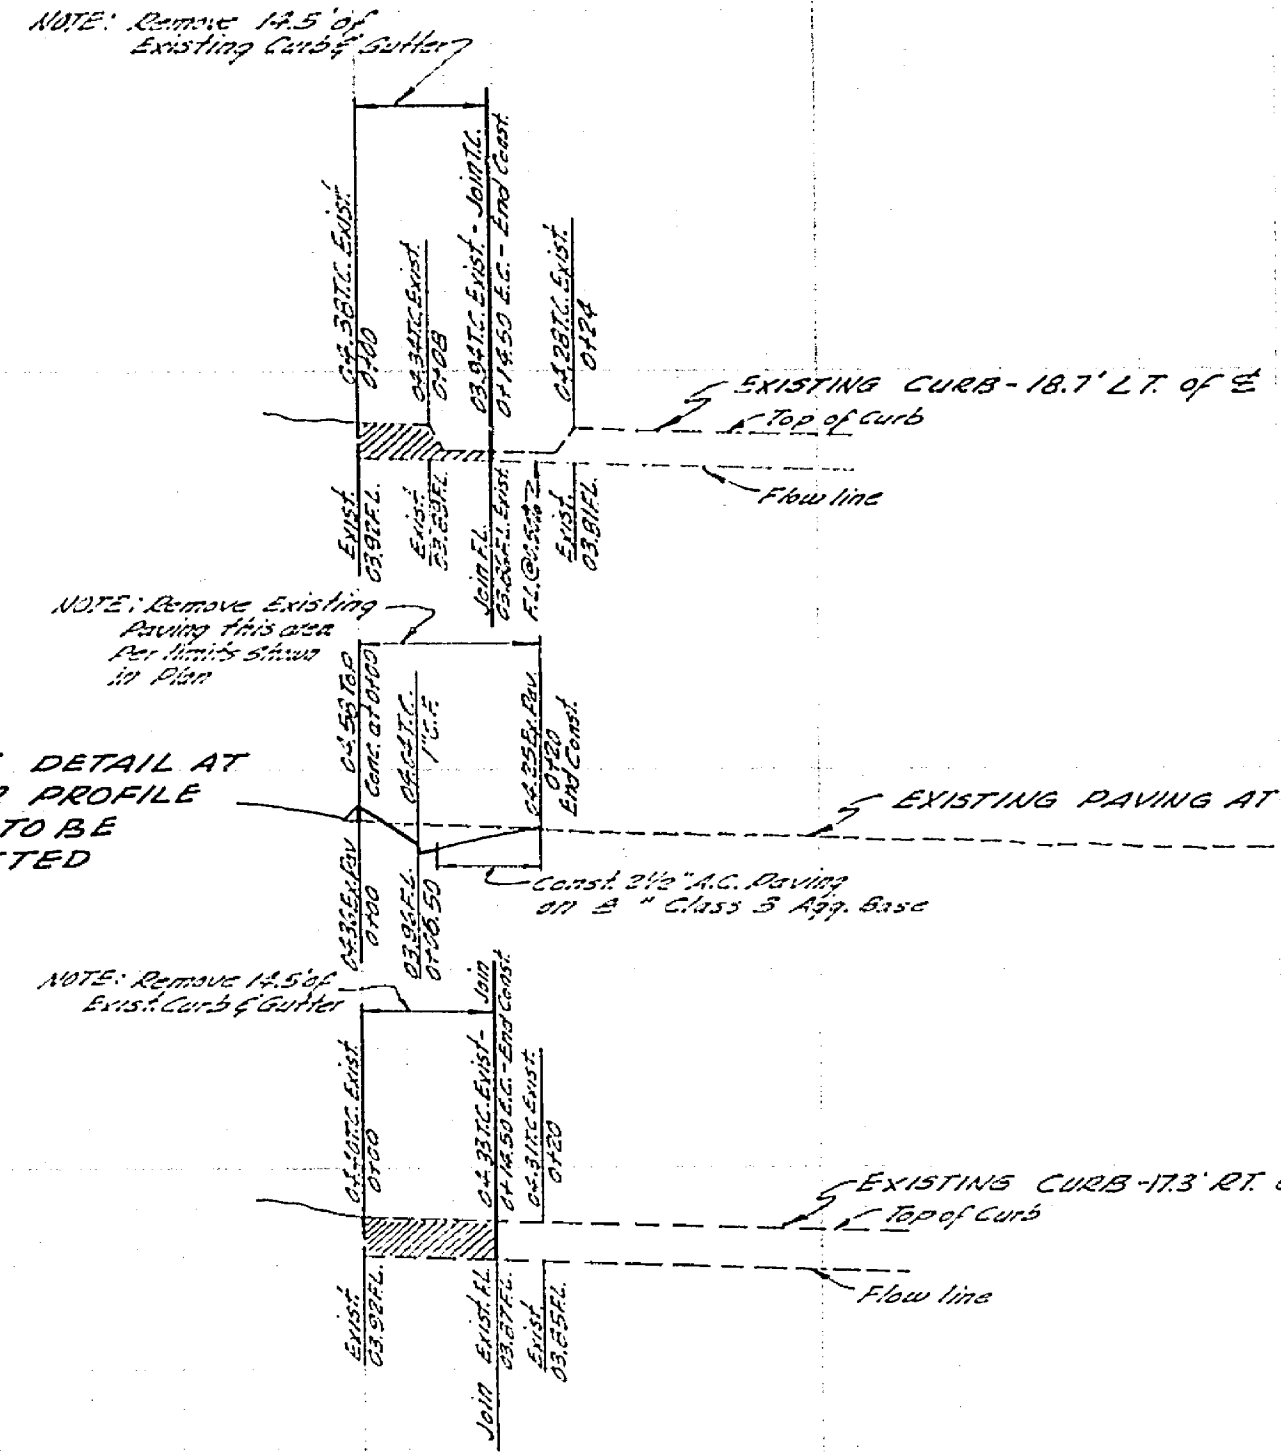


SCALE: HOR. 1"=20' - VERT. 1"=2'

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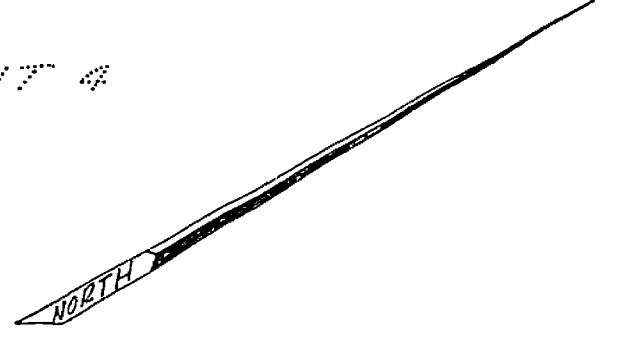
DETAIL - PROFILE OF CURB TO BE CONSTRUCTED  
SCALE: HOR. 1"=10' - VERT. 1"=2'



TED & PRICE  
2645 FAIRVIEW  
RIVERSIDE, CALIF.

CURVE DATA (Both Curves)  
R=150.00'  
L=118.57'

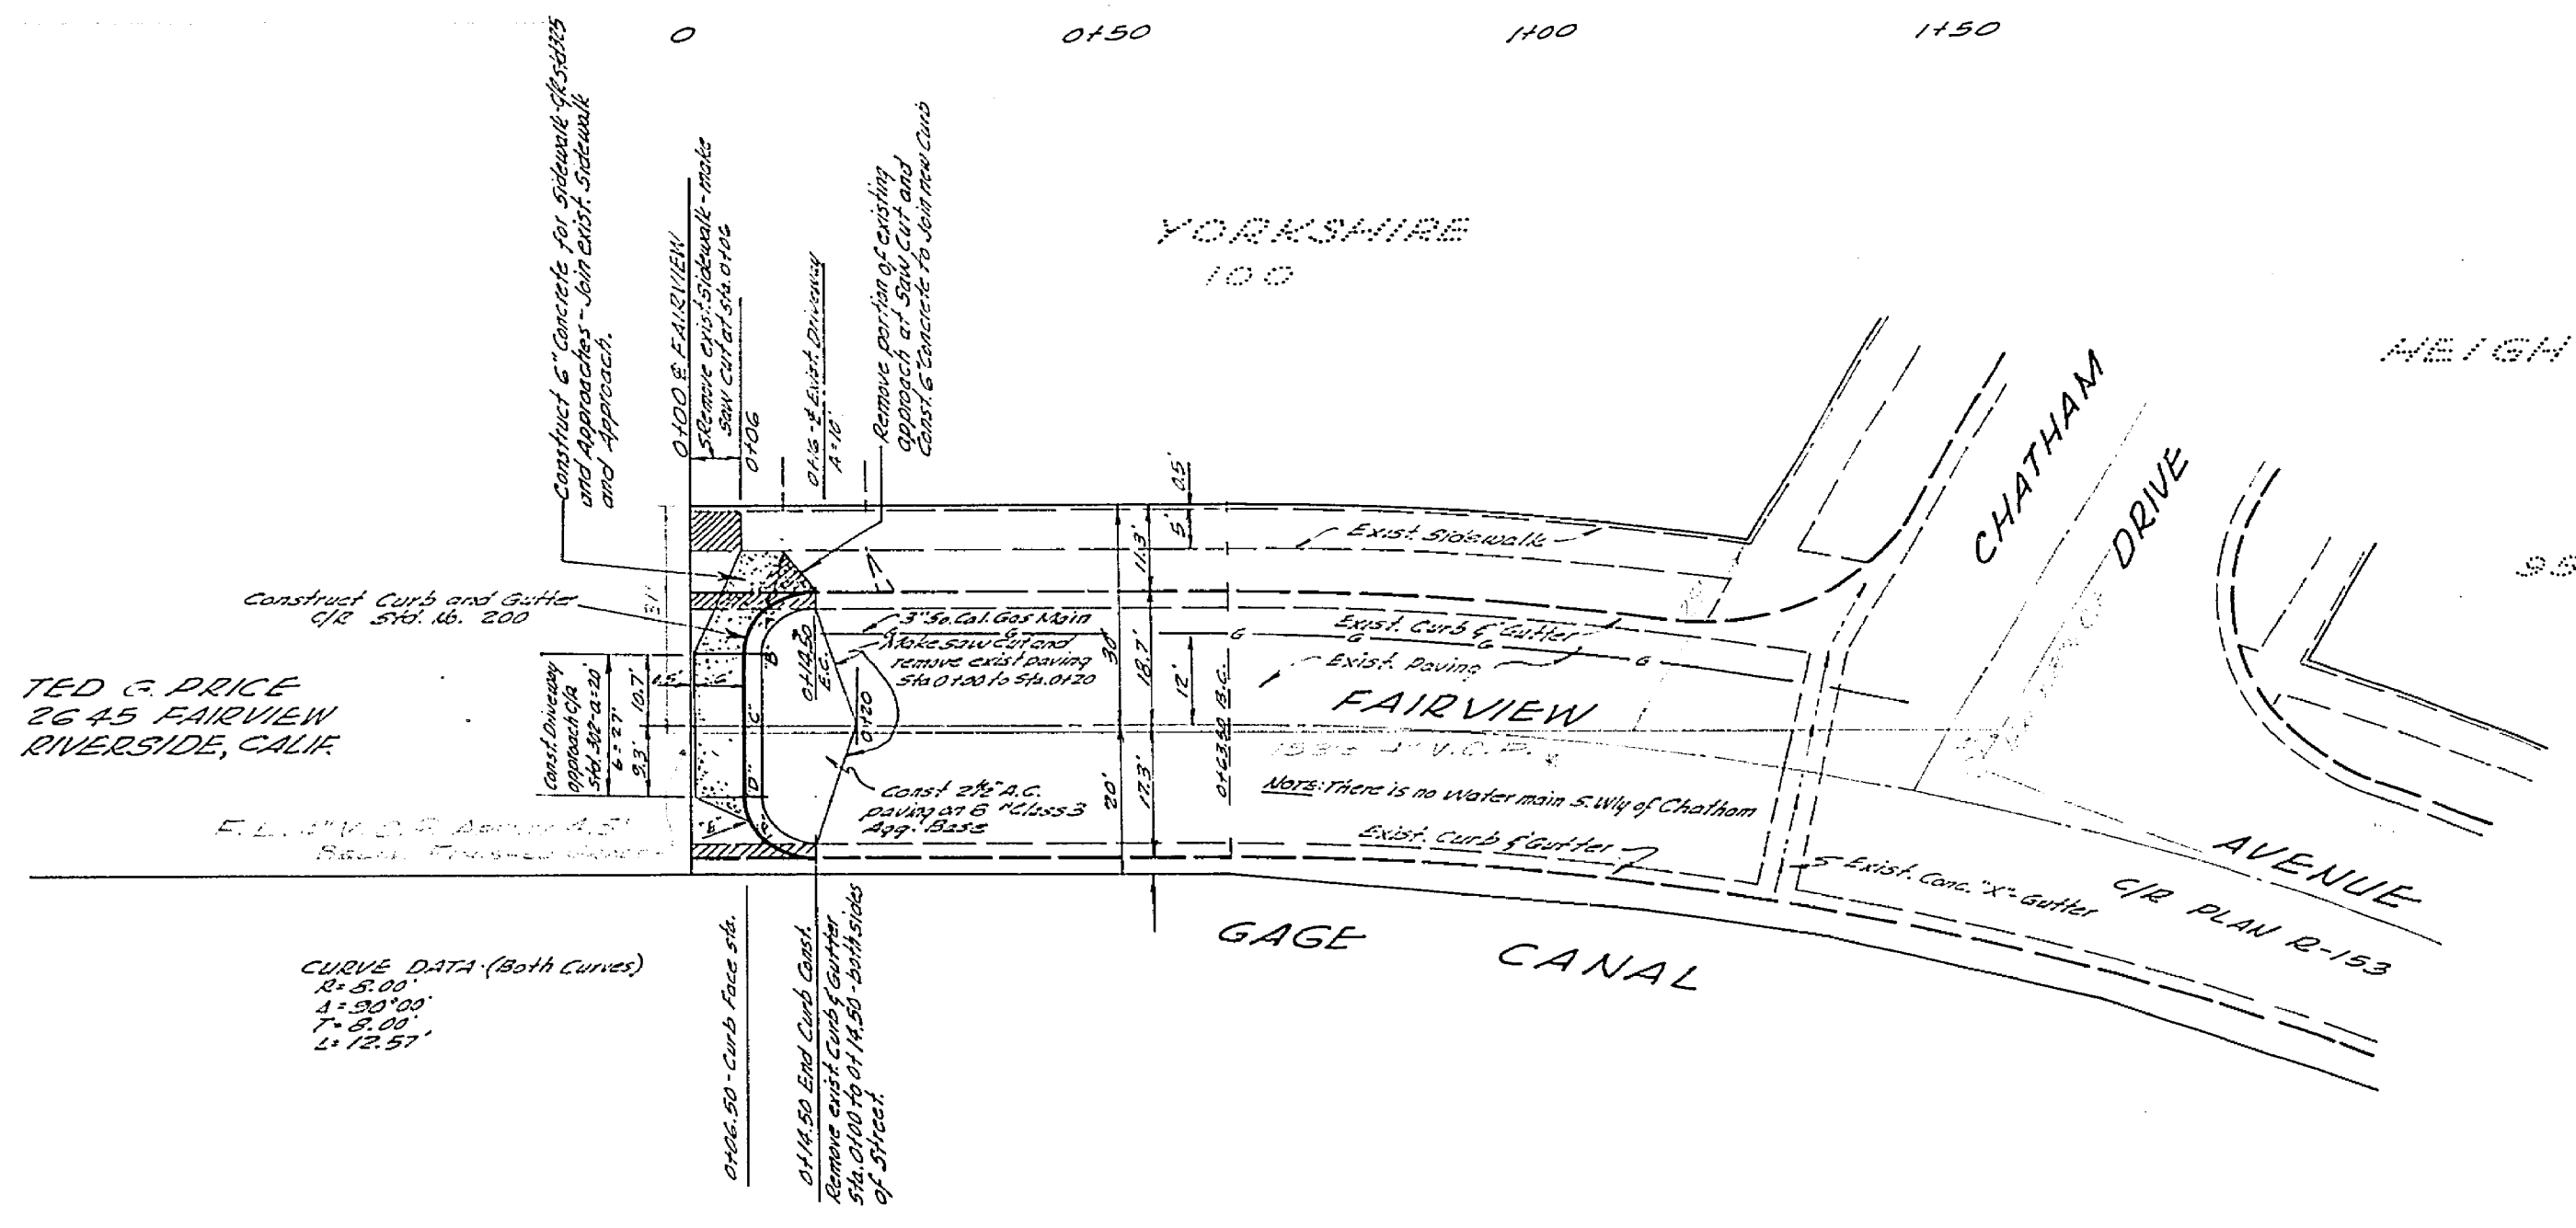HEIGHTS - UNIT 4



GENERAL NOTES

- It shall be the responsibility of the contractor to clear the Right of Way in accordance with the provisions of law as it affects each utility including irrigation lines and appurtenances and at no cost to the City.
- Construction shall be in accordance with the City of Riverside Dept. of Public Works Specifications No. 461 and Standard Drawings.
- Prime Coat, Seal Coat and Paint Binder are required.
- Thin edge of existing pavement, where new pavement joins existing pavement, to a clean, straight line. Construct match up paving as shown.
- The finish sub-grade shall have a compaction of not less than 98% for a depth of 6" feet as determined by test method No. 216 immediately prior to placement of concrete.

BENCH MARK - T.B.M.#1 - Top of curb W. side Fairview Ave - Sta. 0+00  
Elev. 1004.30  
T.B.M.#2 - Top of curb S.W. side Fairview Ave - Sta. 0+20 - Elev. 1004.31

**CRAWLEY, HAWKINS & HIEBER**  
ENGINEERS AND SURVEYORS  
3245 BLUEBETH ST., RIVERSIDE, CALIF.  
PH. 684-7878  
APPROVED *George O. Crawley* DATE 1/3/67  
REG. 34851

DESIGNED BY	DRAWN BY	CHECKED BY	APPR. DATE
J.S. 685	M.G.	M.G.	

CITY OF RIVERSIDE, CALIFORNIA DEPARTMENT OF PUBLIC WORKS			
APPROVED BY	BY	DATE	APPROVED BY
OFFICE ENGINEER	<i>[Signature]</i>	1-30-67	DIRECTOR OF PUBLIC WORKS
PARK DEPARTMENT			
TRAFFIC DIVISION			
ASSISTANT CITY ENG.			

STREET PLAN AND PROFILE FAIRVIEW AVENUE 140' W. OF CHATHAM DRIVE TERMINATE IMPROVEMENTS 2645 FAIRVIEW AVENUE		PROJECT NO. <b>R-1214</b>
HORIZ. SCALE: 1" = 20' AS NOTED VERT. SCALE: 1" = 2'		SHEET <b>1</b> OF <b>1</b> FILE NO. <b>114</b>