


STREET SIGN SCHEDULE

A	LIBERTY STREET	6100 BLK
A	GRIFFITH STREET	5800 BLK

- GENERAL NOTES**
- It shall be the responsibility of the contractor to clear the right of way in accordance with the provisions of the law as it affects each utility, including irrigation lines and appurtenances and at no cost to the city.
 - Construction shall be in accordance with City of Riverside, Department of Public Works Specifications No. 461 and Standard Drawings.
 - Prime coat, seal coat and paint binder are required.
 - Grading will require a permit under Ordinance No. 3033 for a cut or fill exceeding 100 cubic yards or a fill over one foot in depth.
 - Trim edge of existing pavement where new paving joins existing paving to a plain, straight edge. Construct proper tie paving or slabs and overlay as directed in the plans to construct a smooth, uniform section. Engineers estimate of pavement overlay is 1" thick.
 - Street name sign and post shall conform to City Specifications and Std. Dwg. No. 662.

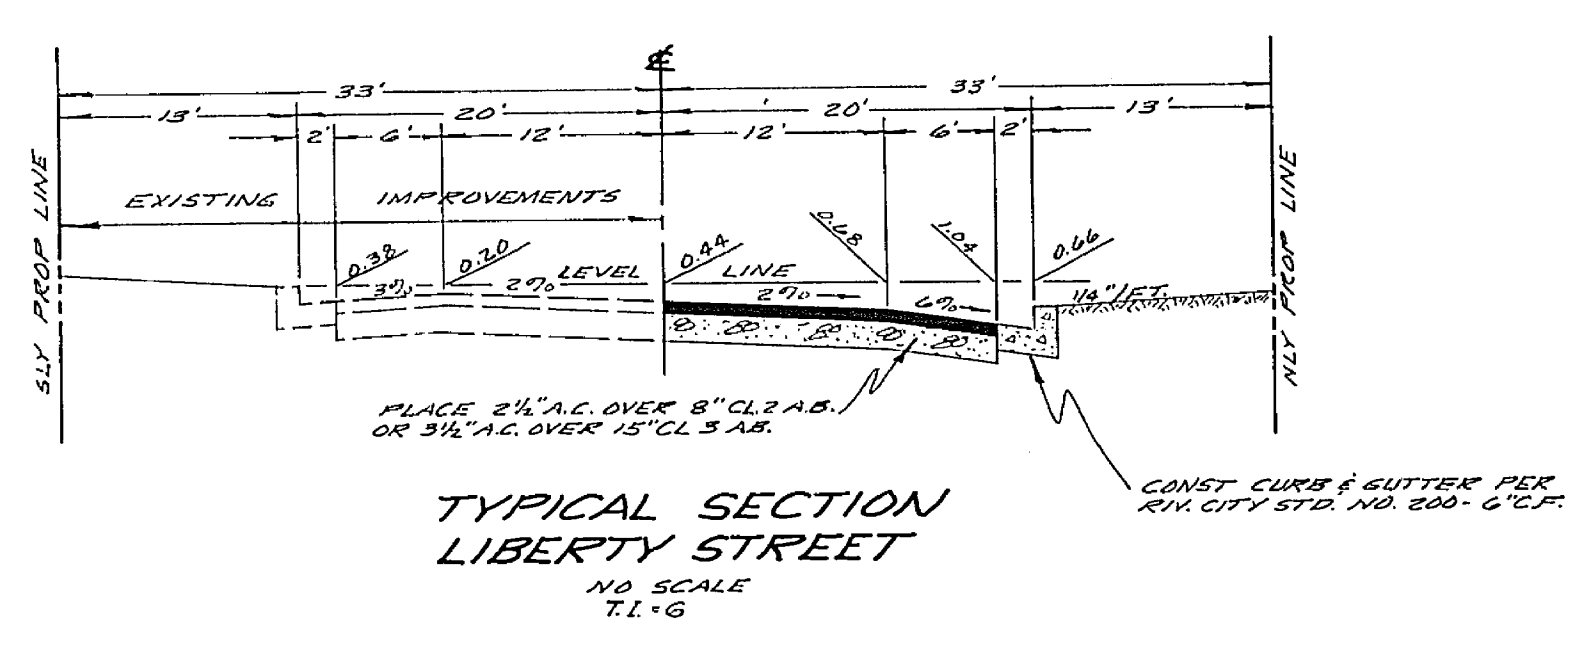

CRAWLEY, HAWKINS & HIEBER ENGINEERS & SURVEYORS RIVERSIDE, CALIF. - PH-684-3522 APPROVED <i>[Signature]</i> DATE 1/25/67 REG. 12407		CITY OF RIVERSIDE, CALIFORNIA DEPARTMENT OF PUBLIC WORKS APPROVED BY <i>[Signature]</i> DATE 2-7-67 OFFICE ENGINEER PARK DEPARTMENT TRAFFIC DIVISION ASSISTANT CITY ENGINEER		STREET PLAN AND PROFILE GRIFFITH STREET LIBERTY TO 270' NLY OF LIBERTY LIBERTY STREET 175' ELY OF GRIFFITH TO GRIFFITH BUILDING PERMIT (5887 - FREDMONT)		PROJECT NO. R-1216 SHEET 1 OF 1 FILE NO. 416
JO. WIG FOR: RIV. TRANSFER FEB 5/73	DESIGNED BY <i>[Signature]</i> DRAWN BY <i>[Signature]</i> CHECKED BY <i>[Signature]</i>	REVISIONS APPR. DATE	DATE 3-8-67	HORIZ. SCALE: 1" = 40' VERT. SCALE: 1" = 4'		