



GENERAL NOTES

- It shall be the responsibility of the contractor to clear the right of way in accordance with the provisions of law as it affects such utility, including irrigation lines and appurtenances and of no cost to the city.
- Construction shall be in accordance with the City of Riverside, Department of Public Works, Standard Drawings, and the Standard Specifications for Public Works Construction, 1958 edition.
- The edge of existing pavement where new pavement joins to a smooth, straight line. Construct match-up paving on edge and evenly paving as directed in the sheet to produce a smooth section.
- Construct driveway approach per DM Div. 302. Exact size and location to be determined at the time of construction as approved by the Traffic Engineer.
- Curb and gutters shall be sloped with 3' offsets at 25' intervals.
- All flagged elevations shall be checked in the field by the prime engineer.

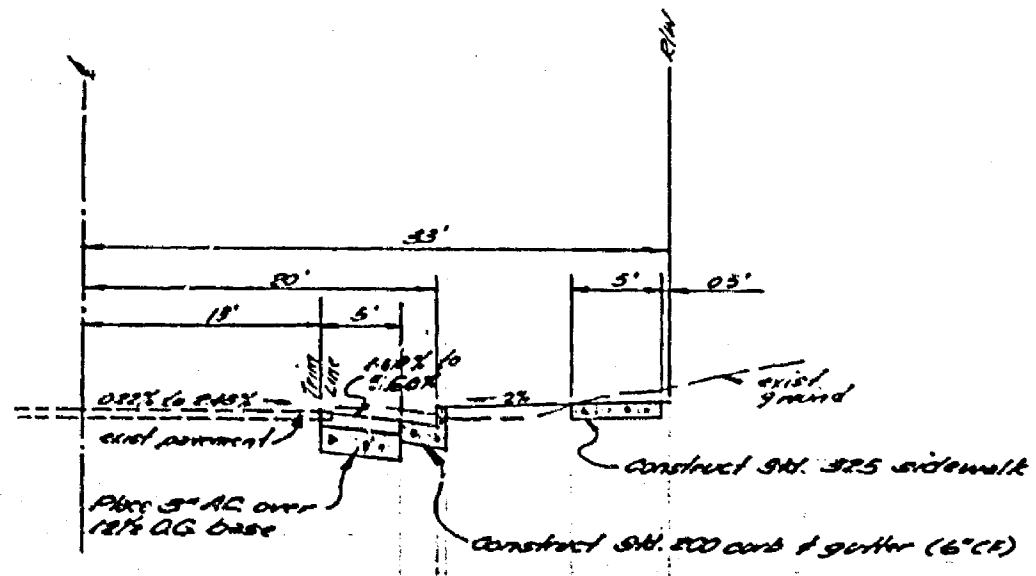

TYPICAL SECTION
12-6

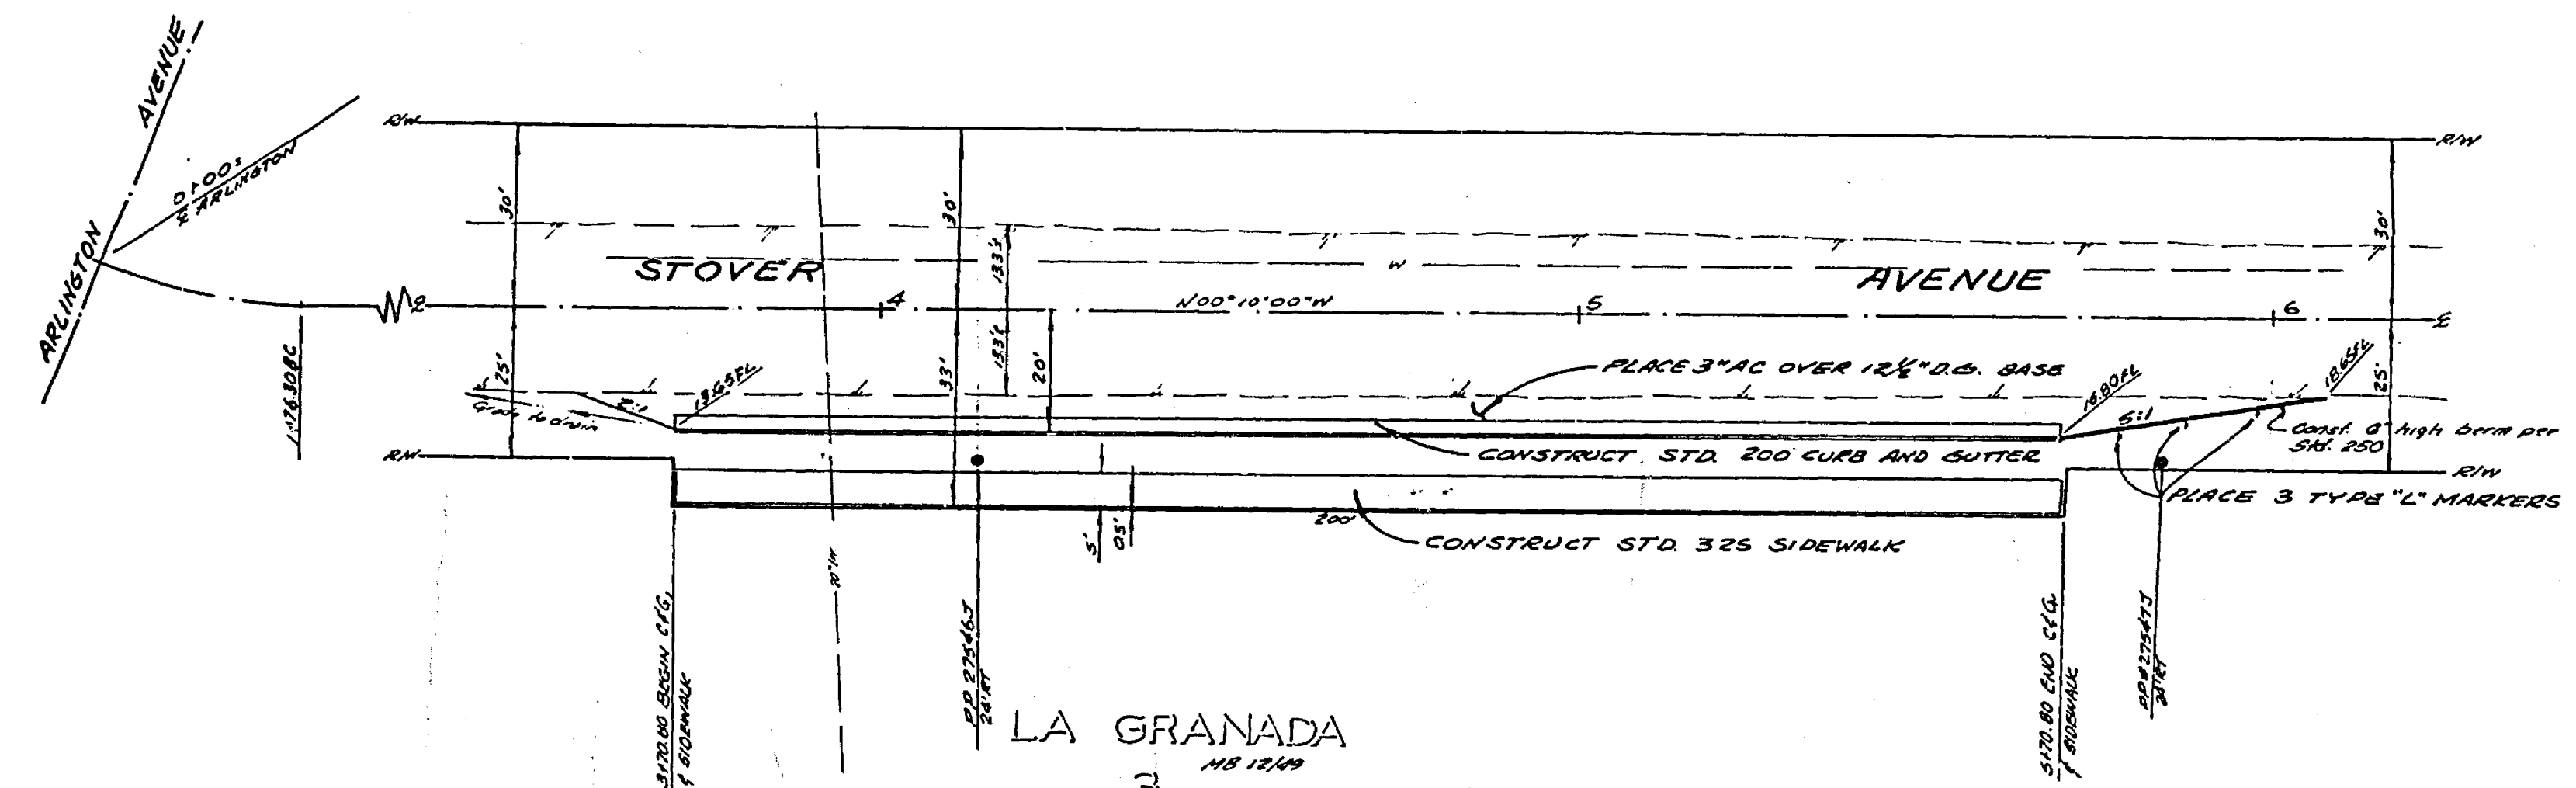

BENCH MARK
City 80237
City of Riverside B.M. GP-D
No. of 136' 11.0 in cap with
intersection of Mitchell &
Stover.

ALBERT A. WEBB ASSOCIATES CIVIL ENGINEERS RIVERSIDE, CALIFORNIA APPROVED BY: <i>[Signature]</i> DATE: 6-76 R.E. NO. 21884	MARK: _____ REVISIONS: _____ APPR. DATE: _____ DESIGNED BY: <i>[Signature]</i> DRAWN BY: <i>[Signature]</i> CHECKED BY: <i>[Signature]</i>	CITY OF RIVERSIDE, CALIFORNIA PUBLIC WORKS DEPARTMENT	STREET PLAN AND PROFILE STOVER AVENUE 370' TO 570' NLY OF ARLINGTON	INDEXED: <i>[Signature]</i> ACCOUNT NO. _____ DRAWING NUMBER R-1857
		APPROVED BY: <i>[Signature]</i> DATE: 2-4-76 PRINCIPAL ENGINEER PARK DEPARTMENT TRAFFIC DIVISION CHIEF PUBLIC WORKS ENGR.	APPROVED BY: <i>[Signature]</i> DIRECTOR OF PUBLIC WORKS	BUILDING PERMIT 6475 STOVER AVENUE

SCALE: HORIZ. 1" = 20' VERT. 1" = 4'