

DONALD AVENUE

ADMIRALTY AVENUE

STREET NAME & TRAFFIC SIGN SCHEDULE:

(A)	CALIFORNIA AVE.	9200
(B)	DONALD AVE.	4200
(C)	ADMIRALTY AVE.	9100
(D)	DONALD AVE.	4200
(E)	RT (STOP SIGN) 30' DIAGONAL	

CONST. JUNCTION STRUCTURE NO. 2
 PER. H.C.P.C. & W.C.D. STD. DWG. 3527
 10' x 10' x 10' ELEV. 9.21
 10' x 10' x 10' ELEV. 1.30
 10' x 10' x 10' ELEV. 2.10
 10' x 10' x 10' ELEV. 3.05
 10' x 10' x 10' ELEV. 3.99


NOTE: REMOVE EX. CATCH BASIN, PAVING AND PLUMB. EXIST. PIPES W/ PILING AND MORTARS AT ALL POINTS INDICATED TULLOCH & PARTIAL TO CURB. ELEV. 1.85, 1.85 & 2.05 PER CALIF. AVE. INT.

- GENERAL NOTES**
- IT SHALL BE THE RESPONSIBILITY OF THE CONTRACTOR TO CLEAR THE RIGHT OF WAY IN ACCORDANCE WITH THE PROVISIONS OF LAW AS IT AFFECTS EACH UTILITY INCLUDING IRRIGATION LINES AND APPURTENANCES AND AT NO COST TO THIS CITY.
 - CONSTRUCTION SHALL BE IN ACCORDANCE WITH THE CITY OF RIVERSIDE, DEPT. OF PUBLIC WORKS, STANDARD DRAWINGS, AND THE STANDARD SPECIFICATIONS FOR PUBLIC WORKS CONSTRUCTION, 1974 EDITION.
 - TOE EDGE OF EXISTING PAVEMENT WHERE NEW PAVING JOINS TO A SMOOTH STRAIGHT LINE, CONSTRUCT MATCH-UP PAVING AS SHOWN ON PLAN AND OVERLAY PAVING AS DIRECTED IN THE FIELD TO PRODUCE A SMOOTH SECTION. ENGINEER ESTIMATED OVERLAY TO BE 1/2" TO 1".
 - CONSTRUCT DRIVEWAY APPROACHES PER STD. DWG. 302. EXACT SIZE AND LOCATION TO BE DETERMINED AT THE TIME OF CONSTRUCTION AND APPROVED BY THE TRAFFIC ENGINEER.
 - CURB AND GUTTER, BE STAKED WITH 3" OFFSET AT 25' INTERVALS, EXCEPT WHERE OFFSET IS LESS THAN 25'. THE INTERVALS TO BE 12.5' AND TWO ROWS OF 8" REBAR SHALL BE PLACED IN GUTTER AND 3/4" DOWEL PINS AT ALL EXPANSION JOINTS.
 - ALL TRAFFIC SIGNS SHALL BE INSTALLED PRIOR TO OPENING THE STREETS TO TRAFFIC.
 - ALL FLAGGED ELEVATIONS SHALL BE STAKED IN THE FIELD BY THE PRIVATE ENGINEER.
 - 4' x 4' BLOCKOUTS FOR MAILBOXES REQUIRED IN CURB SIDEWALK.
 - NO PAVING SHALL BE INSTALLED IN THE STREETS PRIOR TO THE INSTALLATION OF ALL UTILITIES IN THE STREET UNLESS APPROVED BY THE DEPT. OF PUBLIC WORKS.
 - SEE "STREET LIGHTING PLAN" FOR QUANTITY AND LOCATION OF REQUIRED STREET LIGHTS.
 - THE CONTRACTOR SHALL CONTACT THE PUBLIC WORKS DEPT. (781-7251) TO PICK UP ANY EXISTING STD. 150 BARRICADES THAT ARE BEING REMOVED. THE CITY'S IMPACTOR WILL MAKE THE FINAL DETERMINATION ON WHETHER A BARRICADE MAY BE RELOCATED.

- CONSTRUCTION NOTES**
- CONSTRUCT P.C.C. CURB AND GUTTER PER STD. DWG. NO. 200, C.P.C. UNLESS OTHERWISE NOTED.
 - CONSTRUCT C.P.C. CURB SIDEWALK PER STD. DWG. NO. 325.
 - CONSTRUCT A.C. PAVING AND BASE MATERIAL AS INDICATED ON TYPICAL SECTION.
 - CONSTRUCT WHEELCHAIR RAMP PER STD. DWG. NO. 304.

CURVE DATA

NO.	RAD.	Δ	T	L
(1)	35.00	30° 00' 00"	35.00	54.98
(2)	200.00	29° 41' 23"	53.01	103.64
(3)	180.00	" "	47.71	93.71
(4)	210.00	" "	58.31	114.00
(5)	800.00	22° 44' 47"	79.87	156.75
(6)	280.00	" "	74.36	146.97
(7)	320.00	" "	84.99	166.14
(8)	47.00	30° 01' 58"	47.03	73.95
(9)	27.00	" "	27.04	44.43
(10)	100.00	10° 00' 00"	8.75	17.45
(11)	61.00	110° 01' 58"	" "	117.16

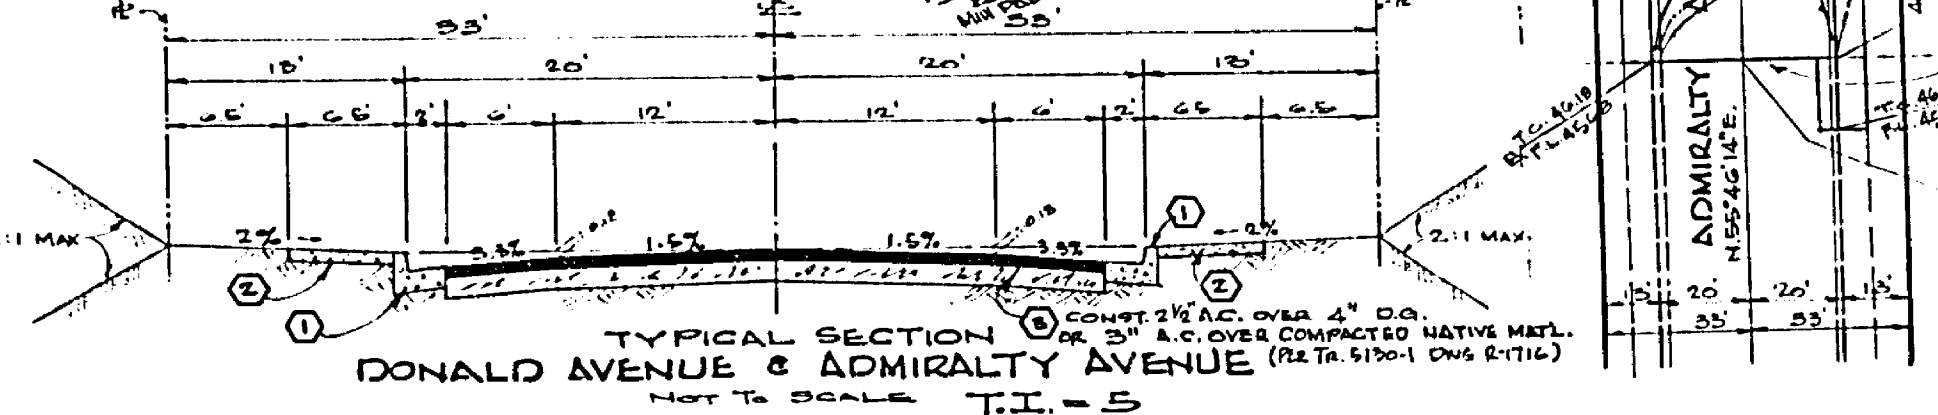

-CAUTION-
 PACIFIC TELEPHONE
 CABLES UNDERGROUND
 BEFORE EXCAVATING
 CALL COLLECT:
 7:30 A.M. to 5 P.M. After Hours & Holidays
 Orange County 714-633-0811 714-547-6606
 Riverside County 714-684-0071 714-547-6609
 Inyo County 714-684-0071 714-547-6609
 San Bernardino County 714-684-0071 714-547-6609
 Los Angeles County 714-621-3111 24 HOUR SERVICE
 Ventura County 714-621-3111 24 HOUR SERVICE
 San Diego County 714-728-4555 714-728-4527
 FOR FREE CABLE LOCATING SERVICE

BENCH MARK:
 TOP OF BRICK DICK STAMPED 64-5 IN
 CARVED MONUMENT AT MONROE ST. 10'
 NORTHWEST CORNER OF CALIFORNIA AVE.
 O/R. P.D. 705/44 ELEV. 754.925

ALBERT A. WEBB ASSOCIATES CIVIL ENGINEERS RIVERSIDE, CALIFORNIA APPROVED BY: <i>Albert A. Webb</i> DATE: 12/13/76 R.E. No. 2076 W.O. 78-19 FOR WOODHAVEN EXT. F.B. 1029	CITY OF RIVERSIDE, CALIFORNIA PUBLIC WORKS DEPARTMENT APPROVED BY: <i>[Signature]</i> DATE: 3-16-77 PRINCIPAL ENGINEER TRAFFIC DIVISION CHIEF PUBLIC WORKS ENGINEER	STREET PLAN AND PROFILE DONALD AVENUE ADMIRALTY AVENUE TRACT NO. 8868 (PERMITS: 5130)	ACCOUNT NO. DRAWING NUMBER R-1954 SHEET 1 OF 1 76-388A
		SCALE: HORIZ. 1"=40' VERT. 1"=4' DESIGNED BY: 12/13/76 DRAWN BY: D22 CHECKED BY: 12/13/76	DATE: 3-16-77