
DRAWING NUMBER	DRAWING TITLE	SHEET
	GENERAL	
	COVER SHEET	
K-OI	INDEX OF DRAWINGS	
K-02	RAILROAD GRADING NOTES / ABBREVIATIONS	
K-03	KEY MAP	
K-04	SURVEY CONTROL	
	CONSTRUCTION STAGING	
CS-01	CONSTRUCTION STAGING - STAGE & STAGE 2	
CS-02	CONSTRUCTION STAGING - STAGE 3 & STAGE 4	
CS-03	CONSTRUCTION STAGING - STAGE 5 & STAGE 6	
	CIVIL	
C-01	TYPICAL SECTIONS	
C-02	PLAN - JURUPA AVENUE "J" 95+00 TO "J" 100+00	
C-03	PLAN - JURUPA AVENUE "J" 100+00 TO "J" 105+00	
C-04	PLAN - JURUPA AVENUE "J" 105+00 TO "J" 110+00	
C-05	PLAN - JURUPA AVENUE "J" IIO+00 TO "J" II4+00	
C-06	PLAN - FLORENCE AND WILLIAM STREETS	
C-07	PROFILE - JURUPA AVE "J" 95+60 TO "J" 106+80	
C-08	PROFILE - JURUPA AVE "J" 106+80 TO "J" 1/4+00	
C-09	PROFILE - FLORENCE AND WILLIAM STREETS	
C-10	DRIVEWAY PROFILES	
C-11	PLAN AND PROFILE - DRIVEWAYS	
C-12	PLAN AND PROFILE - DRIVEWAYS	
C-/3	STREET IMPROVEMENT PLAN - SHEPPARD ST AND ANITA PL	
C-14	STREET IMPROVEMENT PLAN - MOUNTAIN VIEW AVENUE CIVIL DETAILS	
C-15 C-16	RETAINING WALL - LAYOUT PLAN	
C-16 C-17	RETAINING WALLS - FLORENCE STREET AND WILLIAM STREET	
C-17 C-18	NOT USED	
C-19	NOT USED	
C-20	PLAN - MARTHA MCLEAN ANZA NARROWS PARK	
C-21	PROFILE - PARK ENTRANCE ROAD	
C-22	ENTRANCE ROAD - CONSTRUCTION DETAILS	
DE-01	PLAN AND PROFILE - DETOUR ROAD	
DE-02	PLAN AND PROFILE - DETOUR ROAD	
	DRAINAGE	
SD-01 SD-02	PLAN AND PROFILE -STORM DRAIN SHT I PLAN AND PROFILE -STORM DRAIN SHT 2	
30 02		
	UTILITIES	
SS-01 SS-02	PLAN AND PROFILE - SANITARY SEWER SHT I PLAN AND PROFILE - SANITARY SEWER SHT 2	
	SIGNING AND STRIPING	
PD-01	SIGNING AND STRIPING - JURUPA AVE	
PD-02	SIGNING AND STRIPING - JURUPA AVE	
PD-03	SIGNING AND STRIPING - DETOUR ROAD	
PD-04	SIGNING AND STRIPING - DETOUR ROAD	
	TRACK	
RC-01	TYPICAL CROSS SECTIONS - SHEET I OF 3	
RC-02	TYPICAL CROSS SECTIONS - SHEET 2 OF 3	
		Ī

DRAWING NUMBER	DRAWING TITLE		
	TRACK (CONTINUED)		
RP-0I	SHOOFLY PLAN & PROFILE - MT2 2784+00 TO MT2 2795+00		
RP-02	SHOOFLY PLAN & PROFILE - MT2 2795+00 TO MT2 2806+00		
RP-03	SHOOFLY PLAN & PROFILE - MT2 2806+00 TO MT2 2817+00		
RP-04	SHOOFLY PLAN & PROFILE - ROHR SPUR TRACK - RSST 2+65.82 TO RSST 10+00		
RP-05	NOT USED		
RP-06	PLAN & PROFILE - REALIGNED ROHR SPUR TRACK - RRST 10+00 TO RRST 18+93		
RP-07	SHOOFLY TRACK - 701 PROFILE - MT2 2792+00 TO MT2 2814+00		
RP-08	PLAN & PROFILE - DRAIN PIPE AND RETAINING WALL		
RP-09	RETAINING WALL DETAILS		
RP-IO	FINAL MAIN TRACK I PROFILE - MT2 2792+00 TO MT2 2815+00		
RP-II	FINAL MAIN TRACK 2 PROFILE - MT2 2792+00 TO MT2 2815+00		
RP-I2	FINAL TRACK 701 PROFILE - MT2 2789+00 TO MT2 2812+00		
RP-I3	FINISHED PARK GRADING PLAN - MT2 2789+00 TO MT2 2801+00		
RP-I4	DELINEATION OF RAILROAD WORK		
RT-0I	GEOMETRY DATA - SHEET OF 2		
RT-02	GEOMETRY DATA - SHEET 2 OF 2		
RX-OI	TRACK CROSS-SECTIONS - MT2 2790+00 TO MT2 2797+00		
RX-02	TRACK CROSS-SECTIONS - MT2 2798+00 TO MT2 2805+00		
RX-03	TRACK CROSS-SECTIONS - MT2 2806+00 TO MT2 2811+00		
RX-04	TRACK CROSS-SECTIONS - RSST 3+00 TO RSST 10+00		
RX-05	TRACK CROSS-SECTIONS - RRST 10+00 TO RRST 17+00		
RX-06	FINISHED PARK GRADING - CROSS SECTIONS - MT2 2790+10 TO MT2 2797+50		
	STRUCTURAL		
	JURUPA AVENUE UNDERPASS		
S-0I	GENERAL PLAN		
S-02	GENERAL STRUCTURAL NOTES		
S-03	PAY LIMITS		
S-04	FOUNDATION PLAN		
S-05	ABUTMENT I LAYOUT		
S-06	ABUTMENT 5 LAYOUT		
S-07	ABUTMENT DETAILS NO. I	F	
S-08	ABUTMENT DETAILS NO. 2		
S-09	ABUTMENT DETAILS NO. 3		
S-10	ABUTMENT DETAILS NO. 4		
S-//	BENT DETALS NO. 1		
S-12 S-13	BENT DETALS NO.2 GIRDER LAYOUT - SPANS / & 2		
5-13 S-14	GIRDER LAYOUT - SPANS 7 & 2		
S-15	GIRDER DETALS NO. I		
S-16	GIRDER DETALS NO. 2		
S-17	TYPICAL SECTION AND DECK REINFORCEMENT		
S-18	DECK DETAILS		
S-19	COLUMN/CAST-IN-DRILLED HOLE CONCRETE PILE DETAILS		
S-20	DECK DRAINAGE DETAILS		
S-2/	STRUCTURE APPROACH DETAILS		
S-22	STRUCTURE APPROACH DRAINAGE DETAILS		
S-23	WATERPROOFING DETAIL		
S-24	HAND RAILING DETAILS		
S-25	SLOPE PAVING DETAILS		
S-26	MISCELLANEOUS DETAILS		
	GEOTECHNICAL		
B-0/	LOG OF TEST BORINGS - SHEET I OF 2		
B-02	LOG OF TEST BORINGS - SHEET 2 OF 2		

DRAWING NUMBER	DRAWING TITLE	SHEET	
	LANDSCAPING & IRRIGATION		
L-I	TITLE SHEET		
TR-I	TREE RETENTION PLAN		
TR-2	TREE RETENTION PLAN		
CD-I	CONSTRUCTION DETAILS		
CD-2	MEDIAN ENLARGEMENT		
1-1	IRRIGATION PLAN		
1-2	IRRIGATION PLAN		
/-3	IRRIGATION PLAN		
1-4	IRRIGATION PLAN		
<i>l-</i> 5	IRRIGATION PLAN		
<i>I-</i> 6	IRRIGATION LEGEND & DETAILS		
<i>I-</i> 7	IRRIGATION DETAILS		
<i>I-8</i>	IRRIGATION NOTES		
<i>I-9</i>	IRRIGATION NOTES		
1-10	IRRIGATION NOTES		
P-I	PLANTING PLAN		
P-2	PLANTING PLAN		
P-3	PLANTING PLAN		
P-4	PLANTING PLAN		
P-5	PLANTING PLAN		
P-6	PLANTING PLAN		
P-7	PLANTING DETAILS		
	ROADWAY CROSS SECTION		
CX-OI	CROSS SECTIONS - JURUPA AVENUE		
CX-02	CROSS SECTIONS - JURUPA AVENUE		
CX-03	CROSS SECTIONS - JURUPA AVENUE		
CX-04	CROSS SECTIONS - JURUPA AVENUE		
CX-05	CROSS SECTIONS - JURUPA AVENUE		
CX-06	CROSS SECTIONS - JURUPA AVENUE		
CX-07	CROSS SECTIONS - JURUPA AVENUE	•	
CX-08	CROSS SECTIONS - JURUPA AVENUE		
CX-09	CROSS SECTIONS - FLORENCE STREET		
CX-10	CROSS SECTIONS - PROPOSED WILLIAM STREET		
	TRAFFIC SIGNAL		
X-436	JURUPA AVENUE AT FLORENCE STREET		
	WATER		
D5-0701612-1	12" WATER MAIN RELOCATION		
D5-0701612-2	12" WATER MAIN RELOCATION		
D5-0701612-3	12" WATER MAIN RELOCATION		
	ELECTRIC		
-070015-01	UNDERGROUND ELECTRIC STRUCTURES AND SHOOFLY - SHEET I OF 3		
-0700/5-0/	UNDERGROUND ELECTRIC STRUCTURES AND SHOOFLY - SHEET 2 OF 3		
-070015-01	UNDERGROUND ELECTRIC STRUCTURES AND SHOOFLY - SHEET 3 OF 3		
	STREET LIGHTING		
	JURUPA UNDERPASS STREET LIGHTING - SHEET I OF 2		
;-07002I-I	STATE TO STALL TO STALL TO		
-07002I-I -07002I-I	JURUPA UNDERPASS STREET LIGHTING - SHEET 2 OF 2		

AS BUILT 1-20-10

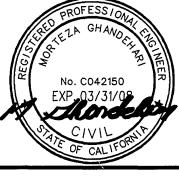

			CITY OF PUBLIC
			APPROVED BY
TRACKWORK BY CIVIL CONTRACTOR	MG	12/5/06	PRINCIPAL ENGINEER CONST. CONTRACT ADMIN
REVISIONS	APPR.	DATE	STREET SERVICES SURVEYOR
IED BY PM DRAWN BY SR CHECKED BY	Υ	LP	TRAFFIC DIVISION PARKS DEPARTMENT

CITY OF RIVERSIDE, CALIFORNIA
PUBLIC WORKS DEPARTMENT

JURUPA AVENUE UNDERPASS PHASE 11 CONSTRUCTION R-3634 K-01 INDEX OF DRAWINGS

OCTOBER 9, 2006

DMJM HARRIS | AECOM

999 Town & Country Road
0range, CA 92868
T 714.567.2501 F 714.567.2441

SCALE: NONE

GENERAL NOTES FOR RAILROAD GRADING

- I. CONTRACTOR SHALL COMPLY WITH ALL LOCAL, STATE, AND FEDERAL SAFETY CODES AND REGULATIONS AND THE SPECIFICATIONS FOR THIS CONTRACT.
- 2. ALL CONSTRUCTION ACTIVITIES SHALL BE SCHEDULED AND COORDINATED THROUGH THE ENGINEER, INCLUDING THE VARIOUS COMPANIES, AGENCIES AND OTHER CONTRACTORS WHO MAY BE AFFECTED BY THIS WORK. ALL REQUIRED PERMITS INCLUDING RAILROAD RIGHT-OF-ENTRY PERMITS NEEDED FOR THE WORK SHALL BE OBTAINED BY THE CONTRACTOR UNLESS OTHERWISE NOTED. THE CONTRACTOR SHALL COMPLY WITH ALL RAILROAD OCCUPANCY REQUIREMENTS INCLUDING INSURANCE REQUIREMENTS AND USE OF AND PAYMENT FOR RAILROAD FLAGMEN.
- 3. HORIZONTAL AND VERTICAL CONTROL POINTS FOR THE TRACK LAYOUT ARE IDENTIFIED IN THE CONTRACT DOCUMENTS. IT SHALL BE THE CONTRACTOR'S RESPONSIBILITY TO UTILIZE THESE CONTROL POINTS TO ASSURE THAT ALL FACILITIES INCLUDED IN THIS PROJECT ARE CONSTRUCTED AT THE CORRECT VERTICAL AND HORIZONTAL LOCATIONS.
- 4. THE UNION PACIFIC RAILROAD (UPRR) WILL CONSTRUCT ALL TRACKWORK. TRACKWORK DONE BY UPRR WILL INCLUDE ALL MATERIAL ABOVE THE TOP OF THE SUBBALLAST. THE CONTRACTOR IS RESPONSIBLE FOR ALL GRADING WORK BELOW THE TOP OF SUBBALLAST. GRADING WORK CONSISTS OF SUBGRADE PREPARATION AND PLACEMENT OF SUBBALLAST TO GRADES INDICATED ON THE PLANS.
- 5. SUBGRADE BELOW A TRACK (I.E.WITHIN 14'OF THE CENTERLINE OF A TRACK), SHALL BE COMPACTED TO 95% OF THE MAXIMUM PROCTOR DENSITY. ALL OTHER SUBGRADE WORK SHALL BE COMPACTED TO A MINIMUM OF 90% OF THE MAXIMUM PROCTOR DENSITY.
- 6. NOT USED
- 7. POSITIVE DRAINAGE MUST BE MAINTAINED AT ALL TIMES DURING CONSTRUCTION TO PREVENT PONDING OF WATER.
- 8. THE CONTRACTOR SHALL COMPLY WITH THE STATE OF CALIFORNIA NPDES PERMIT REGARDING THE TREATMENT OF WATER BEFORE DISCHARGING OFF OF UPRR R/W.
- 9. SECTION 4216/4217 OF THE GOVERNMENT CODE REQUIRES A DIG ALERT IDENTIFICATION NUMBER BE ISSUED BEFORE A "PERMIT TO EXCAVATE" IS VALID. THE CONTRACTOR SHALL CALL THE UNDERGROUND SERVICE ALERT (I-800-422-4133) TWO WORKING DAYS PRIOR TO CONSTRUCTION TO OBTAIN A DIG ALERT ID NUMBER. THE CONTRACTOR SHALL BE RESPONSIBLE FOR PROTECTING THE FIBER OPTIC LINES.
- IO. THE CONTRACTOR SHALL BECOME FAMILIAR WITH LEGISLATION OUTLINING PROCEDURES FOR LOCATING UTILITIES BY HAND EXCAVATION AND COMPLY WITH ITS DIRECTIVE.
- II. PRIOR TO EACH CONSTRUCTION ACTIVITY WITHIN UPRR RIGHT-OF-WAY, THE CONTRACTOR SHALL NOTIFY UPRR'S SIGNAL REPRESENTATIVE.
- 12. THE CONTRACTOR SHALL PROTECT ALL UPRR SIGNAL FACILITIES IN PLACE.
- 13. THE CONTRACTOR SHALL FIELD VERIFY ALL DIMENSIONS FOR CONFLICTS WITH EXISTING UTILITIES, SIGNAL CABLES / EQUIPMENT AND/OR OTHER ITEMS THAT MIGHT IMPAIR CONSTRUCTION ACTIVITIES. INCONSISTENCIES FOUND SHALL BE REPORTED TO THE ENGINEER.
- 14. REPAIRS TO FACILITIES INTENDED TO REMAIN IN PLACE SHALL BE MADE BY THE CONTRACTOR AT THE CONTRACTOR'S EXPENSE UNLESS OTHERWISE STATED BY THE ENGINEER.
- 15. ALL EXCAVATED WASTE MATERIAL SHALL BE IMMEDIATELY REMOVED FROM THE SITE. ONSITE STORAGE OF EXCAVATED WASTE MATERIAL SHALL NOT BE PERMITTED AT ANY TIME.
- 16. ON-SITE CONSTRUCTION BY OTHERS, INCLUDING ROUTINE MAINTENANCE WORK, (UPRR FORCES, UPRR SIGNAL CONTRACTOR, SCRRA, FIBER OPTIC, UTILITIES, ETC.) MAY OCCUR DURING THE CONSTRUCTION PERIOD OF THIS CONTRACT. THE CONTRACTOR SHALL COORDINATE CONSTRUCTION ACTIVITIES THROUGH THE ENGINEER SO AS TO MINIMIZE INTERFERENCE WITH OTHERS.
- 17. PRIOR TO COMMENCING WORK, ALL EXISTING SITE CONDITIONS SHALL BE FIELD VERIFIED WITH THE ENGINEER TO ASCERTAIN
 THE LIMITS OF WORK ACTIVITIES. THE CONTRACTOR SHALL SUBMIT AND RECEIVE THE ENGINEER'S APPROVAL OF THE CONTRACTORS PROJECT
 SCHEDULE AND OPERATIONS PLAN. EACH ITEM OF WORK SHALL BE DESCRIBED AND ACCOUNTED FOR IN THE CONTRACT DOCUMENTS. THE
 CONTRACTOR SHALL REFER TO THE SPECIFICATIONS FOR FURTHER INFORMATION REGARDING SUBMITTAL REQUIREMENTS.
- 18. RAIL TRAFFIC DISRUPTIONS SHALL BE KEPT TO A MINIMUM.DISRUPTIONS IN RAIL TRAFFIC THAT MAY BE REQUIRED SHALL BE COORDINATED WITH THE ENGINEER BEFOREHAND.NO SUCH WORK SHALL BE COMMENCED WITHOUT THE ENGINEER'S APPROVAL.WORK AFFECTING THE MOVEMENT OF TRAINS WILL BE UNDER THE AUTHORITY AND OVERALL CONTROL OF THE ENGINEER OR HIS REPRESENTATIVE. SCRRA COMMUTER TRAIN OPERATIONS AND UPRR FREIGHT TRAFFIC MUST BE MAINTAINED THROUGHOUT THE CONSTRUCTION PERIOD.
- 19. THE CONTRACTOR SHALL NOT PLACE MATERIAL AND/OR EQUIPMENT WITHIN 25 FEET OF AN ACTIVE TRACK AT ANY TIME WITHOUT PRIOR APPROVAL OF THE ENGINEER.
- 20. EXISTING RAILROAD SIGNAGE (INCLUDING SPEED SIGNS) SHALL BE MAINTAINED DURING THE CONSTRUCTION PERIOD.ALL RAILROAD SIGNAGE SHALL BE FULLY RESTORED UPON COMPLETION OF EACH DAYS WORK IN ACCORDANCE WITH UPRR ENGINEERING STANDARDS. PRIOR TO CONSTRUCTION, BNSF STANDARD PROJECT NOTICE SIGNS SHALL BE PLACED AT LOCATIONS AS DIRECTED BY THE ENGINEER. NO TRESPASSING SIGNS SHALL BE PLACED IN ACCORDANCE WITH UPRR STD DWG 0538A AND AS SHOWN ON THE DRAWINGS.
- 21. ALL WORK SHALL BE COORDINATED WITH UPRR'S SIGNAL ENGINEER, SIGNAL FORCES AND SIGNAL CONTRACTOR THRU THE ENGINEER.
 WORK WILL BE PHASED TO EFFECT THE CONTINUED OPERATION OF EXISTING SIGNAL SYSTEM DURING CONSTRUCTION. IN NO INSTANCE
 MAY WORK PROCEED IN ANY AREA WITHOUT ADVANCE APPROVAL OF UPRR'S SIGNAL ENGINEER. THE CONTRACTOR SHALL LOCATE ALL
 SIGNAL AND COMMUNICATION CONDUITS, CABLES, WIRES, OR OTHER TRACK, TRACK BED, AND RIGHT-OF-WAY.
- 22. WALKWAYS SHALL BE PLACED AS REQUIRED BY CALIFORNIA PUBLIC UTILITIES COMMISSION GENERAL ORDER NO.118 AND 26D FOR ALL NEW CONSTRUCTION, UNLESS NOTED OTHERWISE.
- 23. DIMENSIONS SHOWN IN PARENTHESES INDICATE APPROXIMATE EXISTING DIMENSIONS. WHERE ELEVATIONS ARE SHOWN IN PARENTHESES AT JOIN LOCATIONS, THE CONTRACTOR SHALL VERIFY THESE ELEVATIONS PRIOR TO CONSTRUCTION AND JOIN FEATURES AT EXISTING ELEVATIONS.

DEFINITIONS:

A.TRACK OUTAGE: TRACK WHICH IS OUT OF SERVICE FOR A GIVEN PERIOD OF TIME.

B.ACTIVE TRACK: TRACK ON WHICH TRAINS ARE OPERATING AND INTERRUPTION OF SERVICE MAY OCCUR ONLY WITHIN AN APPROVED "WINDOW". AS DEFINED BELOW.


C.FOULED TRACK: TRACK IS FOULED WHEN AN OBSTRUCTION INCLUDING A WORKING CREW, IS WITHIN 25 FEET FROM THE CENTERLINE
OF THE TRACK OR WHEN AN OVERHEAD OBSTRUCTION IS PLACED WITHIN 22'-6" ABOVE THE TOP OF RAIL WORK MAY BE
PERFORMED UNDER THE PROTECTION OF A RAILROAD FLAGMAN.

D.WINDOW: A GIVEN PERIOD OF TIME BETWEEN OPERATING TRAINS WHERE A TRACK MAY BE TAKEN OUT OF SERVICE, WITH THE STIPULATION THAT THE TRACK SHALL BE BACK IN SERVICE AT THE END OF THE GIVEN PERIOD OF TIME.

ABBREVIATIONS:


&	AND	MAINT	MAINTENANCE
@	AT DECREE(S)	M/L MED	MAINLINE
ф	DEGREE(S) DIAMETER	MFR MAX	MANUFACTURER MAXIMUM
,	FOOT or FEET or MINUTE(S)	MIN	MINIMUM
•/	INCH or INCHES or SECOND(S)	MP	MILEPOST
% #	PERCENT POUND or NUMBER	MPH	MILES PER HOUR
		N	NORTH or NORTHERLY or NORTHING
ABT ABUT	ABOUT ABUTMENT	NF NO	NEAR FACE NUMBER or NORTHERN
ABOT AC	ASPHALT CONCRETE	NIC NIC	NOT IN CONTRACT
ADD'L	ADDITIONAL	NTS	NOT TO SCALE
ALT APPROX	ALTERNATE APPROXIMATELY	OC	ON CENTER
APWA	AMERICAN PUBLIC WORKS ASSOCIATION	OG OG	ORIGINAL GROUND
ASTM	AMERICAN SOCIETY FOR TESTING	OTM	OTHER TRACK MATERIAL
AVE	AND MATERIALS AVENUE	PB	PULLBOX
		PCC	PORTLAND CEMENT CONCRETE or
BC	BEGIN CURVE	DO	POINT OF COMPOUND CURVATURE
BK BVC	BACK BEGIN VERTICAL CURVE	PC PG	POINT OF CURVATURE PROFILE GRADE
BW	BACK OF WALK (SIDEWALK)	PL	<i>PLACE</i>
CALTRANS	STATE OF CALIFORNIA	PL PL PL	PLATE PROPERTY LINE
CALITANS	DEPARTMENT OF TRANSPORTATION	POB	POINT OF BEGINNING
CB	CATCH BASIN	POC	POINT OF CURVE
CIP CIDH	CAST IRON PIPE CAST-IN-DRILLED-HOLE	POE POT	POINT OF ENDING POINT ON TANGENT
CAL	CALIFORNIA	POVC	POINT ON VERTICAL CURVE
C-C	CENTER-TO-CENTER	PRC	POINT OF REVERSE CURVATURE
CF C/L or ©	CURB FACE CENTERLINE	PROP PSI	PROPOSED POUNDS PER SQUARE INCH
CLR	CLEAR	PT	POINT OF TANGENCY
CMP CORR	CORRUGATED METAL PIPE CORRUGATED	PVC	POLY VINYL CHLORIDE or POINT OF VERTICAL CURVATURE
CONST	CONSTRUCTION	PVCC	POINT OF VERTICAL COMPOUND CURVATURE
CONST JT	CONSTRUCTION JOINT	PVI	POINT OF VERTICAL INTERSECTION
CP CPUC or PUC	CONTROL POINT CALIFORNIA PUBLIC UTILITIES COMMISSION	PVRC PVT	POINT OF VERTICAL REVERSE CURVATURE POINT OF VERTICAL TANGENCY
CRSI	CONCRETE REINFORCING STEEL INSTITUTE		
CL or CTR(s)	CENTER(S)	RC BOX	REINFORCED CONCRETE BOX
DGAC	DENSE GRADE ASPHALT CONCRETE	REINF RH	REINFORCEMENT RIGHT HAND
DESC	DESCRIPTION	RT	RIGHT
DIA DOT	DIAMETER DEPARTMENT OF TRANSPORTATION	R/W RCP	RIGHT-OF-WAY REINFORCED CONCRETE PIPE
DWG	DRAWING	RR	RAILROAD
E	EAST OF EASTERLY OF EASTING	S	SOUTH or SOUTHERLY
E EC	EAST or EASTERLY or EASTING END CURVE	SCRRA	SOUTHERN CALIFORNIA
EL or ELEV	ELEVATION		REGIONAL RAIL AUTHORITY
EP EPDM	EDGE OF PAVEMENT ETHYLENE-PROPYLENE-DIENE-MONOMERS	SD SDMH	STORM DRAIN STORM DRAIN MANHOLE
EQ	EQUAL	SQ	SQUARE
EVC EV or EVIST	END VERTICAL CURVE	SO SSULI	SOUTHERN SANITARY SEWER MANHOLE
EX or EXIST	EXISTING	SSMH ST	STREET
FF.	FAR FACE	STA	STATION
FL F0B	FLOWLINE FREIGHT ON BOARD	STD SWK	ST ANDARD SIDEWALK
FT	FOOT or FEET	SYMM	SYMMETRICAL
FTG	FOOTING	TANSAT	TOW-AWAY NO STOPPING ANY TIME
G	GRADE	T ANSAT TC	TRACK CENTER(S) or TOP OF CURB
GB	GRADE BREAK	TF	TRACK FEET or TRACK FOOT
ga GALV	GAGE GALVANIZED	T/R TRK	TOP OF RAIL TRACK
GV	GAS VALVE	<i>TW</i>	TOP OF WALL
ப	HEICHT	TYP	TYPICAL
H HORIZ	HEIGHT HORIZONTAL	UD	UNDERDRAIN
		UP	UNDERPASS
ID IN	INSIDE DIAMETER INCH or INCHES	UPRR	UNION PACIFIC RAILROAD
/NV	INVERT	VAR	VARIES or VARIABLE
,	IENCTU	VC VCB	VERTICAL CURVE
LB LB	LENGTH POUND	VCP VERT	VITRIFIED CLAY PIPE VERTICAL
LH	LEFT HAND		
LOL LT	LAYOUT LINE LEFT	W W/	WEST or WESTERLY WITH
LI	tradium 1 1	WV	WATER VALVE
		X	BY
		XINĜ	CROSSING

		AS BUILT 1-20-10		
PATTERSON 725 TOWN & COUNTRY ROAD & SULTE ROAD	PROFESS / ONAL	CITY OF RIVERSIDE, CALIFORNIA	JURUPA AVENUE UNDERPASS	
ASSOCIATES, INC. ORANGE CA 92868 WITH 300 ORANGE CA 92868	SON NEED NEED NEED NEED NEED NEED NEED NE	PUBLIC WORKS DEPARTMENT APPROVED BY BY DATE APPROVED BY	PHASE II CONSTRUCTION	R-3634
DMJM HARRIS AECOM	No. C042150 EXP. 03/31/08	PRINCIPAL ENGINEER PM 12/100 CONST. CONTRACT ADMIN De 10/17/00 STREET SERVICES 19/12 1/6/06	RAILROAD GRADING NOTES / ABBREVIATIONS	K-02
999 Town & Country Road Orange, CA 92868 T 714.567.2501 F 714.567.2441	OF CALIFORNY	STREET SERVICES 19/2 1/6/06 SURVEYOR	SCALE: NONE	OCTOBER 9, 20

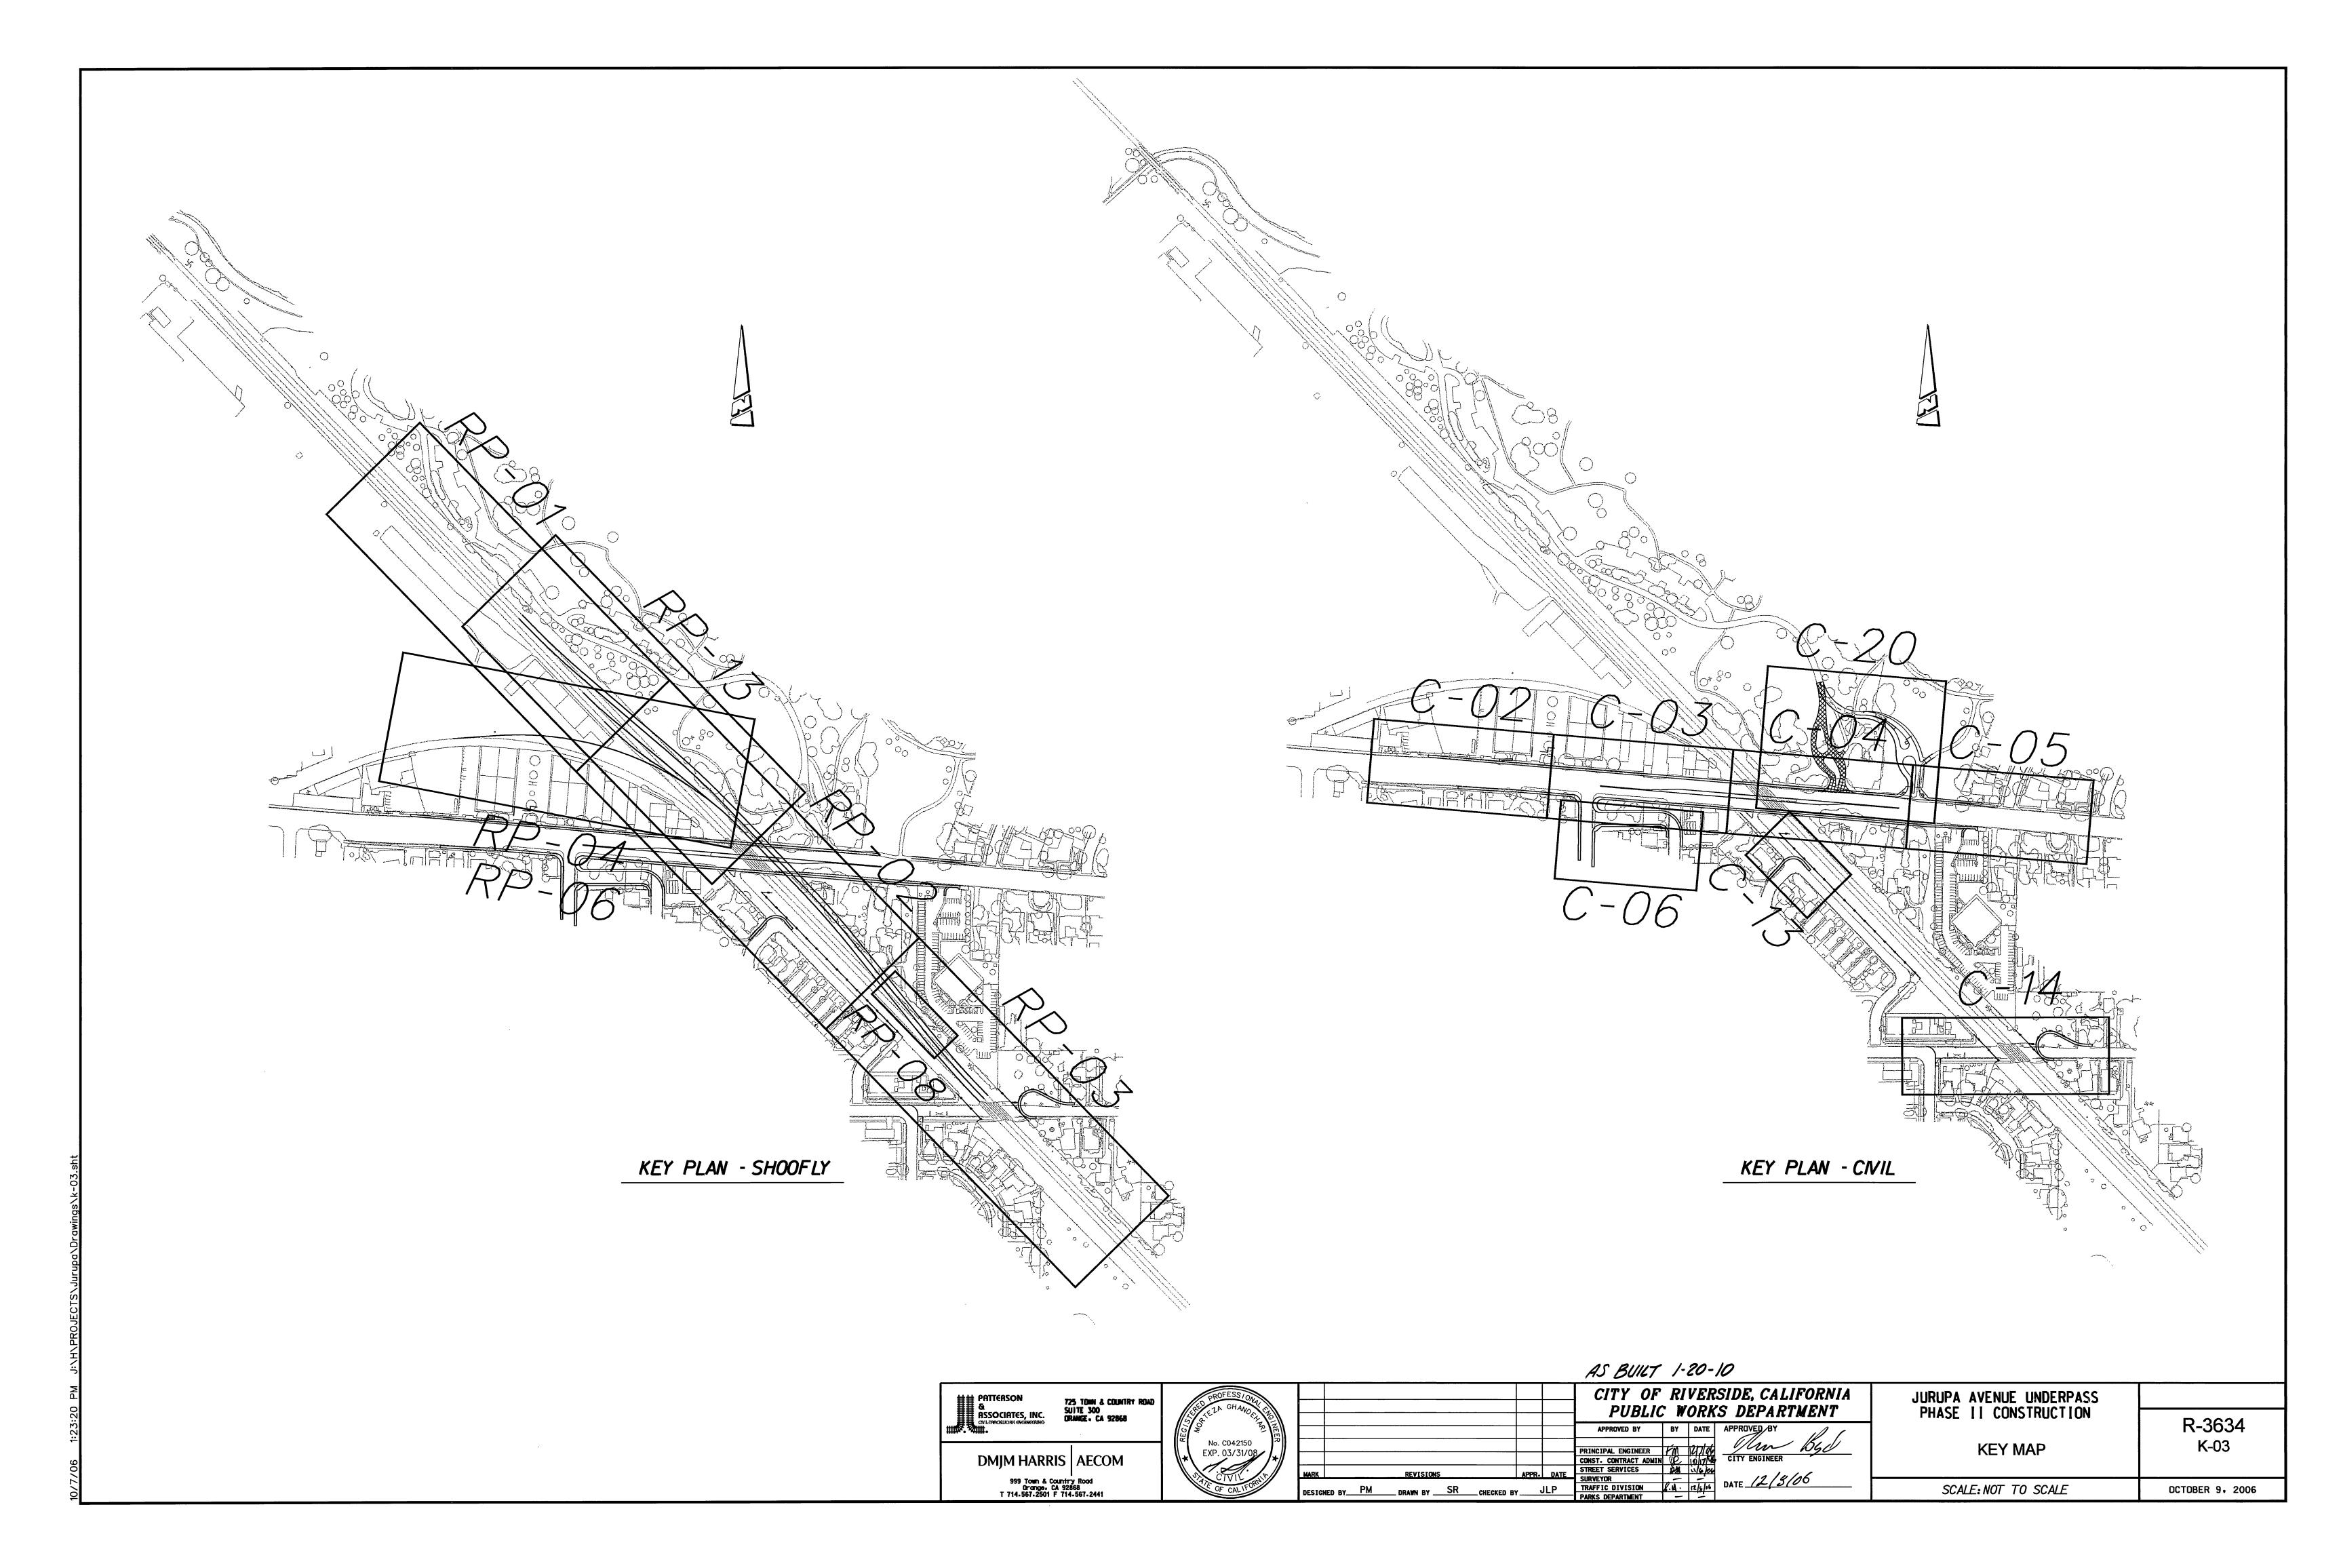

BENCH MARKS:

POINT	ELEVATION	DESCRIPTION
H4-C3	790.277	P.K.NAIL AND CITY ENGINEER TAG IN THE BASE OF A TRAFFIC SIGNAL AT THE NORTHWEST CURB RETURN OF JURUPA AVENUE AND FREMONT STREET (THE RETURN BETWEEN FREMONT ATREET AND COLUMBUS STREET).
H5-G3	787.253	P.K.NAIL AND CITY ENGINEER TAG IN THE SOUTHERLY CORNER OF A CATCH BASIN ALONG THE NORTHERLY CURB OF GRAND AVENUE,90 FEET NORTHEASTERLY OF THE INTERSECTION OF GRAND AVENUE AND STREETER AVENUE.
GPS-0059	769.94	IN THE SOUTH SIDE OF JURUPA AVE OPPOSITE ANZA PARK AND .5 MILES EAST OF VAN BUREN

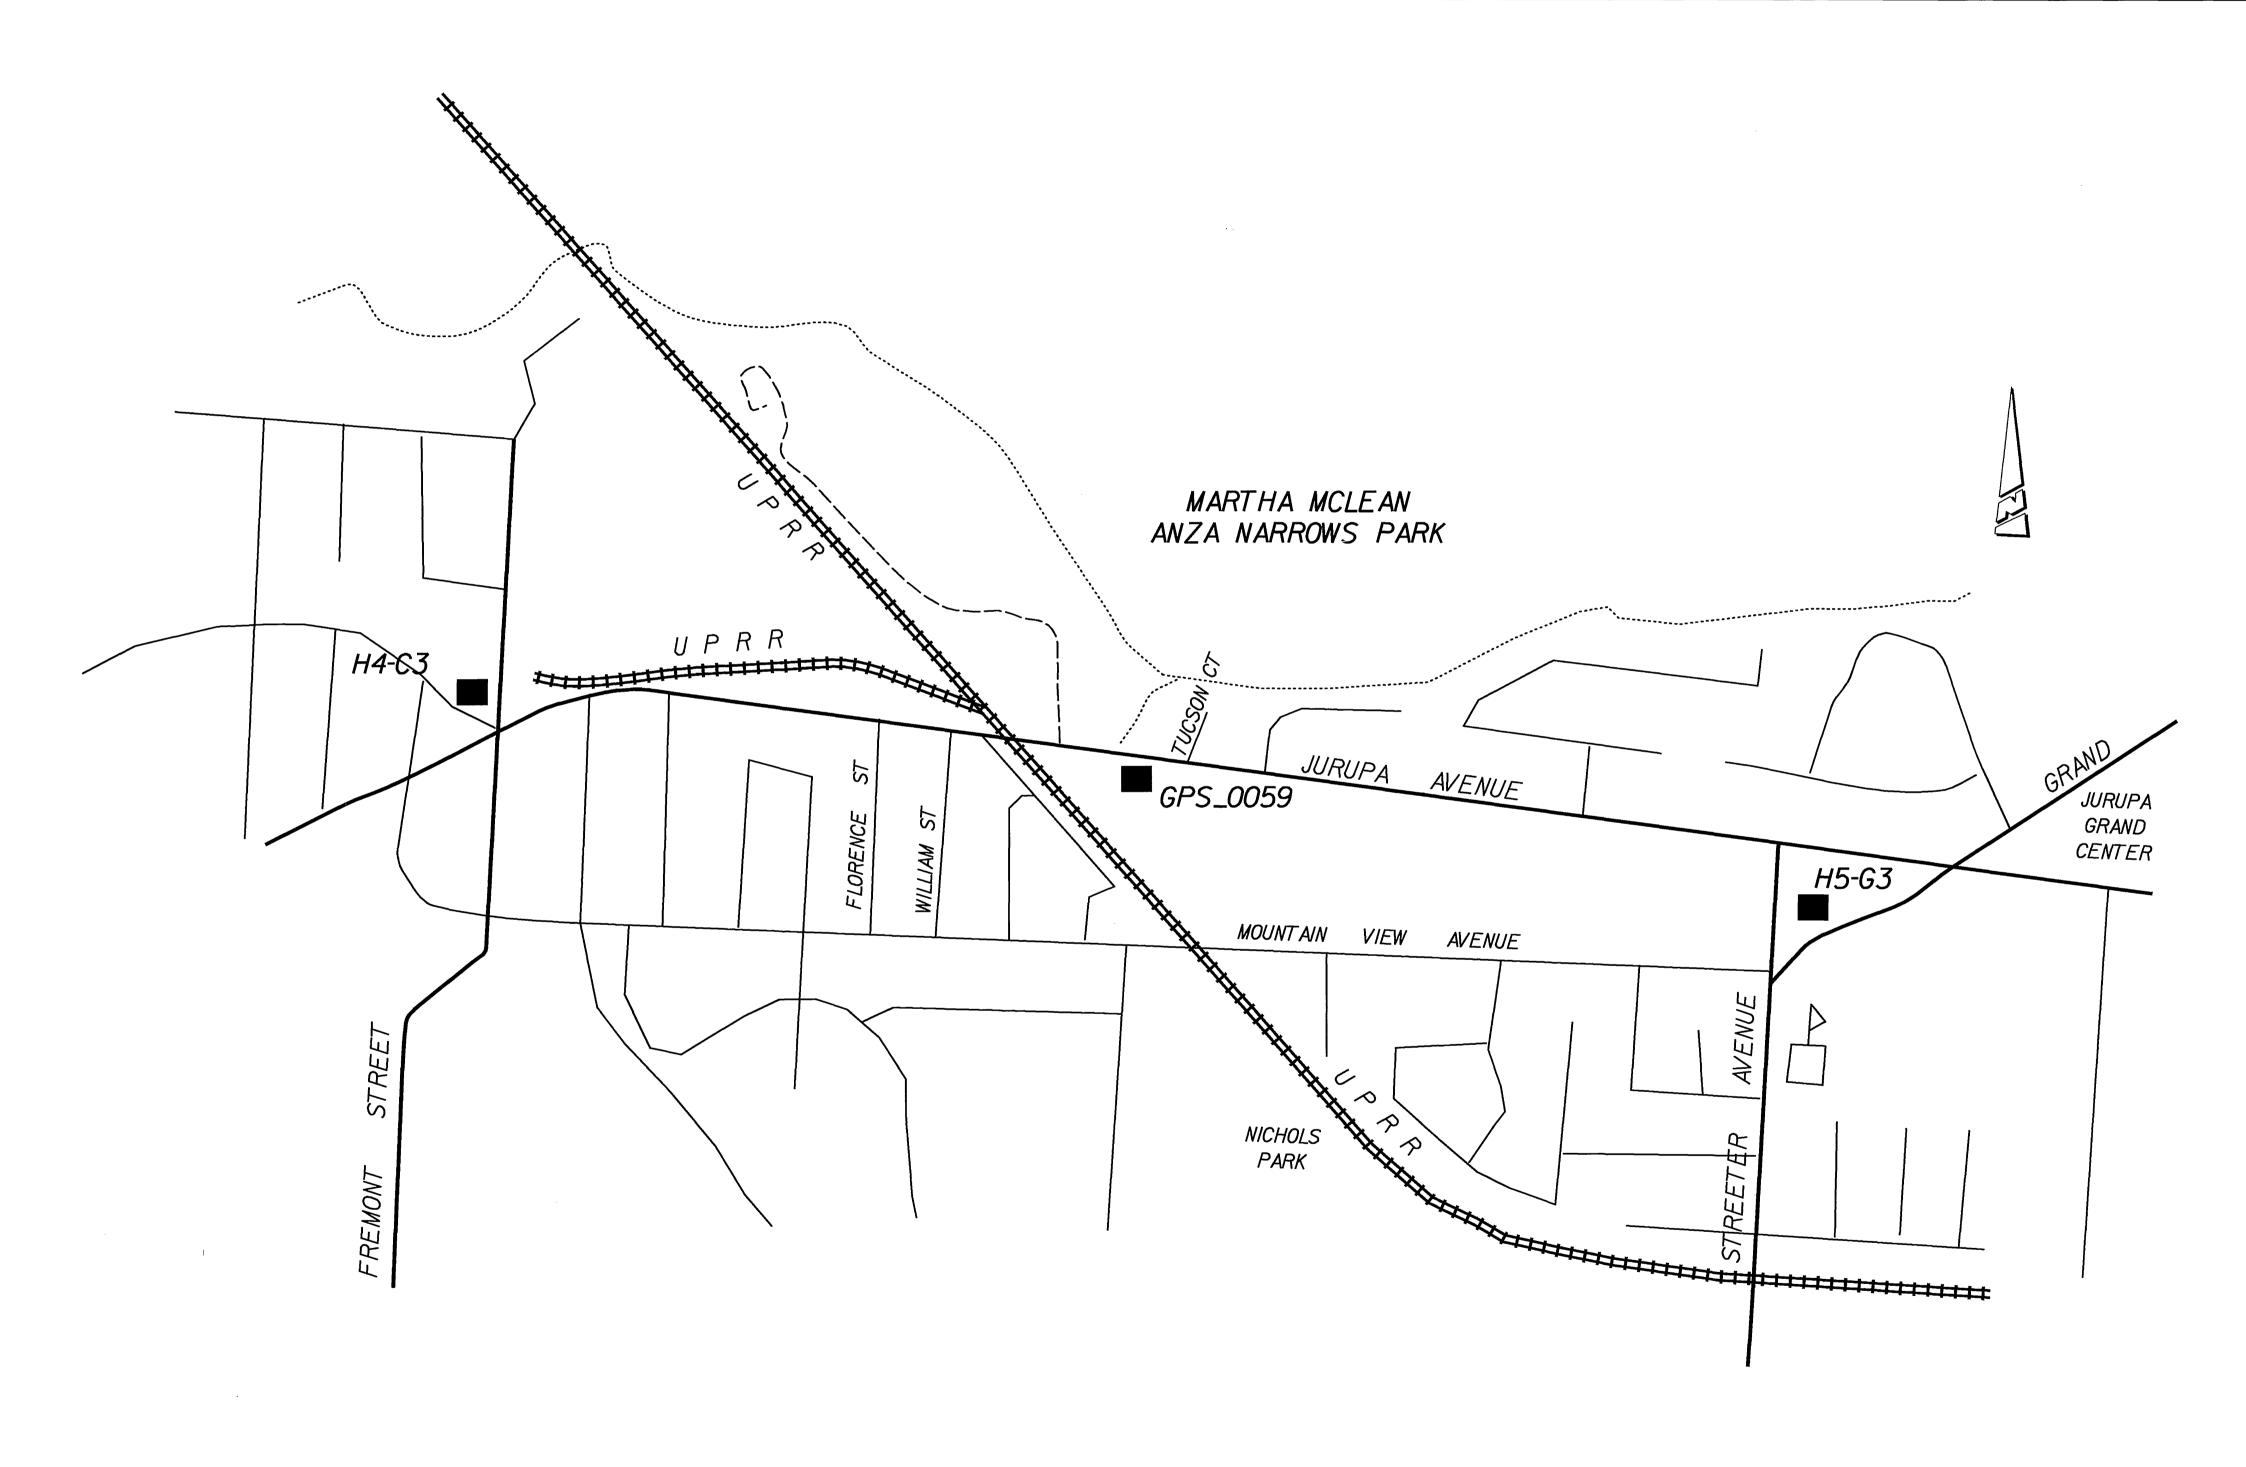

AS BUILT 1-20-10

PATTERSON 725 TOWN & COUNTRY ROAD SUITE 300 ORANGE. CA 92868	PROFESSIONAL CHEST OF THE PROFESSION OF THE PROF		CITY OF RIVERSIDE, CALIFORNIA PUBLIC WORKS DEPARTMENT	JURUPA AVENUE UNDERPASS PHASE II CONSTRUCTION	D 2624
DMJM HARRIS AECOM	No. C042150 EXP. 03/31/08		PRINCIPAL ENGINEER PRINCIPAL ENGINEER CONTROL CONTRACT ADMIN CONTROL CITY ENGINEER CONTROL CERTIFICATION CONTROL CO	SURVEY CONTROL	R-3634 K-04
999 Town & Country Road Orange, CA 92868 T 714.567.2501 F 714.567.2441	STATE OF CALIFORNIE	MARK REVISIONS APPR. DATE DESIGNED BY PM DRAWN BY SR CHECKED BY JLP	STREET SERVICES DAY 16/06 SURVEYOR DATE /2/9/06 TRAFFIC DIVISION PARKS DEPARTMENT	SCALE: NOT TO SCALE	OCTOBER 9. 2006

::42 PM J:\H\PROJECTS\Jurupa\Dra