
GENERAL NOTES

- NO PERSON SHALL PERFORM ANY CONSTRUCTION ACTIVITY OR INSTALL ANY OBJECTS WITHIN THE PUBLIC RIGHTS-OF-WAY OR EASEMENTS OF THE CITY OF RIVERSIDE WITHOUT A VALID CONSTRUCTION PERMIT OR, A STREET OPENING PERMIT OR AN ENCROACHMENT PERMIT ISSUED BY THE CITY'S PUBLIC WORKS DEPARTMENT
- IT SHALL BE THE RESPONSIBILITY OF THE CONTRACTOR TO CLEAR THE RIGHT OF WAY IN ACCORDANCE WITH THE PROVISIONS OF LAW AS IT AFFECTS EACH UTILITY INCLUDING IRRIGATION LINES AND APPURTENANCES AND AT NO COST TO THE CITY.
- CONSTRUCTION SHALL BE IN ACCORDANCE WITH THE CITY OF RIVERSIDE DEPARTMENT OF PUBLIC WORKS, STANDARD DRAWINGS, ITS SUPPLEMENTAL NOTES AND THE STANDARD SPECIFICATIONS FOR PUBLIC WORKS CONSTRUCTION, CURRENT EDITION.
- THE PRIVATE ENGINEER SIGNING THESE PLANS IS RESPONSIBLE FOR ASSURING THE ACCURACY AND ACCEPTABILITY OF THE WORK HEREON. IN THE EVENT OF DISCREPANCIES ARISING DURING CONSTRUCTION, THE PRIVATE ENGINEER SHALL BE RESPONSIBLE FOR DETERMINING AN ACCEPTABLE SOLUTION AND REVISING THE PLANS FOR APPROVAL BY THE CITY.
- QUANTITIES SHOWN ARE FOR INFORMATION ONLY AND THE CITY OF RIVERSIDE IS NOT RESPONSIBLE FOR THEIR ACCURACY.
- THE DEVELOPER SHALL BE RESPONSIBLE FOR PRESERVING OR RE-ESTABLISHING AND REFERENCING SURVEY MONUMENTS DESTROYED, DISTURBED, OR BURIED AS A RESULT OF CONSTRUCTION SHOWN HEREON
- '. SEE "STREET LIGHTING PLANS" FOR QUANTITY AND LOCATION OF REQUIRED STREET LIGHTS
- 3. ALL FLAGGED ELEVATIONS SHALL BE STAKED IN THE FIELD BY THE PRIVATE ENGINEER
- WHERE NEW PAVEMENT IS TO JOIN EXISTING PAVEMENT, THE EDGE OF THE EXISTING PAVEMENT SHALL BE TRIMMED IN A SMOOTH STRAIGHT LINE. CONSTRUCT MATCH-UP PAVING AS SHOWN ON THE PLANS AND OVERLAY PAVING AS DIRECTED IN THE FIELD TO PRODUCE A SMOOTH SECTION.
- 10. CONSTRUCT DRIVEWAY APPROACHES PER STANDARD DRAWING 302. EXACT SIZE AND LOCATION TO BE STAKED AS SHOWN PRIOR TO CONSTRUCTION OF THE CURB AND GUTTER.
- ALL OVERHANGING TREE LIMBS THAT ARE LESS THAN 14' ABOVE THE STREET GRADE SHALL BE TRIMMED
- 12. ON ALL AREAS WITHIN THE PUBLIC RIGHT-OF-WAY WHERE THE FILL IS ONE (I) FOOT OR GREATER, A LETTER WILL BE REQUIRED FROM THE SOILS ENGINEER, CERTIFYING THE COMPACTION OF THE FILL BELOW SUB-GRADE, PRIOR TO ISSUANCE OF THE CONSTRUCTION PERMIT/CUT SHEETS.
- ANY TRAFFIC CONTROL STRIPING OBLITERATED AND/OR BADLY WORN DURING CONSTRUCTION SHALL BE RESTORED BY THE CONTRACTOR WITHIN FIVE DAYS AFTER NOTIFICATION FROM THE CITY INSPECTORS
- 4. FINAL STRIPING FOR TRAFFIC CONTROL AND/OR PAVEMENT MARKING TO BE THE RESPONSIBILITY OF THE DEVELOPER.
- THE CONTRACTOR SHALL CALL IN A LOCATION REQUEST TO UNDERGROUND SERVICE ALERT (USA), PHONE # 1-800-227-2600, TWO WORKING DAYS BEFORE DIGGING. NO CONSTRUCTION PERMIT WILL BE ISSUED BY THE PUBLIC WORKS DEPARTMENT INVOLVING EXCAVATION FOR UNDERGROUND FACILITIES UNLESS THE APPLICANT HAS BEEN PROVIDED AN INQUIRY IDENTIFICATION NUMBER BY USA
- 6. THE CONTRACTOR SHALL ARRANGE FOR A SOIL TEST TO BE MADE BY A SOILS ENGINEER AFTER THE STREETS HAVE BEEN PREPARED TO ROUGH GRADE AND PRIOR TO CURB AND GUTTER CONSTRUCTION. DEPTH OF BASE MATERIAL AND A.C. PAVING SHALL BE DETERMINED BY THE CITY OF RIVERSIDE DESIGN STANDARDS AND TEST PROCEDURES.
- 17. ALL TRAFFIC SIGNS SHALL BE INSTALLED PRIOR TO OPENING THE STREETS TO TRAFFIC.
- 18. THE CONTRACTOR SHALL COORDINATE TRENCHING FOR CABLE TELEVISION WITH OTHER TRENCHING WITHIN THE SUBDIVISION.
- 19. IN PAVEMENT OVERLAY AREAS, ANY DISTRESSED EXISTING PAVEMENT SHALL BE REMOVED AND REPLACED AS DIRECTED BY THE INSPECTOR PRIOR TO OVERLAY WITH A.C. PAVING.

PRIVATE ENGINEER'S NOTES:

- UNLESS SPECIFIED IN THE PROJECT SPECIFIC CONSTRUCTION DOCUMENTS, ALL CONSTRUCTION SHOWN HEREON SHALL BE IN ACCORDANCE WITH THE GOVERNING AGENCY ADOPTED VERSION OF THE UNIFORM BUILDING CODE. THE "STANDARD SPECIFICATIONS FOR PUBLIC WORKS CONSTRUCTION" (CURRENT EDITION) AND THE "STANDARD PLANS FOR PUBLIC WORKS CONSTRUCTION" (CURRENT EDITION).
- THE EXISTENCE AND LOCATION OF ANY UNDERGROUND UTILITY PIPES OF STRUCTURES SHOWN ON THESE PLANS WERE OBTAINED BY A SEARCH OF AVAILABLE RECORDS. THESE LOCATIONS ARE APPROXIMATE AND SHALL BE CONFIRMED IN THE FIELD BY THE CONTRACTOR, SO THAT ANY NECESSARY ADJUSTMENTS CAN BE MADE IN ALIGNMENT AND/OR GRADE OF THE PROPOSED IMPROVEMENTS. THE CONTRACTOR IS REQUIRED TO TAKE DUE PRECAUTIONARY MEASURES TO PROTECT ANY UTILITY LINES SHOWN AND ANY OTHER LINES NOT OF RECORD OR NOT SHOWN ON THESE PLANS.
- PRIOR TO CONSTRUCTION, THE CONTRACTOR SHALL VERIFY THE HORIZONTAL AND VERTICAL POSITION OF ALL POINTS OF CONNECTION TO EXISTING STRUCTURES. THIS SHALL INCLUDE BOTH ABOVE GROUND AND BELOW GROUND POINTS OF CONNECTION. THE ENGINEER SHALL BE NOTIFIED OF ANY DISCREPANCIES PRIOR TO BEGINNING CONSTRUCTION.
- NO PORTION OF ANY PAVEMENT SURFACE WITHIN THE DISABLED PARKING SPACES OR ACCESS AISLES SHALL EXCEED 2% GRADIENT IN ANY DIRECTION. NO PORTION OF THE PATH OF TRAVEL SHALL EXCEED 5% GRADIENT EXCEPT AT DESIGNATED RAMPS WHICH SHALL NOT EXCEED 8.33% GRADIENT. NO PORTION OF THE PATH OF TRAVEL SHALL EXCEED 2% CROSS-FALL GRADIENT. THE ENGINEER SHALL BE NOTIFIED OF ANY DISCREPANCIES PRIOR TO BEGINNING CONSTRUCTION.
- THICKNESS OF PAVEMENT AND BASE MATERIAL SHOWN HEREON IS PRELIMINARY ONLY. FINAL PAVEMENT SECTION TO BE DETERMINED BY SOILS TEST AND RECOMMENDED BY THE SOILS ENGINEER UPON COMPLETION OF ROUGH GRADING.
- CONSTRUCTION CONTRACTOR AGREES THAT IN ACCORDANCE WITH GENERALLY ACCEPTED CONSTRUCTION PRACTICES, CONSTRUCTION CONTRACTOR WILL BE REQUIRED TO ASSUME SOLE AND COMPLETE RESPONSIBILITY FOR JOB SITE CONDITIONS DURING THE COURSE OF CONSTRUCTION OF THE PROJECT INCLUDING SAFETY OF ALL PERSONS AND PROPERTY: THAT THIS REQUIREMENT SHALL BE MADE TO APPLY CONTINUOUSLY AND NOT BE LIMITED TO NORMAL WORKING HOURS.
- THE PRIVATE ENGINEER SIGNING THESE PLANS IS RESPONSIBLE FOR ASSURING THE ACCURACY AND ACCEPTABILITY OF THE DESIGN HEREON. IN THE EVENT OF DISCREPANCIES ARISING AFTER APPROVAL OR DURING CONSTRUCTION, THE PRIVATE ENGINEER SHALL BE RESPONSIBLE FOR DETERMINING AN ACCEPTABLE SOLUTION AND REVISING THE PLANS ACCORDINGLY. STORM DRAIN CONSTRUCTION NOTES

CITY OF RIVERSIDE ALLEY IMPROVEMENT PLANS 3675 UNIVERSITY AVENUE

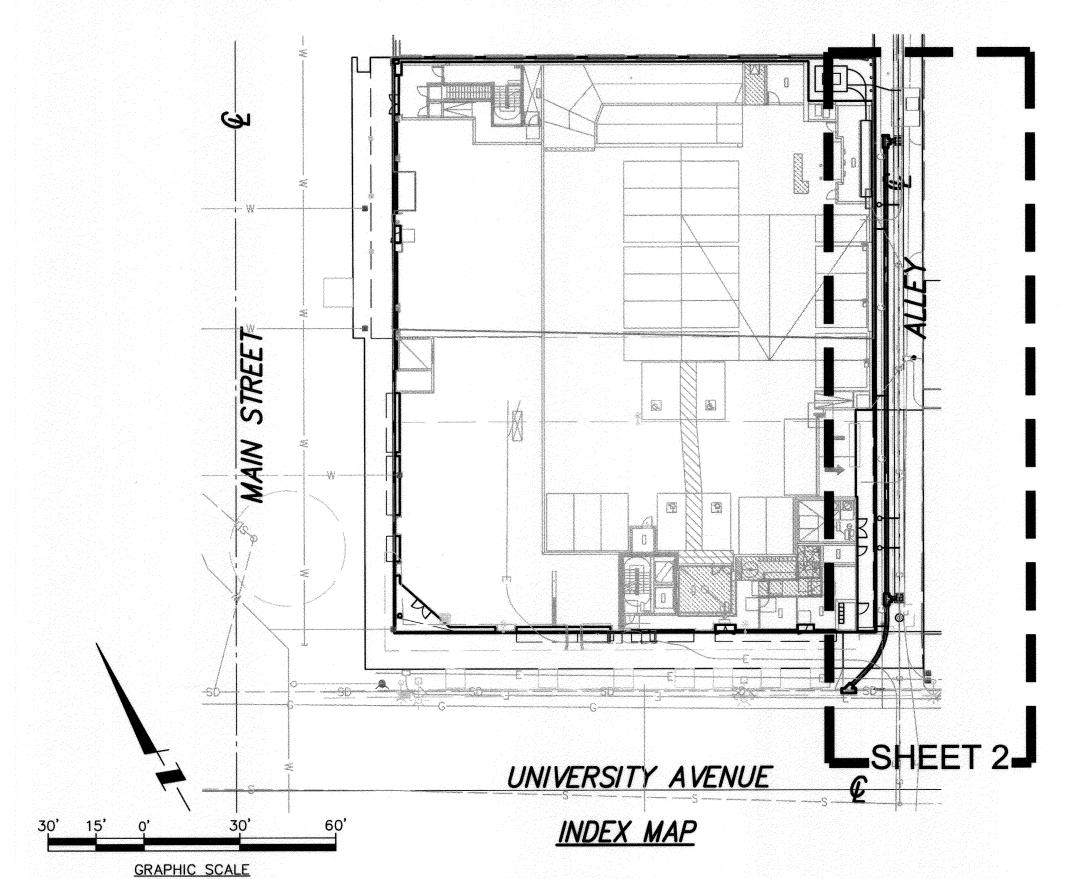

<u>EMERGENCT</u>	
RIVERSIDE POLICE DEPARTMENT	(951) 787-7911
RIVERSIDE FIRE DEPARTMENT	(951) 826-5321
GOODHEW AMBULANCE	(951) 684-5520
RIVERSIDE COMMUNITY HOSPITAL	(951) 788-3000
RIVERSIDE GENERAL HOSPITAL	(951) 351-0925
UTILITIES	
UNDERGROUND SERVICE ALERT	(800) 227-2600
CITY OF RIV. ELEC. OPERATIONS CONTROL CTR	
SOUTHERN CALIFORNIA GAS (DISTRIBUTION)	
CITY OF RIV. PUBLIC UTIL. CUSTOMER SERVICES	
PACIFIC BELL	
AMERICAN TELEPHONE & TELEGRAPH	(951) 381-7380
CHARTER COMMUNICATION CABLE	(951) 688-9012
CITY OF RIV. WATER OPERATIONS EMERGENCIES	
OTHERS	
RIVERSIDE PUBLIC WORKS DEPARTMENT	(951) 826-534
R.F. DICKSON STREET SWEEPING	(800) 811-799
WESTERN WASTE	(000) 041-111-1 (051) 737-03/1
RIVERSIDE DIAL-A-RIDE (SUPERVISOR)	(951) 275-9620
US POSTAL SERVICE	
RIVERSIDE UNIFIED SCHOOL DISTRICT	
RIVERSIDE TRANSITAGENCY	
NIVERSIDE TRANSITAGENCI	(151) 004 0050

<u>EMERGENCY</u>	
RIVERSIDE POLICE DEPARTMENT	(951) 787-7911
RIVERSIDE FIRE DEPARTMENT	(951) 826-5321
GOODHEW AMBULANCE	(951) 684-5520
RIVERSIDE COMMUNITY HOSPITAL	(951) 788-3000
RIVERSIDE GENERAL HOSPITAL	(951) 351-0925
UTILITIES	4.150 - 150
UNDERGROUND SERVICE ALERT	(800) 227-2600
CITY OF RIV. ELEC. OPERATIONS CONTROL CTR	
SOUTHERN CALIFORNIA GAS (DISTRIBUTION)	
CITY OF RIV. PUBLIC UTIL. CUSTOMER SERVICES	
PACIFIC BELL AMERICAN TELEPHONE & TELEGRAPH	(OUU) 221-2000 (OEI) 201 7200
AFTER COMMUNICATION CARLE	(951) 301-7300
CHARTER COMMUNICATION CABLE	
CITY OF RIV. WATER OPERATIONS EMERGENCIES	(451) 182-0330
<u>OTHERS</u>	
RIVERSIDE PUBLIC WORKS DEPARTMENT	
R.F. DICKSON STREET SWEEPING	
WESTERN WASTE	(951) 737-0343
RIVERSIDE DIAL-A-RIDE (SUPERVISOR)	(951) 275-9620
US POSTAL SERVICE	(951) 737-0451
US POSTAL SERVICERIVERSIDE UNIFIED SCHOOL DISTRICT	(951) 788-7134
RIVERSIDE TRANSITAGENCY	.(951) 684-0850

SCALE: 1'' = 30'

UANTITIE. CONSTRUCTION NOTES CONSTRUCT 3.5" A.C. OVER 9.5" CLASS 2 AGGREGATE BASE. FINAL SECTION

- SHALL BE DETERMINED BY THE SOILS ENGINEER AT THE COMPLETION OF ✓ ROUGH GRADE, R-VALUE=25, V-GUTTER SHALL HAVE THE SAME BASE AS AC PAVEMENT.
- CONSTRUCT ALLEY SECTION TYPE I PER CITY OF RIVERSIDE STD. DWG. NO. igspace 110. V-GUTTER SHALL HAVE THE SAME BASE AS CONCRETE PAVEMENT.
- CONSTRUCT ALLEY SECTION TYPE I PER CITY OF RIVERSIDE STD. DWG. NO. (3) 110 WITH CONCRETE PAVEMENT PER CONSTRUCTION NOTE 10. V-GUTTER SHALL HAVE THE SAME BASE AS CONCRETE PAVEMENT.
- CONSTRUCT DRIVEWAY APPROACH PER CITY OF RIVERSIDE DWG. STD. NO. (4) 302 TYPE I. (MODIFIED) WITH CONCRETE PAVEMENT PER CONSTRUCTION
- (5) INSTALL 3'X3' CATCH BASIN WITH TRAFFIC GRATE PER DETAIL ON SHEET 2.
- INSTALL 6" VCP SEWER LATERAL PER CITY OF RIVERSIDE DWG. STD. NO. (7) 562. CONTRACTOR SHALL COORDINATE WITH BUILDING CONTRACTOR FOR THE EXACT LOCATION OF SEWER CLEANOUT.

(6) INSTALL 2'X2' CATCH BASIN WITH TRAFFIC GRATE PER DETAIL ON SHEET 2.

- INSTALL SEWER CLEANOUT PER CITY OF RIVERSIDE DWG. STD. NO. 560. (8) CONTRACTOR SHALL COORDINATE WITH BUILDING CONTRACTOR FOR THE EXACT LOCATION OF SEWER CLEANOUT.
- EXISTING MANHOLE TO BE ADJUSTED TO GRADE. CONTRACTOR SHALL (9) NOTIFY THE MANHOLE OWNER BEFORE ADJUSTING MANHOLE. .
- CONSTRUCT 7" THICK PCC CONCRETE OVER 8" CLASS 2 AGGREGATE BASE. FINAL SECTION SHALL BE DETERMINED BY THE SOILS ENGINEER.
- (II) CONCRETE SLAB PER ARCHITECT PLANS.
- CONTRACTOR SHALL ADJUST GAS VALVE TO GRADE. CONTRACTOR TO RELOCATE THE GAS VALVE, IF CONFLICT WITH PROPOSDE STORM DRAIN.
- (13) CONSTRUCT UTILITY 4" CONCRETE SLAB PER ARCHITECT PLANS.
- (14) INSTALL PIPE BOLLARD PER ARCHITECT PLANS.
- (15) EXISTING ELECTRICAL CONDUIT TO BE ABANDONED PER ELECTRICAL PLANS.
- SWR. C.O. TO BE ADJ. TO GRADE. CONTRACTOR TO RELOCATE THE C.O.

CONSTRUCT WPJ ON CONCRETE PAVEMENT, SIDEWALK AND V-GUTTER PER SPPWC STD. PLAN 112-2 AND SSPWC SPECIFICATIONS. JOINTS IN PAVEMENT AND V-GUTTER SHALL BE ALIGNED AND SHALL BE CONSTRUCTERED SEPARATELY.

LEGEND

M.H.


S.F.

F.G.

C/L

P/L

1,838 S.F.

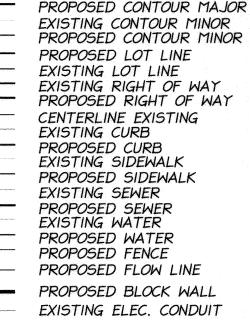

EXISTING CONTOUR MAJOR

PROPOSED LANDSCAPE

PROPOSED AC PAVEMENT

PROPOSED CONCRETE SIDEWALK

MANHOLE SQUARE FEET FLOW LINE ELEVATION FINISH SURFACE ELEVATION FINISH GRADE ELEVATION CENTERLINE RIGHT OF WAY PROPERTY LINE


DRIVEWAY FINISH FLOOR ELEVATION PAD ELEVATION TOP OF CURB SIDEWALK PAD ELEVATION INVERT OF PIPE ELEVATION

EXISTING GROUND NATURAL GROUND TO BE REMOVED PROTECT IN PLACE DEEPENED FOOTING CURB FACE ELBOW

CLEAN OUT SEWER LINE ADJUST WEAKENED PLANE JOINT

STANDARD SPECIFICATIONS FOR PUBLIC WORKS CONSTRUCTION

STANDARD PLANS FOR PUBLICS WORKS CONSTRUCTION

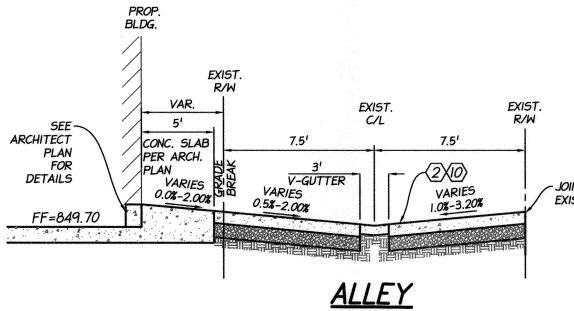

SALEM ENGINEERING GROUP, INC. 11650 MISSION PARK DR. #108 RANCHO CUCAMONGA, CA 91730 PH: (909) 980-6455 FX: (909) 980-6435 STA. 10+60.09 TO STA. 11+19.03 NOT TO SCALE

UCINITY MAP

THOMAS GUIDE - PAGE 685, H-3 (2005 EDITION)

SECTION 23 TOWNSHIP 2 SOUTH RANGE 5 WEST

OWNER/DEVELOPER

2465 CAMPUS DRIVE, THIRD FLOOR

RATKOVICH PROPERTIES, LLC

1500 IOWA AVENUE, SUITE 210

IRVINE, CA 92312

ENGINEER

RIVERSIDE, CA 92507

FAX: (951) 682-3379

<u>ARCHITECT</u>

DESIGN ARC, INC.

PH: (951) 787-8421

PERFORMED ON JUNE 2015

SOILS ENGINEER

PHONE: (310) 204-8950

EMAIL: AALPER@DESIGNARC.NET

TOPOGRAPHY SOURCE

1500 IOWA AVENUE, RIVERSIDE, CA 92507

PHONE: (951) 787-8421

PSOMAS

TEL: (562) 537-1002

CONTACT: ROB DODMAN

NOT TO SCALE

<u>LEGAL DESCRIPTION</u>

213-271-005 THAT CERTAIN REAL PROPERTY IN THE CITY OF RIVERSIDE, COUNTY OF RIVERSIDE, STATE OF CALIFORNIA, DESCRIBED AS FOLLOWS:

2558 OVERLAND AVENUE, LOS ANGELES, CA, 90064

EXISTING TOPOGRAPHY IS BASED UPON A FIELD SURVEY BY

PARCEL I OF CITY OF RIVERSIDE CERTIFICATE OF COMPLIANCE PI4-0748 FOR LOT MERGER, RECORDED OCTOBER 3, 2014 AS DOCUMENT NO. 2014-0377741, OFFICIAL RECORDS OF RIVERSIDE COUNTY, CALIFORNIA.

SHEET INDEX

TITLE SHEET . ALLEY # STORM DRAIN PLAN

VARIES EXISTING

7.5'

STA. 11+19.03 TO STA. 12+39.72 NOT TO SCALE

CITY OF RIVERSIDE, CALIFORNIA CITY OF RIVERSIDE PUBLIC WORKS DEPARTMENT **ALLEY IMPROVEMENT PLAN 3675 UNIVERSITY AVENUE**

SHEET 1 OF 2

PW15-0702

R - 4369

J.N. 4RAT010100

WATER DEPARTMENT REVIEW FOR WATER CONFLICTS

QUANTITIES

CITY BUSINESS CERTIFICATE NO. 0021337, EXP. 10/31/2016 1500 IOWA AVENUE, SUITE 210

RIVERSIDE, CA 92507 (951) 787-8421 WWW.PSOMAS.COM

R.C.E. NO. Ano My

DATE: 9/12/2016

APPR. DATE REVISIONS DESIGNED BY DRAWN BY _ CHECKED BY_

마이 아이들이 남아진 사람들이 아이지 않는데 말했다는데 하는데 말하다. 사람들은 사용하다는 사용이 발표하는 사람들이 가장 사람들이 되었다.

BY DATE APPROVED BY ENGINEERING MANAGER 19-16-16 CHTY ENGINEER/PW DIRECTOR DATE 9/26/16

SEE ARCHITECT PLAN FOR

DETAILS

PARKING STRUCTURE

TITLE SHEET

HORIZ. SCALE: AS NOTED VERT. SCALE: AS NOTED

MUNICIPAL MUSEUM BUILDING. ABOUT 4' HIGHER THAN THE STREET IT IS 41.6' SOUTH OF A CONCRETE LAMP POST, 16.5' EAST OF THE CENTER OF THE ENTRANCE INTO THE BUILDING, 3.3' WEST OF THE MOST EASTERLY ON OF 6 COLUMNS, 3.3' EAST OF THE SECOND COLUMN FROM THE EAST AND .6' SOUTH OF THE NORTH EDGE

A STANDARD U.S.C. & G.S. BRASS DISK CEMENTED IN

A DRILL HOLE AT THE ENTRANCE TO THE RIVERSIDE

A PUBLIC SERVICE BY UNDERGROUND SERVICE ALERT

DAYS BEFORE

YOU DIG

BENCHMARK: Z1-RESET 1988 ELEV. = 860.090 CITY OF RIVERSIDE PUBLIC UTILITIES

BEFORE

YOU DIG

CITY OF RIVERSIDE

OF THE ARCHWAY.

ELECTRIC ENGINEERING

DEPARTMENT-ELECTRIC OVERHEAD & UNDERGROUND

WATER ENGINEERING

CITY OF RIVERSIDE PUBLIC UTILITIES

MINSTALL 12" RCP STORM DRAIN PIPE. D-LOAD=1600, BEDDING CASE 2. PER CITY OF RIVERSIDE STD. DWG. NO. 452.

INSTALL JUNCTION STRUCTURE NO. 4, CASE I PER RIVERSIDE STD.

CONTRACTOR FOR THE EXACT LOCATION OF ROOF DRAIN LATERALS.

23 DWG. 423, CONTRACTOR SHALL COORDINATE WITH BUILDING

INSTALL JUNCTION STRUCTURE B PER RIVERSIDE STD. DWG. 421.

(21) A=45°, B=12", C'=2.55', D=12", E'=2.05', L=2.4'

A=80°, B=12", C'=1.44', D=12", E'=0.90', L=1.7'

No. 39087 이류 06/30/2017 Par CAN

