LANDSCAPE ARCHITECTURAL CONSTRUCTION PLANS

FOR

DOWNTOWN MALL MAIN STREET

CITY OF RIVERSIDE 3900 MAIN STREET RIVERSIDE, CA 92522

I.D.L.A. PROJECT NUMBER 13406

PROJECT DIRECTORY

IDLA

LANDSCAPE ARCHITECTURE

3744 TENTH STREET, SUITE 200 RIVERSIDE, CA 92501 PHONE # (951) 683-1283

IW CONSULTING, INC.

CIVIL ENGINEERING

3544 UNIVERSITY AVENUE RIVERSIDE, CA 92501 PHONE # (951) 687-2929

A & F ENGINEERING GROUP, INC.

ELECTRICAL ENGINEERING

9333 BASELINE, SUITE 100 RANCHO CUCAMONGA, CA 91730 PHONE # (909) 941-3008

CITY OF RIVERSIDE PUBLIC UTILITIES

3901 ORANGE STREET RIVERSIDE, CA 92501 PHONE # (951) 782-0330





L-I.IO LINEAR FOUNTAIN DETAILS

L-1.12 FOUNTAIN DETAILS

L-I.I3 FOUNTAIN DETAILS

L-1.14 STRUCTURAL DETAILS

L-1.15 STRUCTURAL DETAILS

L-1.16 STRUCTURAL DETAILS

L-1.18 PUBLIC COURT DETAILS

L-1.19 CONSTRUCTION DETAILS

L-120 CONSTRUCTION DETAILS

L-12 CONSTRUCTION DETAILS

L-I.IT ARBOR DETAILS

L-122 ART ELEMENTS

L-I.II CIRCULAR FOUNTAIN DETAILS

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ITY OF RIVERSIDE, CALIFORNIA PUBLIC WORKS DEPARTMENT

DOWNTOWN MALL LANDSCAPE PLANS

12/03/07 COVER SHEET M - 457

100 of 100

71 of 100

SHEET INDEX LANDSCAPE GENERAL INFORMATION ---- COVER SHEET L-22 IRRIGATION PLAN L-2.3 IRRIGATION PLAN L-2.4 IRRIGATION PLAN CIVIL ENGINEER L-2.6 IRRIGATION PLAN C.I TITLE SHEET L-2.7 IRRIGATION PLAN INDEX MAP & CONSTRUCTION NOTES L-3.2 PLANTING PLAN L-3.3 PLANTING PLAN L-3.7 PLANTING PLAN C.IO HORIZONTAL CONTROL PLAN L-3.9 PLANTING DETAILS L-4.1 TREE RETENTION PLAN L-4.2 TREE RETENTION PLAN L-4.3 TREE RETENTION PLAN L-4.4 TREE RETENTION PLAN L-4.5 TREE RETENTION PLAN C.16 HORIZONTAL CONTROL PLAN L-4.6 TREE RETENTION PLAN L-4.7 TREE RETENTION PLAN C.IT EROSION CONTROL SHEETS C.IS EROSION CONTROL SHEETS ELECTRICAL C.19 EROSION CONTROL SHEETS C20 DEMOLITION SHEETS EO.I GENERAL NOTES, SYMBOL LIST EO 2 SINGLE LINE DIAGRAM AND PANEL SCHEDULES C2 DEMOLITION SHEETS

C22 DEMOLITION SHEETS EO.3 ELECTRICAL DETAILS G.23 DETAIL SHEETS EO.4 ELECTRICAL DETAILS EO.5 EXTERIOR TITLE 24

1	ANDSC	APE	·		
emo				EI.I	PARTIAL ELECTRICAL DEMOLITION SITE PLAN
L	-0.1 COV	/ER SHEET	25	El2	PARTIAL ELECTRICAL DEMOLITION SITE PLAN
				EI.3	PARTIAL ELECTRICAL DEMOLITION SITE PLAN
1	1.1 CON	ISTRUCTION PLAN	26	El.4	PARTIAL ELECTRICAL DEMOLITION SITE PLAN
L	1.2 CON	ISTRUCTION PLAN	27	EI.5	PARTIAL ELECTRICAL DEMOLITION SITE PLAN
L	1.3 CON	ISTRUCTION PLAN	28	EI.6	PARTIAL ELECTRICAL DEMOLITION SITE PLAN
L	1.4 CON	ISTRUCTION PLAN	29	E2.I	PARTIAL ELECTRICAL RENOVATION SITE PLAN
L	1.5 CON	ISTRUCTION PLAN	30	E2.2	PARTIAL ELECTRICAL RENOVATION SITE PLAN
L	1.6 CON	ISTRUCTION PLAN	31	E2.3	PARTIAL ELECTRICAL RENOVATION SITE PLAN
L	1.7 CON	ISTRUCTION PLAN	32	E2.4	PARTIAL ELECTRICAL RENOVATION SITE PLAN
L	1.8 FOU	NTAIN/BRIDGE DETAILS	33	E2.5	PARTIAL ELECTRICAL RENOVATION SITE PLAN
Į	1.9 FOU	NTAIN/BRIDGE DETAILS	34	E2.6	PARTIAL ELECTRICAL RENOVATION SITE PLAN

ENLARGED RENOVATION PLANS E3.I PARIAL POINT-BY-POINT FOOTCANDLE PHOTOMETRIC STUDY PARIAL POINT-BY-POINT FOOTCANDLE PHOTOMETRIC STUDY E3.3 PARIAL POINT-BY-POINT FOOTCANDLE PHOTOMETRIC STUDY E3.4 PARIAL POINT-BY-POINT FOOTCANDLE PHOTOMETRIC STUDY

E3.5 PARIAL POINT-BY-POINT FOOTCANDLE PHOTOMETRIC STUDY E3.6 PARIAL POINT-BY-POINT FOOTCANDLE PHOTOMETRIC STUDY E4. SOUND SYSTEM RENOVATION SITE PLAN E4.2 SOUND SYSTEM RENOVATION SITE PLAN

E4.3 SOUND SYSTEM RENOVATION SITE PLAN E4.4 SOUND SYSTEM RENOVATION SITE PLAN

NINTH ST. STREET LIGHTS

PUBLIC UTILITIES

SHEET 1 OF 100

CALL: TOLL FREE

UNDERGROUND SERVICE ALERT

CITY OF RIVERSIDE MAIN STREET REVITALIZATION

FROM TENTH STREET TO FIFTH STREET **MARCH 2008**

GRADING NOTES:

1. ALL GRADING SHALL CONFORM TO RIVERSIDE MUNICIPAL CODE TITLE 17 AND APPENDIX CHAPTER 33, VOLUME 1 OF THE CURRENT CITY-ADOPTED EDITION OF THE UNIFORM BUILDING CODE. THE ENGINEER SHALL SUBMIT A LETTER CERTIFYING THE CONTOURING OF SLOPES AS REQUIRED BY SECTION 17.28.020 OF TITLE 17 PRIOR TO ISSUANCE OF A BUILDING PERMIT.

2. NOT USED.

3. THIS PLAN IS FOR GRADING PURPOSES ONLY AND IS NOT TO BE USED FOR THE PURPOSE OF CONSTRUCTING ON-SITE OR OFF-SITE IMPROVEMENTS. ISSUANCE OF A PERMIT BASED ON THIS PLAN DOES NOT CONSTITUTE APPROVAL OF DRIVEWAY LOCATIONS OR SIZES, PARKING LOT STRUCTURAL SECTIONS OR LAYOUT, ADA-RELATED REQUIREMENTS, BUILDING LOCATIONS OR FOUNDATIONS, WALLS, CURBING, OFF-SITE DRAINAGE FACILITIES OR OTHER ITEMS NOT RELATED DIRECTLY TO THE BASIC GRADING OPERATION. ON-SITE IMPROVEMENTS SHALL BE CONSTRUCTED FROM APPROVED BUILDING PERMIT PLANS. OFF-SITE IMPROVEMENTS SHALL BE CONSTRUCTED FROM PLANS APPROVED FOR THIS PURPOSE BY THE PUBLIC WORKS DEPARTMENT.

- 4. THE CONTRACTOR IS RESPONSIBLE FOR EROSION, DUST AND TEMPORARY DRAINAGE CONTROL DURING GRADING OPERATIONS.
- A. THE DEVELOPER AND HIS CONTRACTOR ARE RESPONSIBLE FOR IMPLEMENTATION AND MAINTENANCE OF THE EROSION CONTROL MEASURES SHOWN ON THIS PLAN AND TO PROVIDE ANY ADDITIONAL EROSION CONTROL MEASURES (E.G., HYDRO- SEEDING, MULCHING OF STRAW, SAND BAGGING. DIVERSION DITCHES, RETENTION BASINS, ETC.) DICTATED BY FIELD CONDITIONS TO PREVENT EROSION AND/OR THE INTRODUCTION OF DIRT, MUD OR DEBRIS TO EXISTING PUBLIC STREETS AND/OR ONTO ADJACENT PROPERTIES DURING ANY PHASE OF CONSTRUCTION OPERATIONS. SPECIAL ATTENTION SHALL BE GIVEN TO ADDITIONAL EROSION CONTROL MEASURES NOTED ABOVE DURING THE PERIOD OCTOBER 15 TO APRIL 15.
- B. AFTER A RAINSTORM, ALL SILT AND DEBRIS SHALL BE REMOVED FROM CHECK BERMS AND CHECK DAMS. SILT AND DEBRIS SHALL BE REMOVED FROM CITY OF RIVERSIDE STREETS.
- 5. ANY IMPROVEMENTS CONSTRUCTED IN THE PUBLIC RIGHT-OF-WAY WILL REQUIRE A SEPARATE CONSTRUCTION PERMIT AND INSPECTION FROM THE PUBLIC WORKS DEPARTMENT.

6. ANY WALLS. FENCES. STRUCTURES AND/OR APPURTENCES ADJACENT TO THE S'LY PROPERTY LINE OF THIS PROJECT ARE TO BE REMOVED, THE DEVELOPER IS RESPONSIBLE FOR WORKING OUT AN ACCEPTABLE SOLUTION TO THE SATISFACTION OF THE AFFECTED PROPERTY OWNER(S) DURING THE INSTALLATION OF THE TRACT WALL. THE EXISTING BLOCK WALL ON THE E'LY PROPERTY LINE IS TO BE PROTECTED IN PLACE.

- 7. IT IS THE CONTRACTOR'S RESPONSIBILITY TO ENSURE THAT ADEQUATE COMPACTION HAS BEEN ATTAINED ON THE ENTIRE GRADING SITE.
- 8. IT IS THE SOIL ENGINEER'S RESPONSIBILITY TO OBSERVE AND PERFORM COMPACTION TESTS DURING THE GRADING TO EVALUATE THE PREPARATION OF THE NATURAL GROUND SURFACE TO RECEIVE THE FILL AND THE COMPACTION ATTAINED IN THE FILL, INCLUDING FILL AREAS OUTSIDE THE BUILDING PADS AND ON ALL

10. OPERATIONS SHALL BE LIMITED TO BETWEEN THE HOURS OF 7 A.M. AND 7 P.M. ON WEEKDAYS AND BETWEEN 8: 00 A.M. AND 5: 00 P.M. OM SATURDAYS. NO GRADING OR CONSTRUCTION NOISE WILL BE PEMITTED ON SUNDAY OR FEDERAL HOLIDAYS. (RIVERSIDE MUNICIPAL CODE, 7.35.010, ORDINANCE NO.

- 11. A STORM WATER POLLUTION PREVENTION PLAN (SWPPP) SHALL BE KEPT ON-SITE AND MADE AVAILABLE UPON REQUEST OF A REPRESENTATIVE OF THE REGIONAL WATER QUALITY CONTROL BOARD (RWQCB) - SANTA ANA REGION AND/OR THE CITY OF RIVERSIDE.
- 12. ANY ON-SITE RETAINING WALLS SHOWN ON THIS PLAN THAT ARE UNDER 3 FEET IN HEIGHT AND SUPPORT A SURCHARGE OR THAT ARE OVER 3 FEET IN HEIGHT REQUIRE SEPERATE REVIEW, APPROVAL AND A BUILDING PERMIT FROM THE BUILDING DIVISION, PLANNING DEPARTMENT. ANY NECESSARY RETAINING WALLS ON THE PERIMETER OF THIS SITE SHALL BE IN PLACE AND APPROVED BY THE BUILDING INSPECTOR PRIOR TO ISSUANCE OF THE GRADING PERMIT. APPROVED SEQUENCED GRADING WITH 1 1/2: 1 MAXIMUM SLOPES TO WITHIN 2 FEET OF THE ADJACENT PROPERTY LINE MAY BE ACCEPTABLE TO ALLOW FOR ISSUANCE OF A GRADING PERMIT PRIOR TO COMPLETION OF ANY PERIMETER RETAINING WALLS.
- 13. THE CONTRACTOR/DEVELOPER IS RESPONSIBLE FOR ENSURING THAT RETAINING WALLS DO NOT INTERFERE WITH PROVISION OF UTILITIES.

CONTRACTORS RESPONSIBILITY:

THE CONTRACTOR AGREES THAT HE SHALL ASSUME SOLE AND COMPLETE RESPONSIBILITY FOR JOB SITE CONDITIONS DURING THE COURSE OF CONSTRUCTION OF THIS PROJECT. INCLUDING SAFETY OF ALL PERSONS AND PROPERTY; THAT THIS REQUIREMENT SHALL APPLY CONTINUOUSLY AND NOT BE LIMITED TO NORMAL WORKING HOURS; AND THAT THE CONTRACTOR SHALL DEFEND, INDEMNIFY AND HOLD THE OWNER AND THE ENGINEER HARMLESS FROM ANY AND ALL LIABILITY, REAL OR ALLEGED, IN CONNECTION WITH THE PERFORMANCE OF WORK ON THIS PROJECT, EXCEPTING FOR LIABILITY ARISING FROM THE SOLE NEGLIGENCE OF THE OWNER OR THE ENGINEER.

EROSION CONTROL NOTES:

IN CASE OF EMERGENCY CALL: FRED CERDA AT PH (951) 826-5341 (24 HRS.)

THE UNDERSIGNED CIVIL ENGINEER WILL REVIEW EROSION CONTROL WORK: FREDDY IRIANTO, PE

A STANDBY CREW FOR EMERGENCY WORK SHALL BE AVAILABLE AT ALL TIMES DURING THE RAINY SEASON. NECESSARY MATERIAL SHALL BE AVAILABLE ON SITE AND STOCKPILED AT CONVENIENT LOCATIONS TO FACILITATE RAPID CONSTRUCTION OF TEMPORARY DEVICES OR TO REPAIR ANY DAMAGED EROSION CONTROL MEASURES WHEN RAIN IS IMMINENT

DEVICES SHALL NOT BE MOVED OR MODIFIED WITHOUT THE APPROVAL OF THE CITY INSPECTOR.

ALL REMOVABLE PROTECTIVE DEVICES SHOWN SHALL BE IN PLACE AT THE END OF EACH WORKING DAY WHEN THE FIVE-DAY RAIN PROBABILITY FORECAST EXCEEDS 40 PERCENT.

AFTER A RAINSTORM ALL SILT AND DEBRIS SHALL BE REMOVED FROM CHECK BERMS. ANY GRADED SLOPE SURFACE PROTECTION MEASURES DAMAGED DURING A RAINSTORM SHALL ALSO BE IMMEDIATELY REPAIRED.

THE FACES OF FILL SLOPES SHALL BE PREPARED AND MAINTAINED TO CONTROL AGAINST EROSION. THE SLOPE PROTECTION SHALL BE INSTALLED AS SOON AS PRACTICABLE AND PRIOR TO CALLING FOR FINAL INSPECTION.

A 24-HOUR GUARD SHALL BE POSTED ON THE SITE WHENEVER THE DEPTH OF WATER ON ANY DEVICE EXCEEDS TWO FEET.

EROSION CONTROL SHALL BE IMPLEMENTED DURING THE RAINY SEASON (OCTOBER 15 THROUGH END OF APRIL).

QUANTITY ESTIMATE NOTE:

QUANTITY ESTIMATES SHOWN ON THESE PLANS ARE FOR PLAN CHECK PURPOSES ONLY. THESE QUANTITIES DO NOT REFLECT ANY SHRINKAGE. SWELLING. SUBSIDENCE OVER EXCAVATION, OR ANY SPECIAL CONDITIONS THAT MAY BE SPECIFIED IN THE PRELIMINARY SOILS REPORT. SINCE THE ENGINEER CAN NOT CONTROL THE EXACT METHOD OR MEANS USED BY THE CONTRACTOR DURING GRADING OPERATIONS, NOR CAN THE ENGINEER GUARANTEE THE EXACT SOIL CONDITIONS OVER THE ENTIRE SITE. THE ENGINEER ASSUMES NO RESONSIBILITY FOR FINAL EARTHWORK QUANTITIES FOR BIDDING, CONTRACT, AND CONSTRUCTION PURPOSES. IF IT APPEARS THAT THERE WILL BE AN EXCESS OR SHORTAGE OF MATERIAL, THE CONTRACTOR MAY NOTIFY THE ENGINEER TO DETERMINE IF POSSIBLE GRADE ADJUSTMENTS CAN BE MADE TO ALLEVIATE SAID MATERIAL EXCESS OR SHORTAGE.

ENGINEER'S NOTICE TO CONTRACTORS:

THE EXISTENCE AND LOCATION OF ANY UNDERGROUND UTILITY PIPES OF STRUCTURES SHOWN ON THESE PLANS WERE OBTAINED BY A SEARCH OF AVAILABLE RECORDS. THESE LOCATIONS ARE APPROXIMATE AND SHALL BE CONFIRMED IN FIELD BY THE CONTRACTOR, SO THAT ANY NECESSARY ADJUSTMENT CAN BE MADE IN ALIGNMENT AND/OR GRADE OF THE PROPOSED IMPROVEMENT. THE CONTRACTOR IS REQUIRED TO TAKE DUE PRECAUTIONARY MEASURE TO PROTECT ANY UTILITY LINES SHOWN AND ANY OTHER LINES NOT OF RECORD OR NOT SHOWN ON THESE PLANS.

GENERAL NOTES:

- 1. NO WORK WHATSOEVER SHALL BE STARTED WITHOUT NOTIFYING THE CITY OF RIVERSIDE 48 HOURS PRIOR TO BEGINNING WORK.
- 2. THE DESIGN ENGINEER SHALL EXERCISE SUFFICIENT SUPERVISORY CONTROL DURING GRADING AND CONSTRUCTION TO ENSURE COMPLIANCE WITH THE APPROVED PLANS WITHIN HIS AREA OF TECHNICAL SPECIALTY.
- 3. ALL DIRT, SAND, MUD, OR DEBRIS DEPOSITED OR SPILLED UPON PUBLIC STREETS DURING ANY GRADING, HAULING, OR EXPORT OPERATIONS SHALL IMMEDIATELY BE CLEANED UP BY DEVELOPER, HIS CONTRACTOR OR SUBCONTRACTOR.
- 4. GRADING OPERATIONS SHALL BE LIMITED TO THE HOURS BETWEEN 7:00 A.M. AND 7: 00 P.M. ON THE WEEKDAYS.
- 5. THE CONTRACTOR SHALL VERIFY QUANTITIES SHOWN ON PLANS PRIOR TO START OF CONSTRUCTION OPERATIONS. ANY DISCREPANCIES BETWEEN THE QUANTITIES SHOWN ON PLANS AND THE CONTRACTOR'S QUANTITIES SHALL BE REPORTED TO THE
- 6. APPROVED EROSION PROTECTION DEVICES SHALL BE PROVIDED AND MAINTAINED DURING THE RAINY SEASON AND SHALL BE IN PLACE AT THE END OF EACH DAY'S WORK AND BEFORE FORECASTED RAINY WEATHER.
- 7. THE LOCATION AND PROTECTION OF ALL UTILITIES IS THE RESPONSIBILITY OF THE CONTRACTOR.
- 8. ALL GATE VALVE CANS, WATER METER BOXES, MAN HOLE FRAME AND COVER, UTILITY VAULTS, IRRIGATION BOXES ETC. TO BE ADJUSTED TO GRADE UNLESS IDENTIFIED TO BE ABANDONED. SAID ADJUSTMENTS INCLUDED AS PART OF COMPENSATION FOR WORK REQUIRING ADJUSTMENTS. EXCEPT THAT ADJUSTMENT OF SEWER AND STORM DRAIN MAN HOLES TO GRADE SHALL BE PAID SEPARATELY.
- 9. THIS PROJECT WILL REQUIRE A STREET OPENING PERMIT FROM THE CITY OF RIVERSIDE PUBLIC WORKS DEPARTMENT. CONSTRUCTION INSPECTION WILL BE PERFORMED BY CITY OF RIVERSIDE PERSONNEL OR OTHER REPRESENTATIVES.
- 10. ALL ROOF DOWN DRAINS TO BE CONNECTED TO STORM DRAIN SYSTEM. CONNECTION TO BE MADE PURSUANT TO UBC REQUIREMENTS. PAYMENT FOR PIPING TO BE INCLUDED IN CONSTRUCTION QUANTITIES AND AS CONSTRUCTION ITEM #16. PAYMENT FOR CONNECTION AND ALL REQUIRED APPURTENANCES SHALL BE ON A UNIT BASIS CONSTRUCTION QUANTITY ESTIMATED TO BE 25 UNITS.
- 11. CONTRACTOR'S RESPONSIBILITY TO INCLUDE PROTECTION OF ALL EXISTING UTILITIES UNLESS SPECIFICALLY IDENTIFIED FOR REMOVAL
- 12. REMOVE ALL EXISTING STORM DRAIN PIPING, INLETS, AND APPURTENANCES AS PART OF CLEARING AND GRUBBING.
- 13. ALL EXISTING NEWS STANDS TO BE REMOVED AND RELOCATED. COMPENSATION INCLUDED WITH PAYMENT FOR SURFACE MATERIAL CONSTRUCTION.
- 14. REFER TO LANDSCAPE ARCHITECT PLAN FOR SALVAGE OF ALL BOULDERS AND REUSE.
- 15. SALVAGE AND TRANSPORT TO CITY YARD ALL EXISTING POTS, BENCHES, AND TRASH RECIPROCALS.

TELEPHONE NUMBERS:

RIVERSIDE POLICE DEPARTMENT

EMERGENCY

RIVERSIDE POLICE DEPARTMENT	(901)	101-1911	
RIVERSIDE FIRE DEPARTMENT	(951)	826-5321	
GOODHEW AMBULANCE			
RIVERSIDE COMMUNITY HOSPITAL			
UTILITIES			
UNDERGROUND SERVICE ALERT	(000)	227_2600	
CITY OF RIV. ELEC. OPERATIONS CONTROL CTR			
SOUTHERN CALIFORNIA GAS (DISTRIBUTION)			
CITY OF RIV. PUBLIC UTIL. CUSTOMER SERVICES			
PACIFIC BELL	(800)	422-4133	
AMERICAN TELEPHONE & TELEGRAPH	(951)	381-7380	
CHARTER COMMUNICATION CABLE			
CITY OF RIV. WATER OPERATIONS EMERGENCIES			
OTHERS			
0.7712.70	(054)	000 5744	
RIVERSIDE PUBLIC WORKS DEPARTMENT			
R.F. DICKSON STREET SWEEPING			
WESTERN WASTE			
RIVERSIDE DIAL-A-RIDE (SUPERVISOR)	(951)	275-9620	
US POSTAL SERVICE	(951)	737-0451	
RIVERSIDE UNIFIED SCHOOL DISTRICT	(951)	788-7134	
RIVERSIDE TRANSIT AGENCY			
	, ,		



VICINTY MAP THOMAS GUIDE - PAGE 745, E2 (2000 EDITION) NOT TO SCALE

SHEET INDEX

SHEET 1 TITLE SHEET

SHEET 2 INDEX MAP & CONSTRUCTION NOTES

SHEET 3 - 9 CONSTRUCTION PLAN

SHEET 10 - 16 HORIZONTAL CONTROL PLAN

SHEET 17 & 19 EROSION CONTROL SHEETS

SHEET 20 & 22 DEMOLITION SHEETS

SHEET 23 DETAIL SHEETS

REPRESENTATIVE:

IAN DAVIDSON LANSCAPE ARCHITECT. INC. 3744 TENTH STREET, SUITE 200 RIVERSIDE, CA. 92502 PH: (951) 683-1283 FAX: (951) 683-4352

ENGINEER:

IW CONSULTING ENGINEERS, INC. 3544 UNIVERSITY AVENUE RIVERSIDE, CA 92501 PH: (951) 687-2929 FAX: (951) 687-2999

SOURCE OF TOPOGRAPHY:

SO-CAL ENGINEERING 5750 DIVISION STREET, SUITE 203 RIVERSIDE, CA 92506 PH: (951) 787-0427 FAX: (951) 784-8131

FIELD TOPOGRAPHIC SURVEY PERFORMED ON 10/2006 & 05/2007

WATER: CITY OF RIVERSIDE SEWER: CITY OF RIVERSIDE ELECTRICITY: CITY OF RIVERSIDE THE GAS COMPANY GAS:

TELEPHONE: PACIFIC BELL AIR WAVES/CHARTER COMMUNICATIONS TELEVISION:

LEGEND

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HATCH LEGEND PROPOSED SIDEWALK (SEE LANDSCAPE ARCHITECT PLAN) PROPOSED DECORATIVE PAVERS (SEE LANDSCAPE ARCHITECT PLAN) PROPOSED CONCRETE PAVING PROPOSED GRANITE PAVERS (SEE LANDSCAPE ARCHITECT PLAN) PROPOSED COLORED CONCRETE

(SEE LANDSCAPE ARCHITECT PLAN) PROPOSED LANDSCAPE (SEE LANDSCAPE ARCHITECT PLAN) PROPOSED PAVING

PROPOSED COLD MILL AND 1' MIN. THICK DG AC.

PW 07-0379 PW 07-0217

M-457 SHEET_2_OF_100

10TH STREET TO 5TH STREET

REVITALIZATION TITLE SHEET

TOP OF CURB

PAD ELEVATION

PROTECT IN PLACE

TO BE RELOCATED

INVERT OF PIPE ELEVATION

SIDEWALK

CITY OF RIVERSIDE

MAIN STREET

(51)(56)

ACCOUNT NO.

VERT. SCALE: N/A

A PUBLIC SERVICE BY

BEFORE **YOU DIG** YOU DIG

FROM ANY AND ALL LIABILITY, REAL OR ALLEGED, IN CONNECTION WITH THE PERFORMANCE OF WORK ON THIS PROJECT, EXCEPTING LIABILITY ARISING FROM THE SOLE NEGLIGENCE OF DESIGN PROFESSIONAL

CONSTRUCTION CONTRACTOR AGREES THAT IN ACCORDANCE WITH GENERALLY ACCEPTED CONSTRUCTION PRACTICES, CONSTRUCTION CONTRACTOR WILL BE REQUIRED TO ASSUME SOLE AND COMPLETE RESPONSIBILITY FOR JOB SITE CONDITIONS DURING THE COURSE OF CONSTRUCTION OF THE PROJECT. INCLUDING THE SAFETY OF ALL PERSONS AND PROPERTY THAT THIS REQUIREMENT SHALL BE MADE TO APPLY CONTINUOUSLY AND NOT BE LIMITED O NORMAL WORKING HOURS, AND CONSTRUCTION CONTRACTOR FURTHER AGREES TO DEFEND, INDEMNIFY AND HOLD DESIGN PROFESSIONAL HARMLESS

PRIVATE ENGINEERING NOTE

CITY BUSINESS CERTIFICATE NO. 106198, EXP. 1/1/2008 IW Consulting Engineers, Inc. · Civil Engineering Surveying Land Planning 3544 University Avenue Tel: 951.687.2929 Riverside, CA 92501 Fax: 951.687.2999

No. 60874 Exp.12/31/08

3/25/08 R.C.E. 60874 (EXP. 12-31-08) BENCHMARK: 16-13 P.K. NAIL IN TOP OF CURB ALONG TENTH STREET 12 FEET SOUTHEASTERLY OF THE CURB RETURN AT THE MOST SOUTHEASTERLY

CORNER OF TENTH STREET AND MARKET STREET. ELEVATION: 840.914

PLANS PREPARED UNDER SUPERVISION OF

THIS PLAN SUPERSEDES PLAN DATED 9/19/2007

3/20/2008 - PHASE 1

APPR. DATE DESIGNED BY AW/DY DRAWN BY JC/DY CHECKED BY AW/FI

CONSTRUCTION CONTRACT ADMIN

APPROVED BY

RAFFIC DIVISION

CITY OF RIVERSIDE, CALIFORNIA


PUBLIC WORKS DEPARTMENT


BY DATE APPROVED BY


(951) 787-7911


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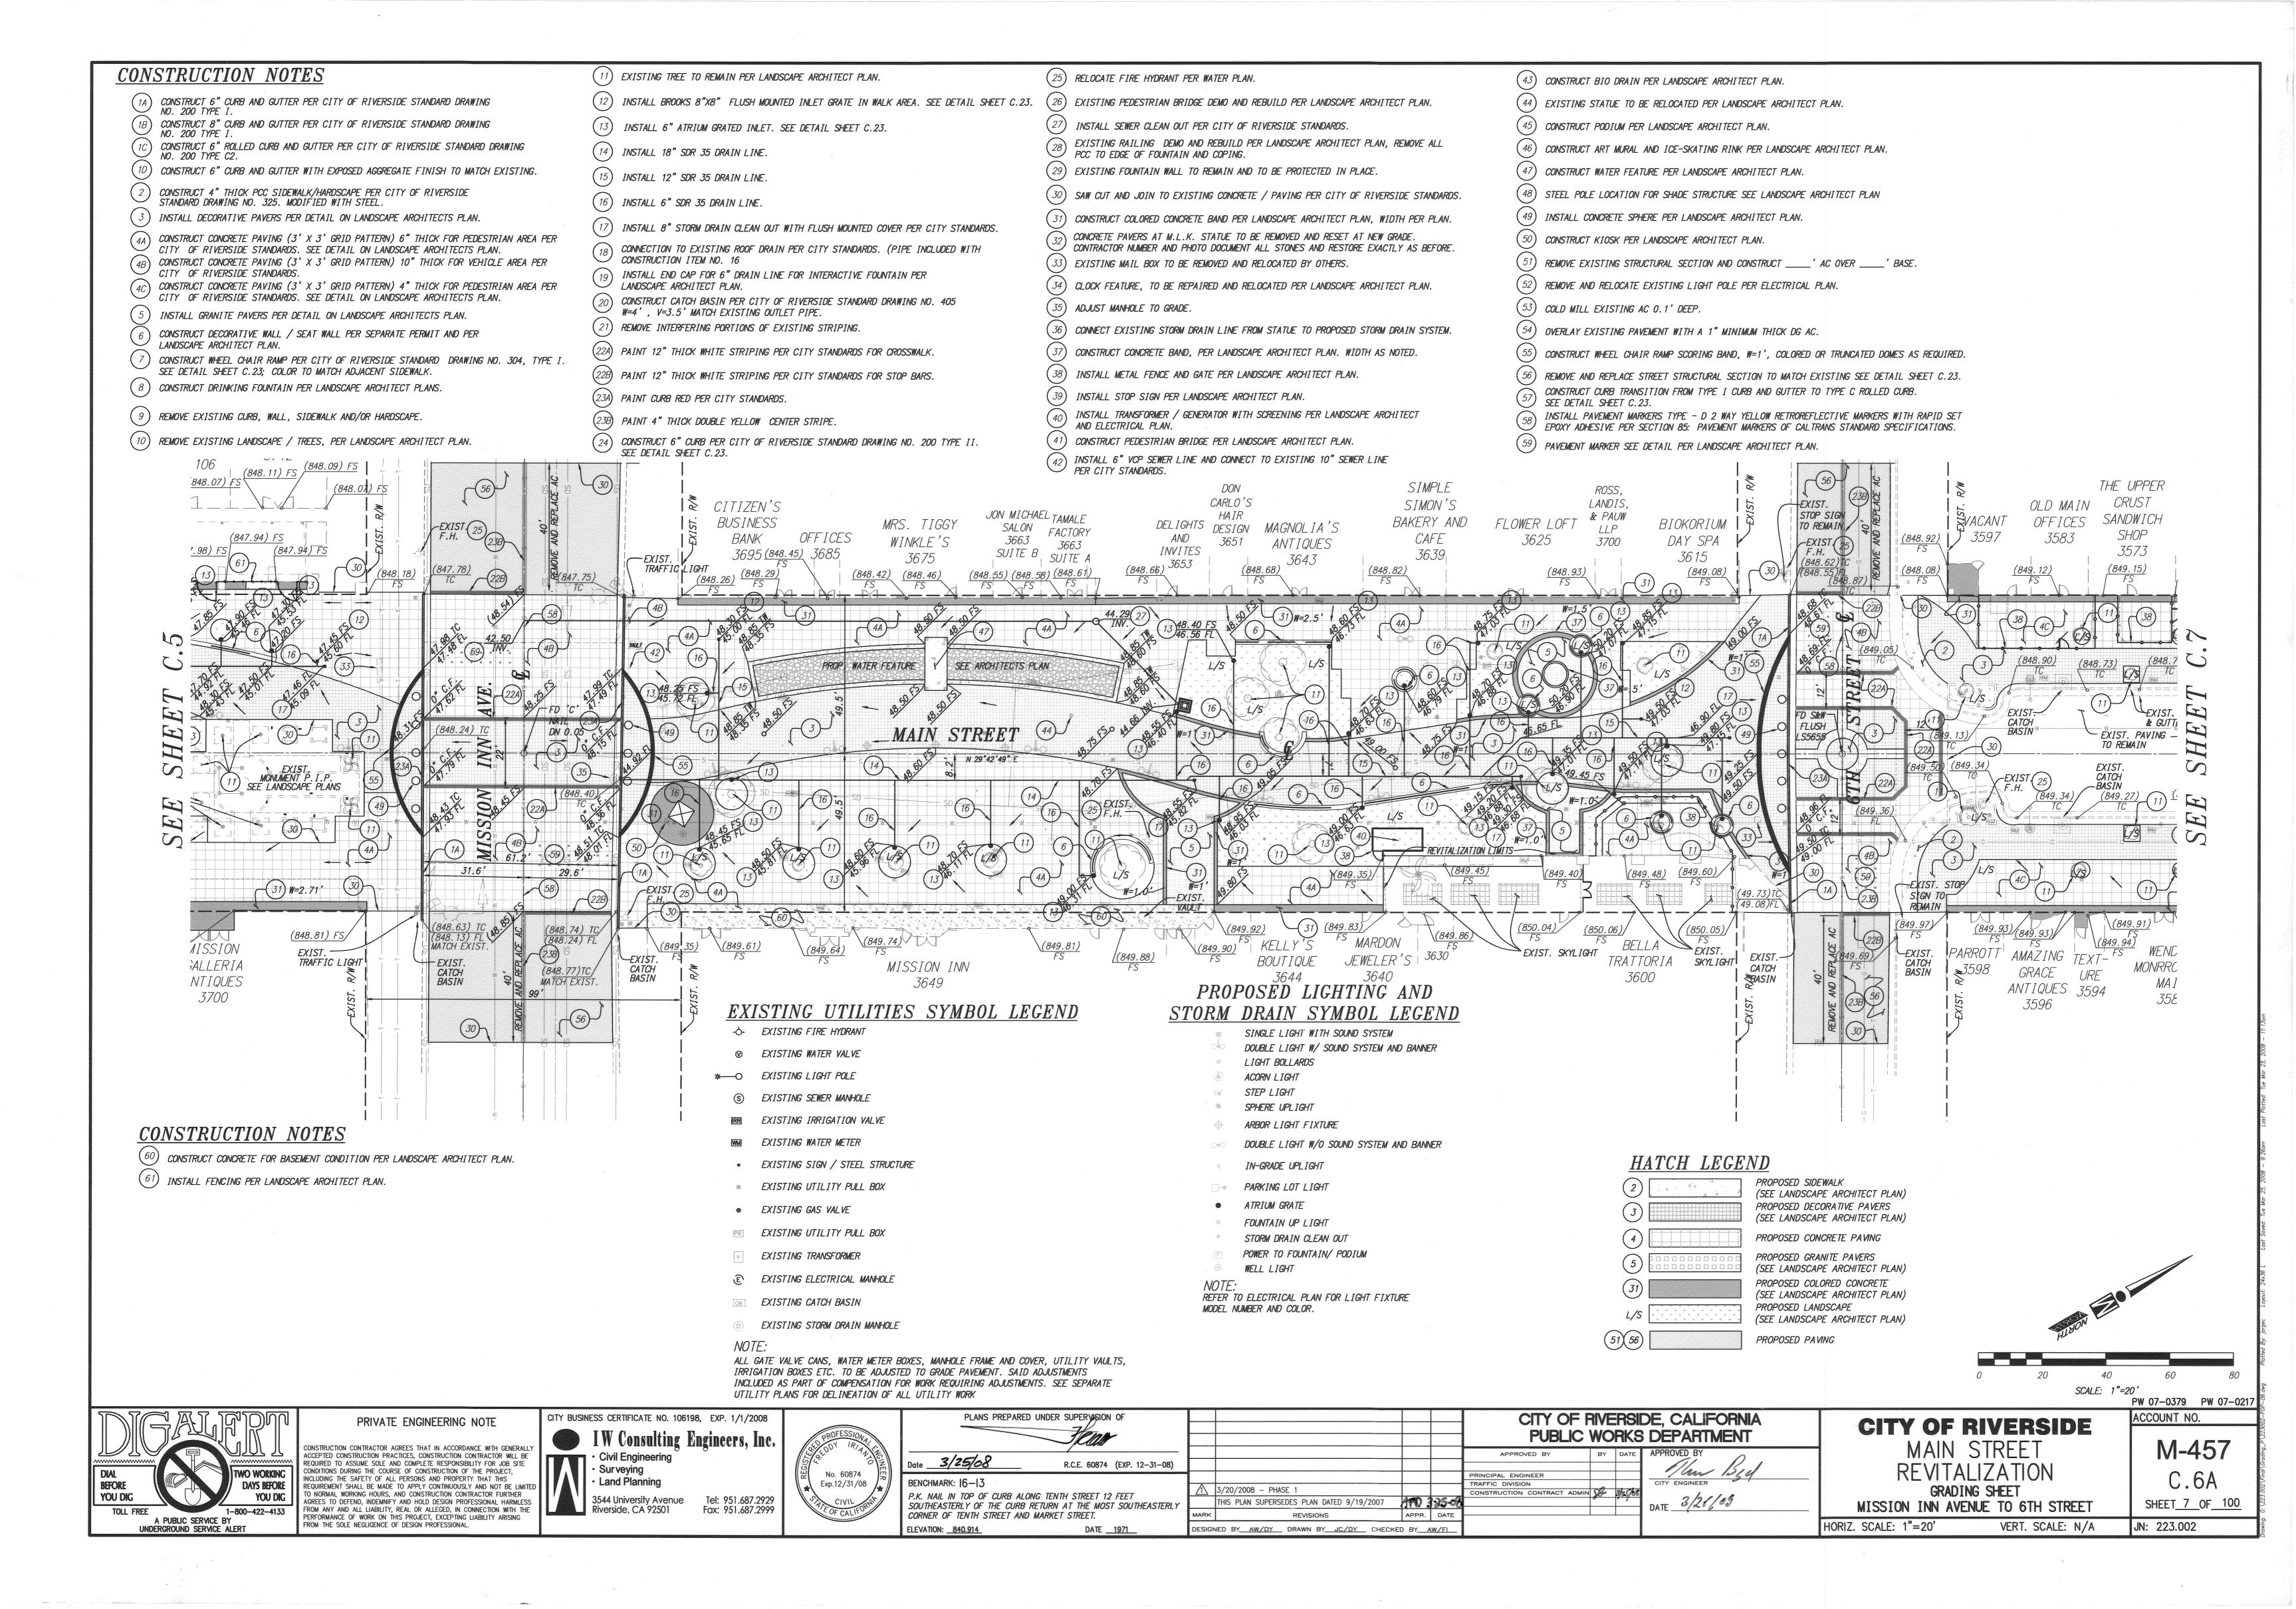
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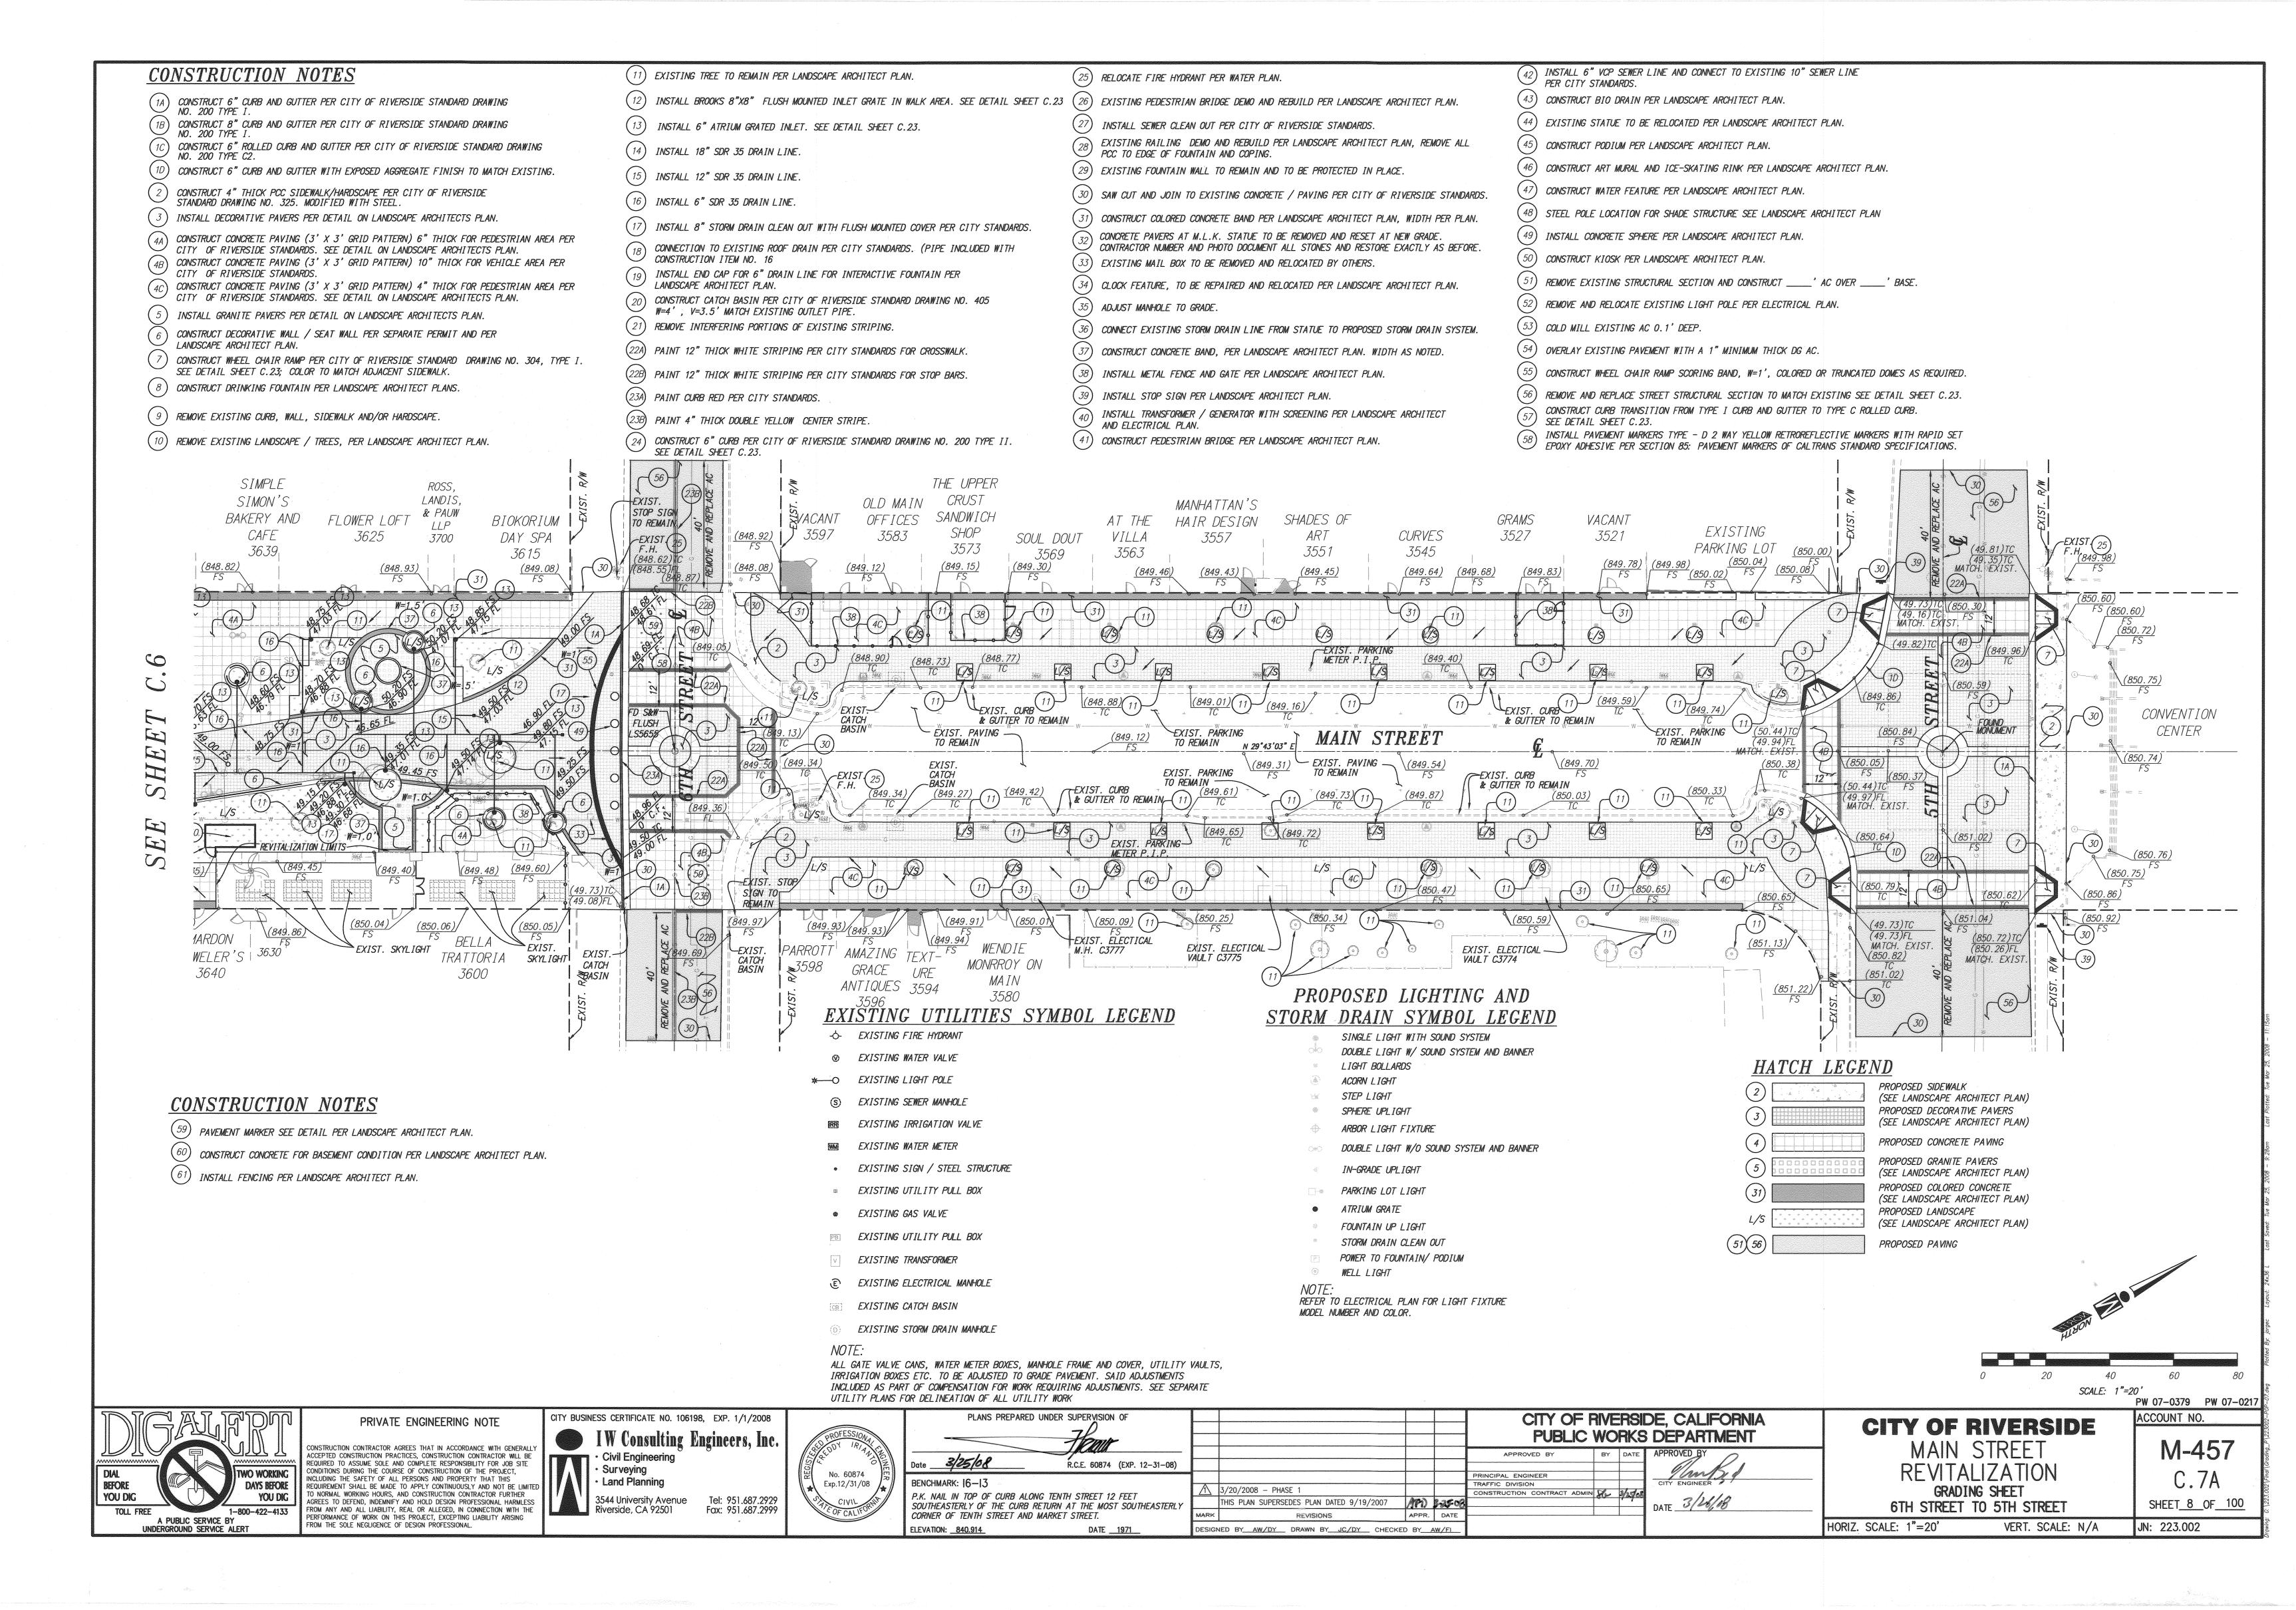





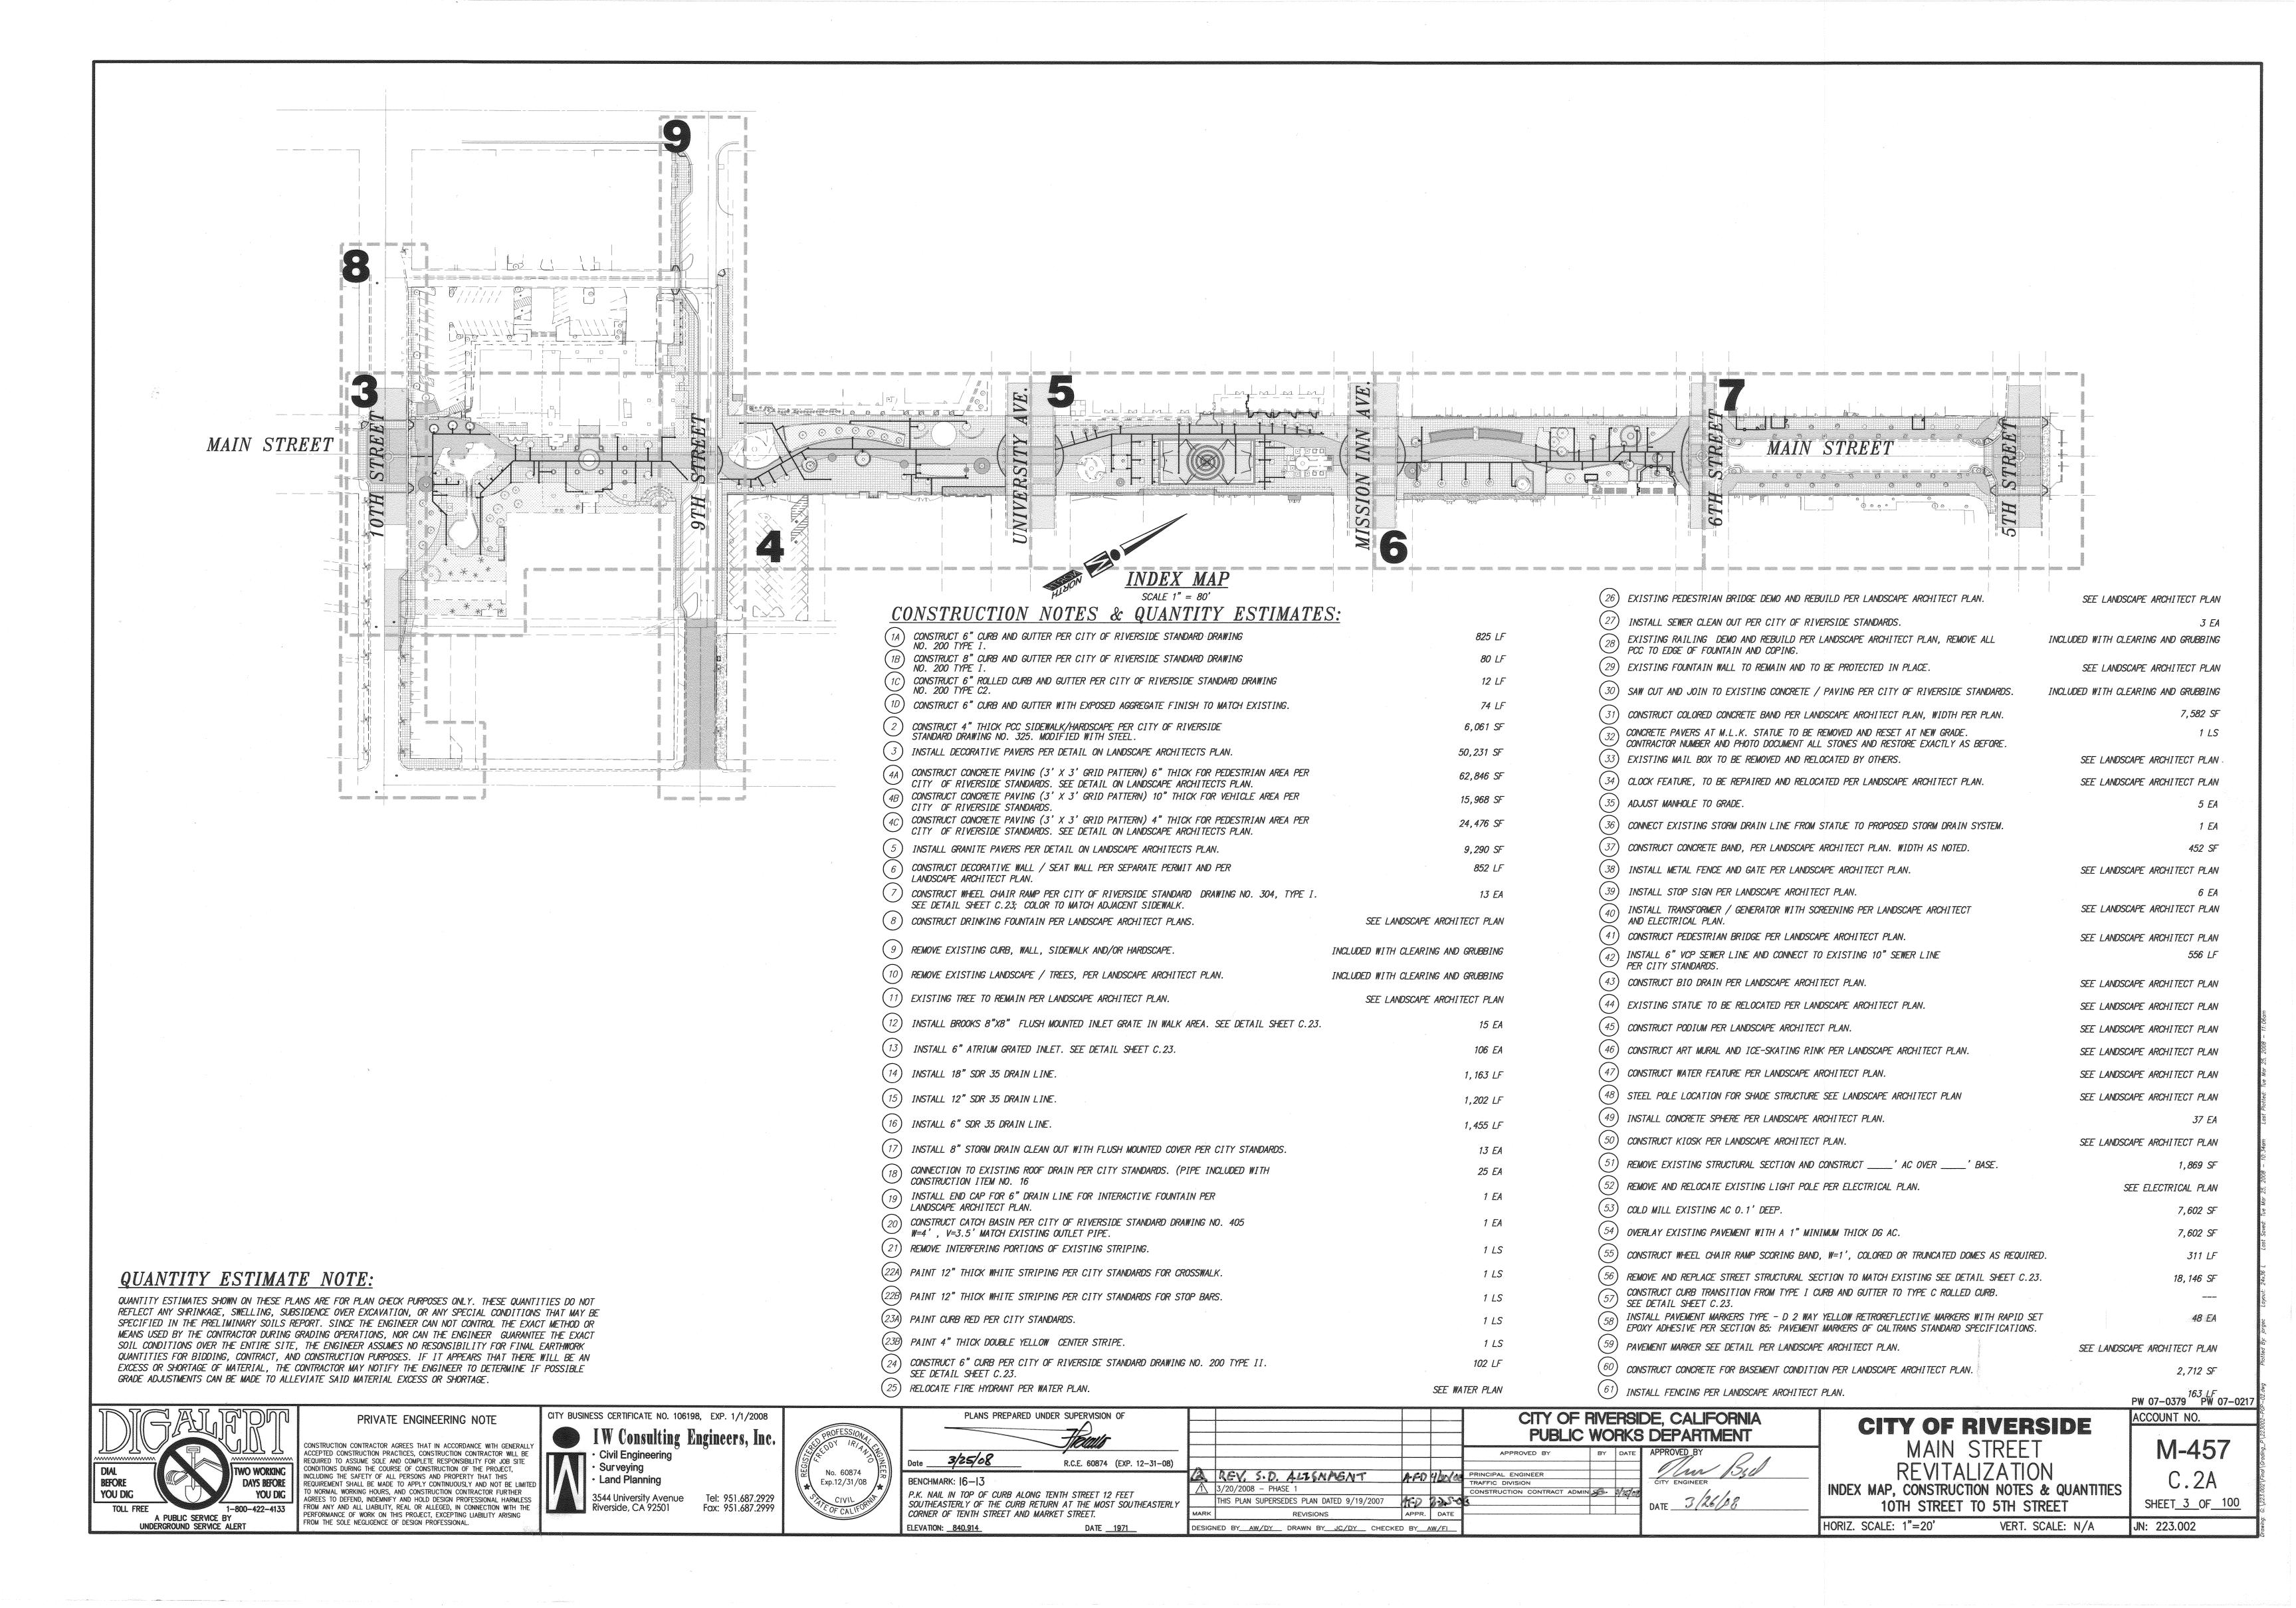


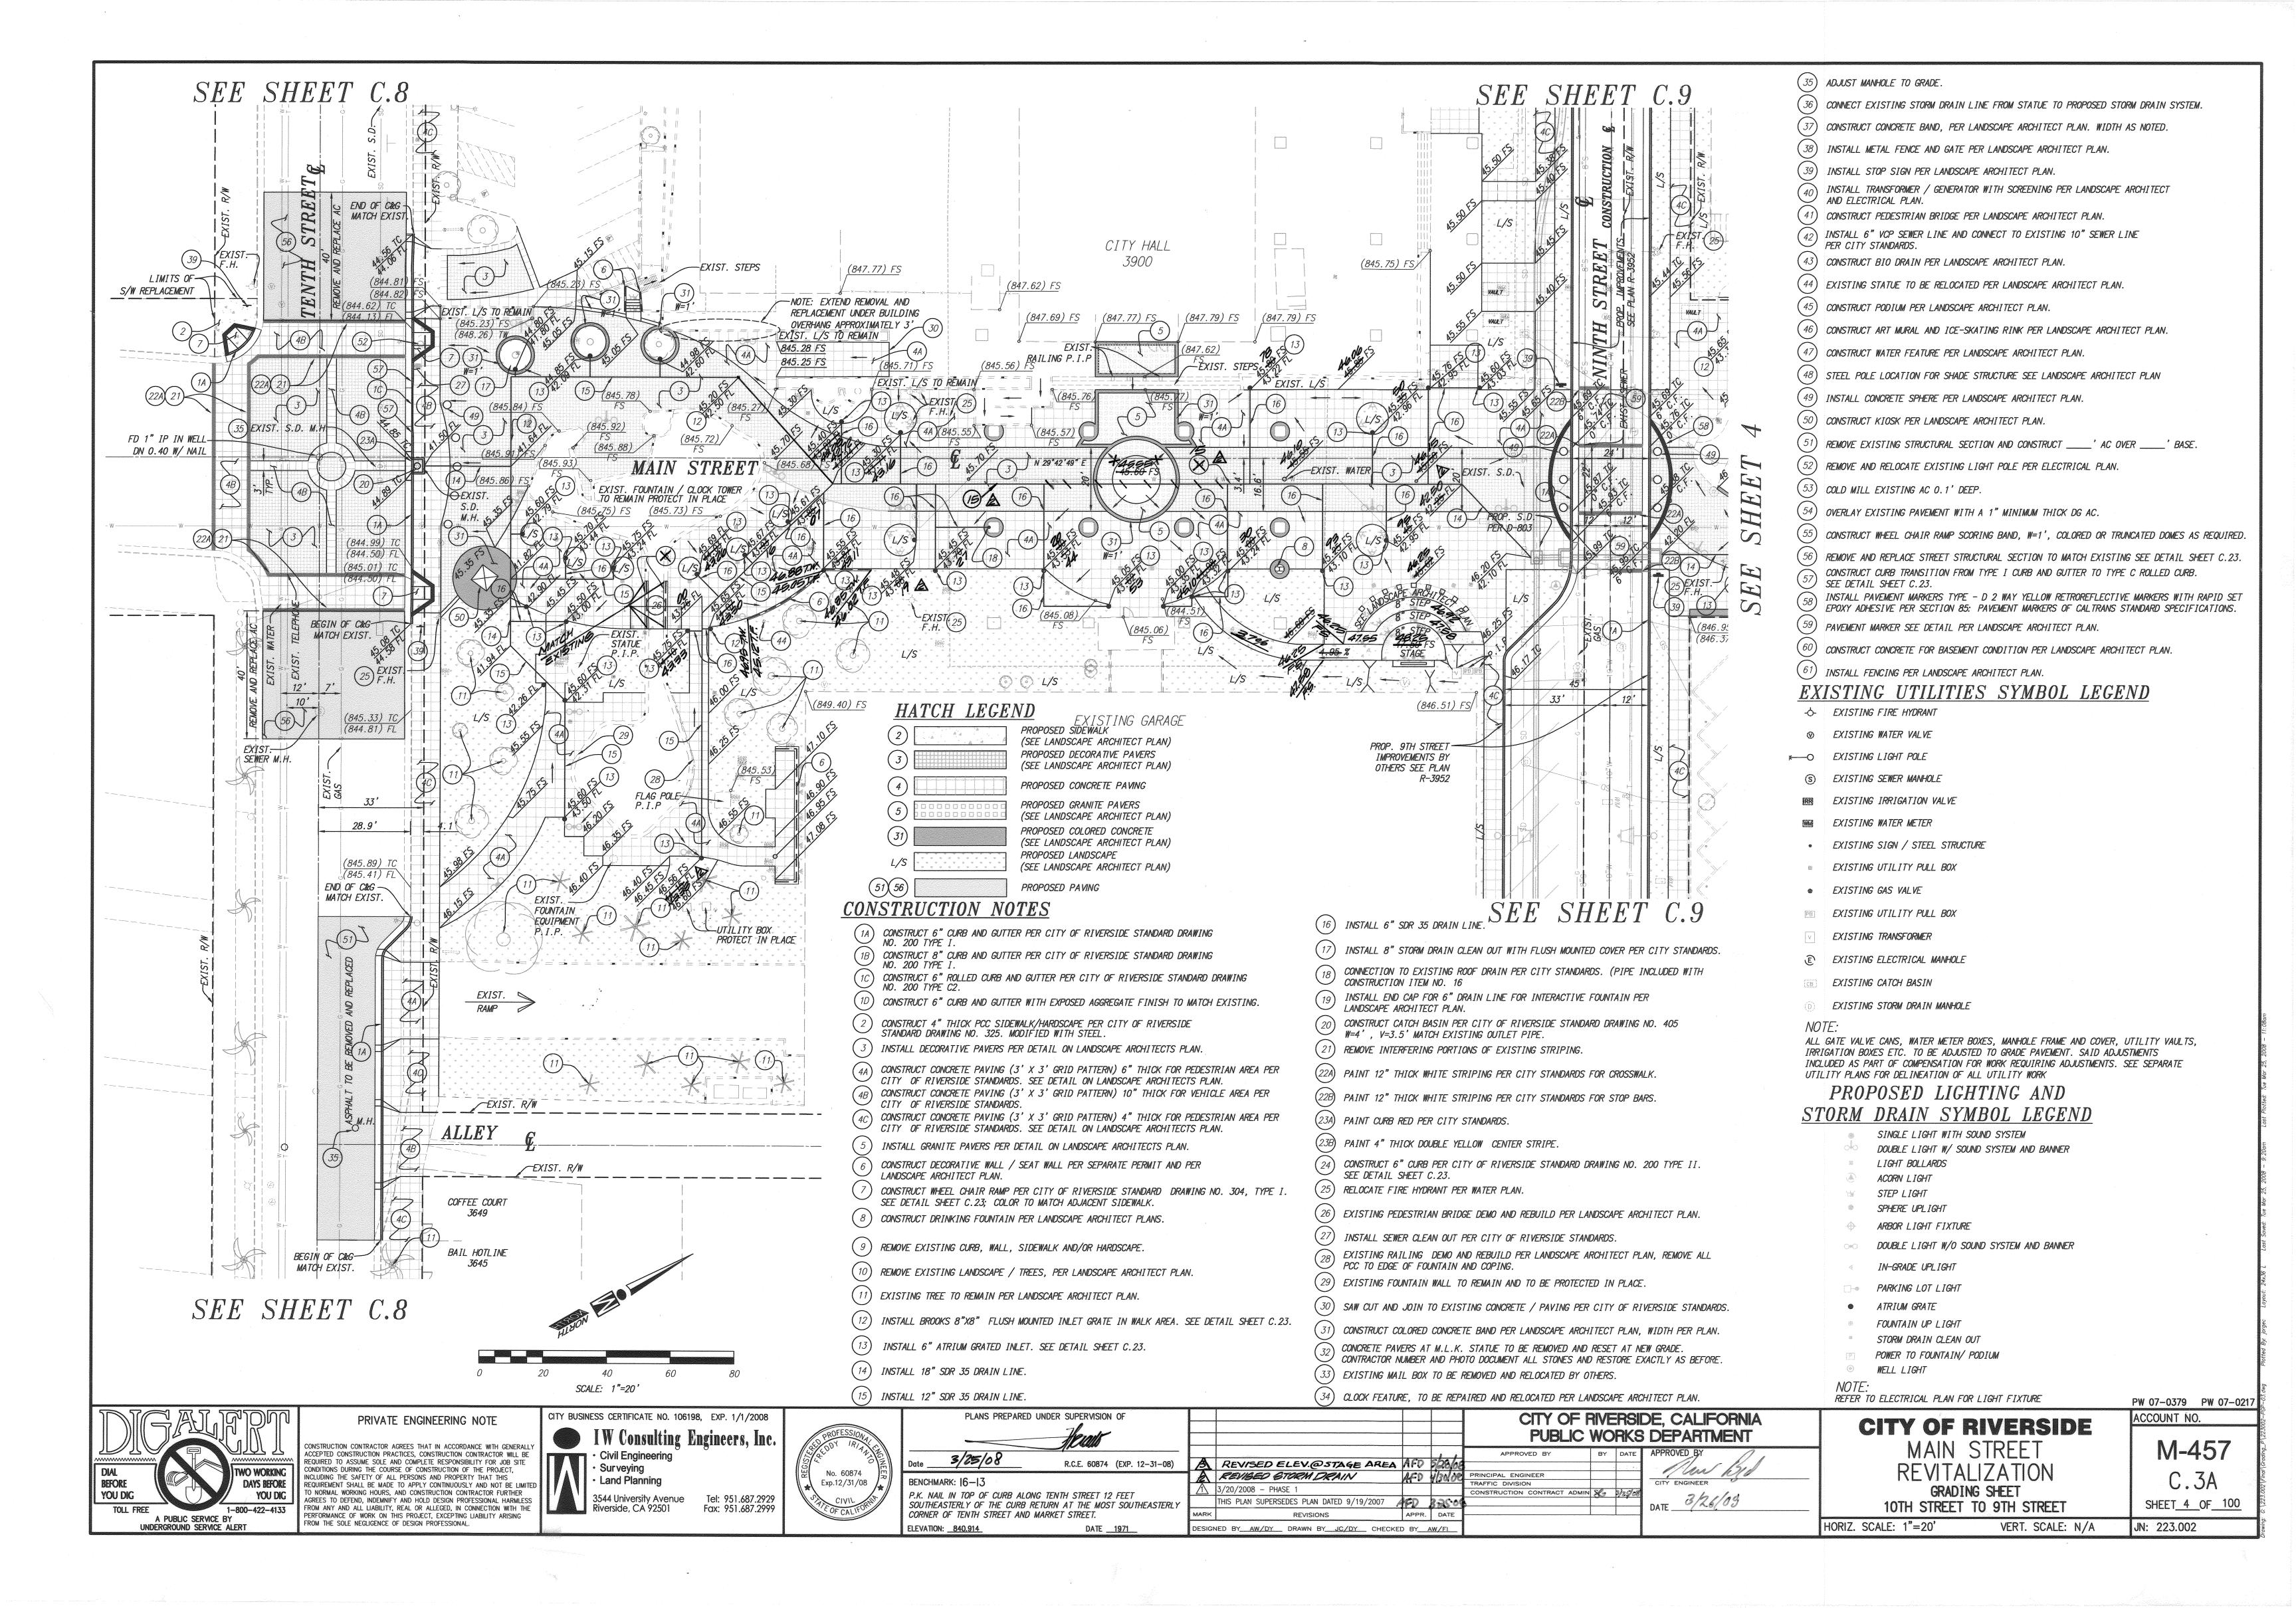


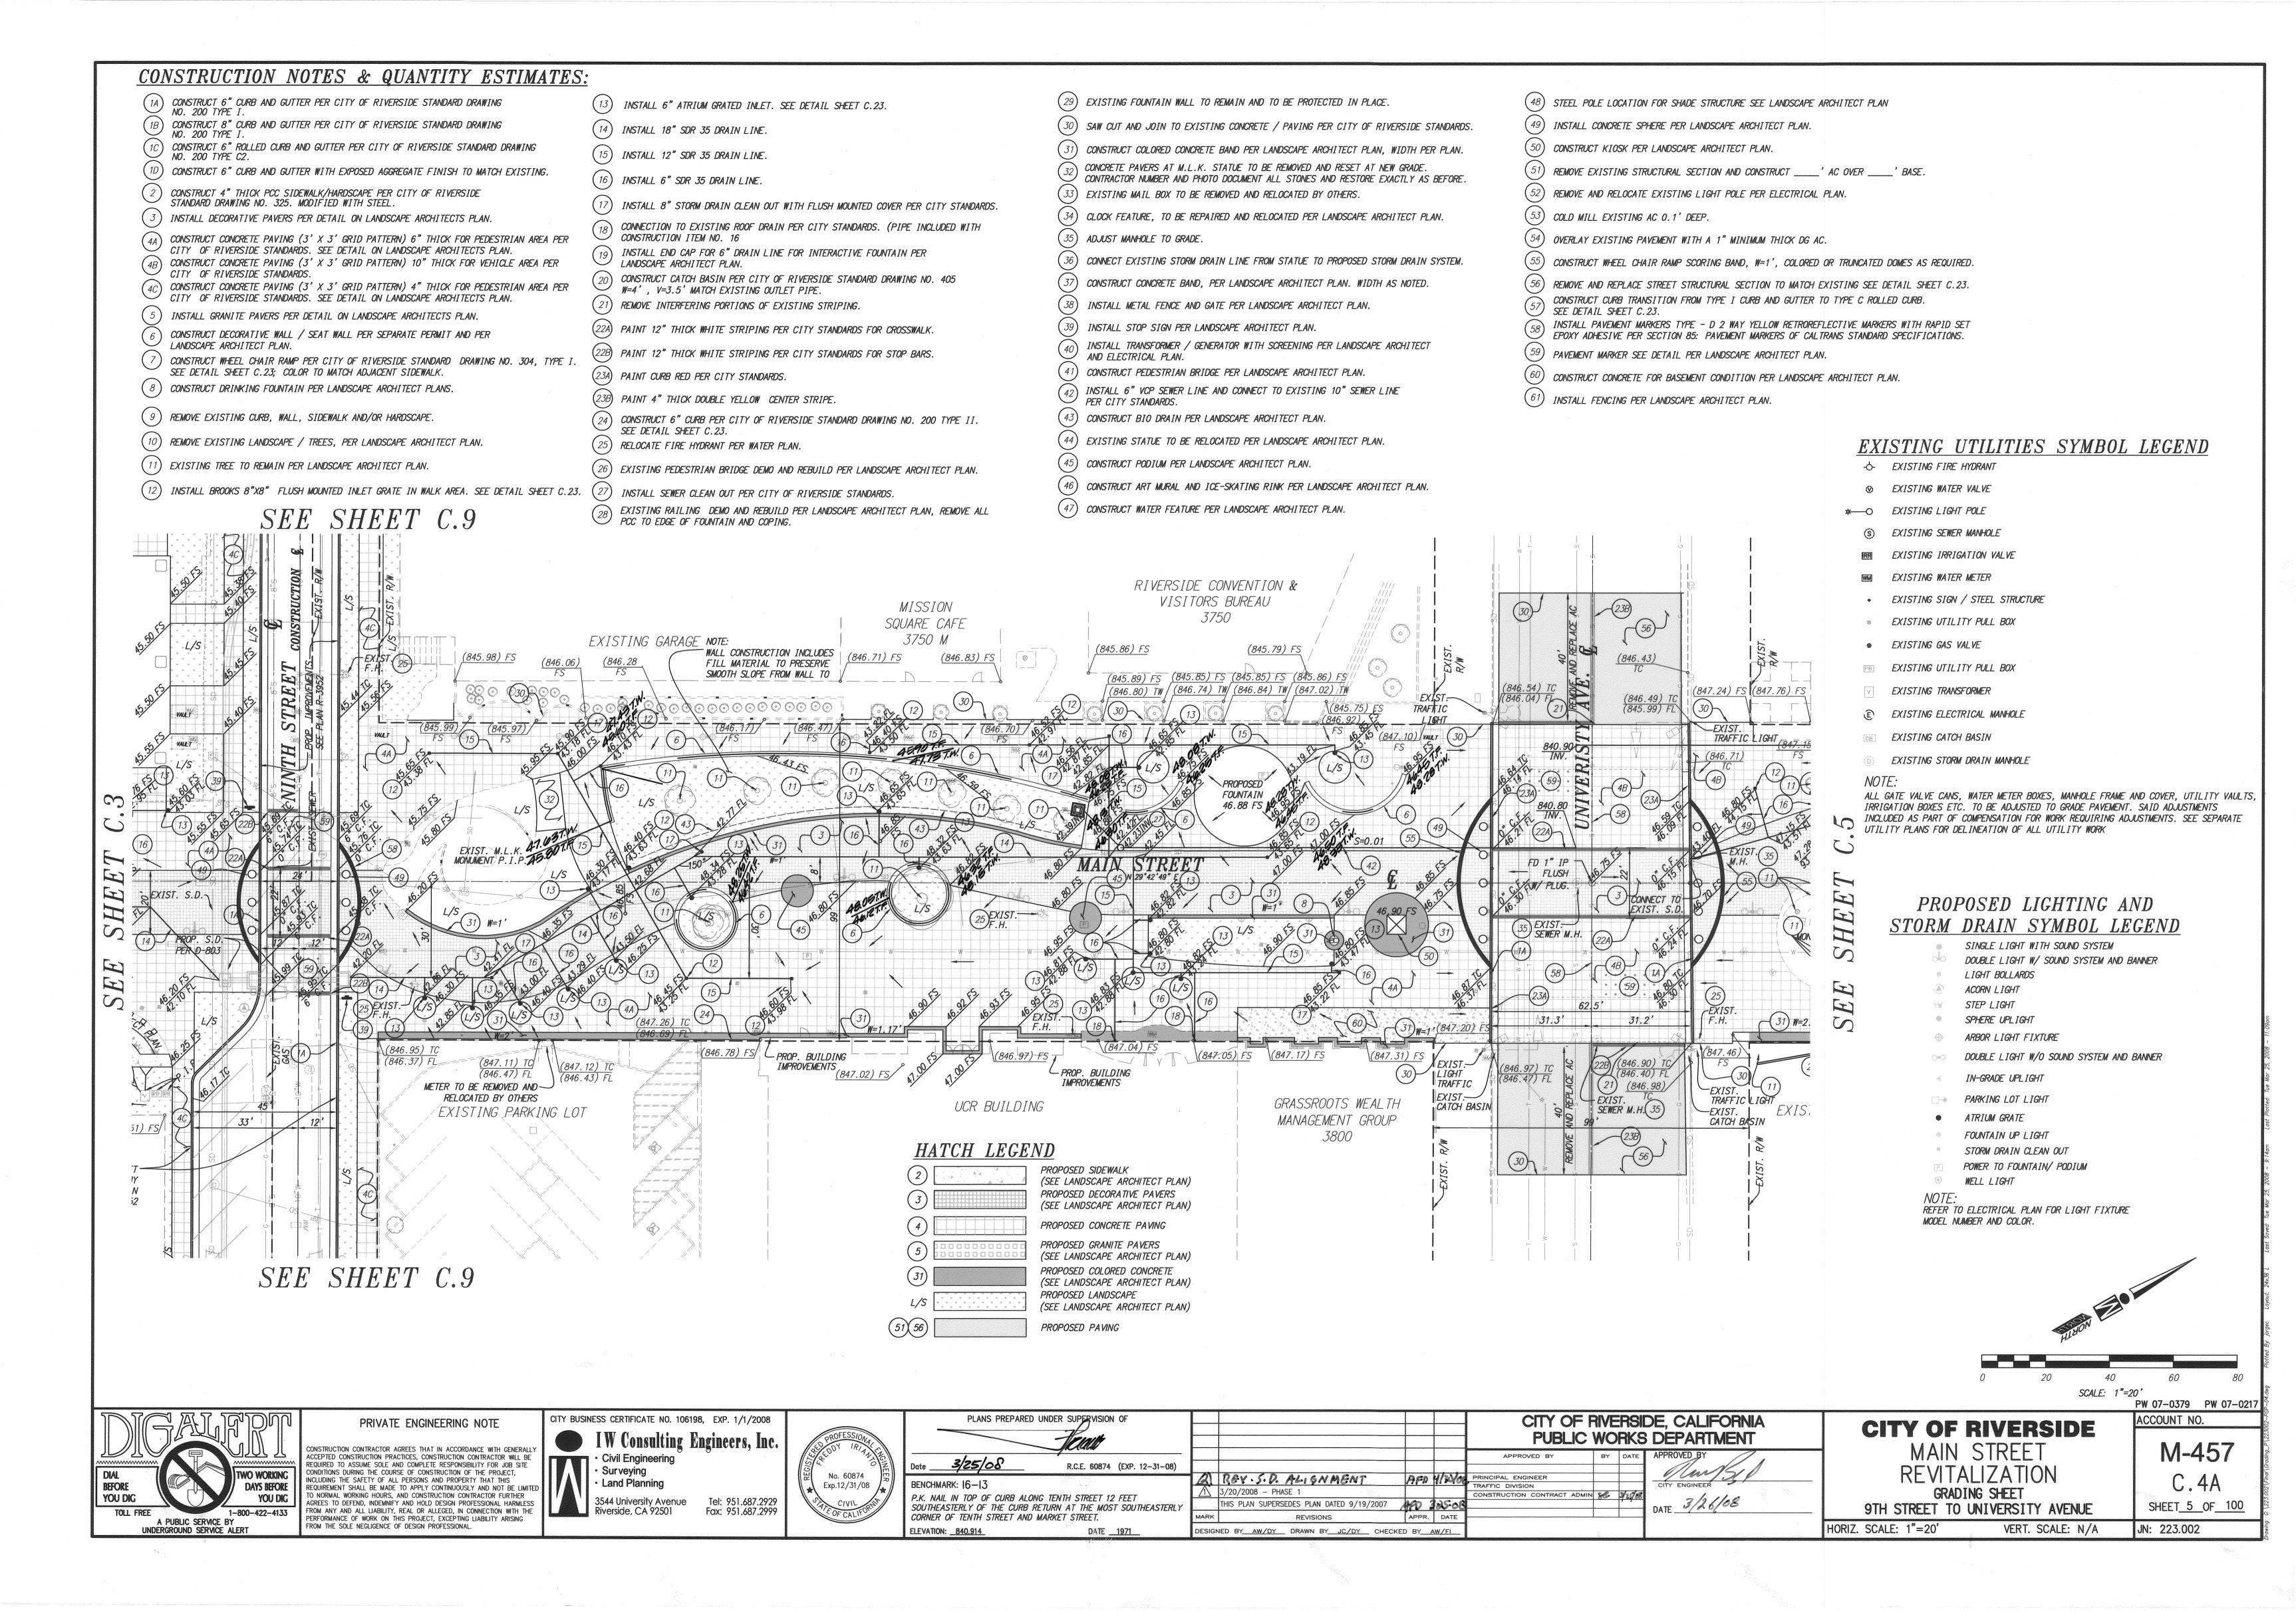


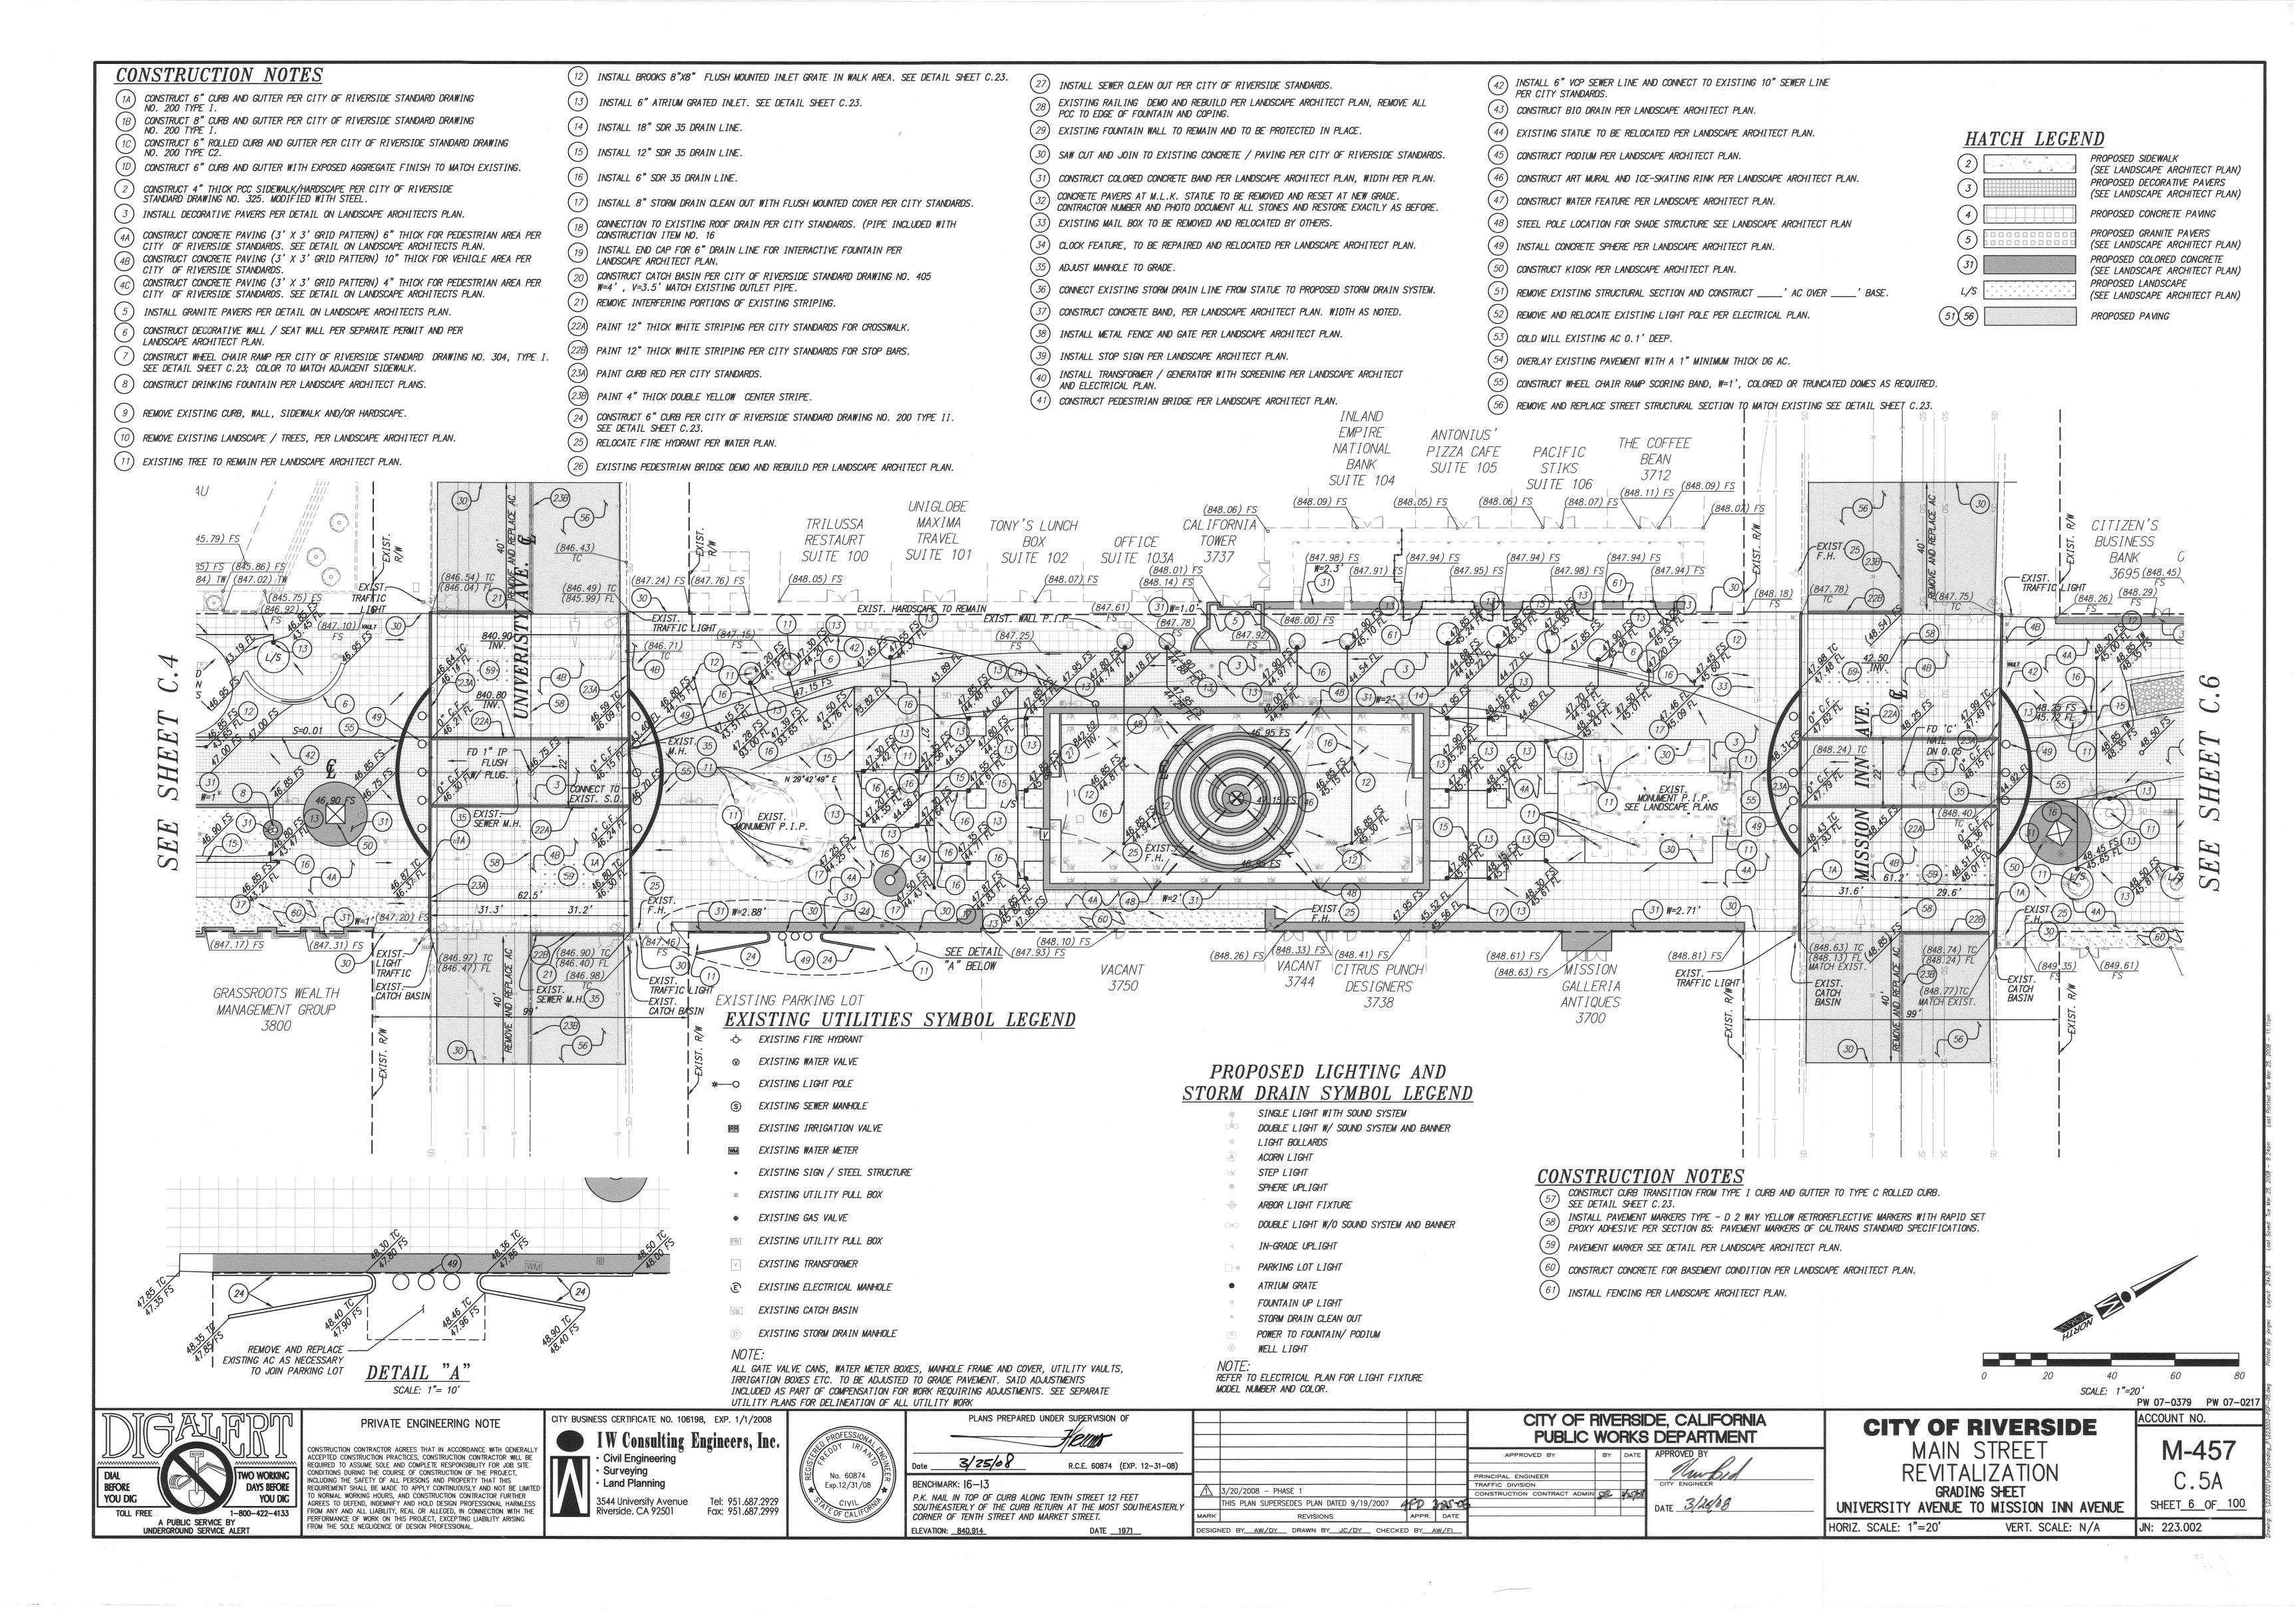

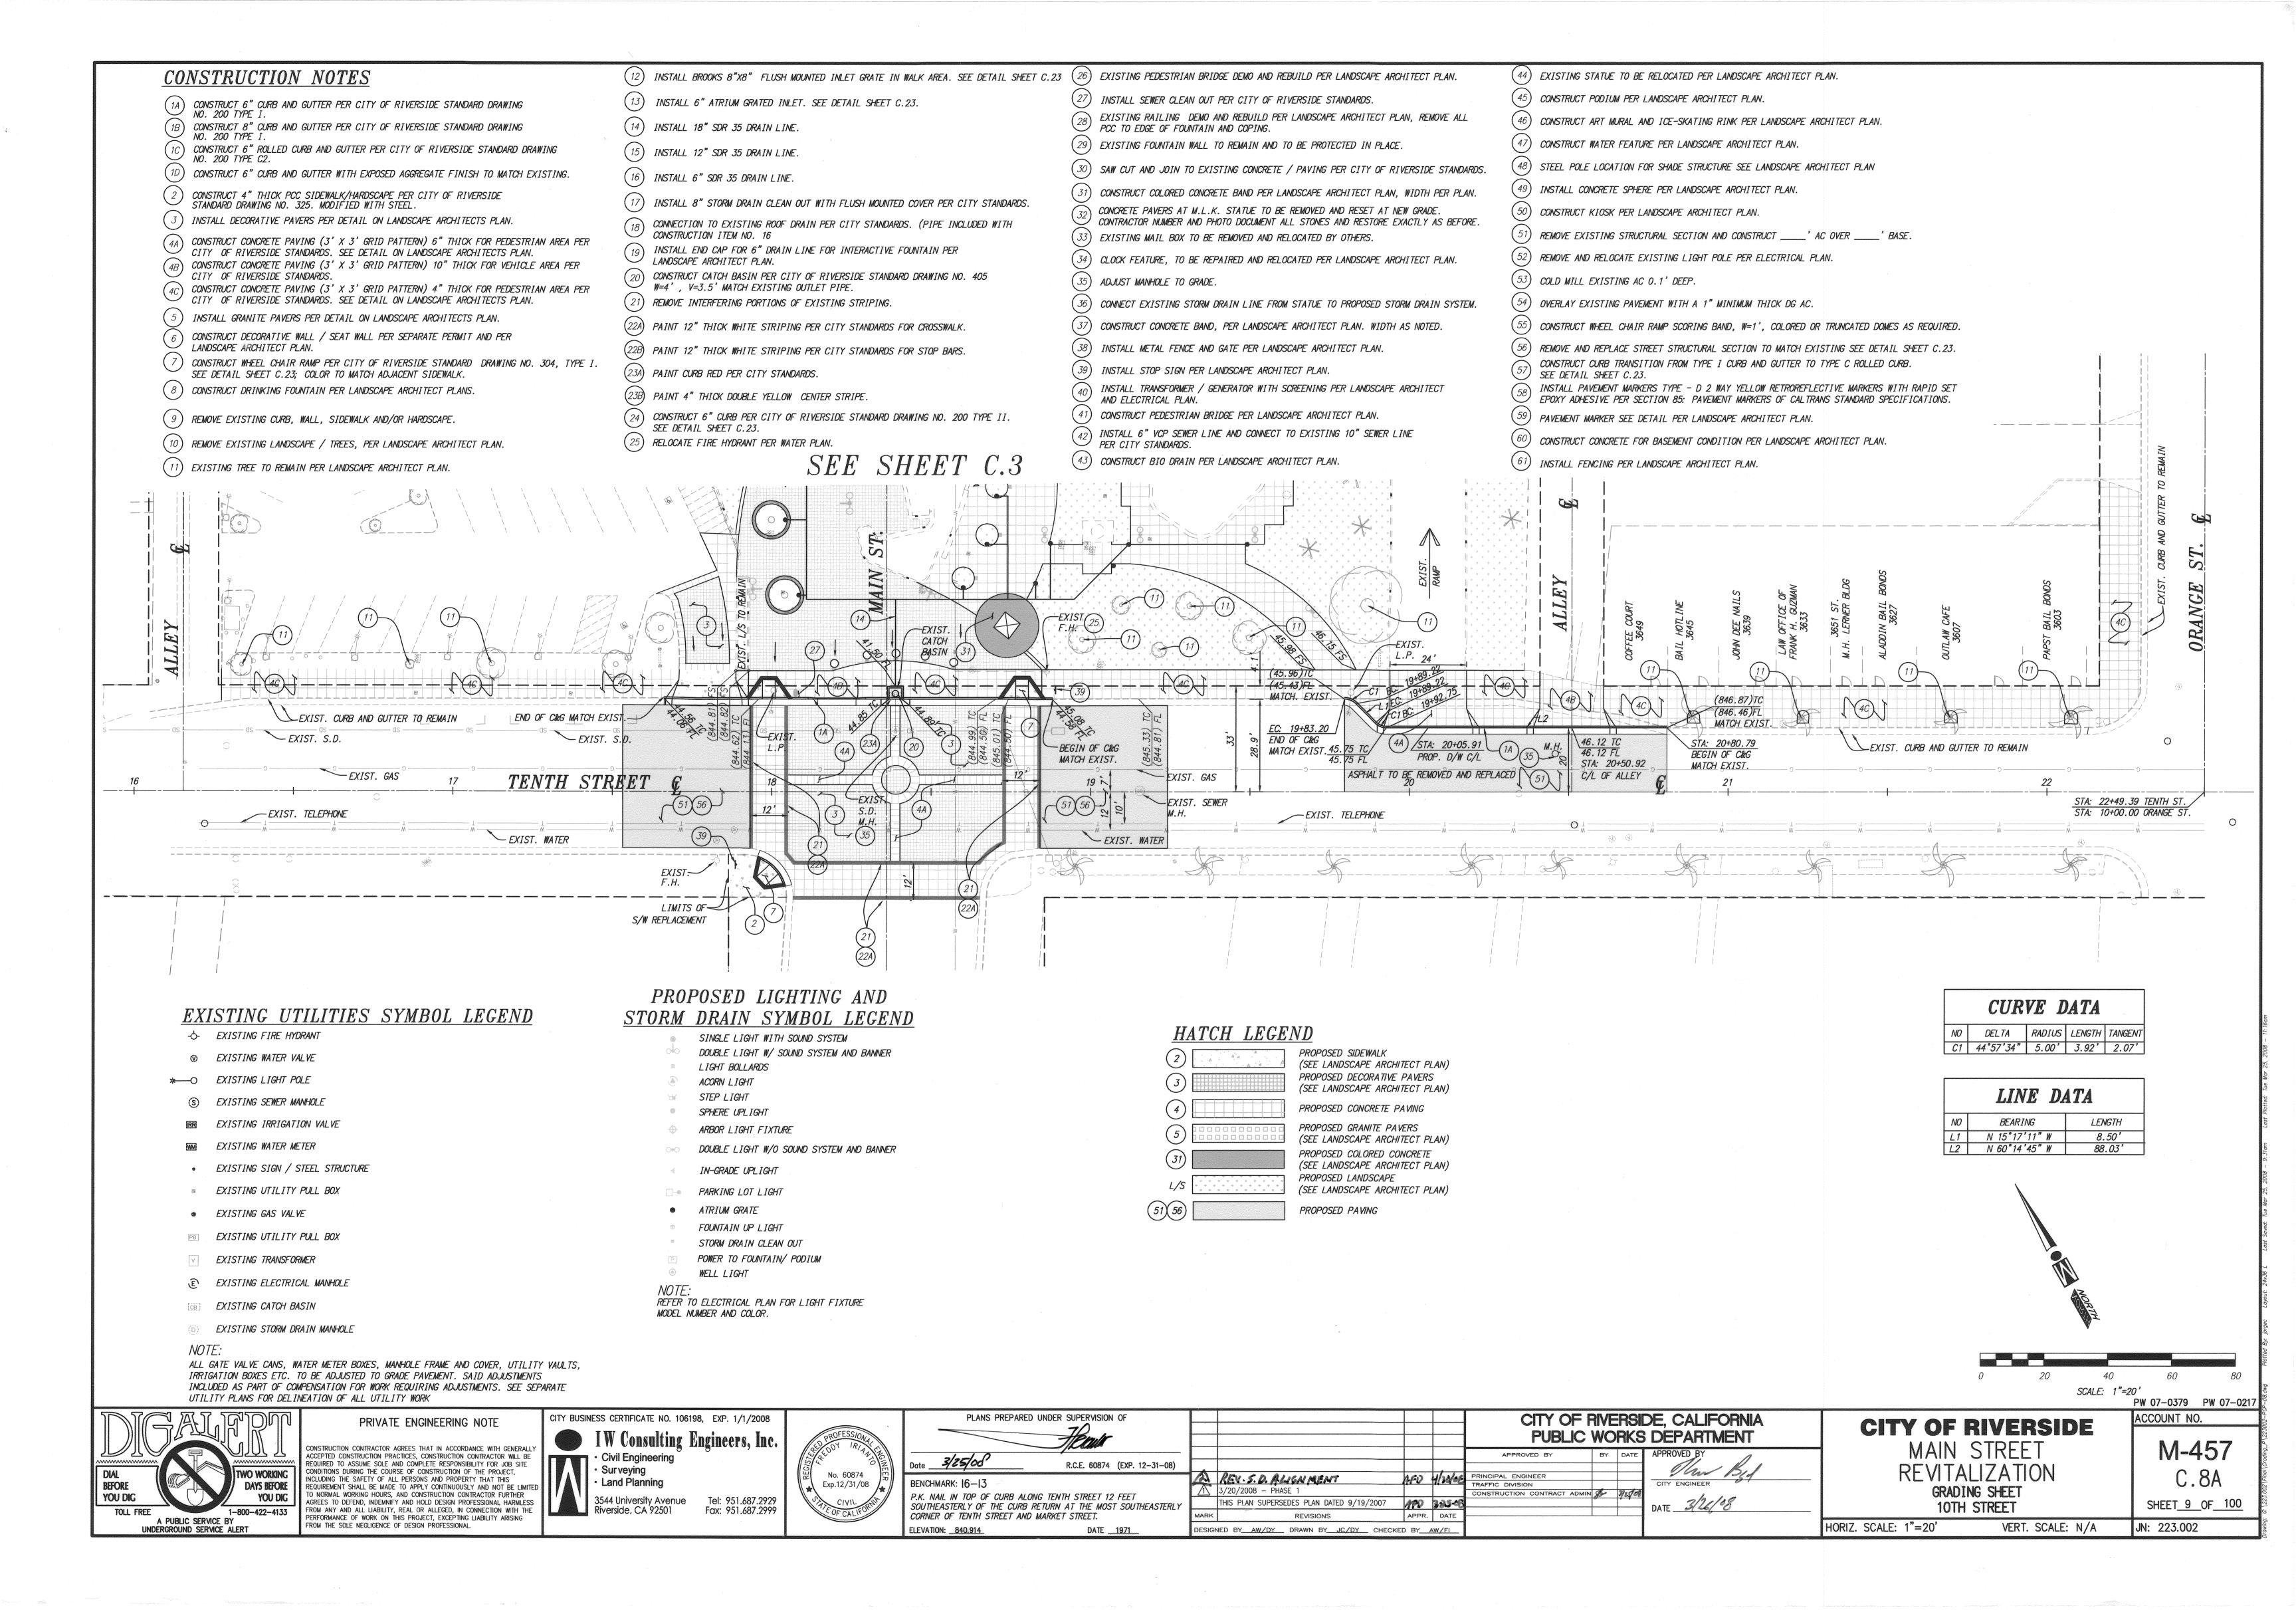

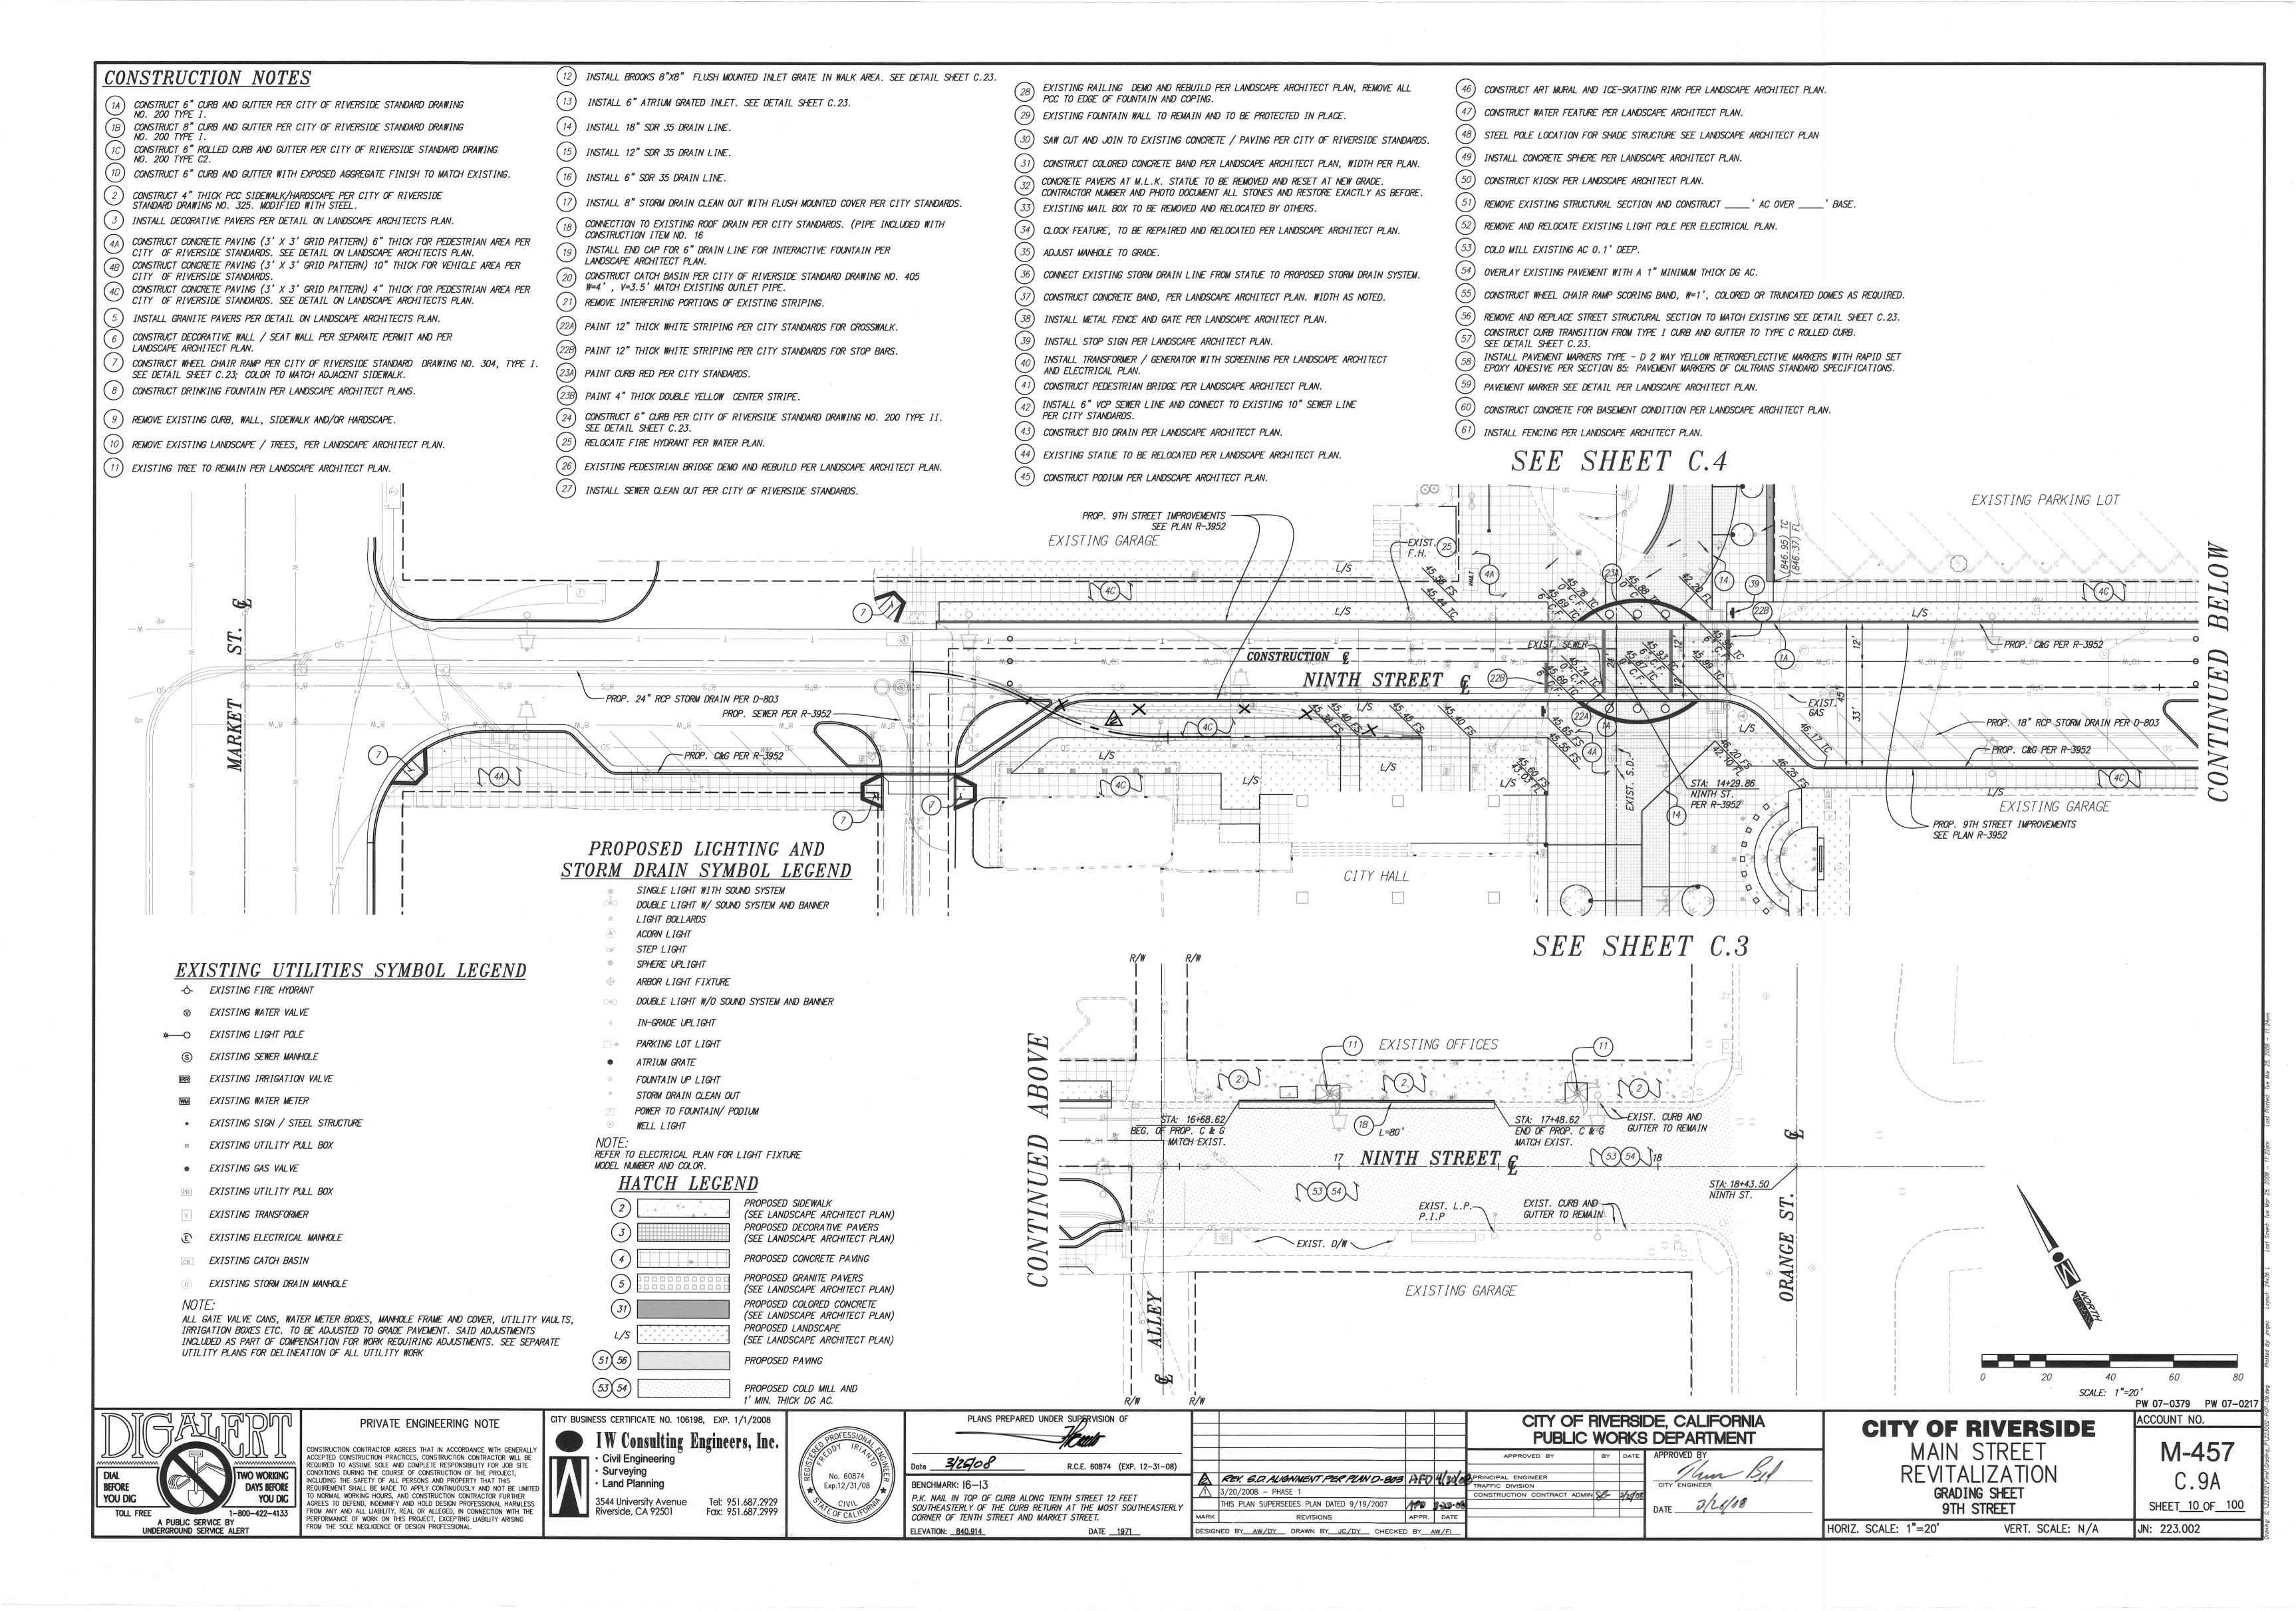


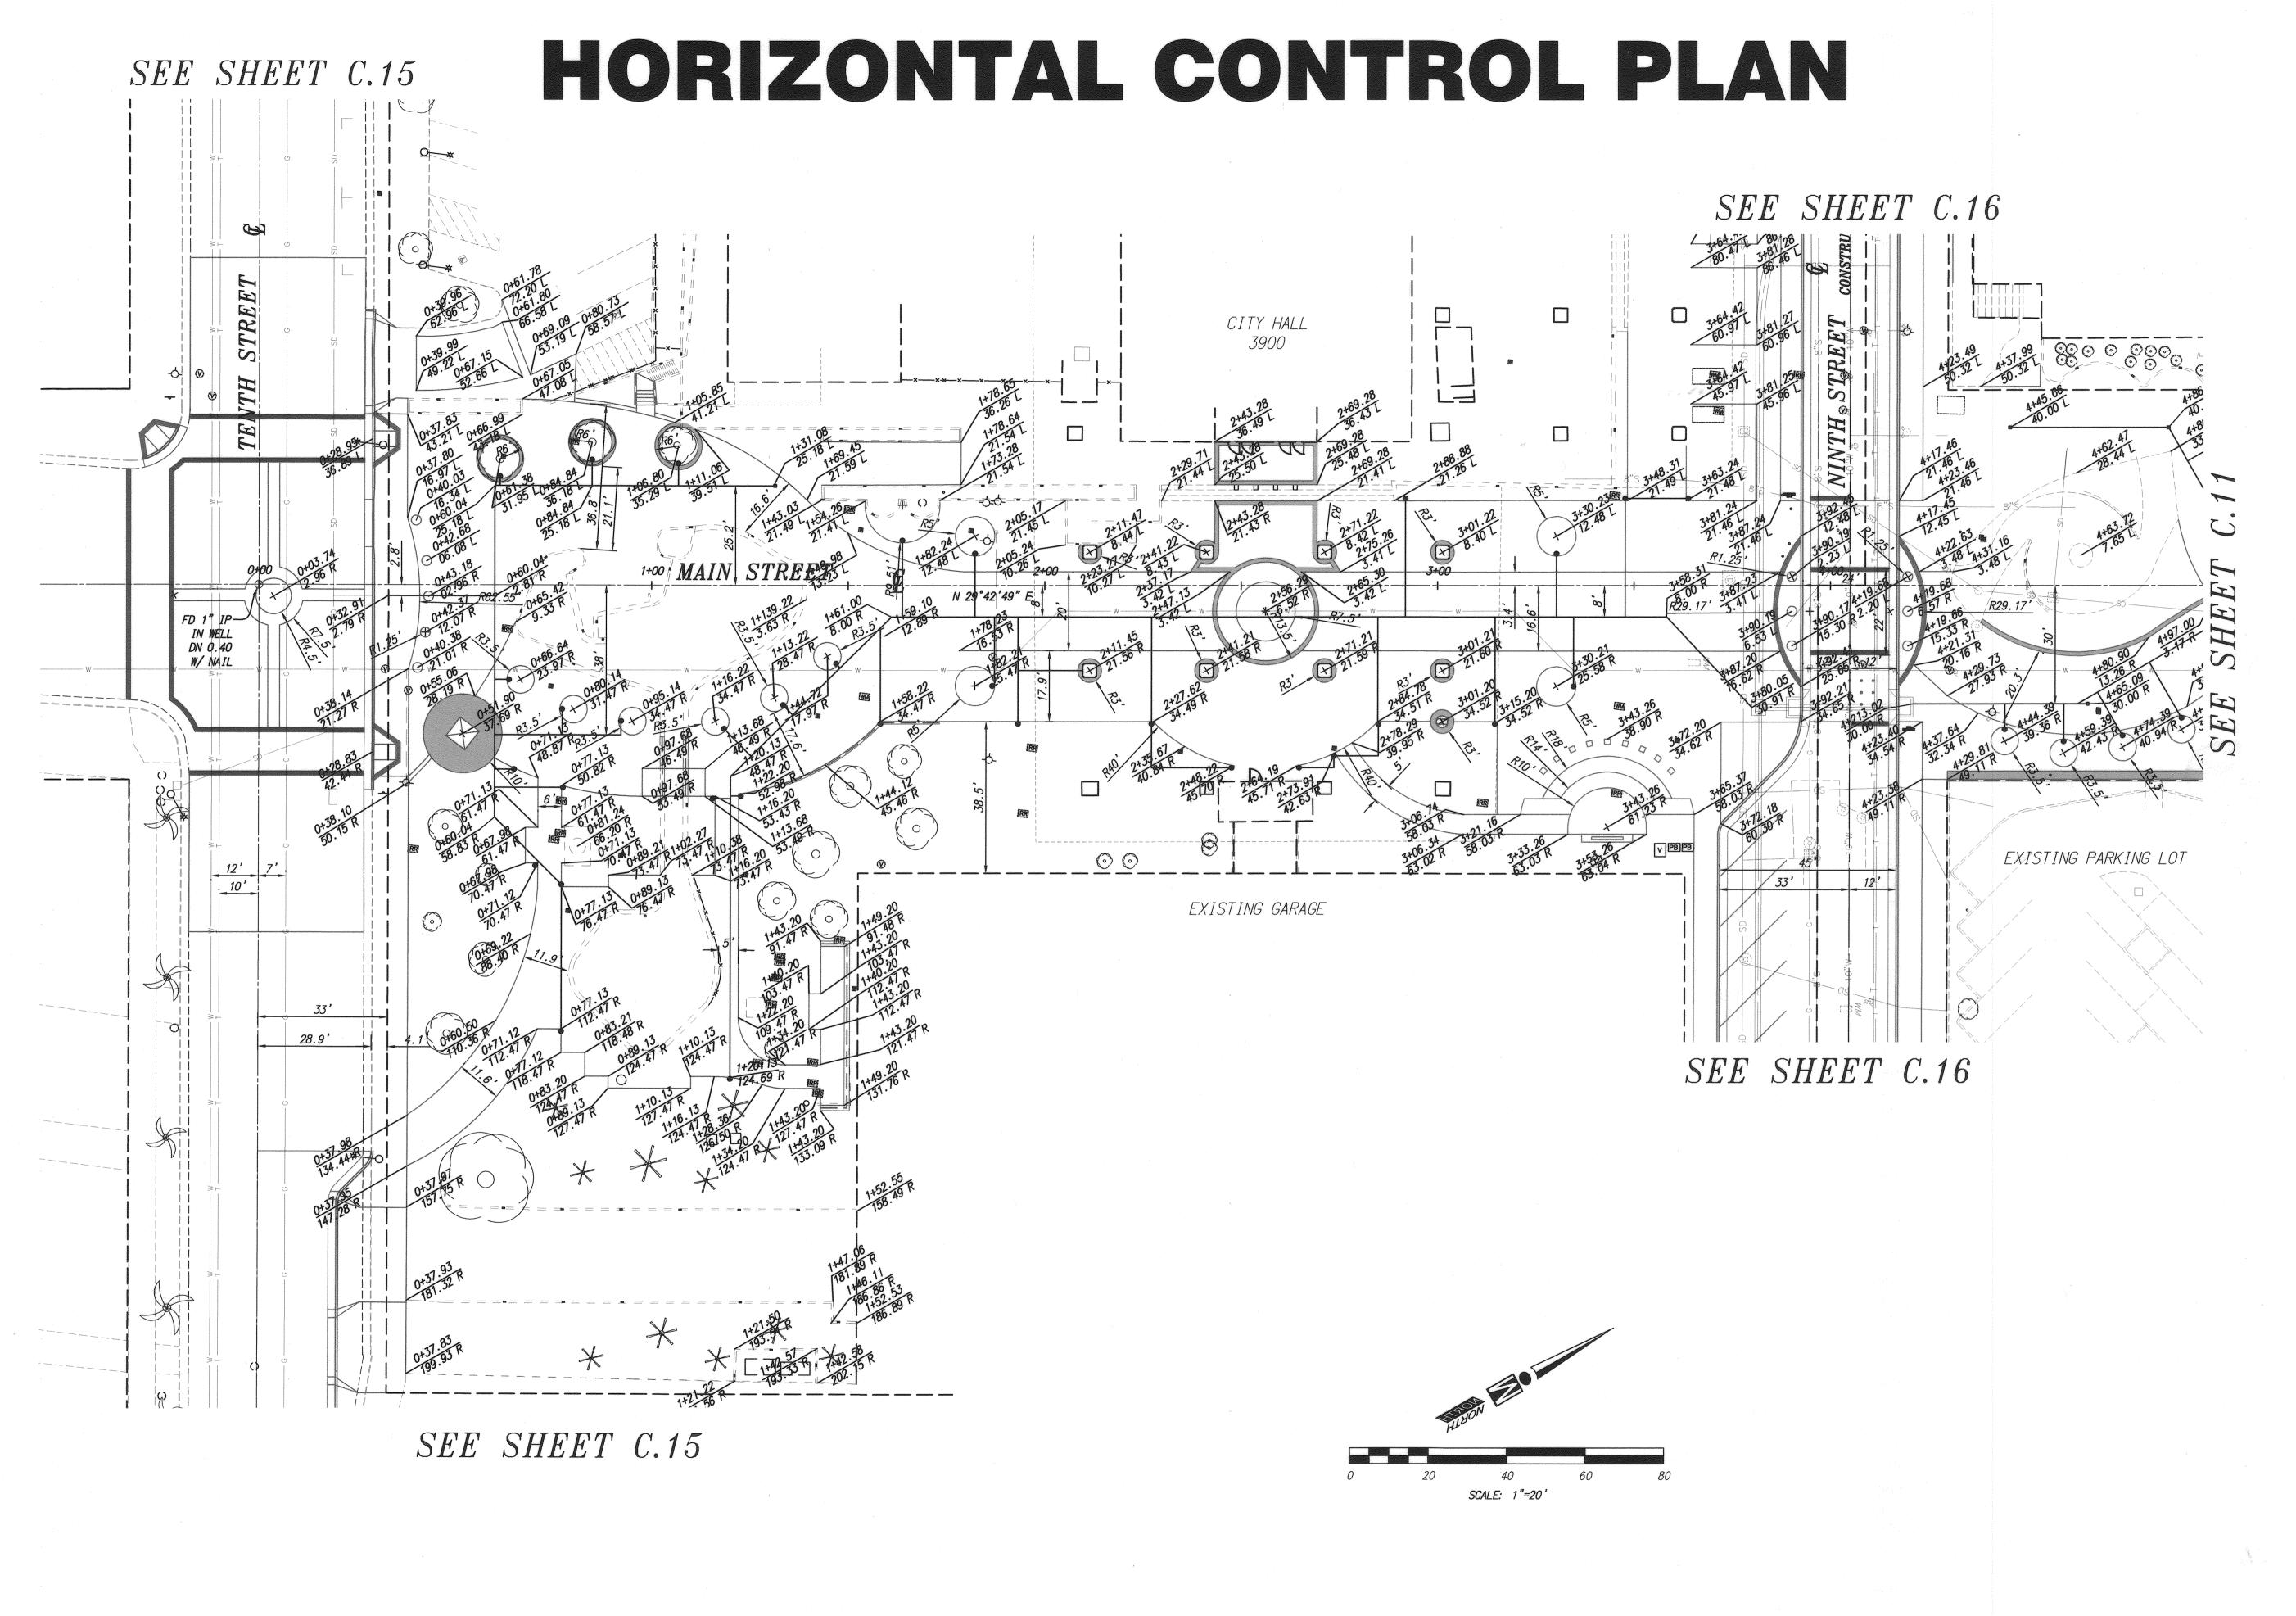

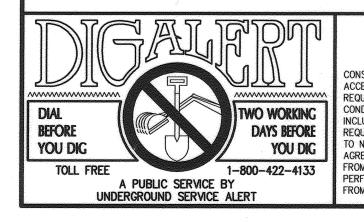

PRIVATE ENGINEERING NOTE

CITY BUSINESS CERTIFICATE NO. 106198, EXP. 1/1/2008 IW Consulting Engineers, Inc. CONSTRUCTION CONTRACTOR AGREES THAT IN ACCORDANCE WITH GENERALLY ACCEPTED CONSTRUCTION PRACTICES, CONSTRUCTION CONTRACTOR WILL BE REQUIRED TO ASSUME SOLE AND COMPLETE RESPONSIBILITY FOR JOB SITE CONDITIONS DURING THE COURSE OF CONSTRUCTION OF THE PROJECT, INCLUDING THE SAFETY OF ALL PERSONS AND PROPERTY THAT THIS REQUIREMENT SHALL BE MADE TO APPLY CONTINUOUSLY AND NOT BE LIMITED TO NORMAL WORKING HOURS, AND CONSTRUCTION CONTRACTOR FURTHER AGREES TO DEFEND, INDEMNIFY AND HOLD DESIGN PROFESSIONAL HARMLESS FROM ANY AND ALL LIABILITY, REAL OR ALLEGED, IN CONNECTION WITH THE PERFORMANCE OF WORK ON THIS PROJECT, EXCEPTING LIABILITY ARISING FROM THE SOLE NEGLIGENCE OF DESIGN PROFESSIONAL.

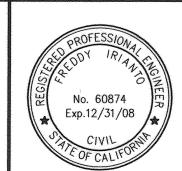


	PLANS PREPARED	UNDER SUPERVISION OF
SSIONAL		TELOU
50874 R	Date	R.C.E. 60874 (EXP. 12-31-08)
50874 /31/08 ★	BENCHMARK: 16-13	
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PW 07-0379 PW 07-0217 ACCOUNT NO. CITY OF RIVERSIDE M-457

MAIN STREET
REVITALIZATION
HORIZONTAL CONTROL PLAN
10TH STREET TO 9TH STREET C.10A SHEET 11 OF 100 VERT. SCALE: N/A JN: 223.002



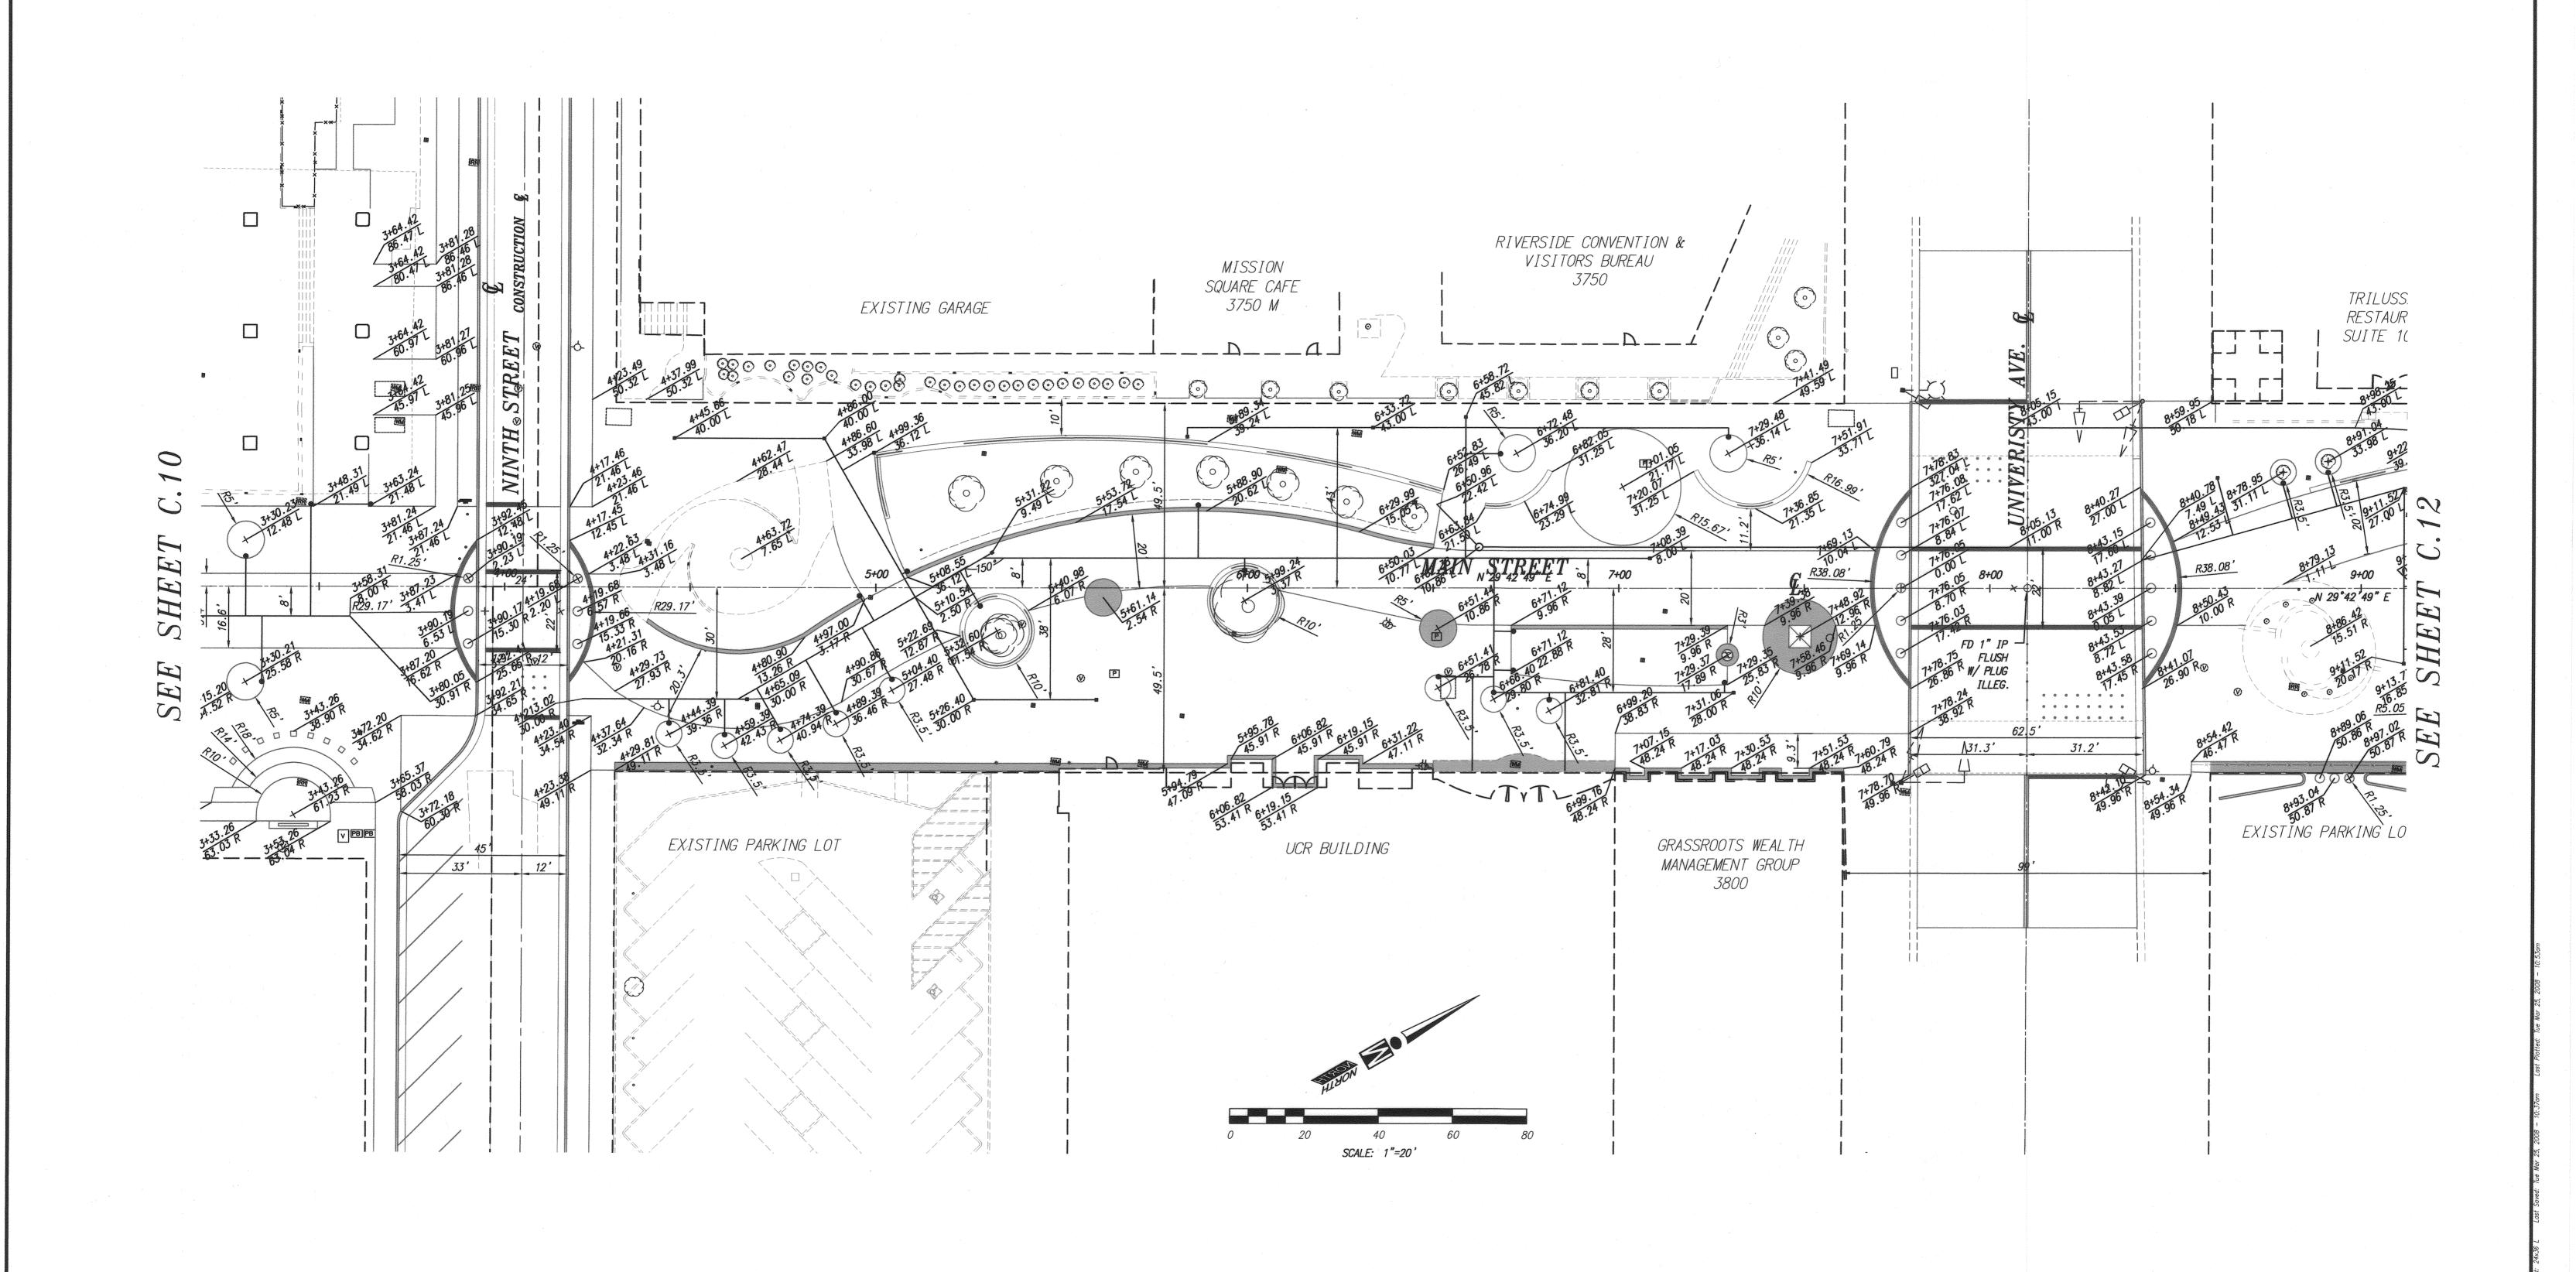

PRIVATE ENGINEERING NOTE

CONSTRUCTION CONTRACTOR AGREES THAT IN ACCORDANCE WITH GENERALLY ACCEPTED CONSTRUCTION PRACTICES, CONSTRUCTION CONTRACTOR WILL BE REQUIRED TO ASSUME SOLE AND COMPLETE RESPONSIBILITY FOR JOB SITE CONDITIONS DURING THE COURSE OF CONSTRUCTION OF THE PROJECT, INCLUDING THE SAFETY OF ALL PERSONS AND PROPERTY THAT THIS REQUIREMENT SHALL BE MADE TO APPLY CONTINUOUSLY AND NOT BE LIMITED TO NORMAL WORKING HOURS, AND CONSTRUCTION CONTRACTOR FURTHER AGREES TO DEFEND, INDEMNIFY AND HOLD DESIGN PROFESSIONAL HARMLESS FROM ANY AND ALL LIABILITY, REAL OR ALLEGED, IN CONNECTION WITH THE PERFORMANCE OF WORK ON THIS PROJECT, EXCEPTING LIABILITY ARISING FROM THE SOLE NEGLIGENCE OF DESIGN PROFESSIONAL.


CITY BUSINESS CERTIFICATE NO. 106198, EXP. 1/1/2008 IW Consulting Engineers, Inc. · Civil Engineering Surveying Land Planning 3544 University Avenue Tel: 951.687.2929 Riverside, CA 92501 Fax: 951.687.2999




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PW 07-0379 PW 07-0217 ACCOUNT NO. **CITY OF RIVERSIDE** MAIN STREET
REVITALIZATION
HORIZONTAL CONTROL PLAN
9TH STREET TO UNIVERSITY AVENUE M-457 C.11A SHEET 12 OF 100 HORIZ. SCALE: 1"=20" VERT. SCALE: N/A JN: 223.002



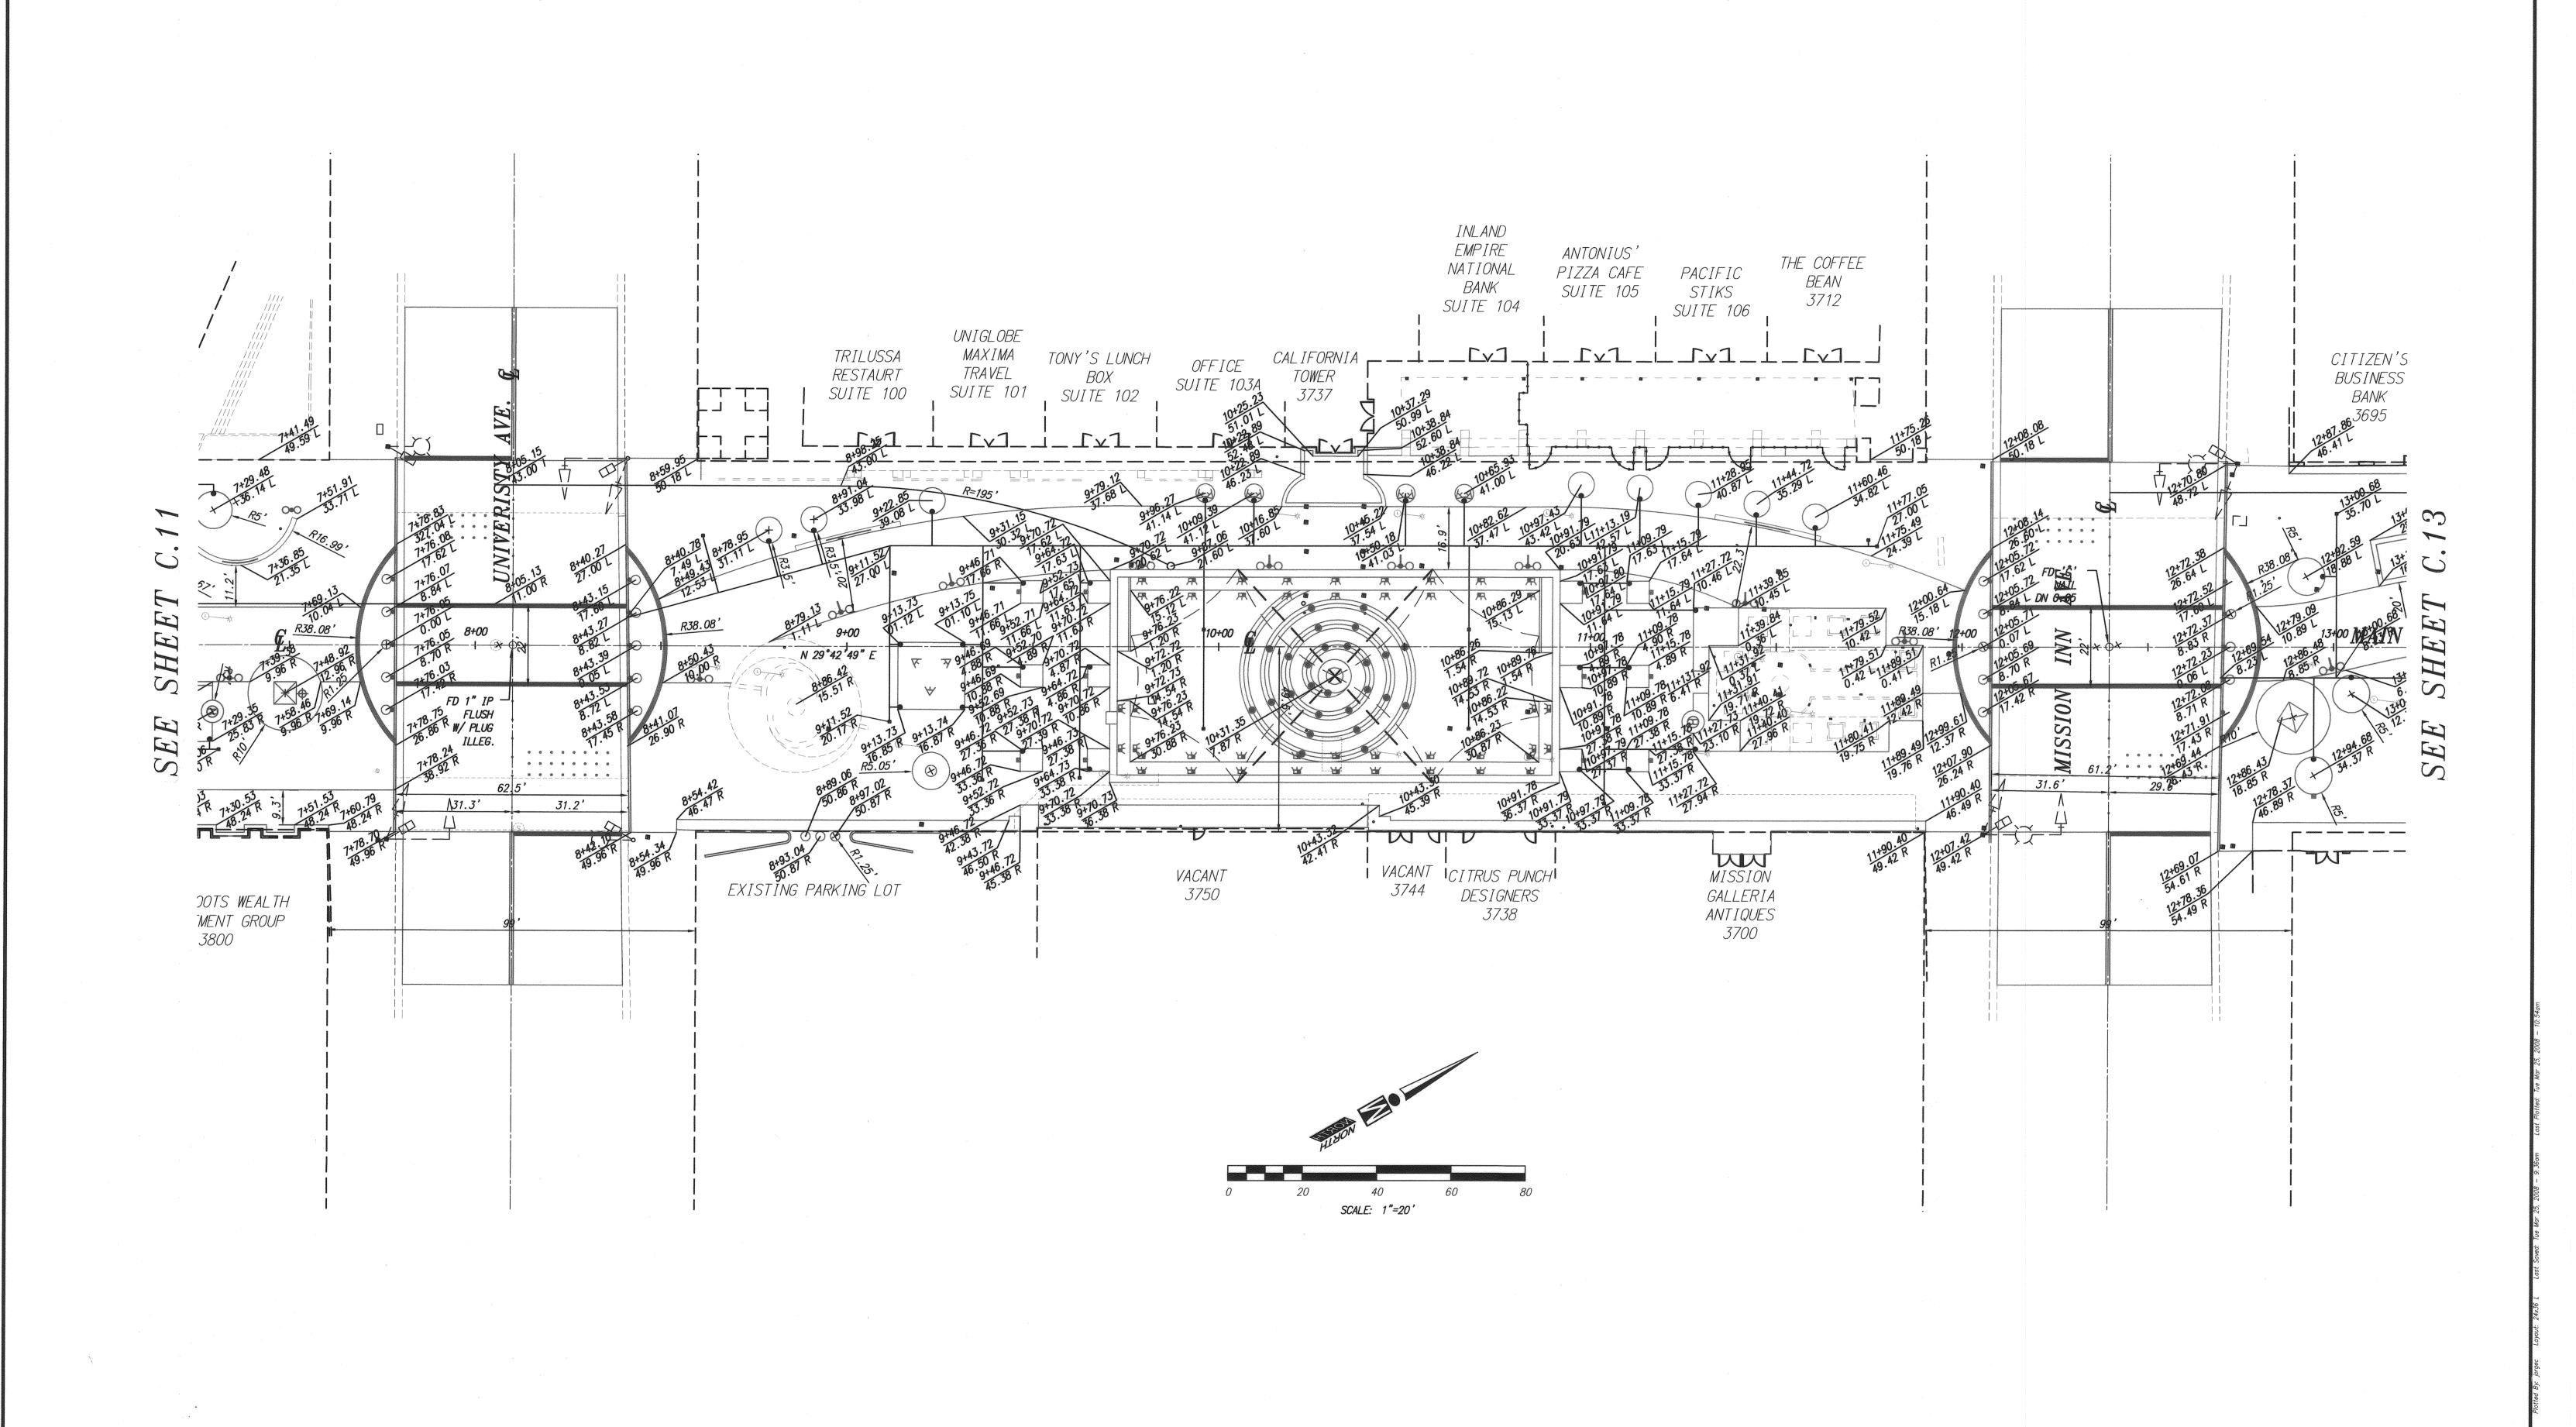

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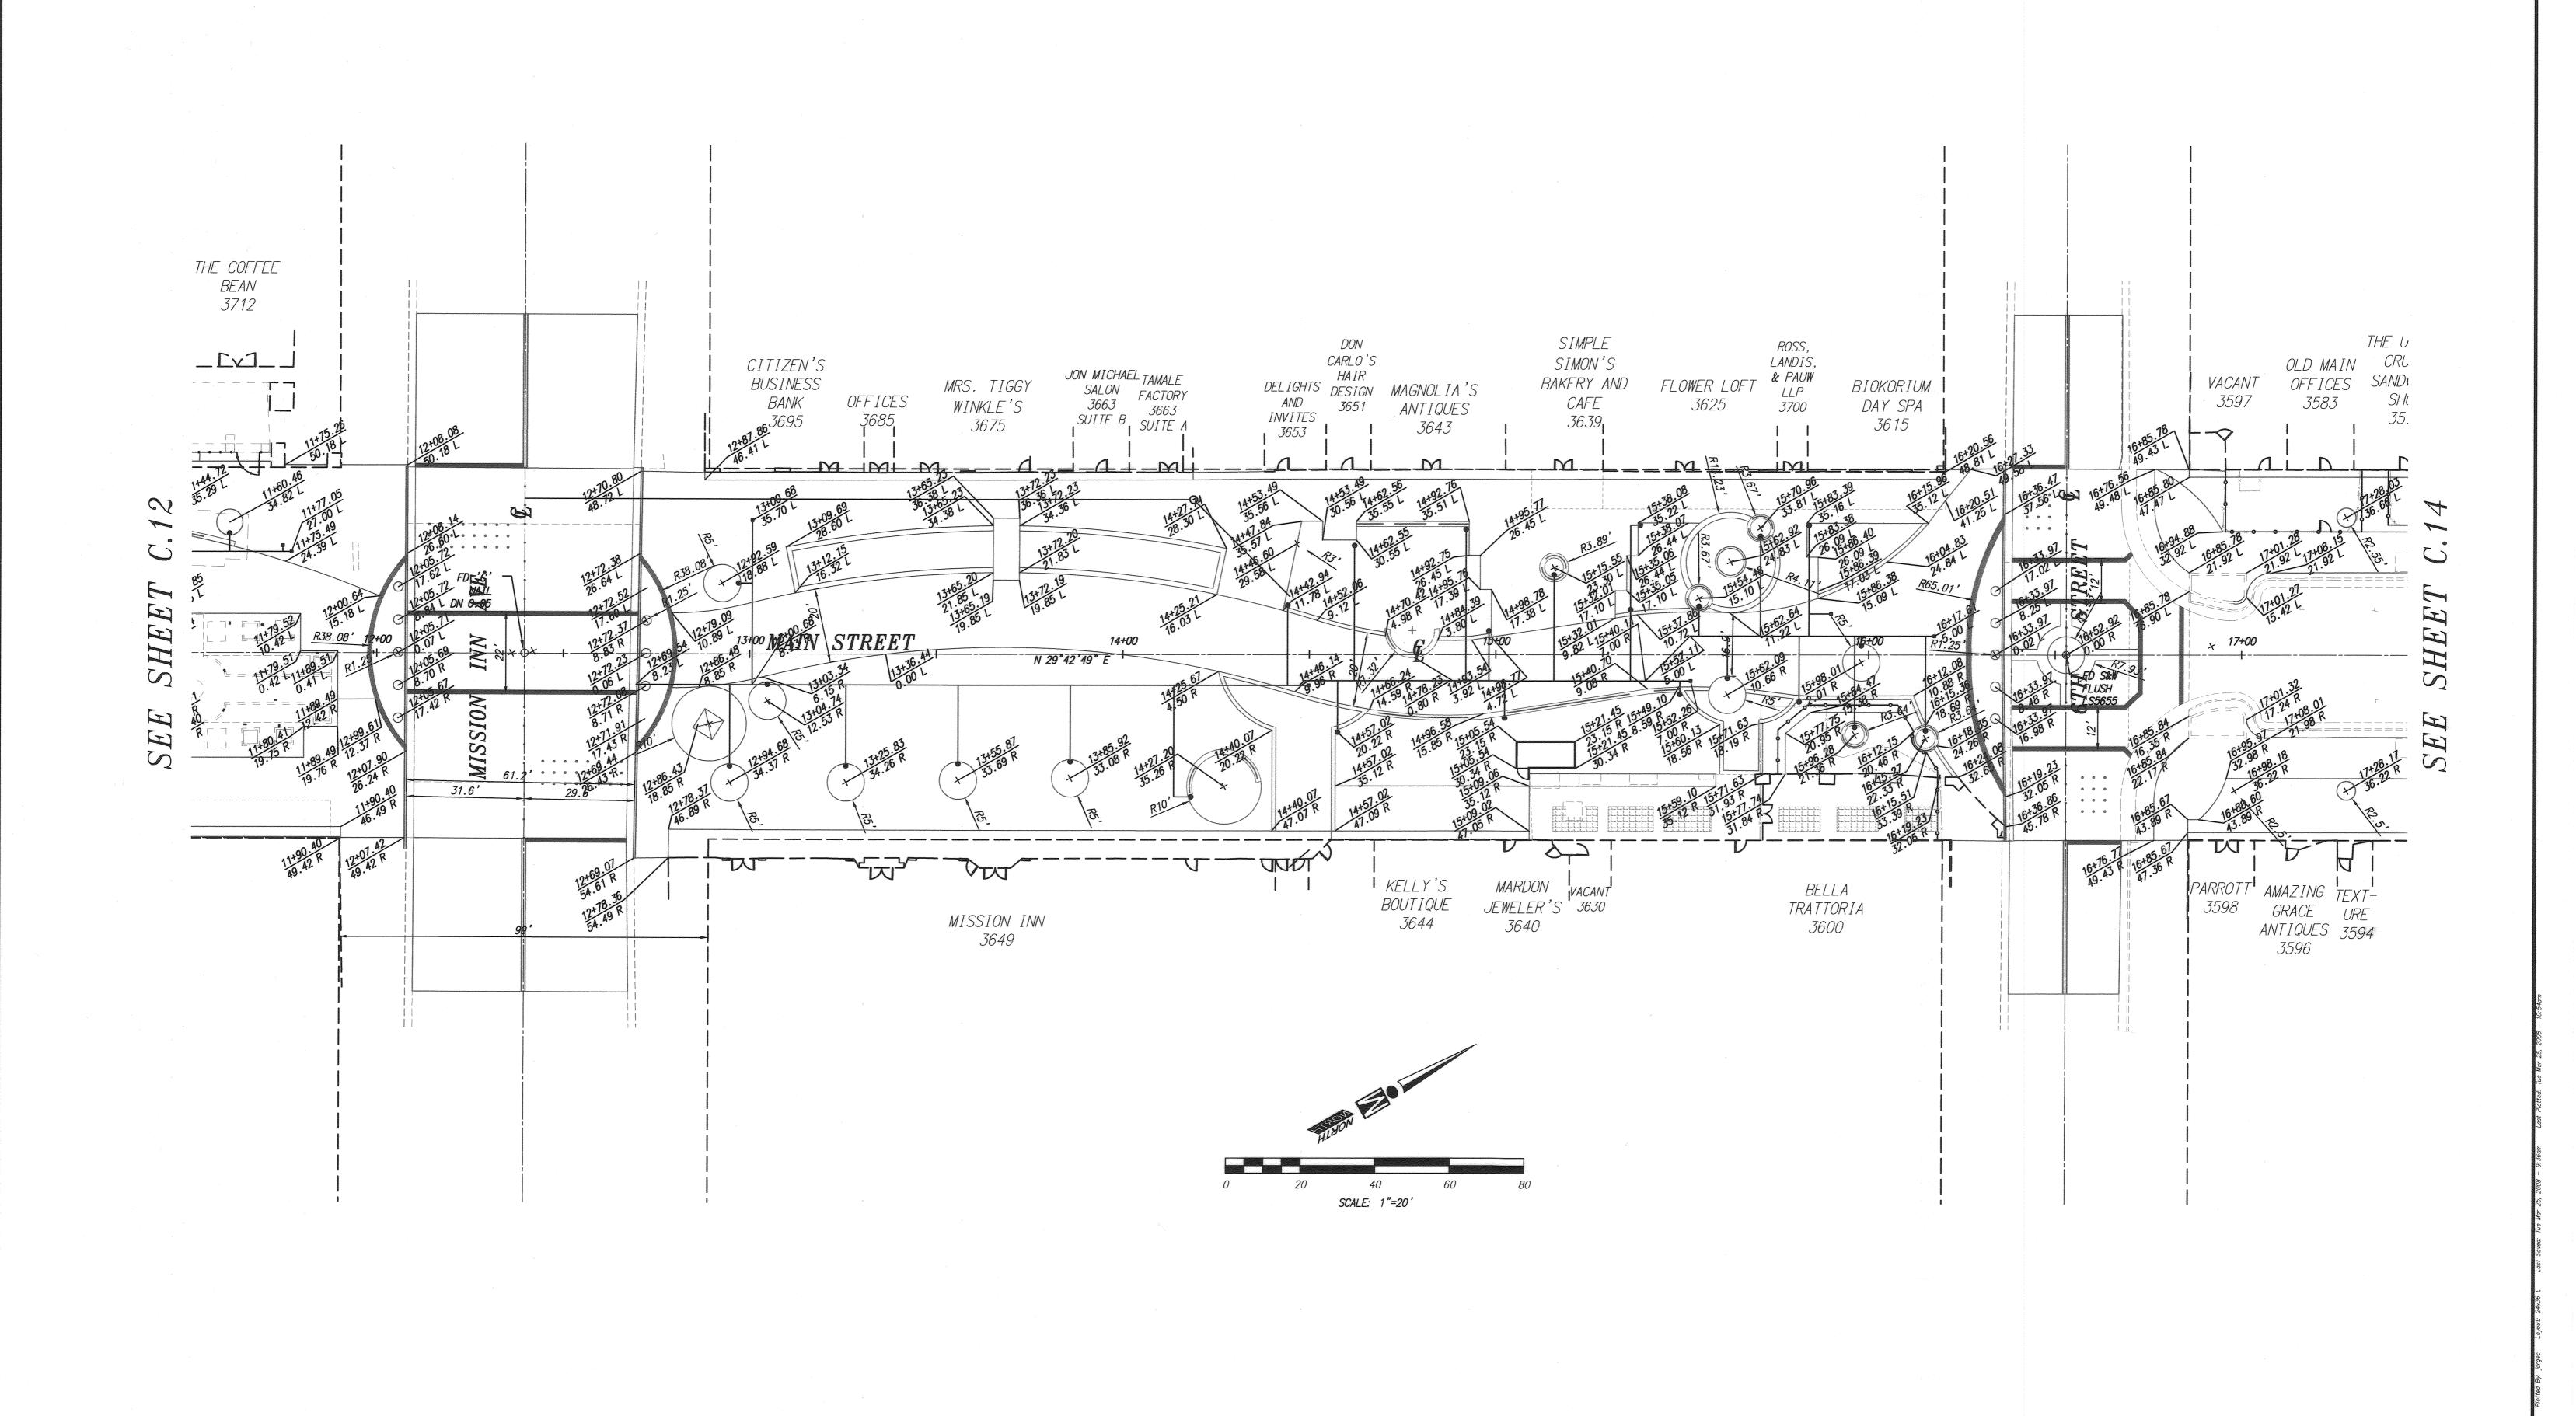
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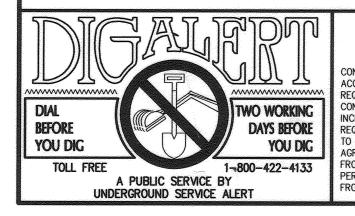
CITY OF RIVERSIDE MAIN STREET
REVITALIZATION
HORIZONTAL CONTROL PLAN
UNIVERSITY AVENUE TO MISSION INN AVENUE

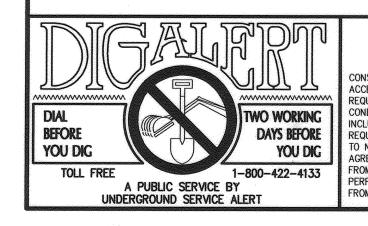M-457 SHEET 13 OF 100 HORIZ. SCALE: 1"=20' VERT. SCALE: N/A JN: 223.002

PW 07-0379 PW 07-0217

ACCOUNT NO.





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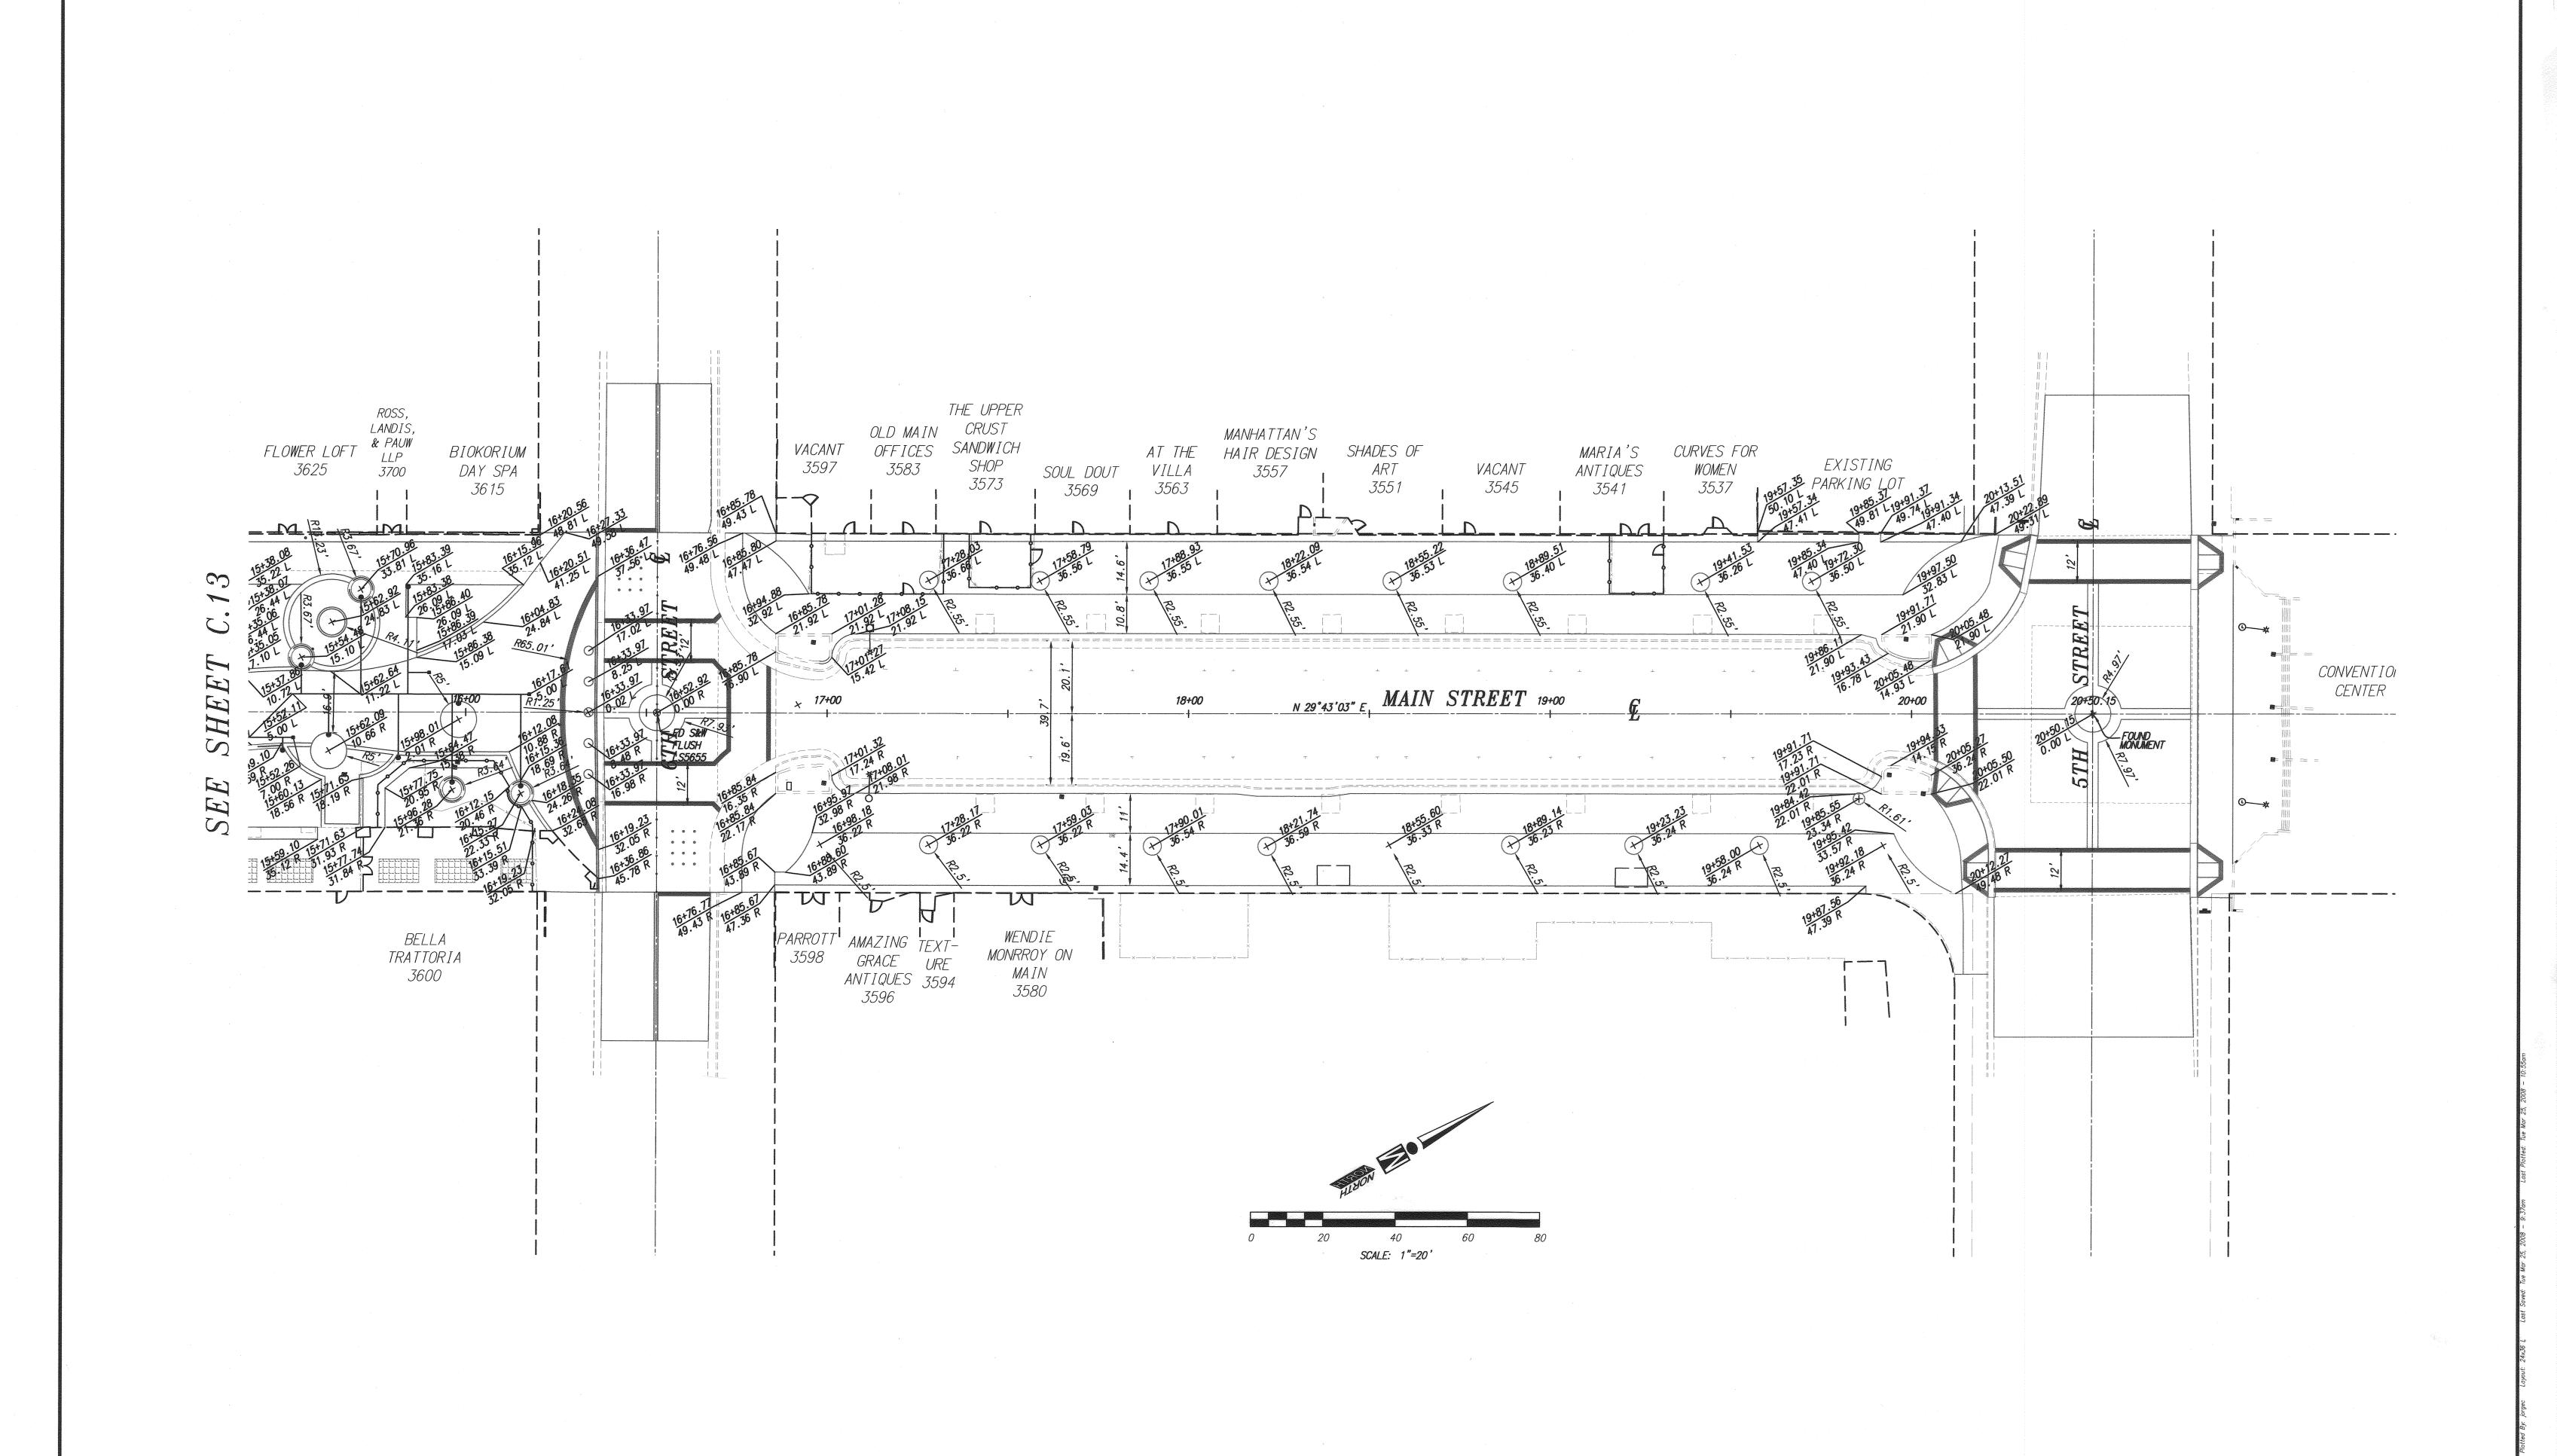
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PW 07-0379 PW 07-0217 ACCOUNT NO. CITY OF RIVERSIDE MAIN STREET REVITALIZATION M-457

HORIZONTAL CONTROL PLAN MISSION INN AVENUE TO 6TH STREET SHEET 14 OF 100 HORIZ. SCALE: 1"=20' VERT. SCALE: N/A JN: 223.002





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Surveying

Land Planning

3544 University Avenue
Riverside, CA 92501

Tel: 951.687.2929
Fax: 951.687.2999



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CITY OF RIVERSIDE

MAIN STREET

REVITALIZATION

HORIZONTAL CONTROL PLAN

HORIZ. SCALE: 1"=20'

REVITALIZATION
HORIZONTAL CONTROL PLAN
6TH STREET TO 5TH STREET

SHEET 15 OF 100


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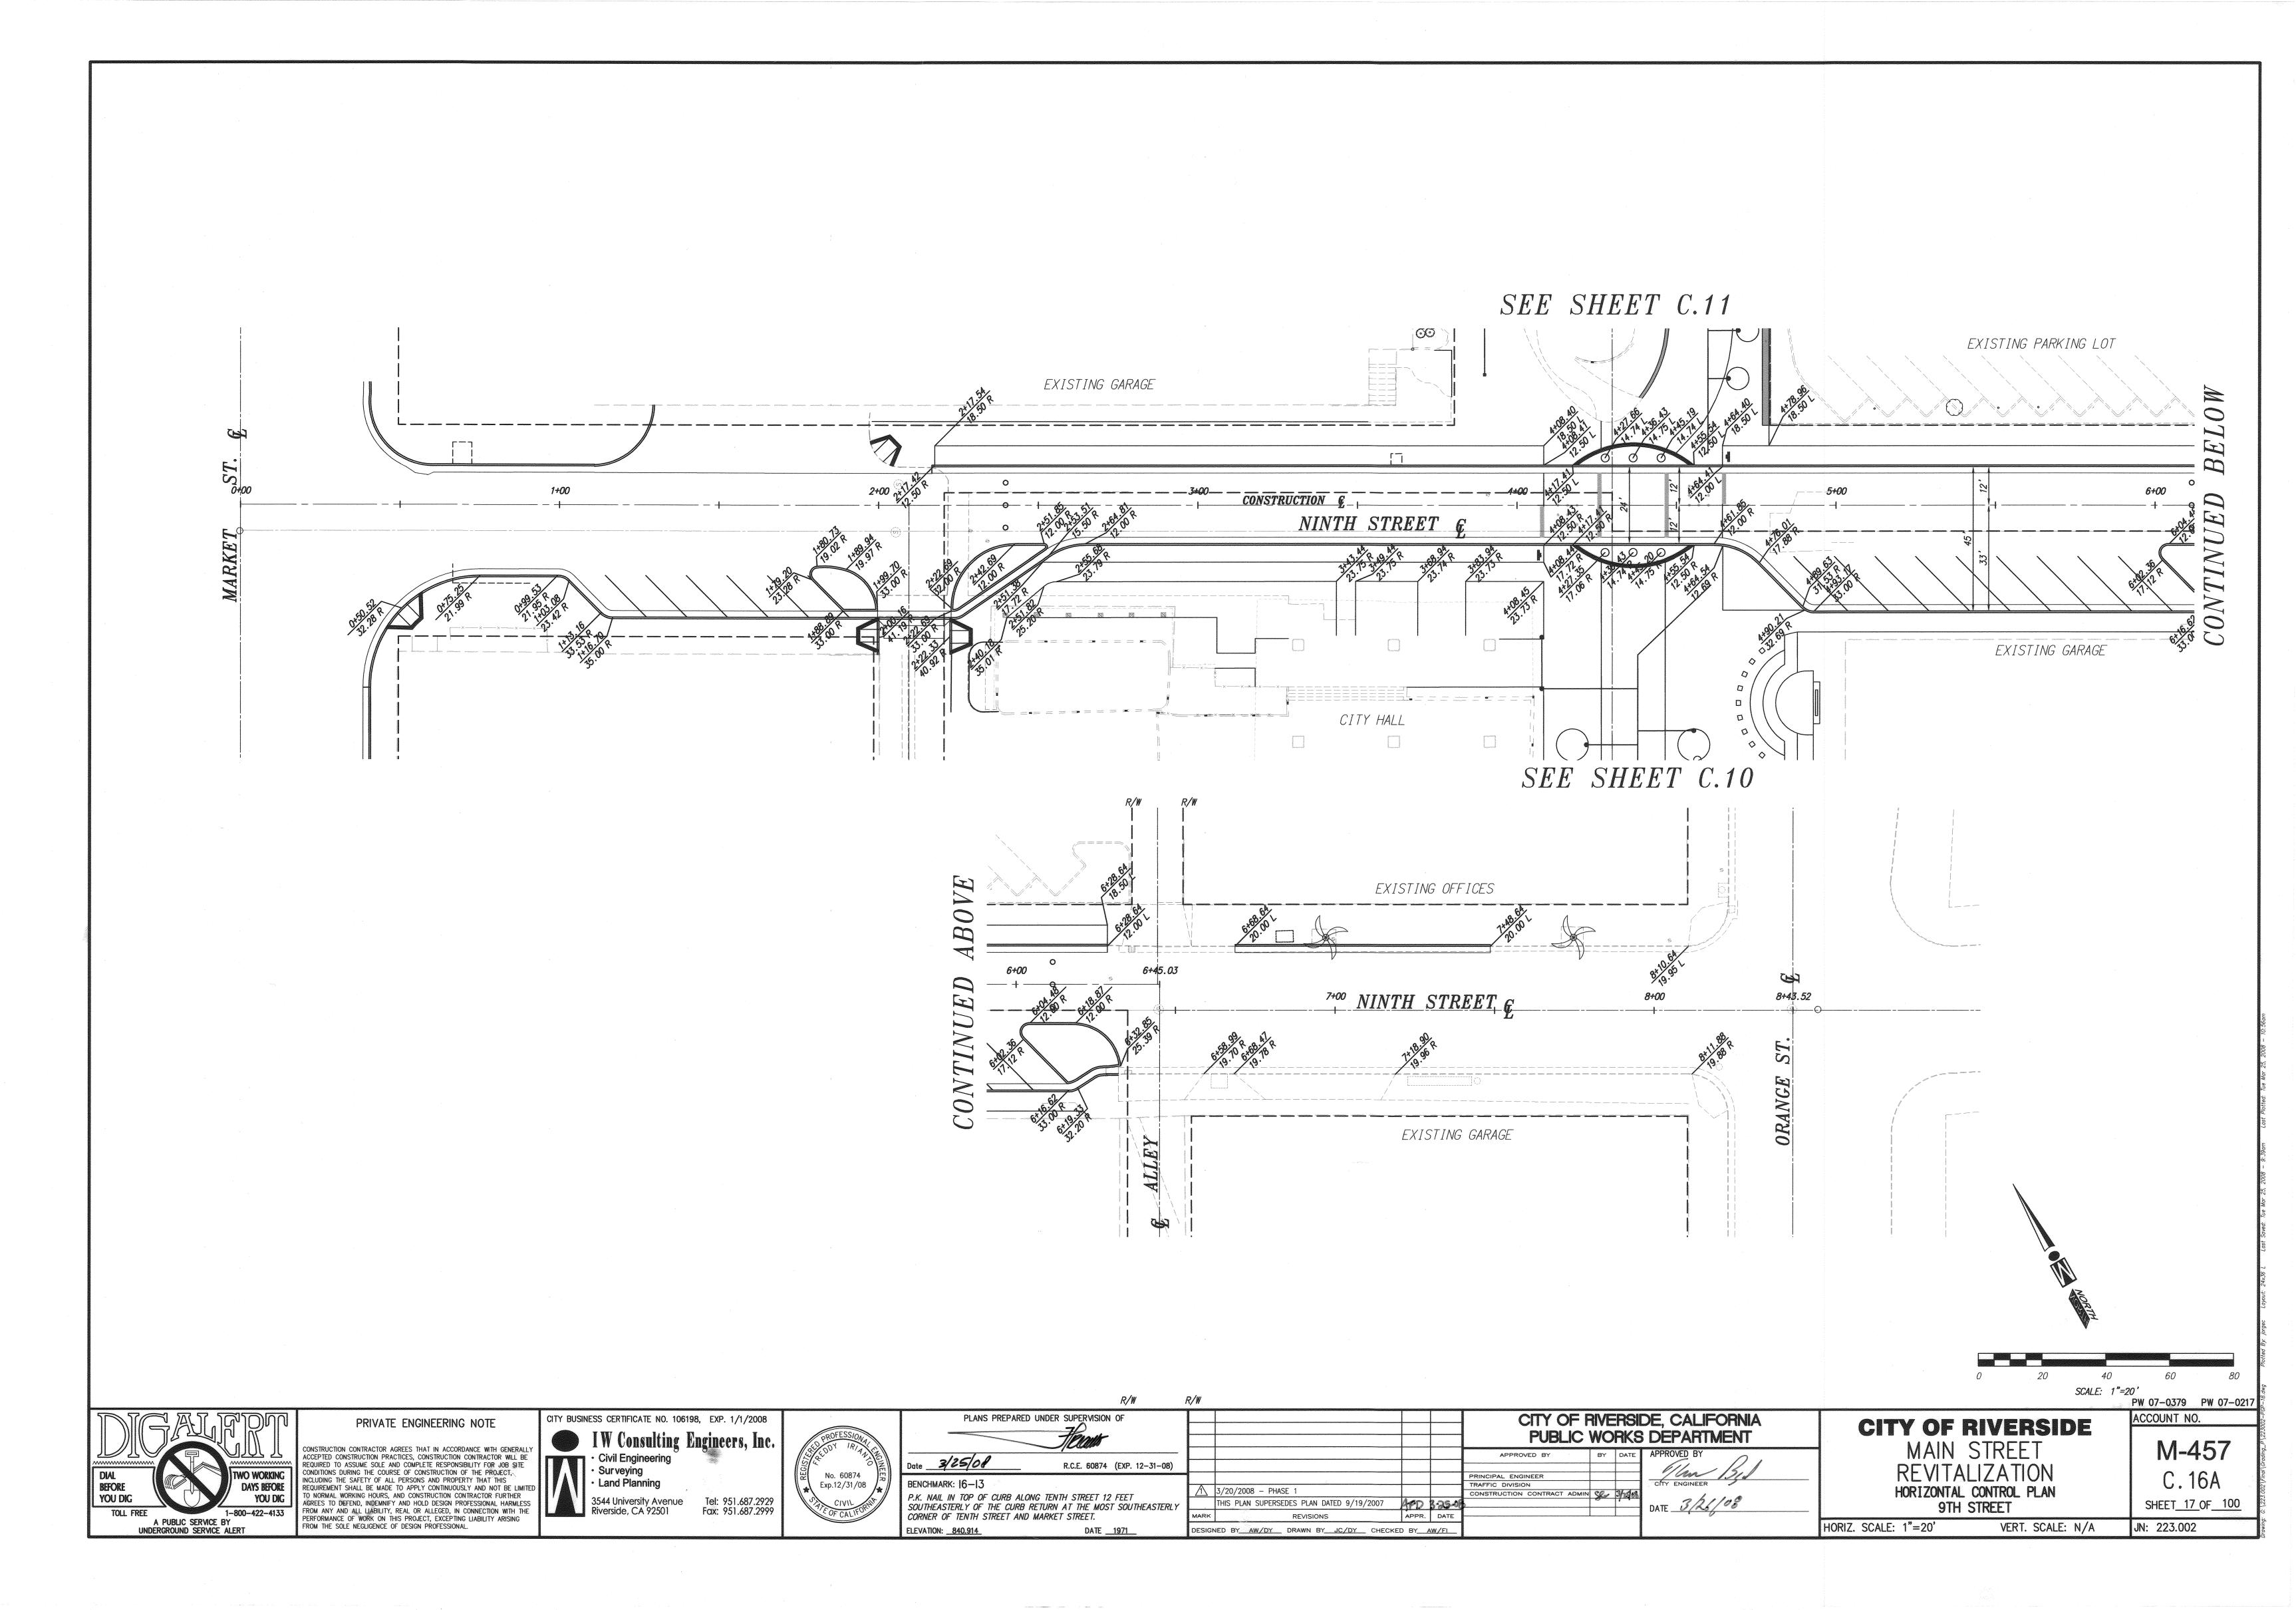
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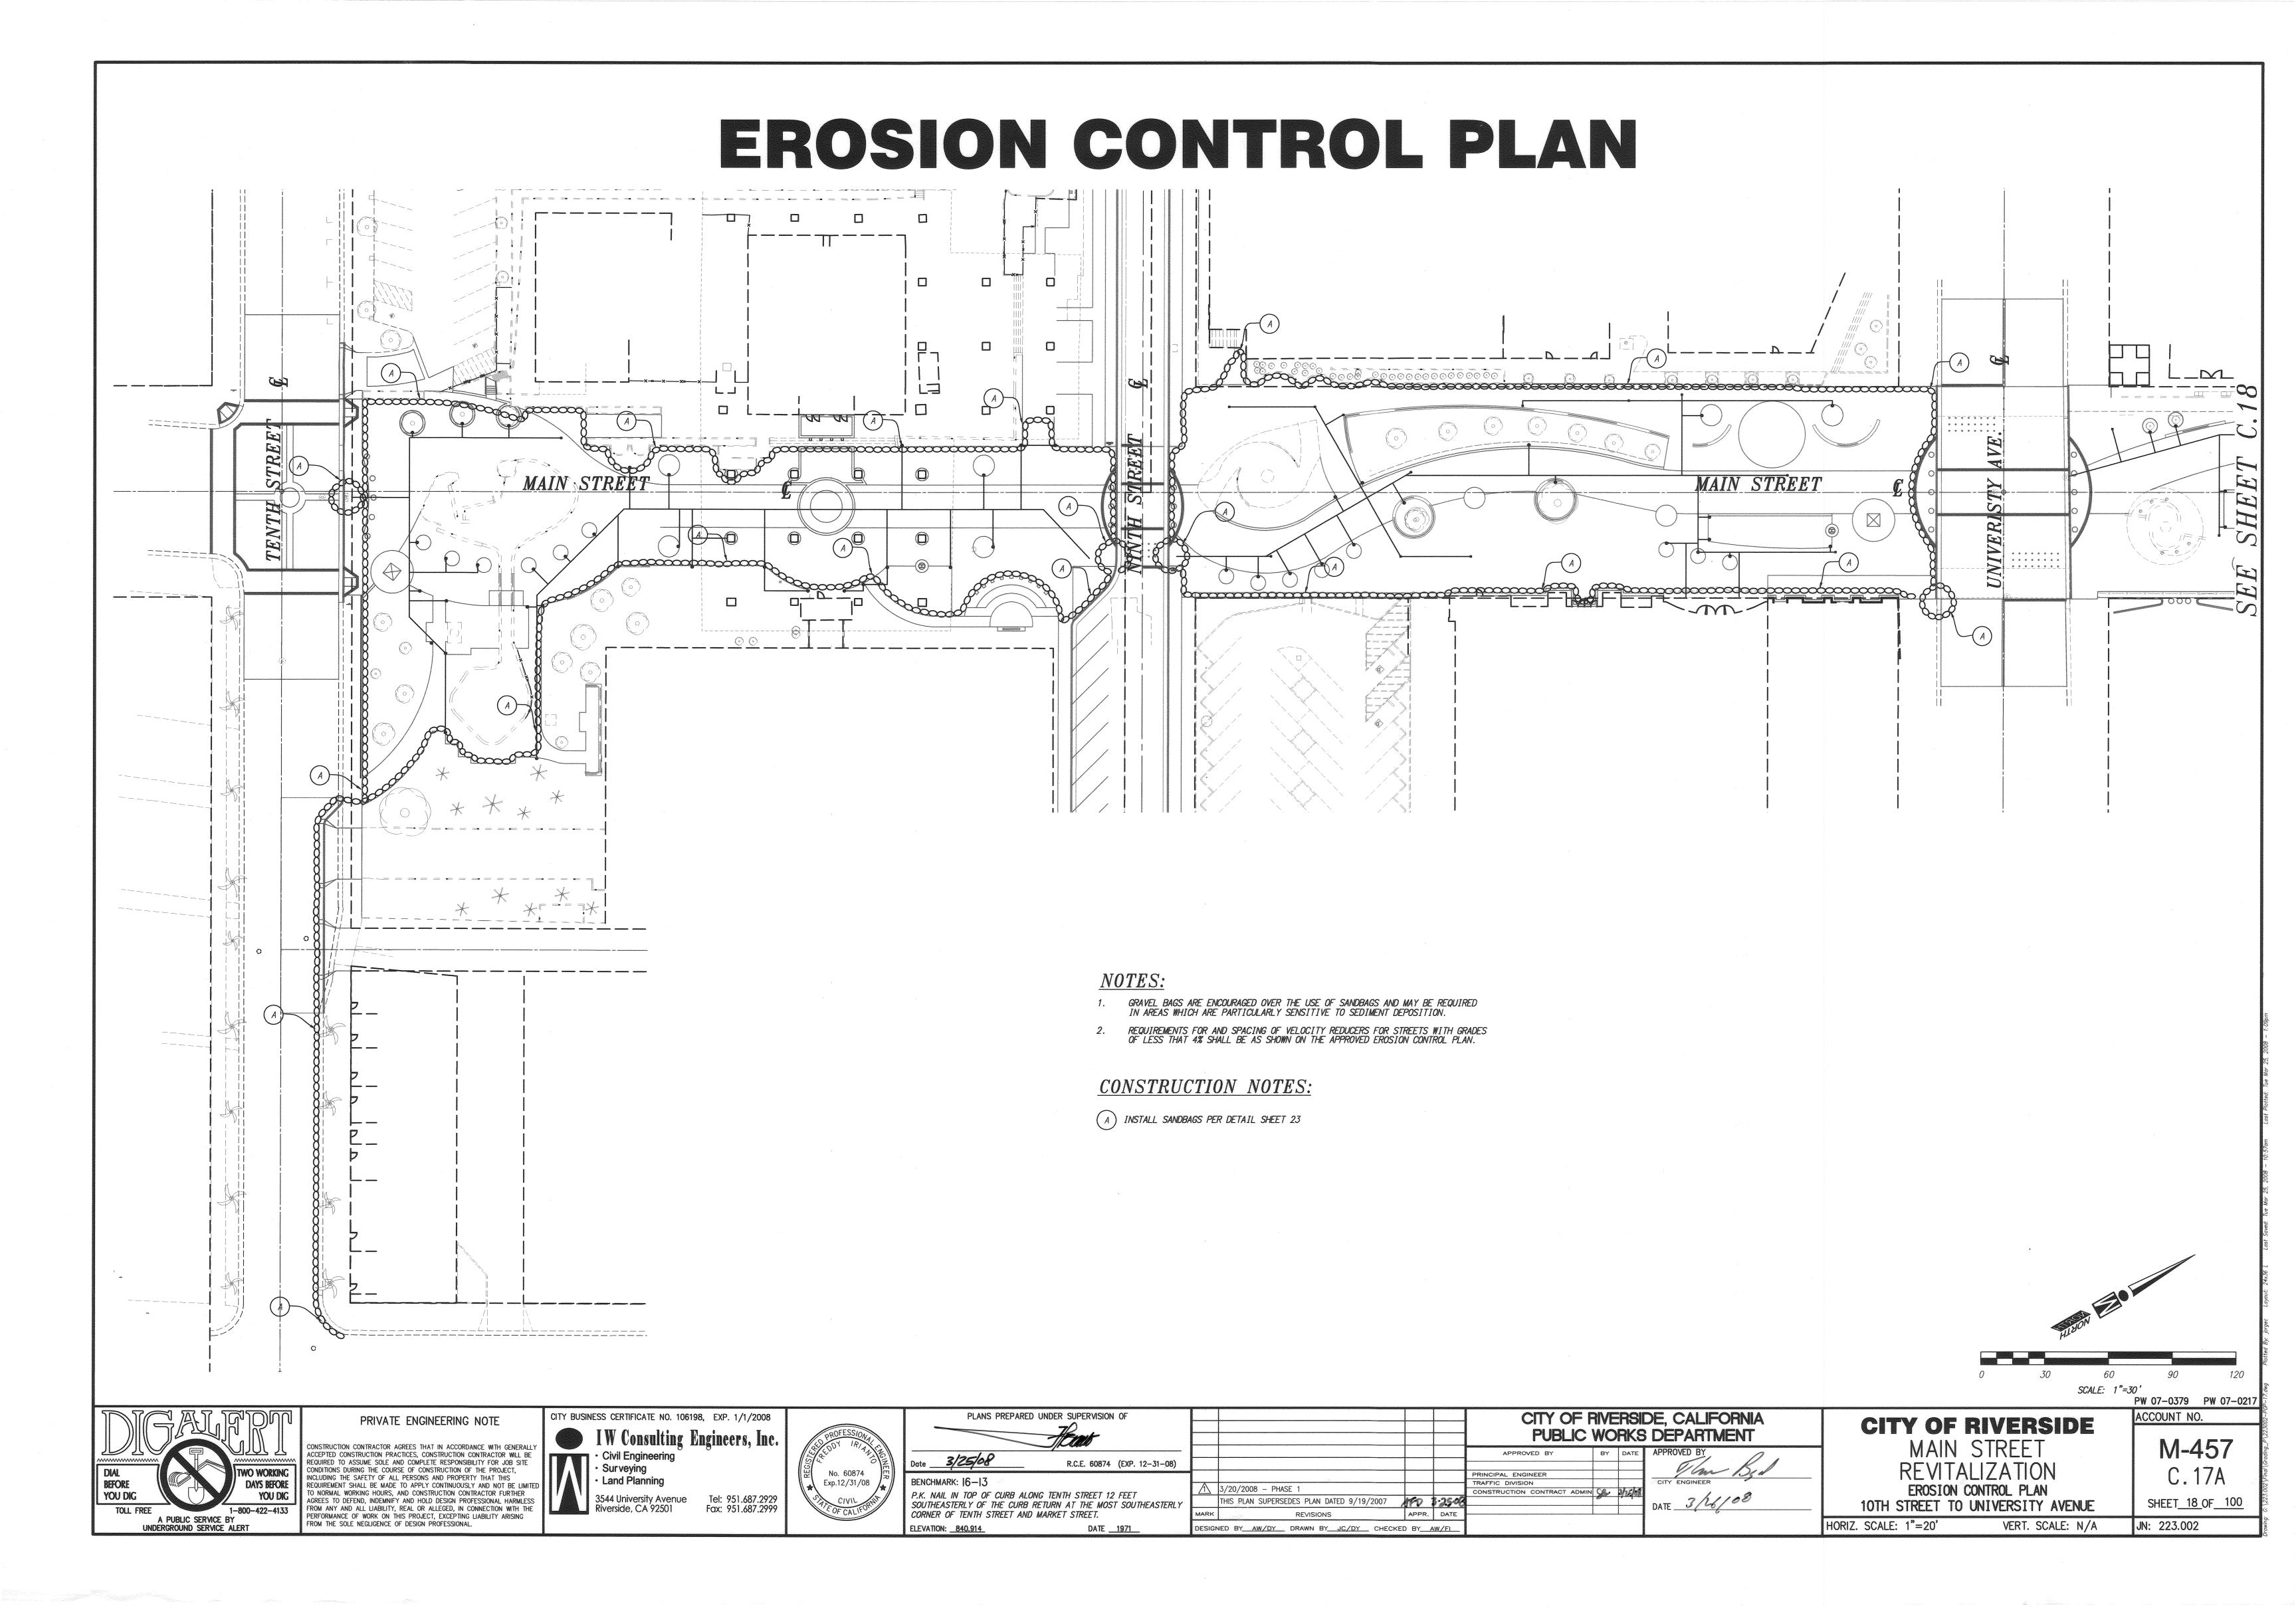
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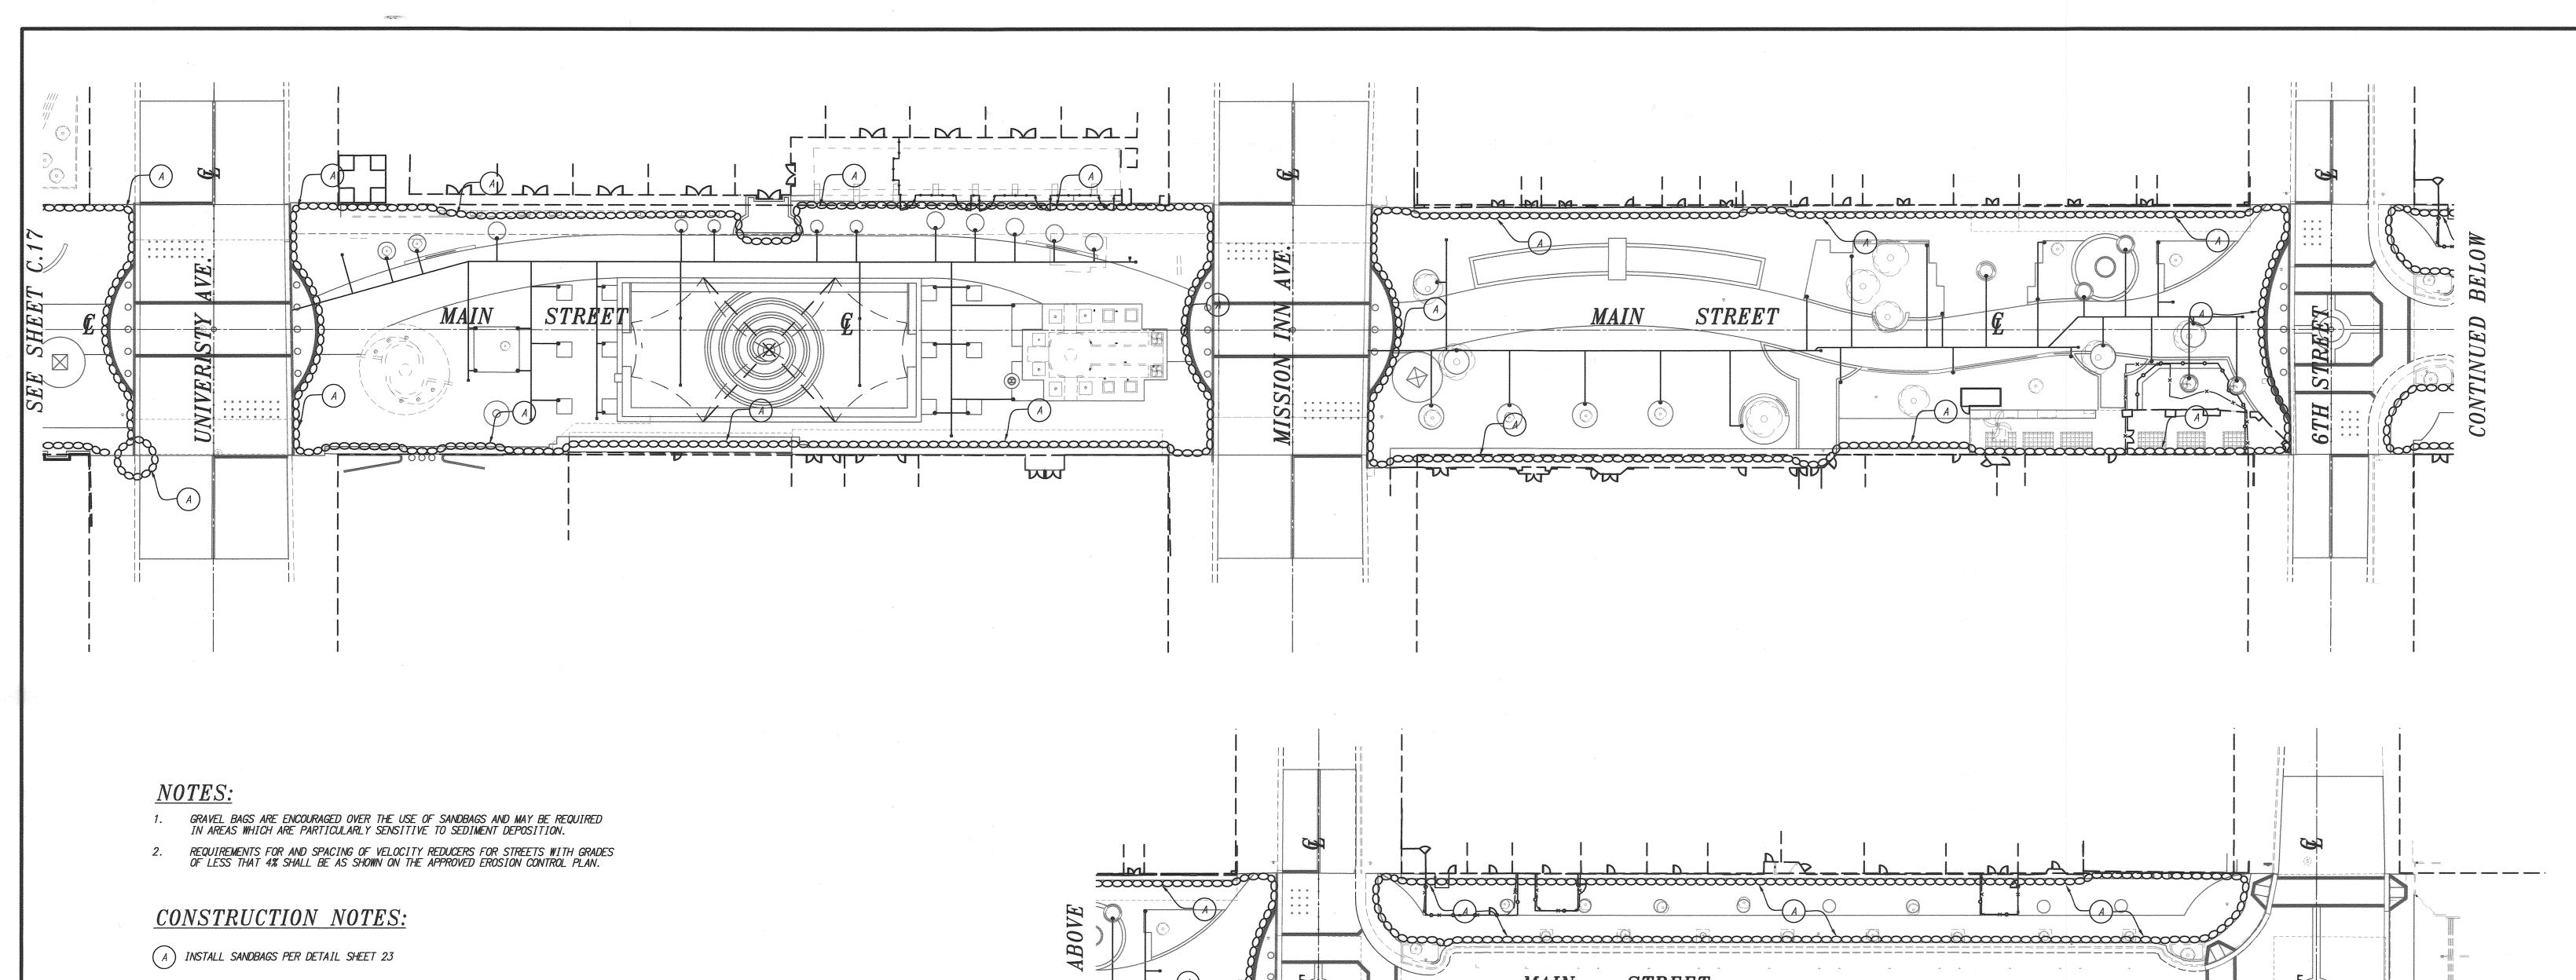
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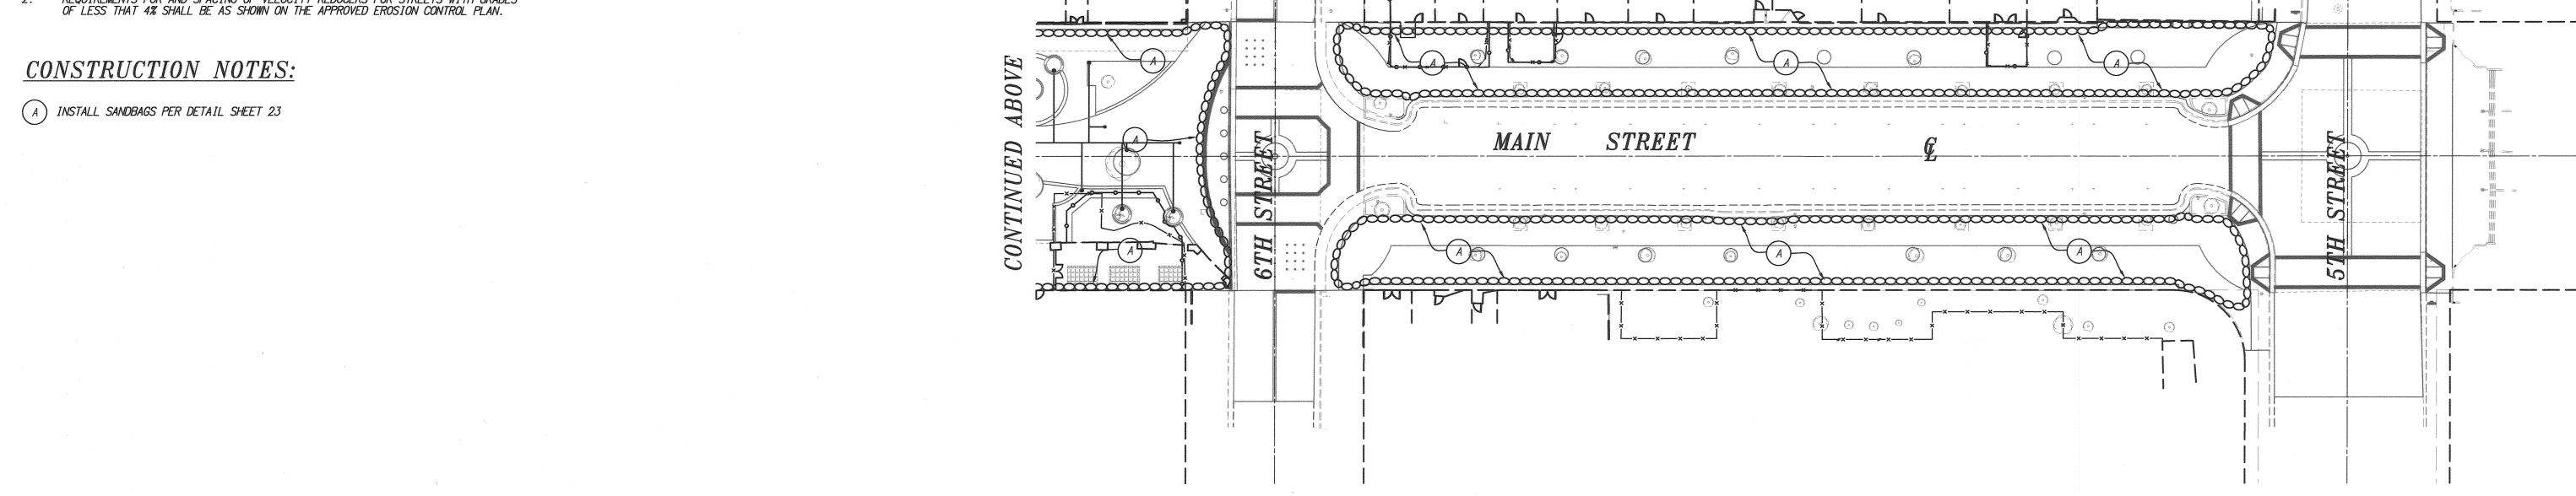
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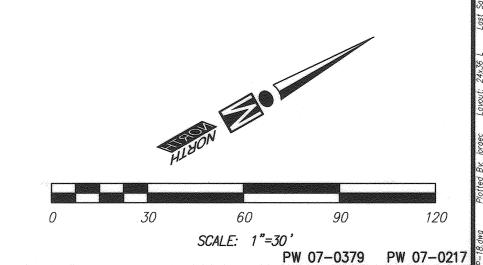




3/20/2008 - PHASE 1

THIS PLAN SUPERSEDES PLAN DATED 9/19/2007

DESIGNED BY AW/DY DRAWN BY JC/DY CHECKED BY AW/FI

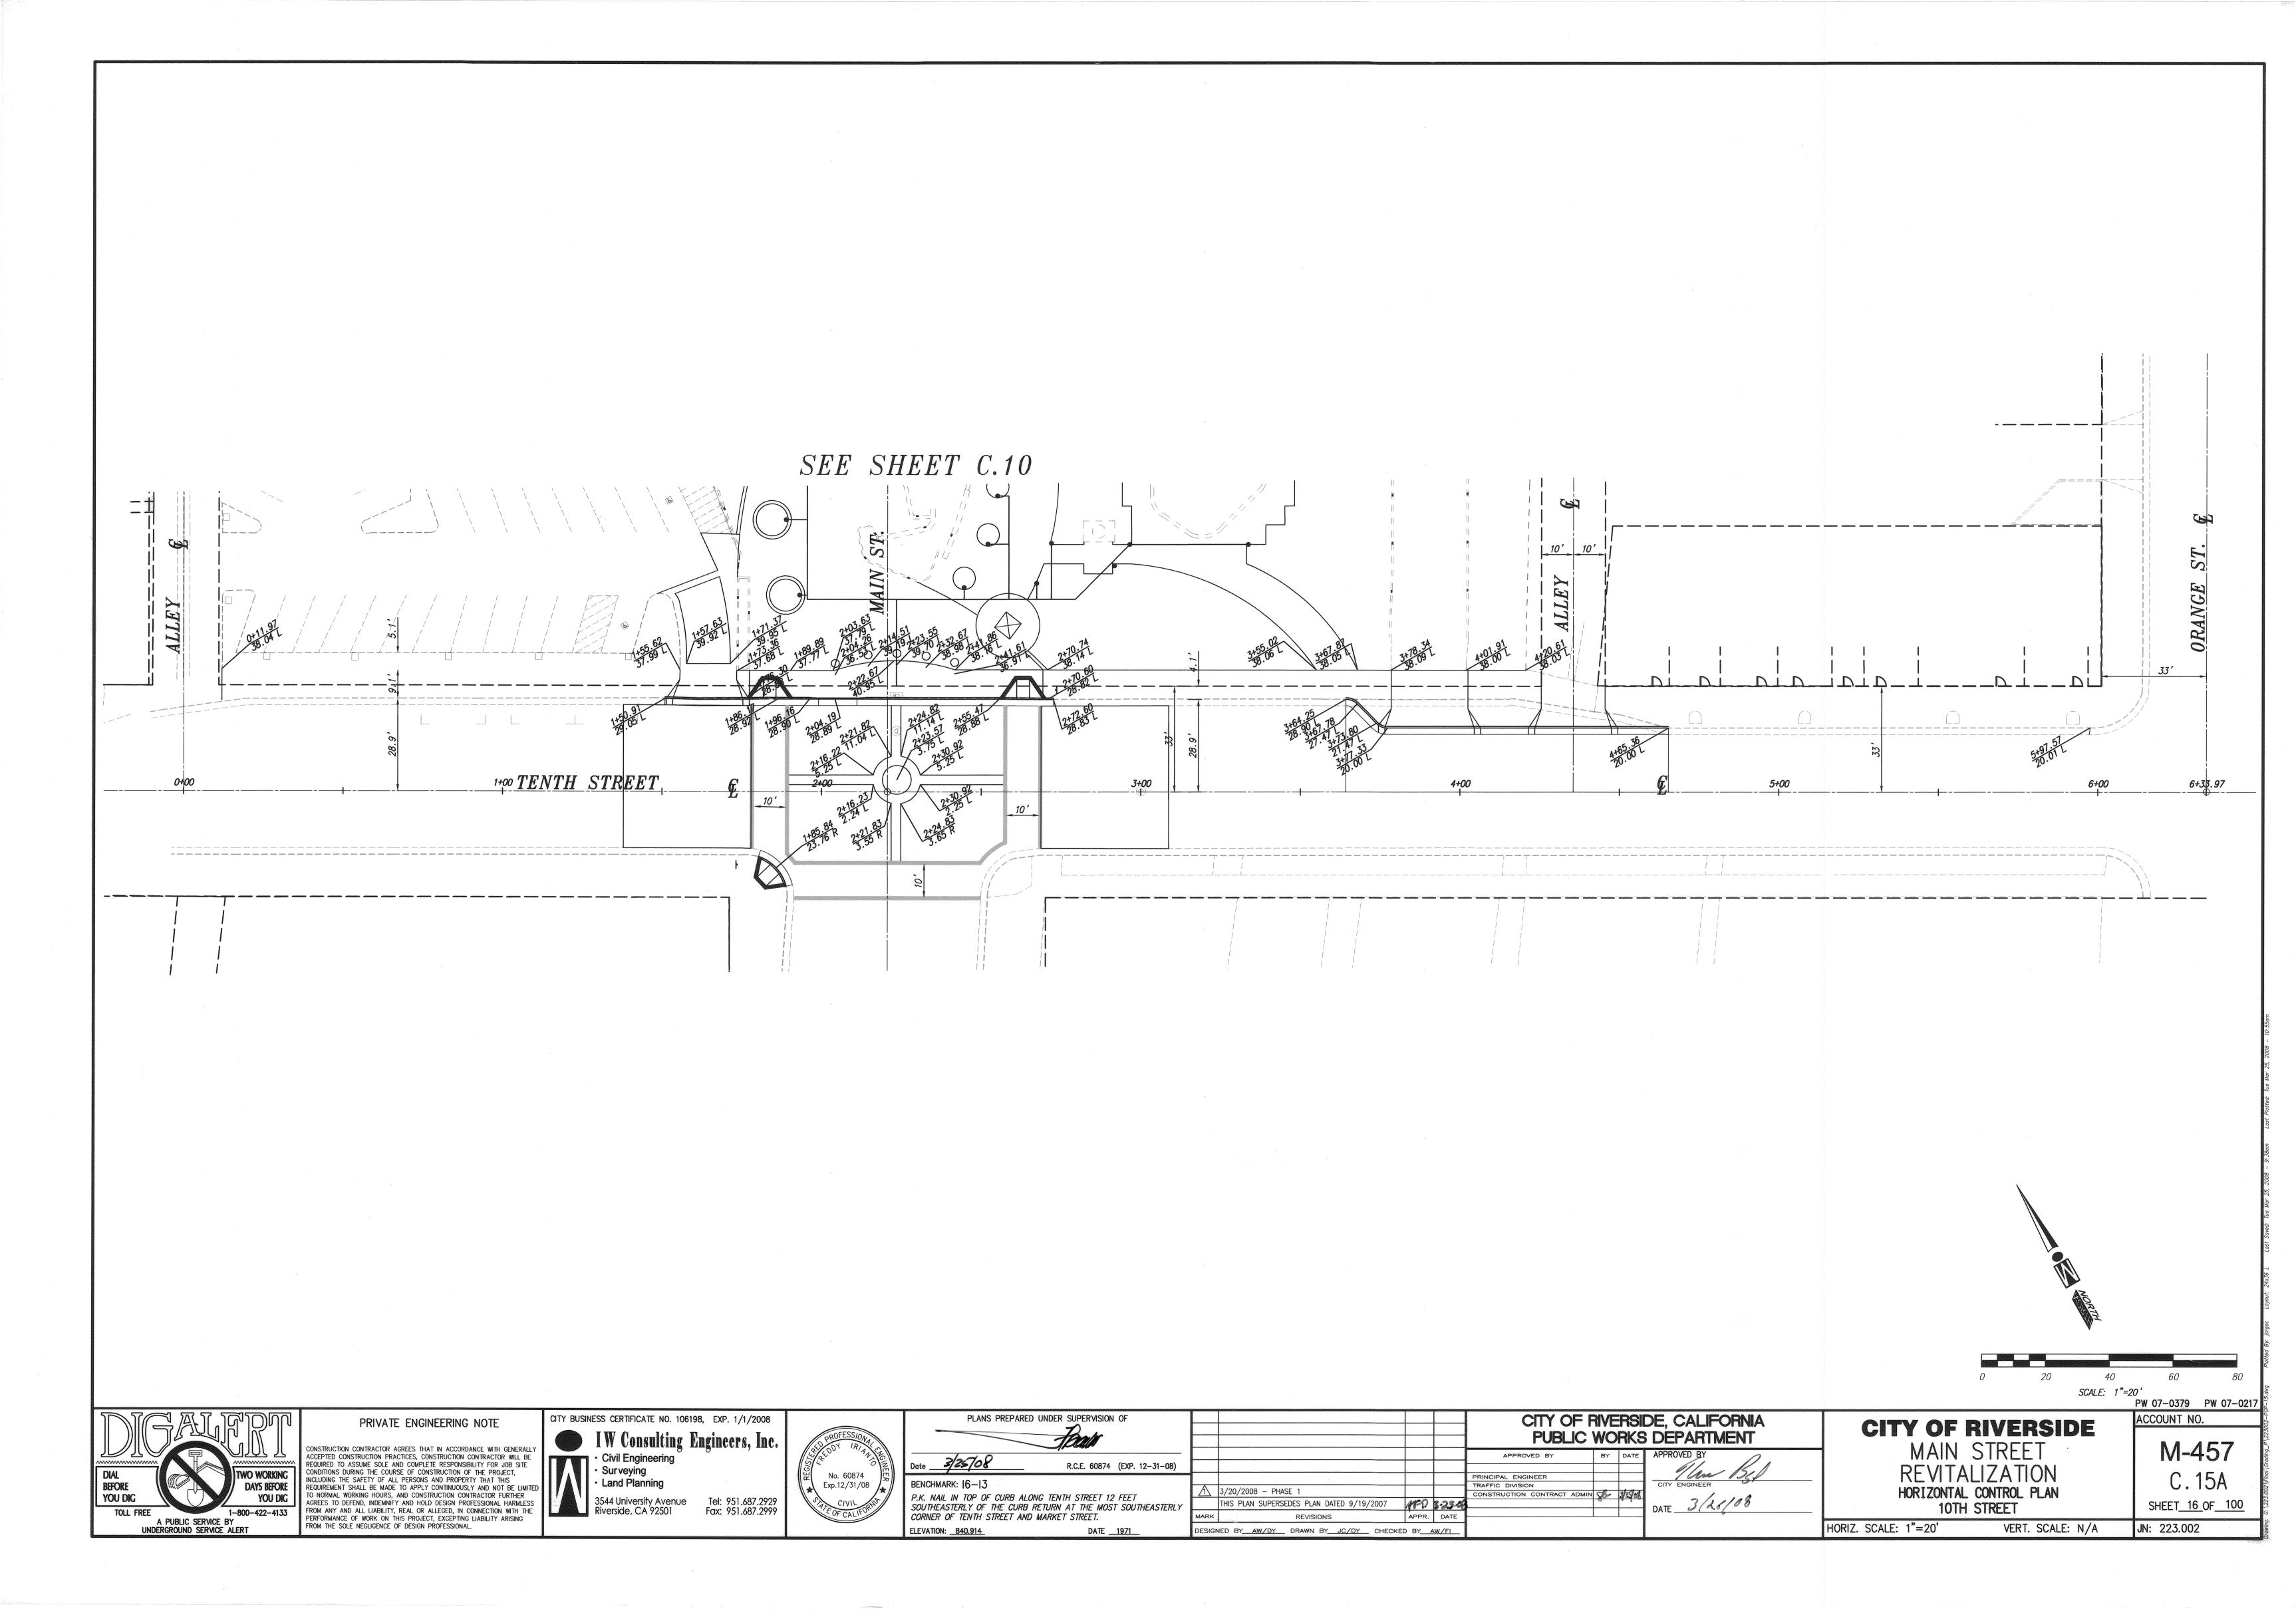



PRIVATE ENGINEERING NOTE

ION CONTRACTOR AGREES THAT IN ACCORDANCE WITH GENERAL CONSTRUCTION PRACTICES, CONSTRUCTION CONTRACTOR WILL B

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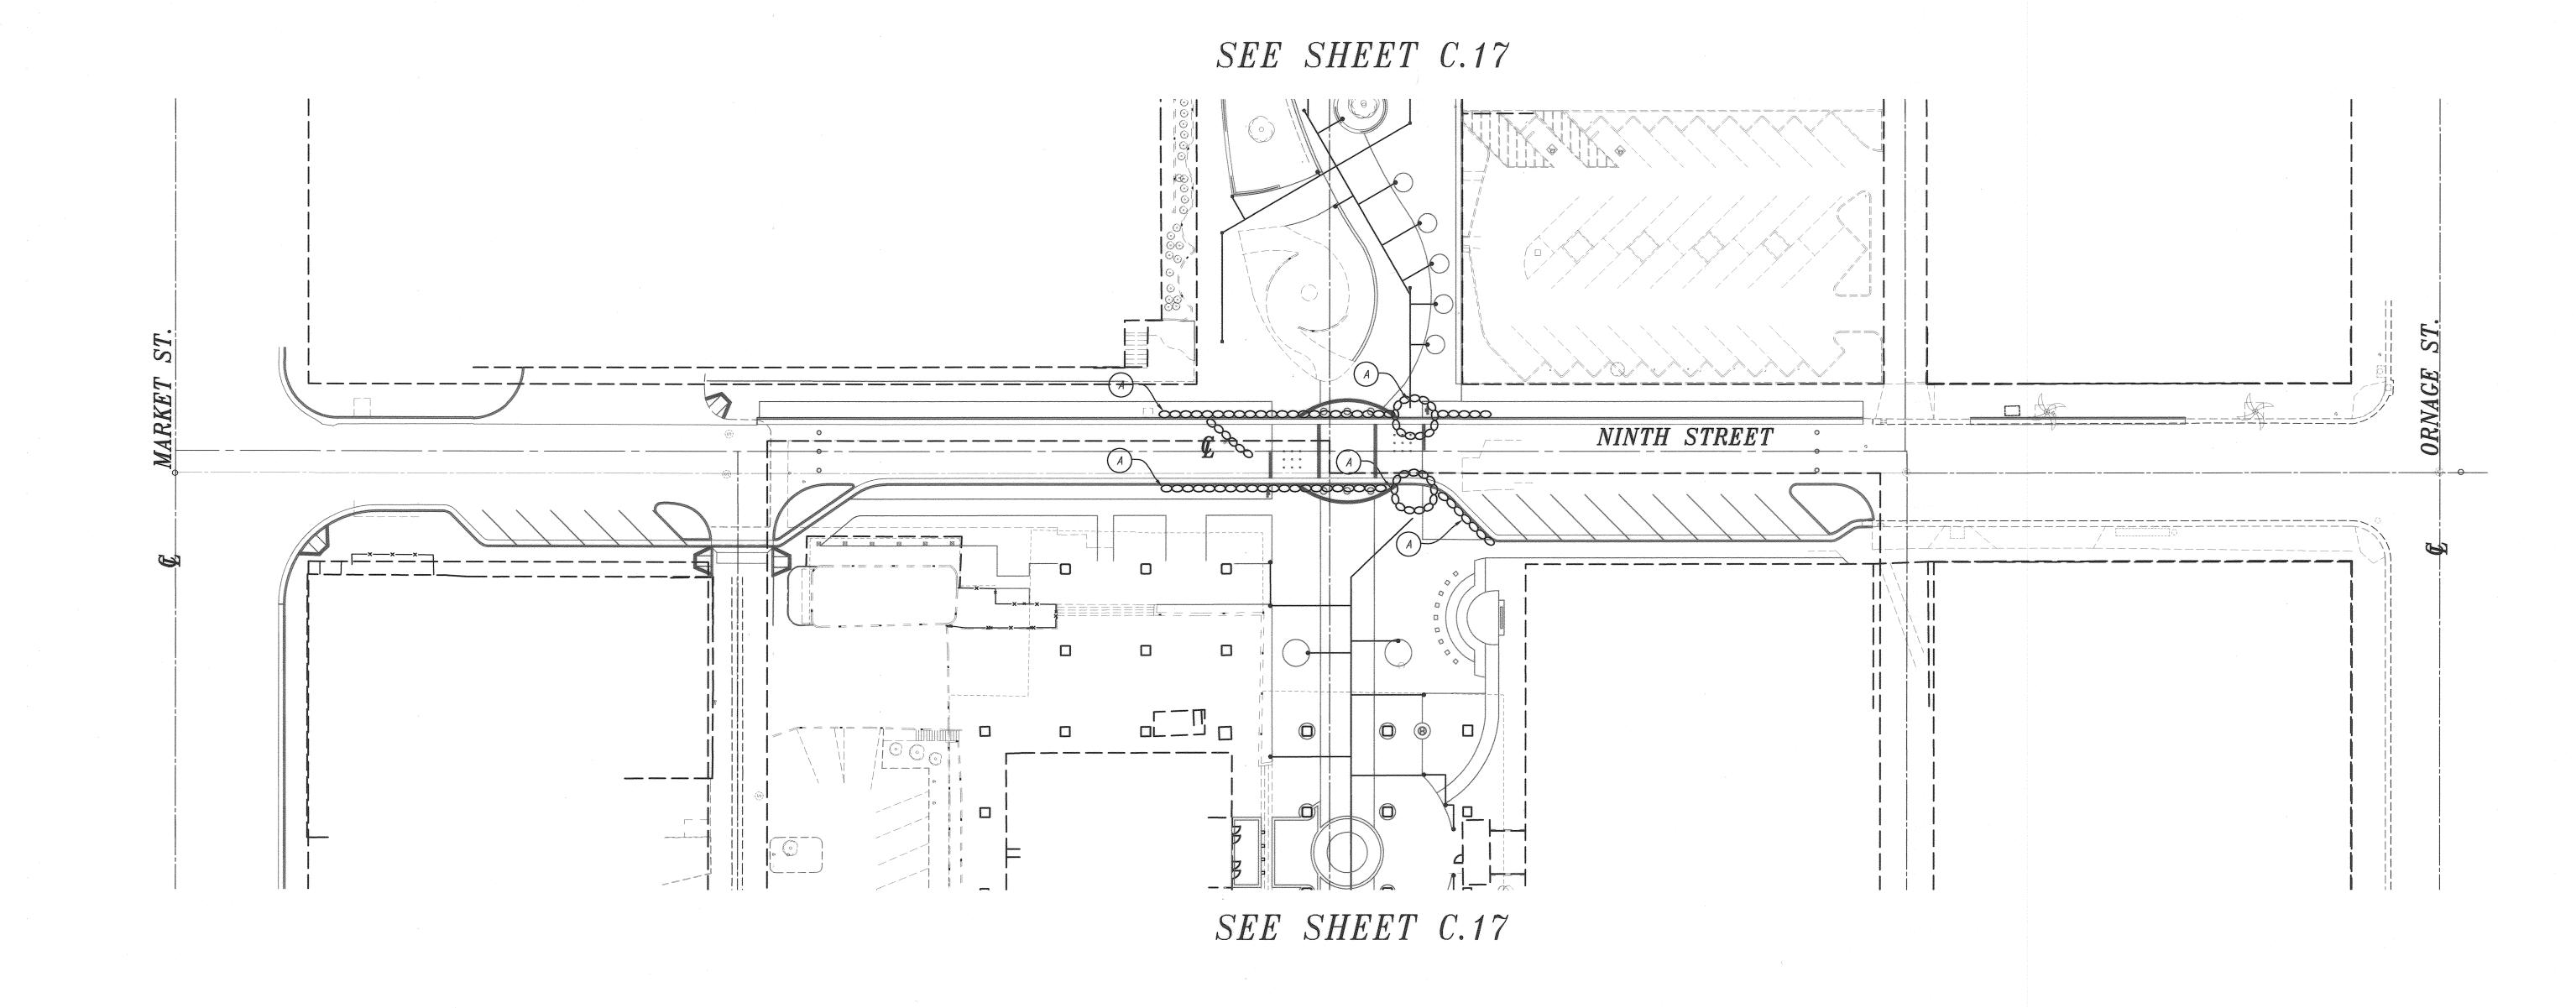


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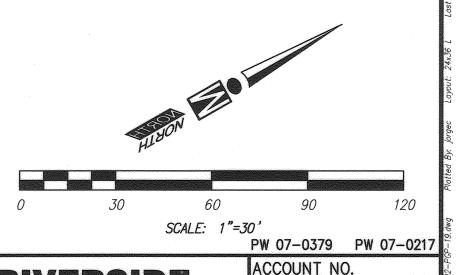


NOTES:

- GRAVEL BAGS ARE ENCOURAGED OVER THE USE OF SANDBAGS AND MAY BE REQUIRED IN AREAS WHICH ARE PARTICULARLY SENSITIVE TO SEDIMENT DEPOSITION.
- REQUIREMENTS FOR AND SPACING OF VELOCITY REDUCERS FOR STREETS WITH GRADES OF LESS THAT 4% SHALL BE AS SHOWN ON THE APPROVED EROSION CONTROL PLAN.

CONSTRUCTION NOTES:

(A) INSTALL SANDBAGS PER DETAIL SHEET 23






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Civil Engineering

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CITY OF RIVERSIDE MAIN STREET

REVITALIZATION EROSION CONTROL PLAN 9TH STREET


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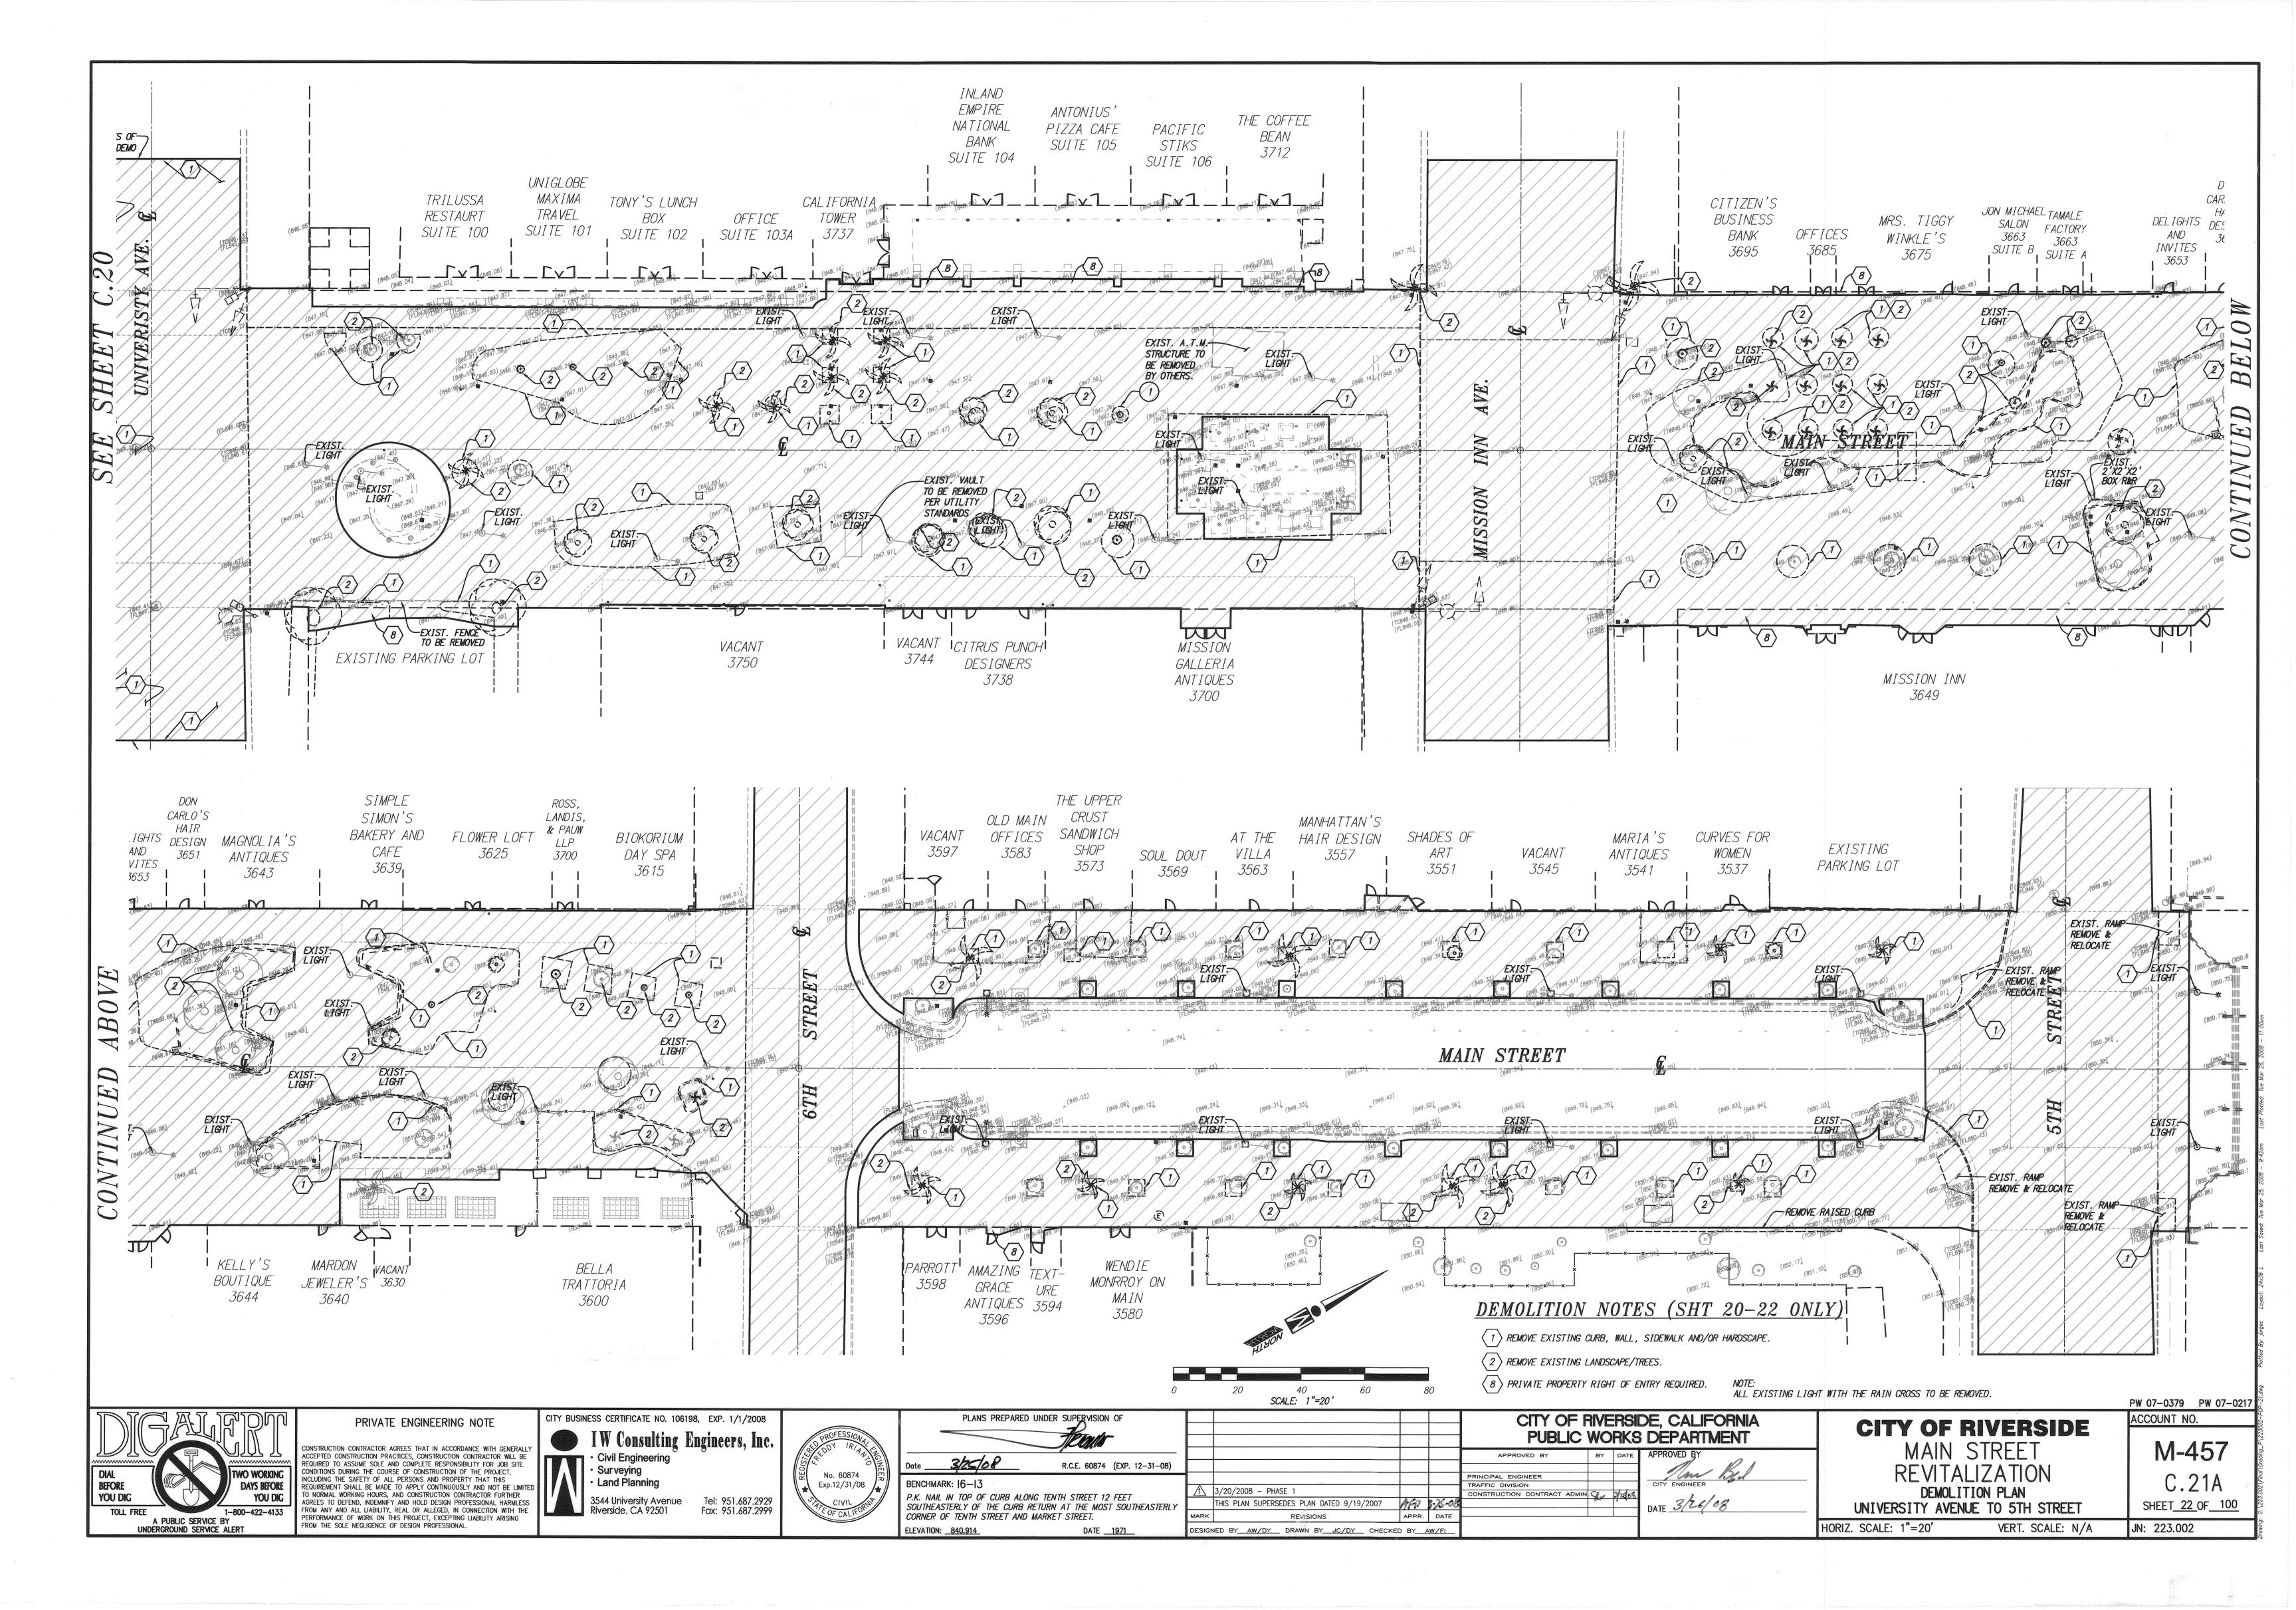
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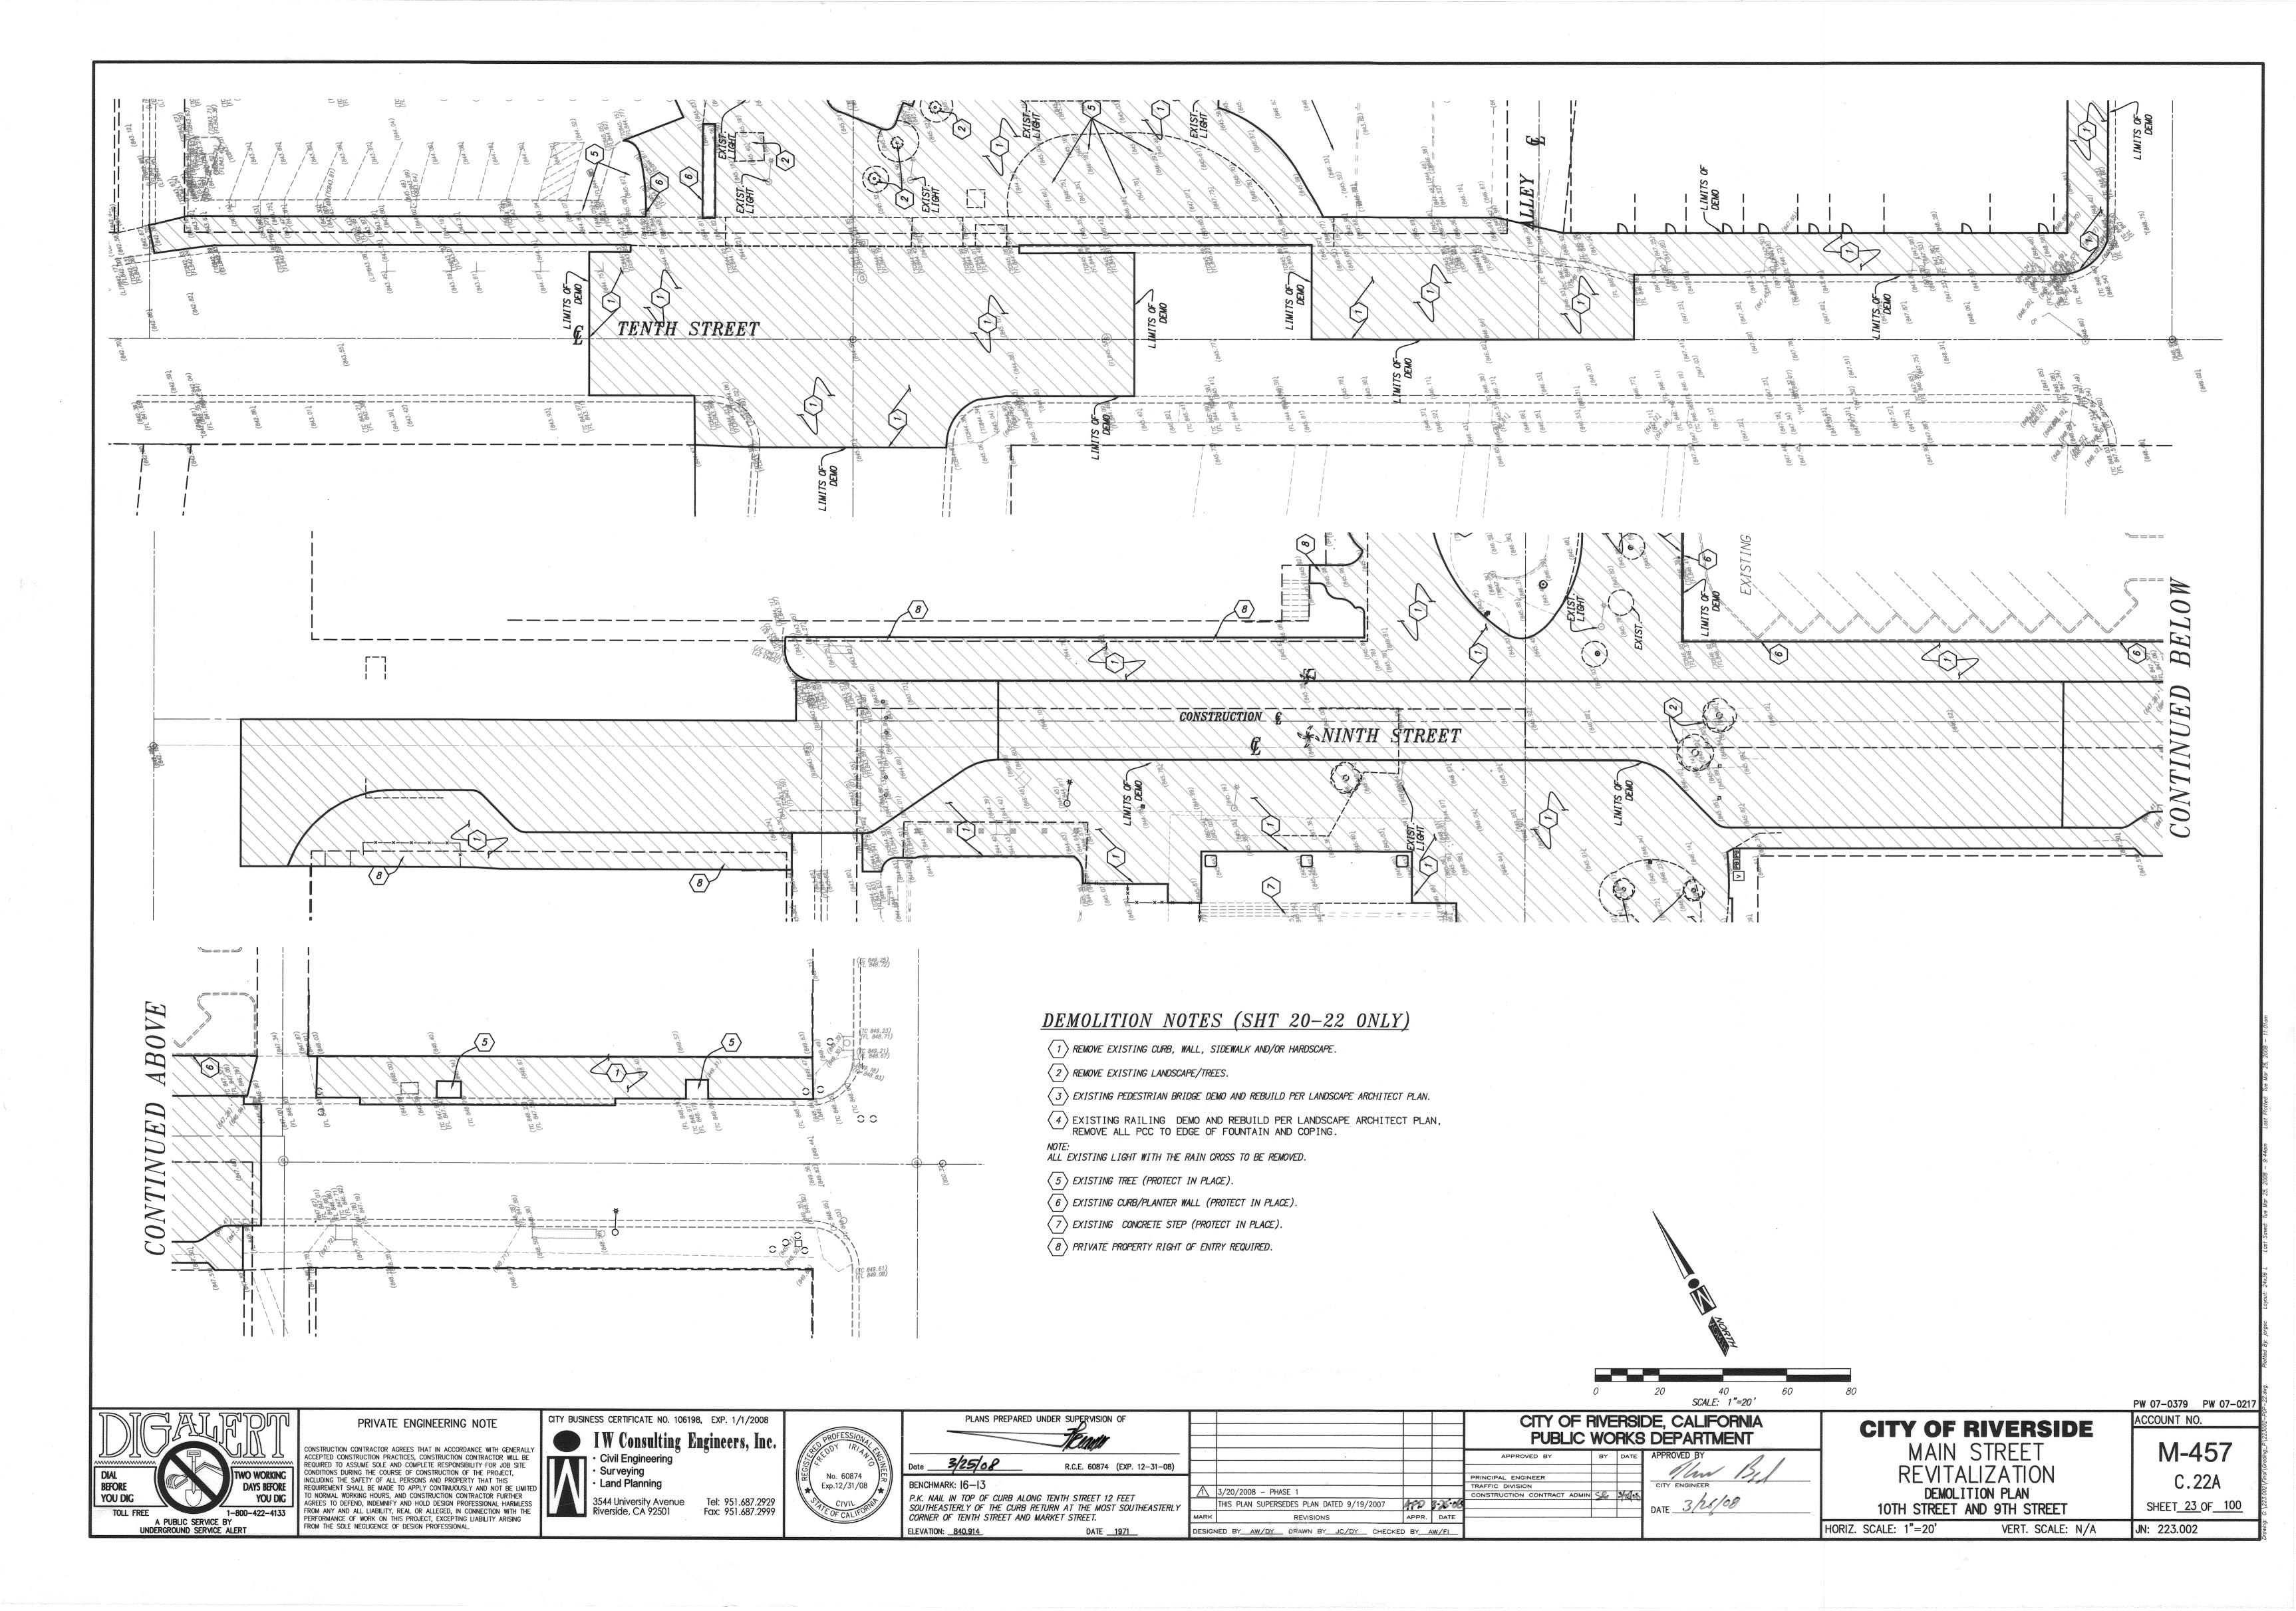
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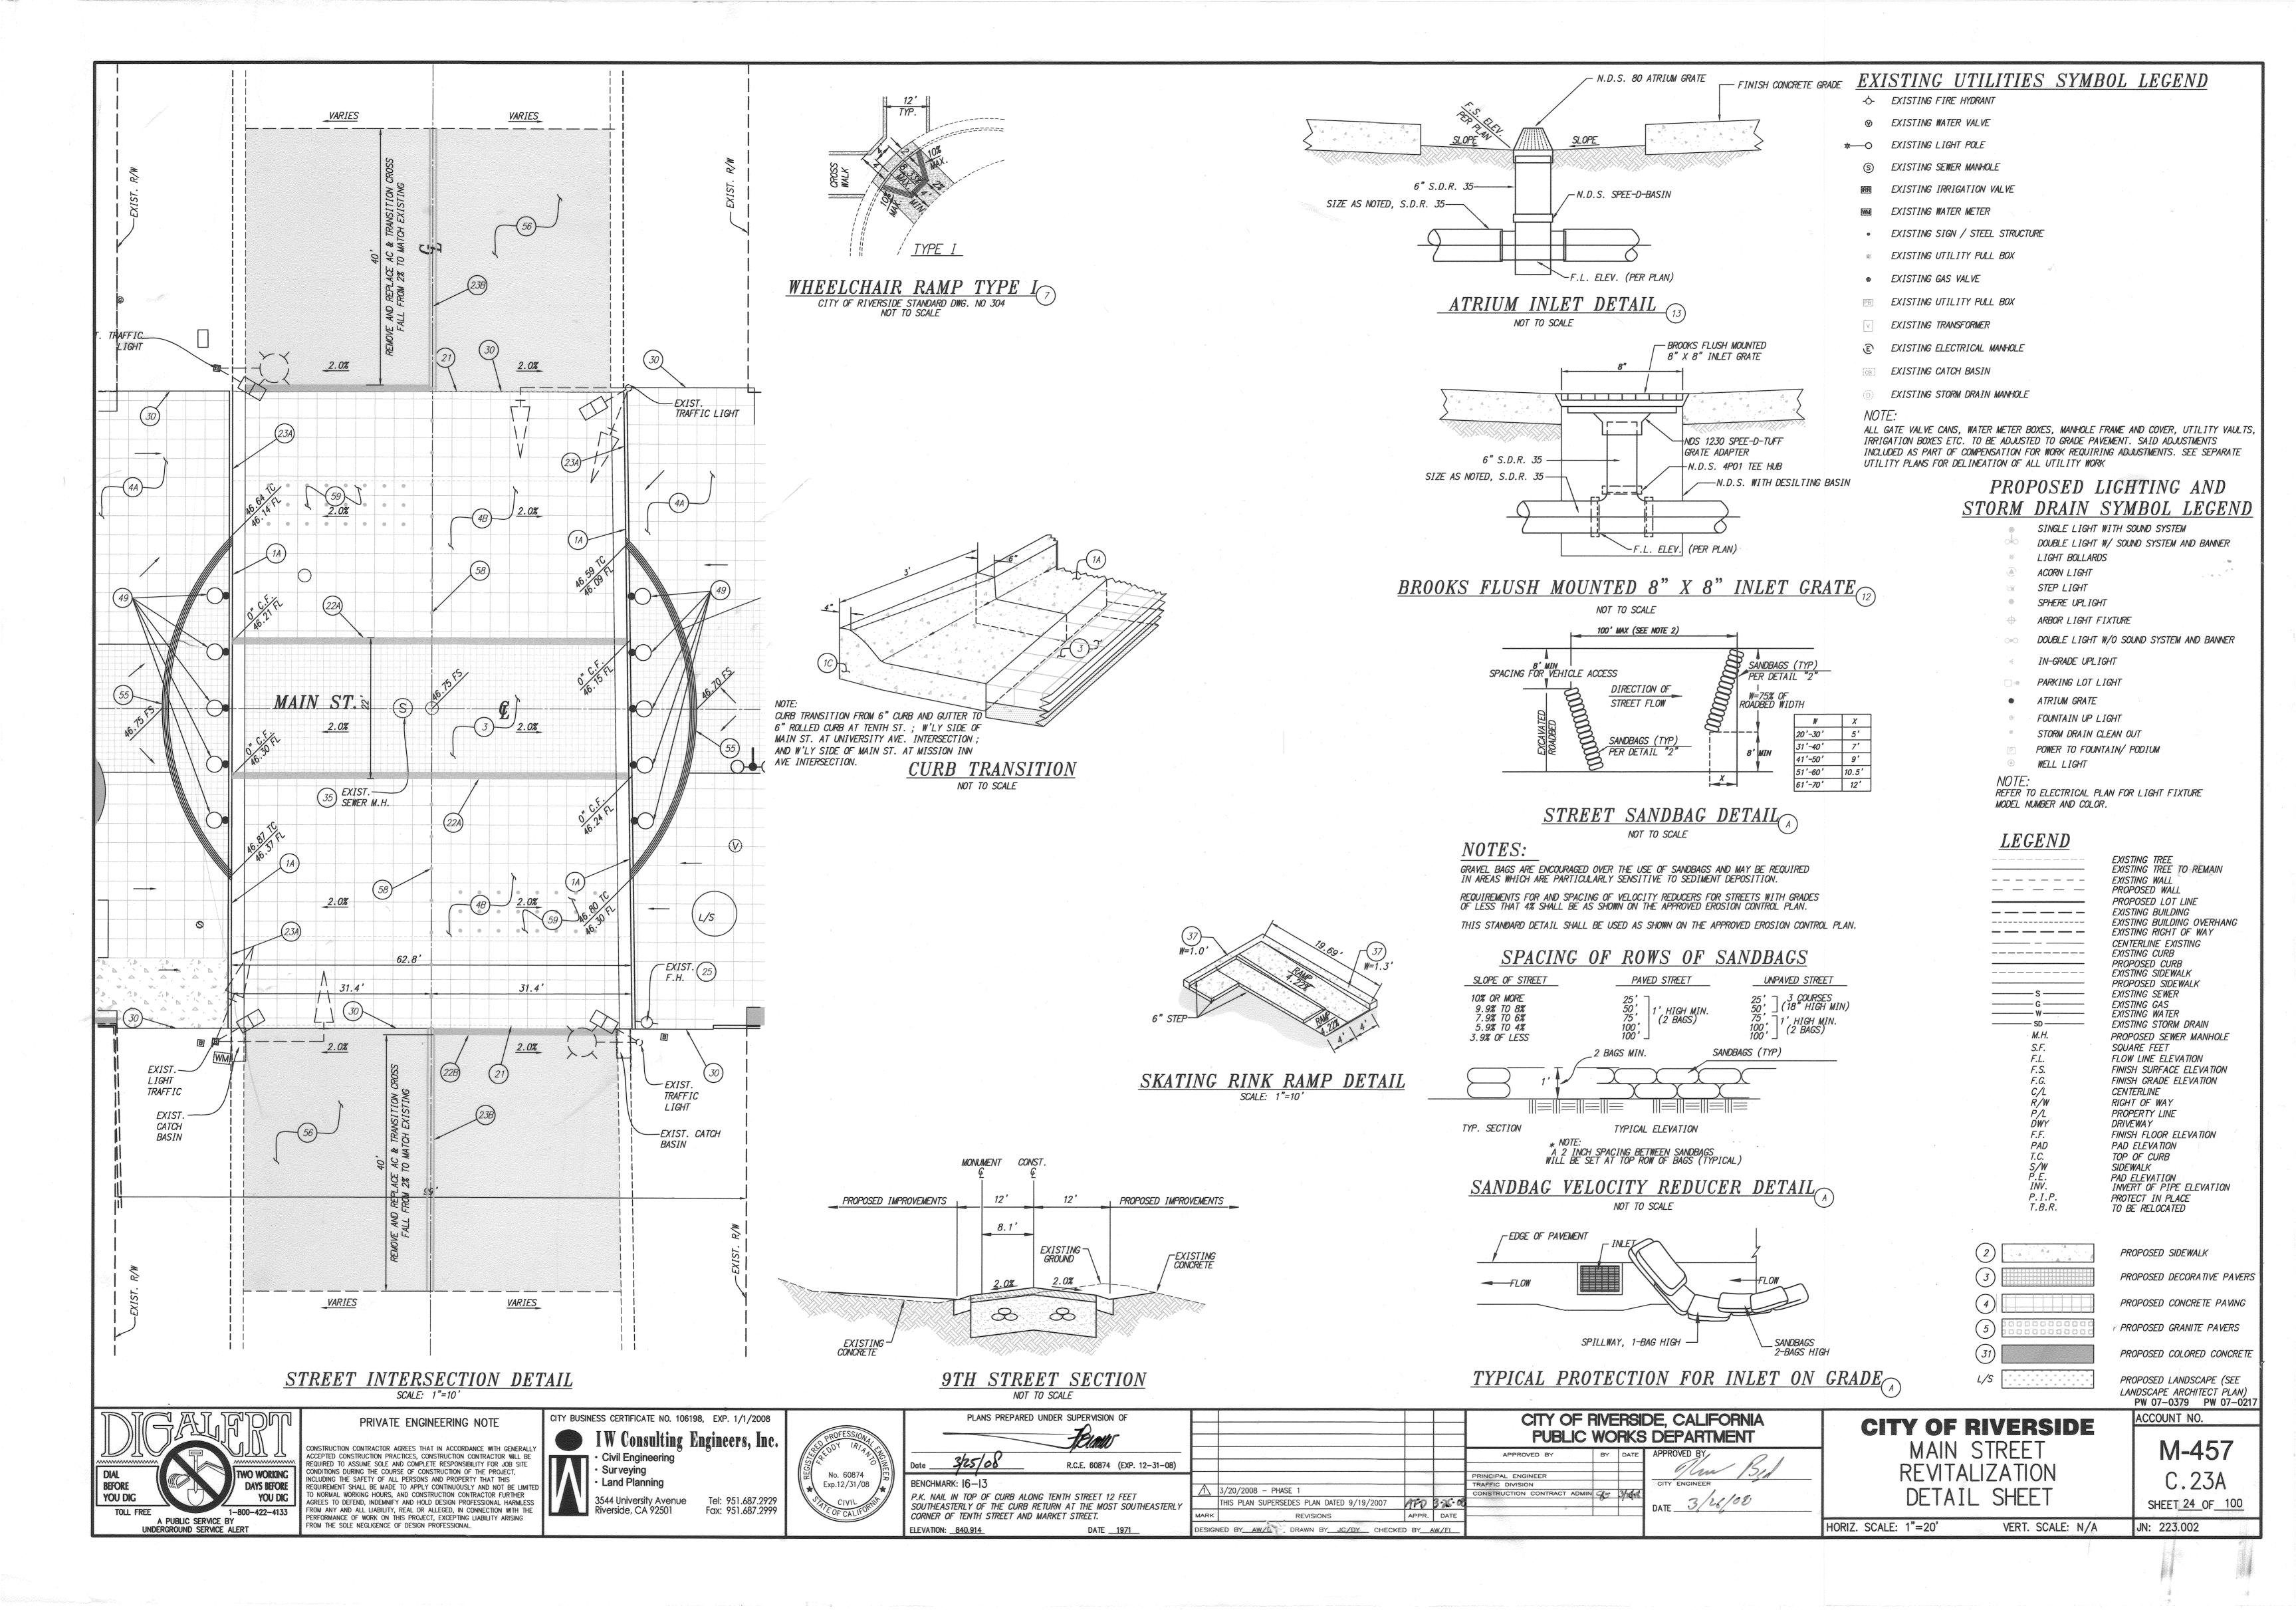
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ACCOUNT NO.



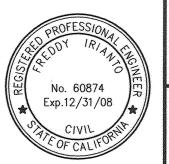





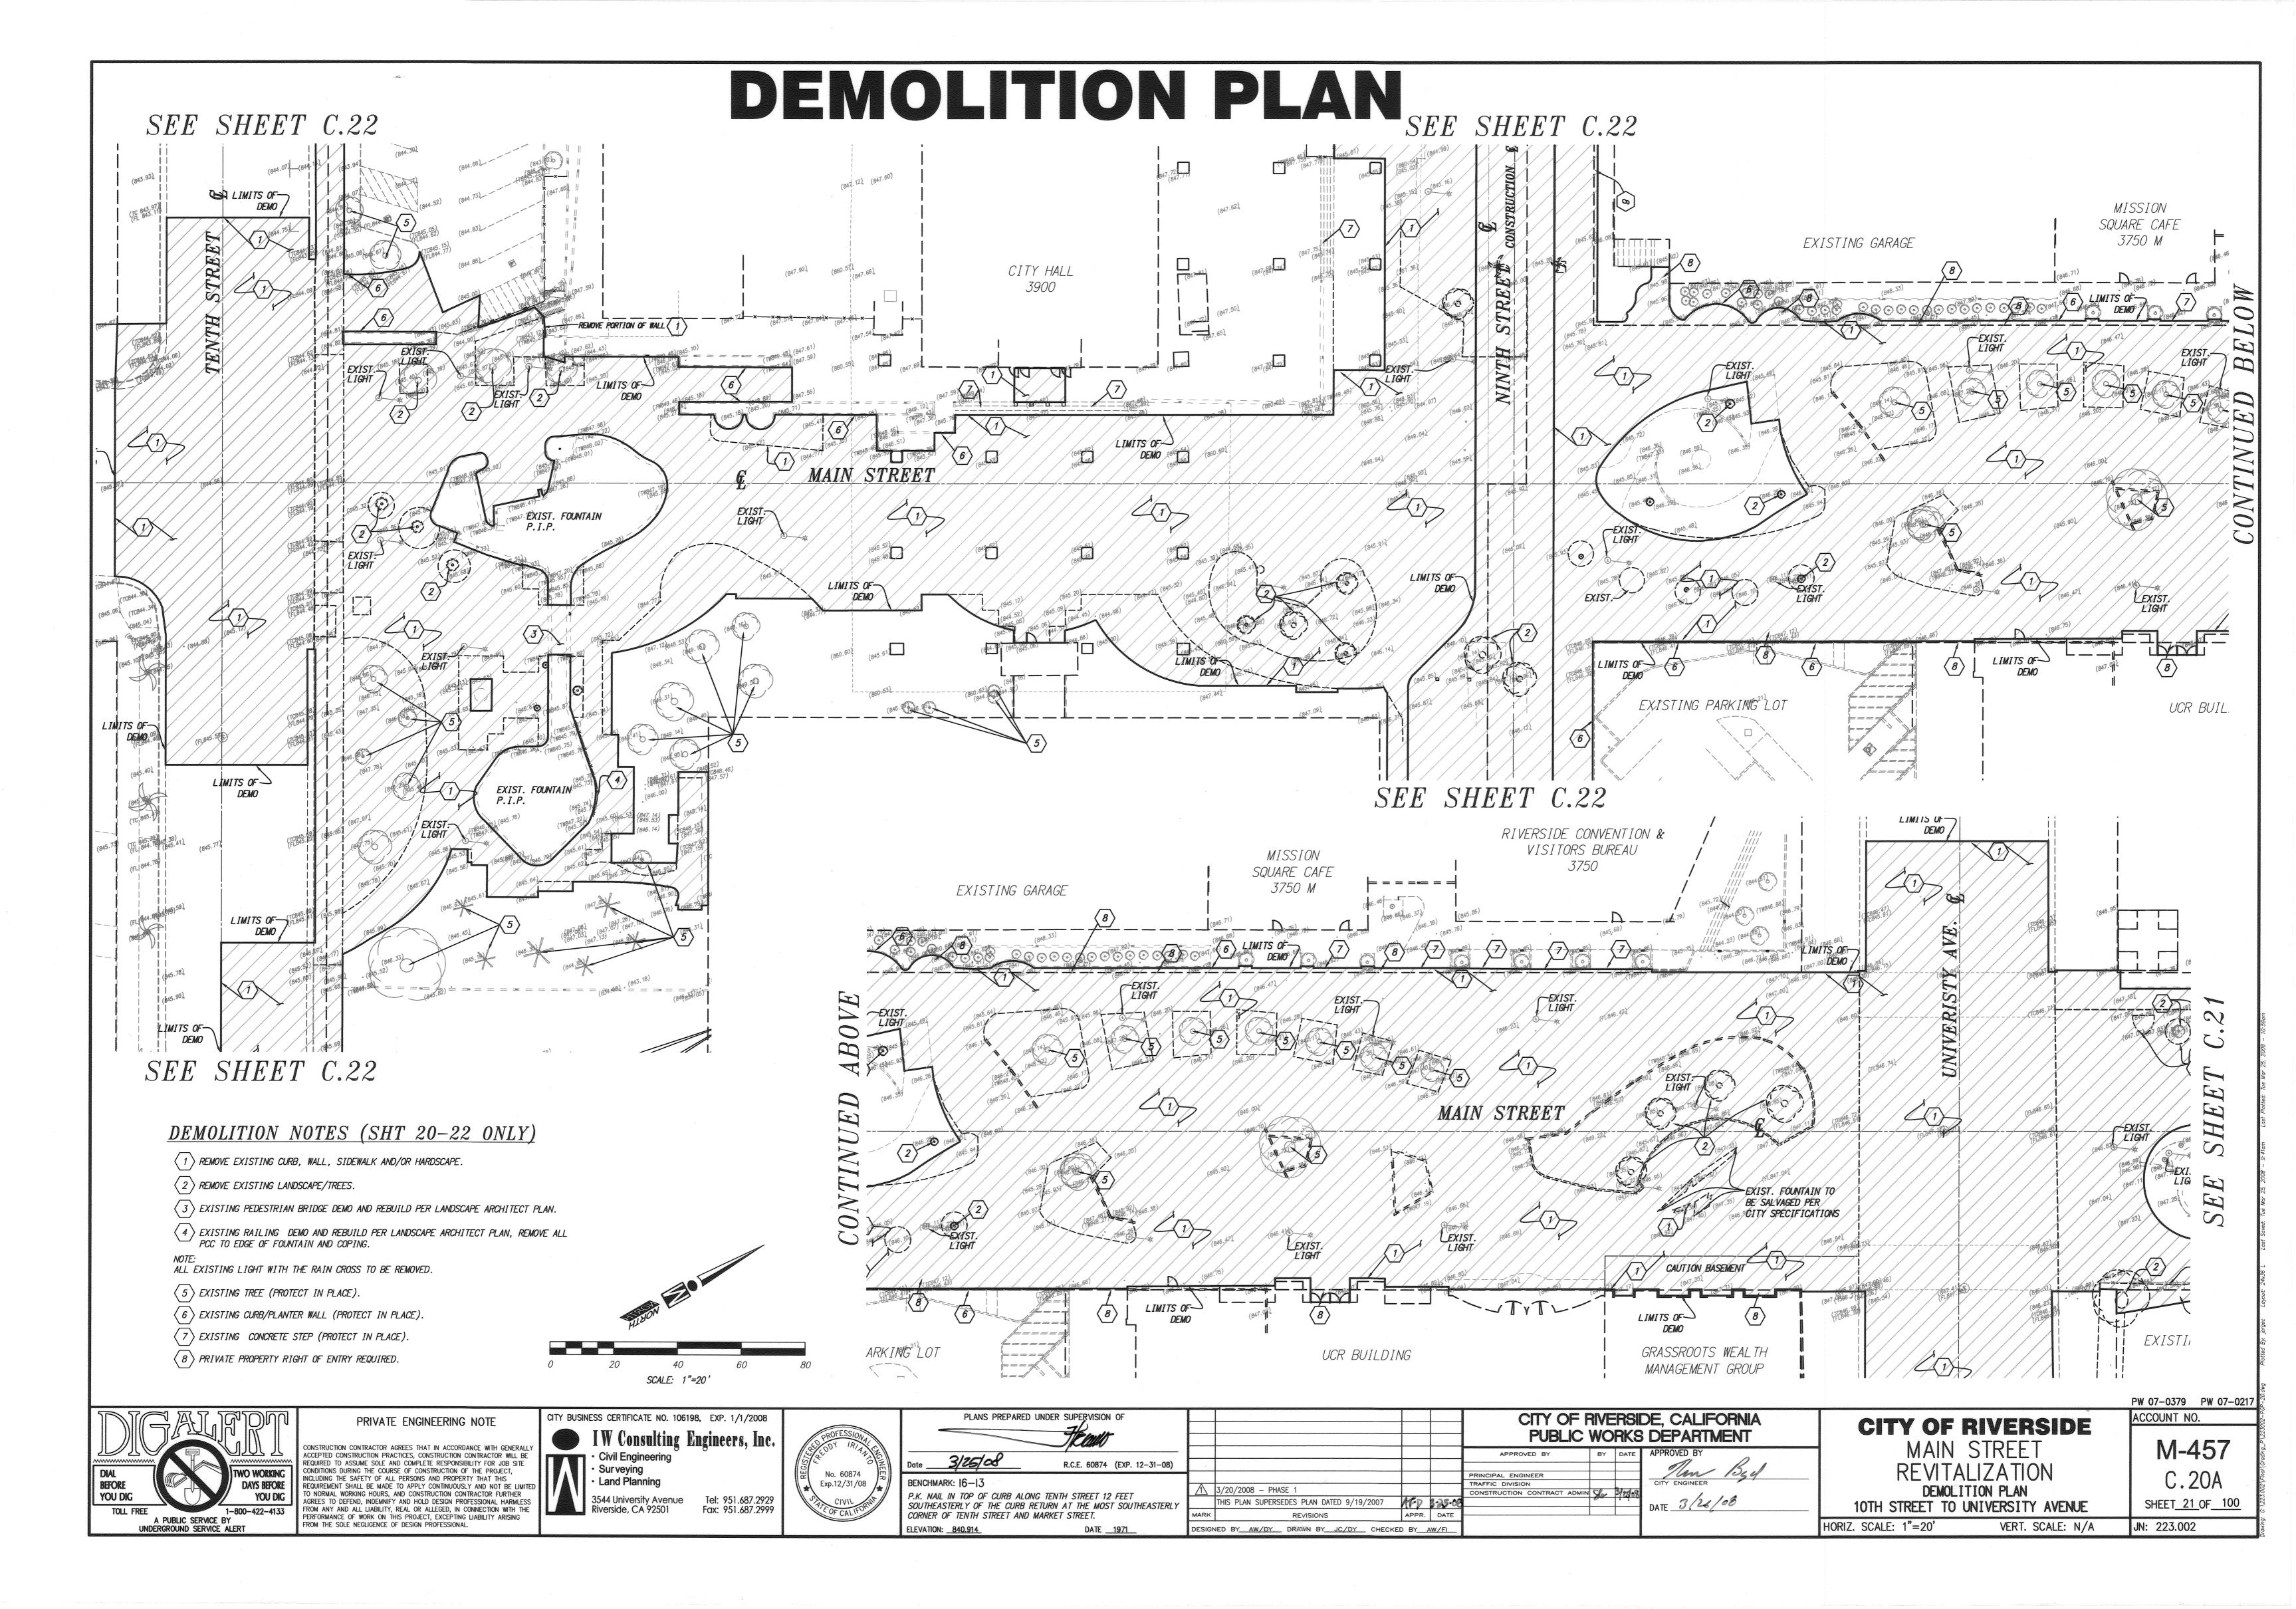

LANDSCAPE ARCHITECTURAL CONSTRUCTION PLANS

FOR

DOWNTOWN MALL MAIN STREET

CITY OF RIVERSIDE 3900 MAIN STREET RIVERSIDE, CA 92522


MANUFACTURER'S LIST:

- ACKERSTONE. 13296 TEMESCAL CANYON RD. CORONA, CA 92883 (909) 322-1988 CONTACT: GEORGE MEADE
- 2. BEGA LIGHTING. 1000 BEGA WAY. CARPINTERIA, CA 93013 (805) 684-0533.
- 3. COLD SPRING GRANITE. 1977 SAGE AVE. CORONA, CA 92882 (951) 549-9042. CONTACT: CRAIG GERBER
- 4. DEEP ROOT. 81 LANGTON STREET SUITE 4. SAN FRANCISCO, CA 94010 (800) 458-7668. CONTACT: PETE VOSKES
- 5. DELTA SCIENTIFIC CORP. 24901 WEST AVENUE STANFORD. VALENCIA, CA 91355 (661) 257-1800
- 6. ELA LIGHTING. 17891 ARENTH AVE. CITY OF INDUSTRY, CA 91748 (800) 423-6561. CONTACT: JOHN VANDER WENDE
- GREENSCREEN. 1743 S. LA CIENEGA BLVD. LOS ANGELES, CA 90035 (800) 450-3494
- 8. INVISIBLE STRUCTURES, INC. 1600 JACKSON ST., SUITE 310. GOLDEN, CO 80401 (206) 595-2203 CONTACT: ANDY
- 9. LANDSCAPE FORMS, 4139 VANETTA PLACE, STUDIO CITY, CA 91604 (818) 761-0655
- 10. MIRAFI. 22672 LAMBERT STREET SUITE 602. LAKE FOREST, CA 92630 (800) 423-9923. CONTACT: JIM OR JOSH
- II. MURDOCK, INC. 2488 RIVER ROAD. CINCINNATI, OHIO 45204 (513) 471-7700

MARKET STREET

- 12. PAVE TECH, INC. P.O. BOX 576. PRIOR LAKE, MINNESOTA 55372
- 13. PERMALOC CORPORATION. 13505 BARRY STREET, HOLLAND, MI. 49424 (800) 356-9660
- 14. ORCO BLOCK. 4510 RUTILE STREET. RIVERSIDE, CA 92509
- 15. QUICK CRETE PRODUCTS CORP. 731 W. PARKRIDGE AVE. NORCO, CA 92860 (951) 737-6240
- 16. L.M. SCOFIELD. 6533 BANDINI BLVD. LOS ANGELES, CA 90040 (480) 460-0434 CONTACT: LARRY BOWER
- 17. SHADE STRUCTURES, INC. 350 KALMUS DRIVE. COSTA MESA, CA 92626 (714) 427-6981 CONTACT: PATTI ABRECHT
- 18. SPECTRUM DEVELOPERS. 1241 FLEMINGTON ROAD, RIVERSIDE, CA 92506 (951) 741-1550 CONTACT: STEVE KOPPES
- 19. SPEED DOWEL. 3400 TREE COURT INDUSTRIAL BLVD. ST. LOUIS, MO 63122 (800) 325-9504
- 20. SOUTHWEST BOULDER & STONE, 4510 RUTILE ST. RIVERSIDE, CA 92509 (951) 685-1521 CONTACT: LOE ABDELLA
- 21. WEST COAST TURF. 75-030 GERALD FORD DR. SUITE 201. PALM DESERT, CA 92211. (800) 447-1840 CONTACT: JOHN
- 22. DALTILE. 1132 DURYEA. IRVINE, CA 92614 (949) 757-7060

VICINTY MAP: NTS

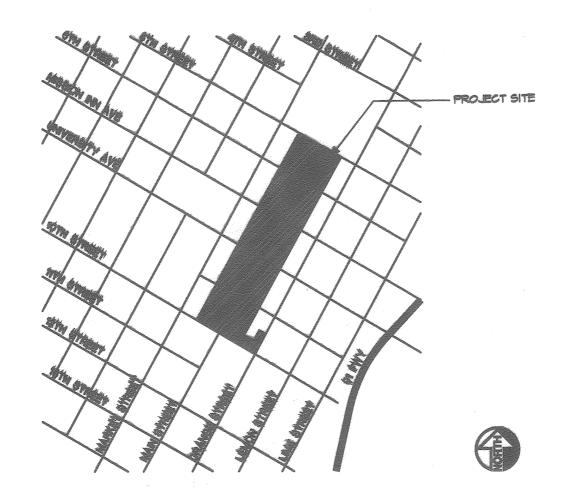

GENERAL NOTES:

I. BASE INFORMATION INCLUDING THE LOCATION OF PROPERTY LINES, EASEMENTS, BUILDING, ROADS AND CURBS HAVE BEEN TAKEN FROM THE ARCHITECTS DRAWINGS. REFER TO THE ARCHITECTS AND CIVIL ENGINEERS

2. REFER TO THE CIVIL ENGINEERS DRAWINGS FOR UTILITY INFORMATION INCLUDING STORM DRAIN, SEWER, WATER, ELECTRICAL, GAS, TELEPHONE AND CABLE TV.

3. REFER TO THE CITY AND / OR COUNTY STANDARD PLANS AND SPECIFICATIONS AS APPLICABLE.

4. CONTRACTOR TO VERIFY SITE INFORMATION INCLUDING PROPERTY LINES OTHER INFORMATION AFFECTING THE SCOPE OF WORK INCLUDED ON THESE DRAWINGS. IF ACTUAL SITE CONDITIONS VARY FROM WHAT IS SHOWN ON THE LANDSCAPE ARCHITECT'S PLANS, THE CONTRACTOR SHALL CONTACT THE OWNER'S REPRESENTATIVE AND THE LANDSCAPE ARCHITECT FOR DIRECTION ON HOW TO PROCEED.

5. EXCAVATION IN THE VICINITY OF UTILITIES AND EXISTING MATERIALS SHALL RESPONSIBILITY FOR THIS WORK. ANY DAMAGE CAUSED BY ANY PERSON, YEHICLE, EQUIPMENT, OR TOOL RELATED TO THE EXECUTION OF THE CONTRACT SHALL BE REPAIRED IMMEDIATELY AT NO EXPENSE TO THE OWNER.

6. CONTRACTOR SHALL BE RESPONSIBLE FOR ANY COORDINATION WITH SUBCONTRACTORS AS REQUIRED TO ACCOMPLISH ALL CONSTRUCTION OPERATIONS. ALL PIPING, CONDUIT, SLEEVES, ETC., SHALL BE SET IN PLACE PRIOR TO INSTALLATION OF CONSTRUCTION ITEMS.

7. CONTRACTOR SHALL NOT WILLFULLY PROCEED WITH CONSTRUCTION AS DESIGNED WHEN IT IS OBVIOUS THAT UNKNOWN OBSTRUCTIONS, AREA DISCREPANCIES AND / OR GRADE DIFFERENCES EXIST THAT MAY NOT HAVE BEEN KNOWN DURING DESIGN, SUCH CONDITIONS SHALL BE IMMEDIATELY BROUGHT TO THE ATTENTION OF THE OWNER'S AUTHORIZED REPRESENTATIVE. THE CONTRACTOR SHALL ASSUME FULL RESPONSIBILITY FOR ALL NECESSARY REVISIONS DUE TO FAILURE TO GIVE SUCH NOTIFICATIONS.

8. ALL ELECTRICAL JUNCTION BOXES FOR LIGHTS SHALL BE IN PLANTING AREAS. STAKE LOCATION PRIOR TO INSTALLATION.

9. SEE CIVIL ENGINEER'S DRAWINGS FOR CURBS AND A/C PAVING.

10. CONTRACTOR SHALL VERIFY ALL CONDITIONS AND DIMENSIONS AT THE JOB SITE AND NOTIFY ARCHITECT OF ANY DIMENSIONAL ERRORS, OMISSIONS OR DISCREPANCIES BEFORE BEGINNING OR FABRICATING ANY WORK. DO NOT SCALE DRAWINGS.

SHEET INDEX:

COVER SHEET

L-0.1	OO 4 LIN OI ILLE I	Applied to the
[.]	CONSTRUCTION PLAN	26
L-12	CONSTRUCTION PLAN	27
L-1.3	CONSTRUCTION PLAN	28
L-1.4	CONSTRUCTION PLAN	29
L-I.5	CONSTRUCTION PLAN	30
L-1.6	CONSTRUCTION PLAN	31
L-1.7	CONSTRUCTION PLAN	32
L-1.8	FOUNTAIN/BRIDGE DETAILS	33
L-1.9	FOUNTAIN/BRIDGE DETAILS	34
L-1.10	LINEAR FOUNTAIN DETAILS	35
	CIRCULAR FOUNTAIN DETAILS	36
L-I.I2	FOUNTAIN DETAILS	31
L-I.13	FOUNTAIN DETAILS	38
L-1.14	STRUCTURAL DETAILS	39
L-I.15	STRUCTURAL DETAILS	40
L-1.16	STRUCTURAL DETAILS	41
L-1.17	ARBOR DETAILS	42
L-1.18	PUBLIC COURT DETAILS	43
L-1.19	CONSTRUCTION DETAILS	44
L-120	CONSTRUCTION DETAILS	45
L-1.21	CONSTRUCTION DETAILS	46
L-1.22	ART ELEMENTS	47
L-2.I	IRRIGATION PLAN	48
L-22	IRRIGATION PLAN	49
L-2.3	IRRIGATION PLAN	50
L-2.4	IRRIGATION PLAN	51
L-2.5	IRRIGATION PLAN	52
L-2.5	IRRIGATION PLAN	53
L-2.7	IRRIGATION PLAN	54
L-2.1 L-2.8	IRRIGATION DETAILS	55
	PLANTING PLAN	56
L-3.l	PLANTING PLAN	57
L-3.2	PLANTING PLAN	58
L-3.3	PLANTING PLAN	59
L-3.4	PLANTING PLAN	60
L-3.5		61
L-3.6	PLANTING PLAN PLANTING PLAN	62
L-3.7		63
L-3.8	PLANTING DETAILS	64
L-3.9	PLANTING DETAILS	65
L-4.I	TREE RETENTION PLAN TREE RETENTION PLAN	66
L-42		67
L-4.3	TREE RETENTION PLAN	68
L-4.4	TREE RETENTION PLAN	
L-4.5	TREE RETENTION PLAN	69
L-4.6	TREE RETENTION PLAN	70
L-4.7	TREE RETENTION PLAN	71 of 100

ABBREVIATION:

PLANTING AREA DIAMETER ARCHITECT TO BE DECIDED

TOE OF SLOPE TOP OF SLOPE BLDG. BUILDING EXISTING PAYING

F.O.B.

DRAWINGS

FACE OF BLDG.

TBD.

DOWNTOWN MALL

LANDSCAPE PLANS


COVER SHEET M - 457SHEET 25 OF 100

UNDERGROUND SERVICE ALERT CALL: TOLL FREE 227 - 2600 WORKING DAYS BEFORE YOU DIG


KEY MAP





IAN DAVIDSON, LANDSCAPE ARCHITECTURE RIVERSIDE, CA 92501

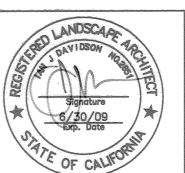


				CITY OF RIVERSIDE, CALIFORNIA PUBLIC WORKS DEPARTMENT
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MARK	REVISIONS ED BY JD DRAWN BY JM / MA CHECKED B	APPR.	DATE	SURVEYOR TRAFFIC DIVISION PARKS DEPARTMENT DATE DATE

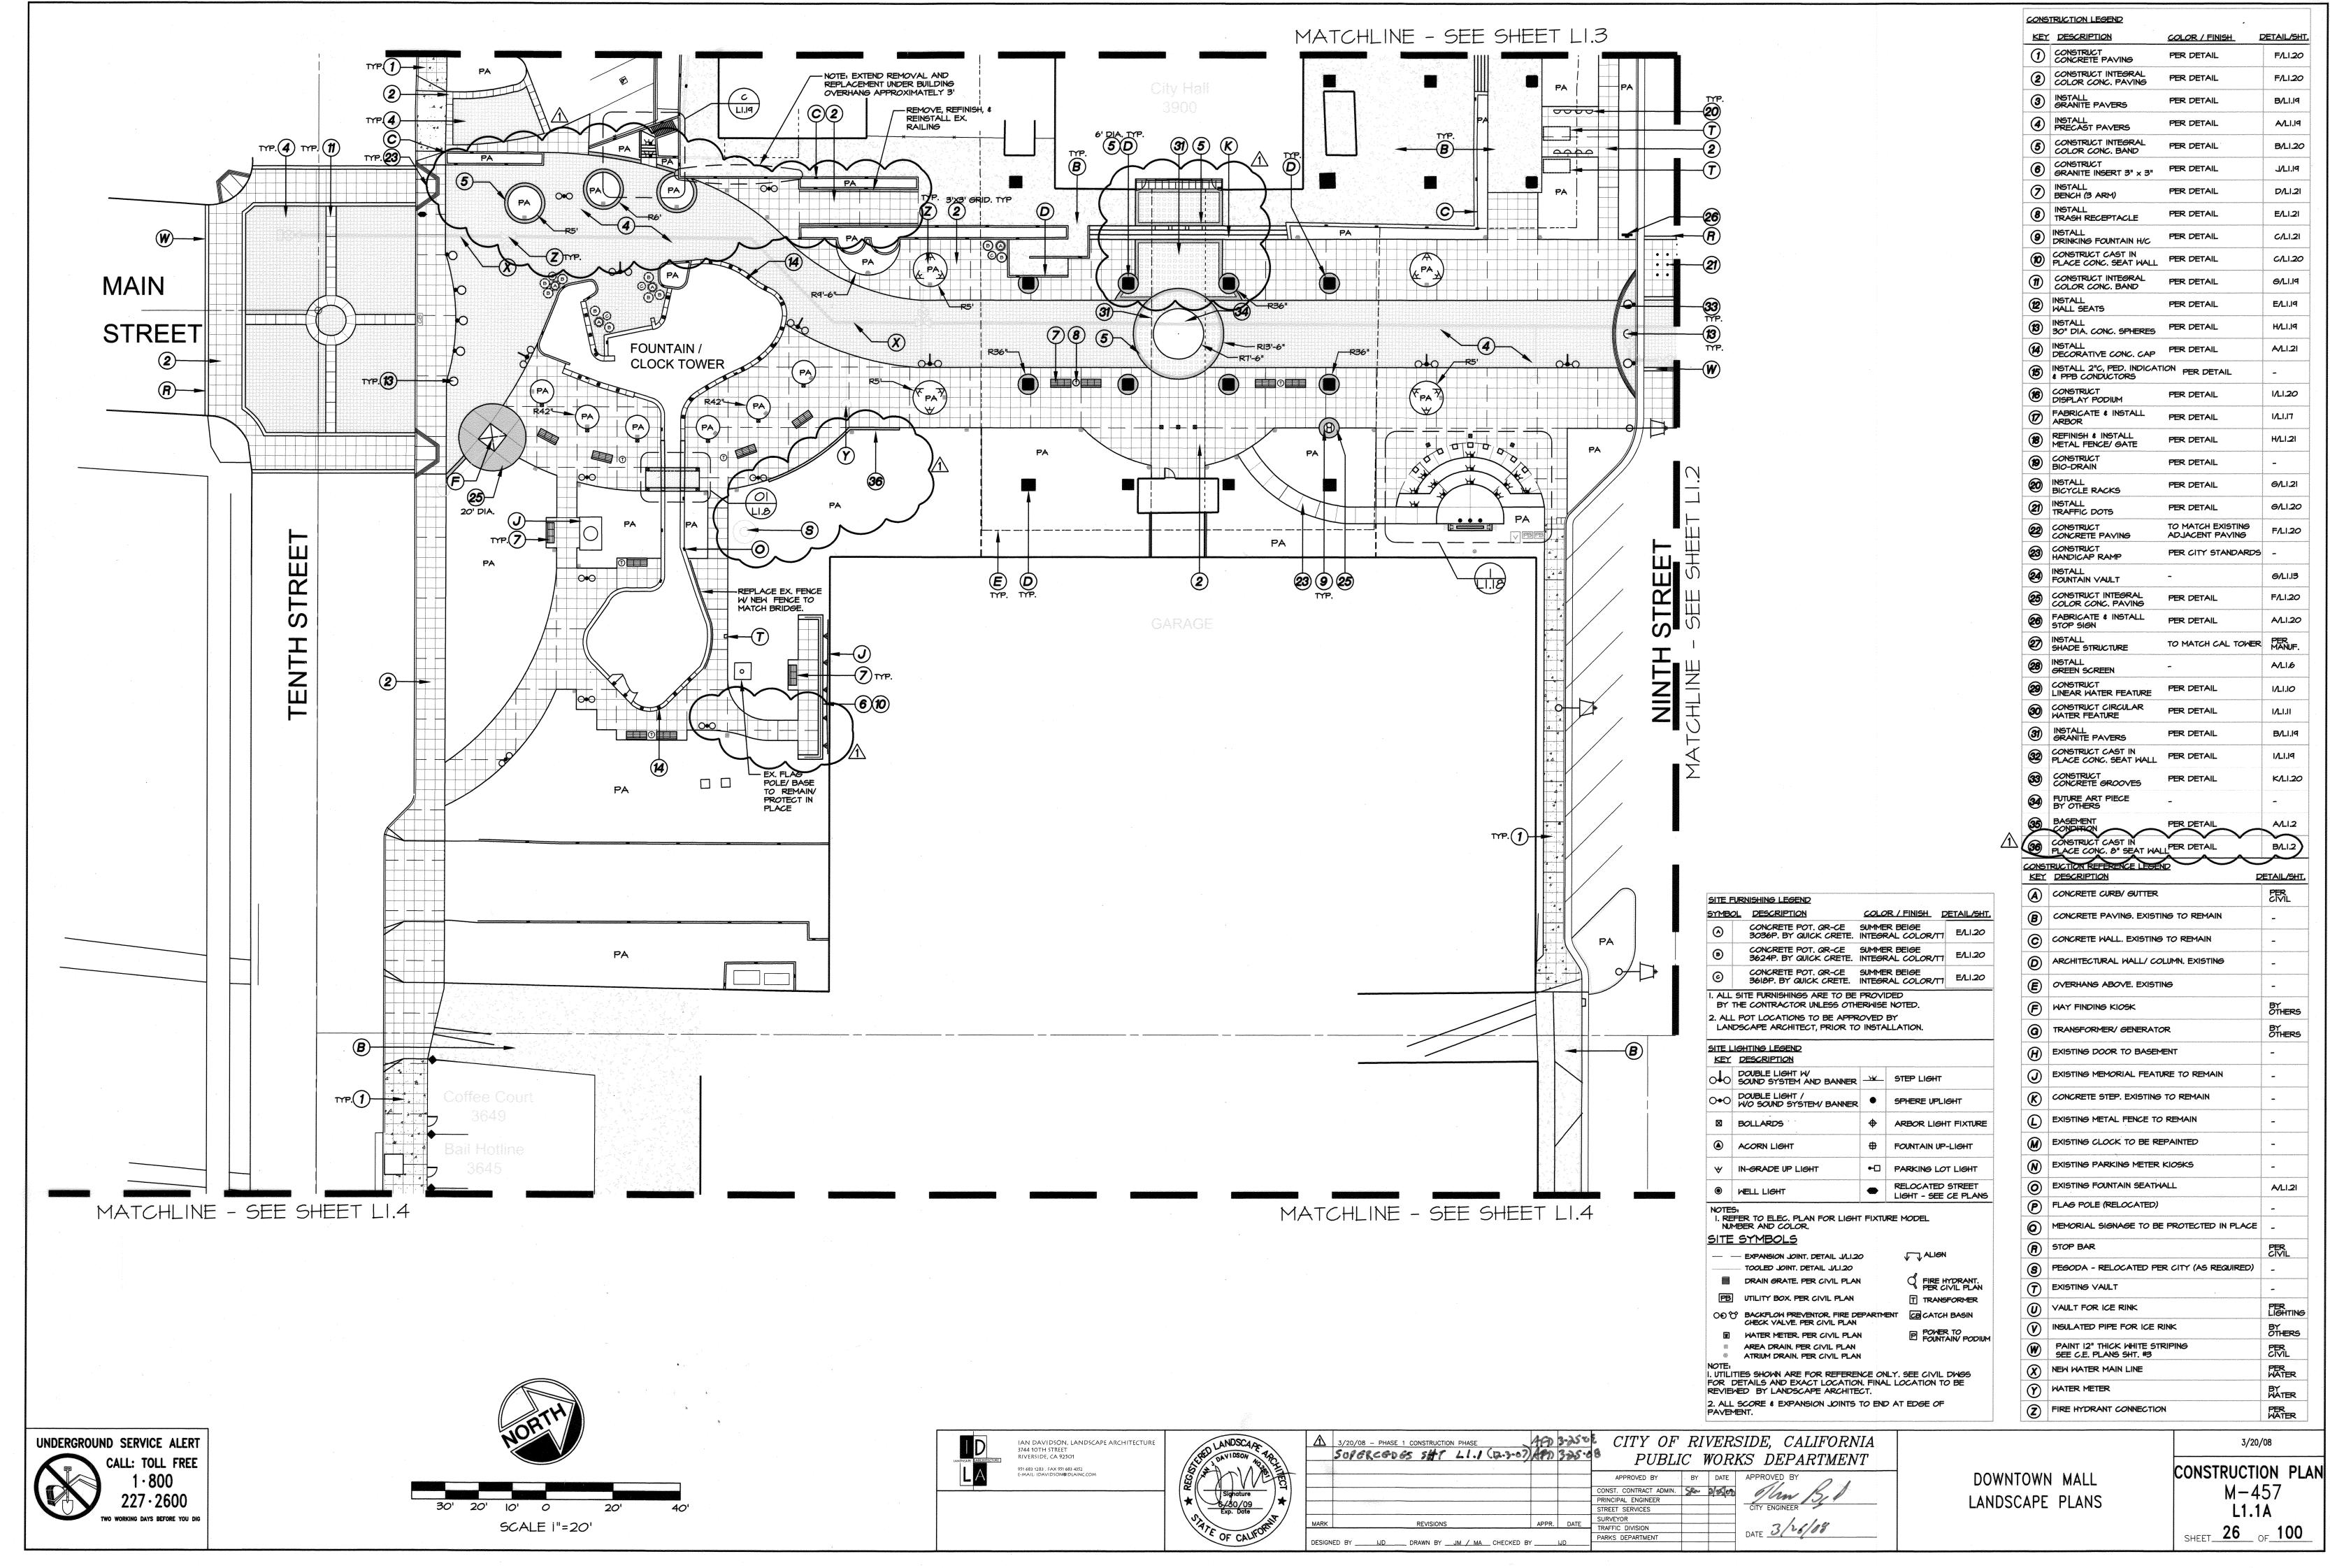


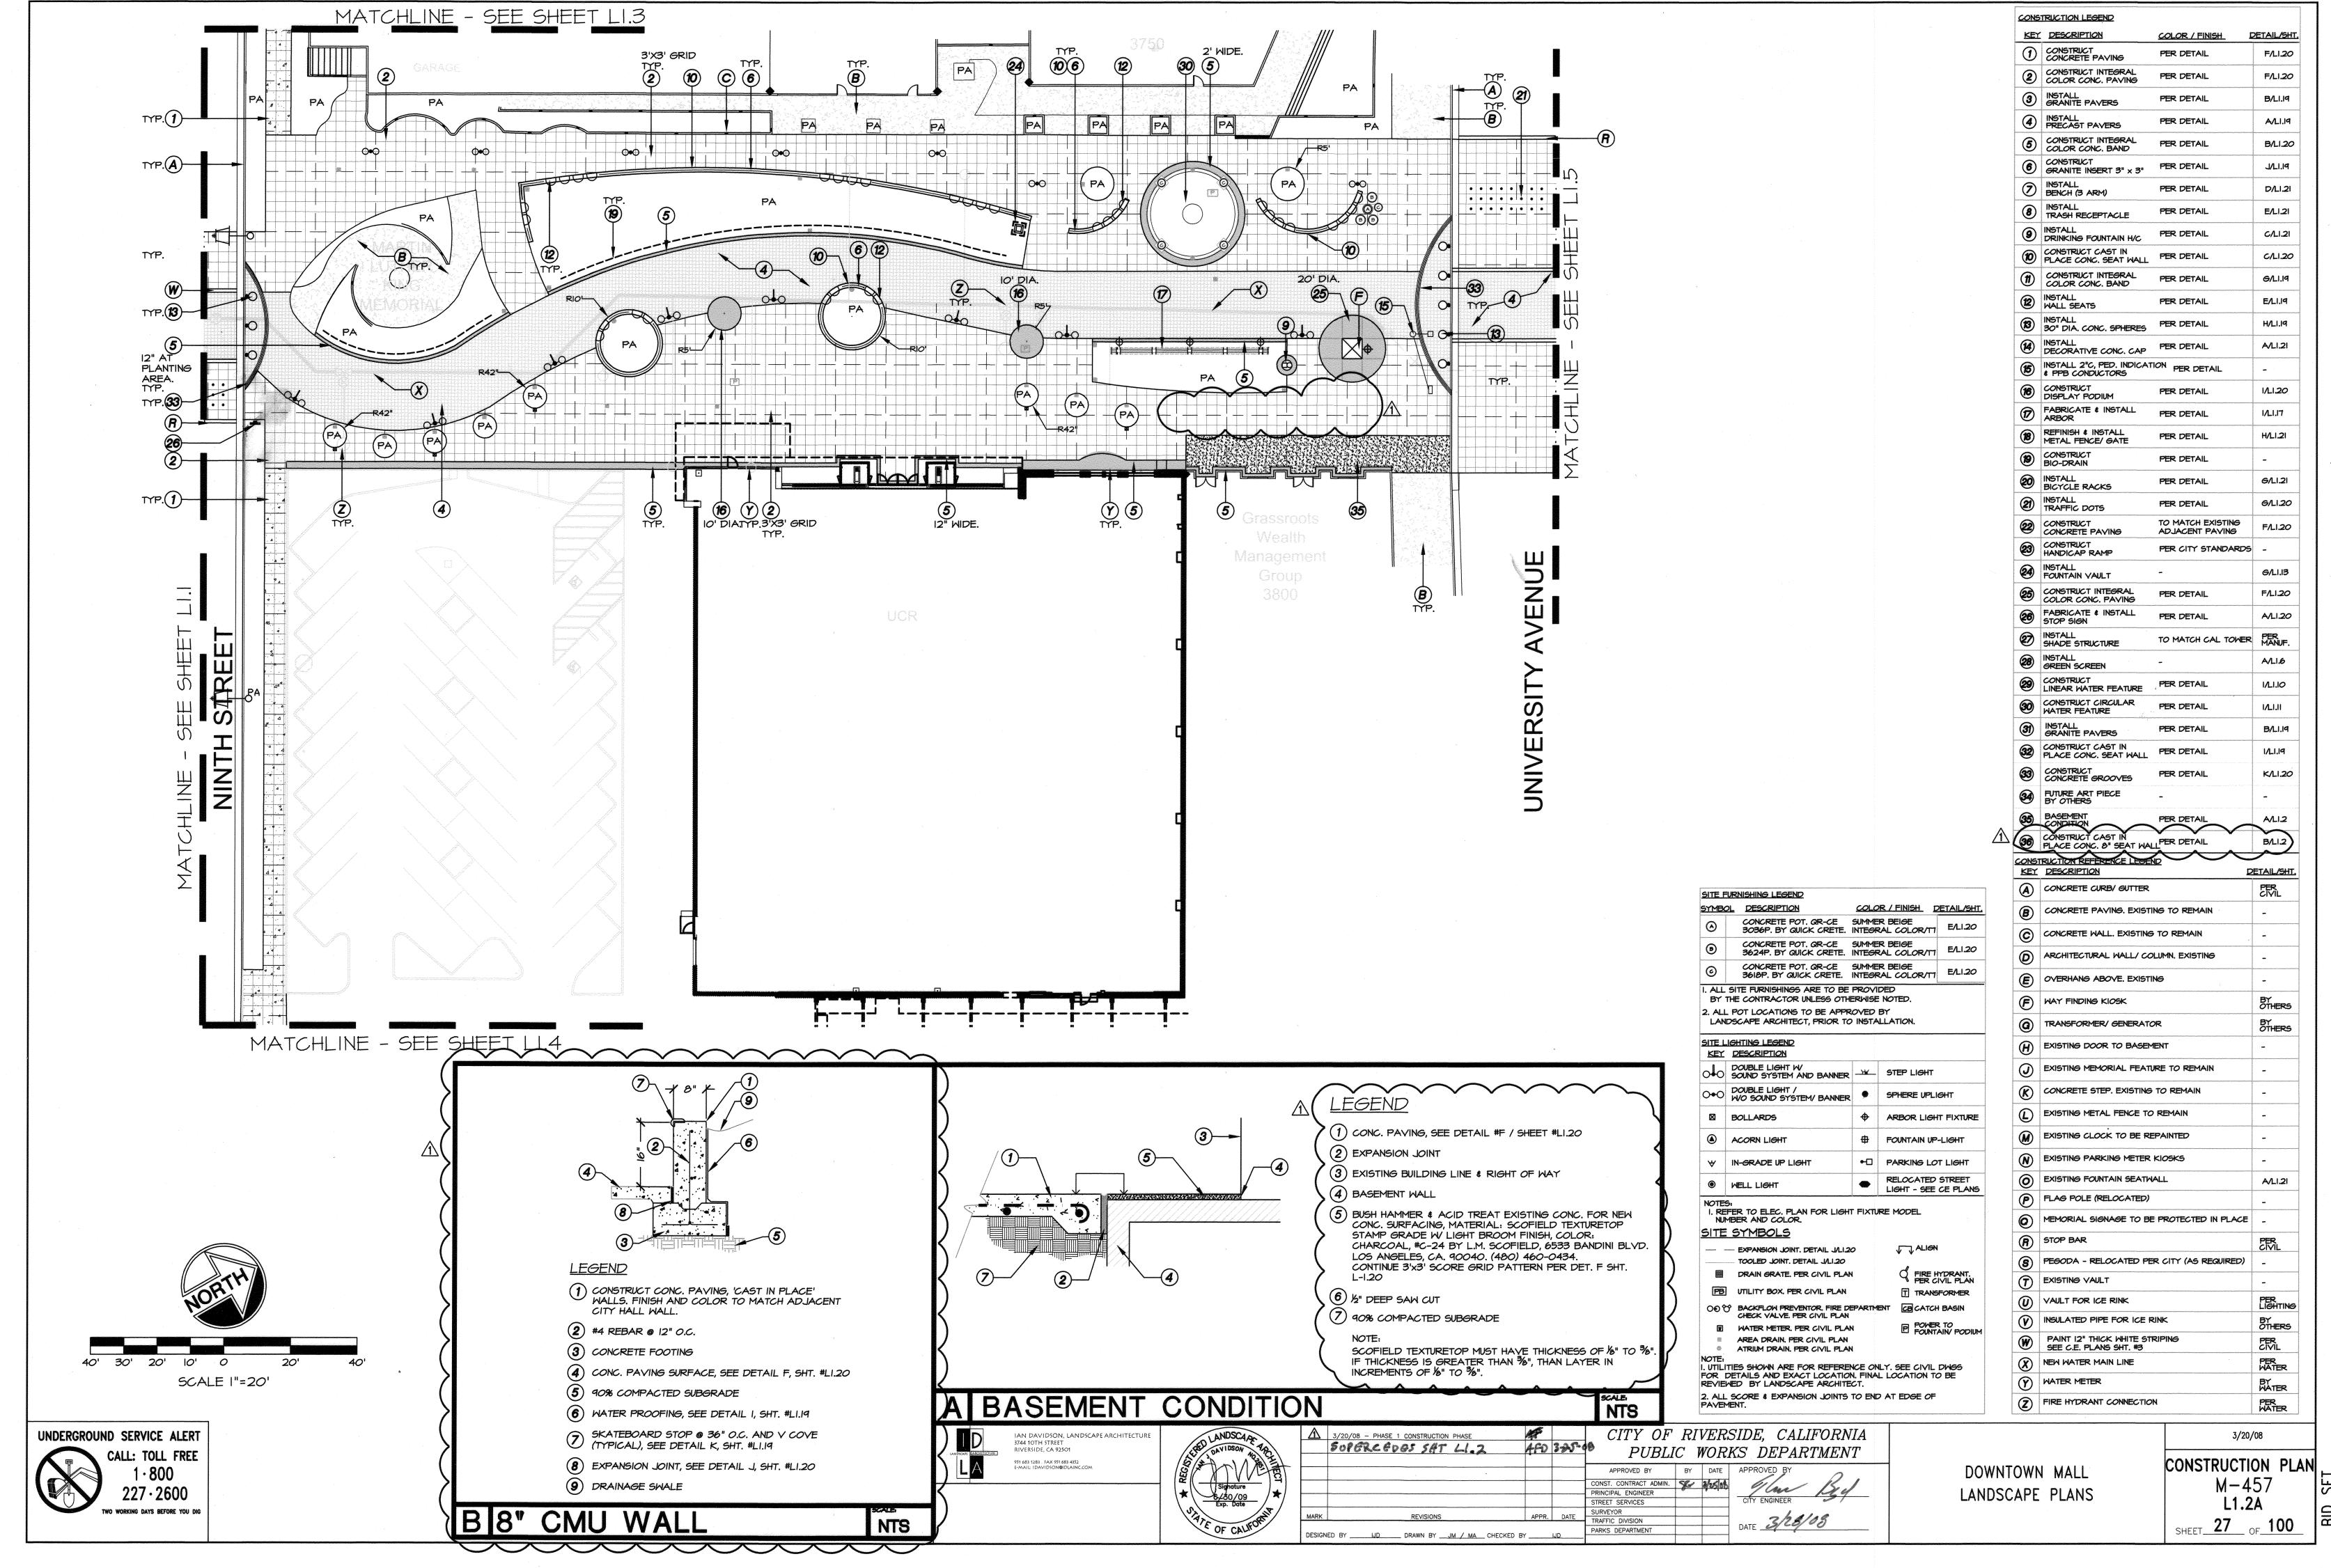

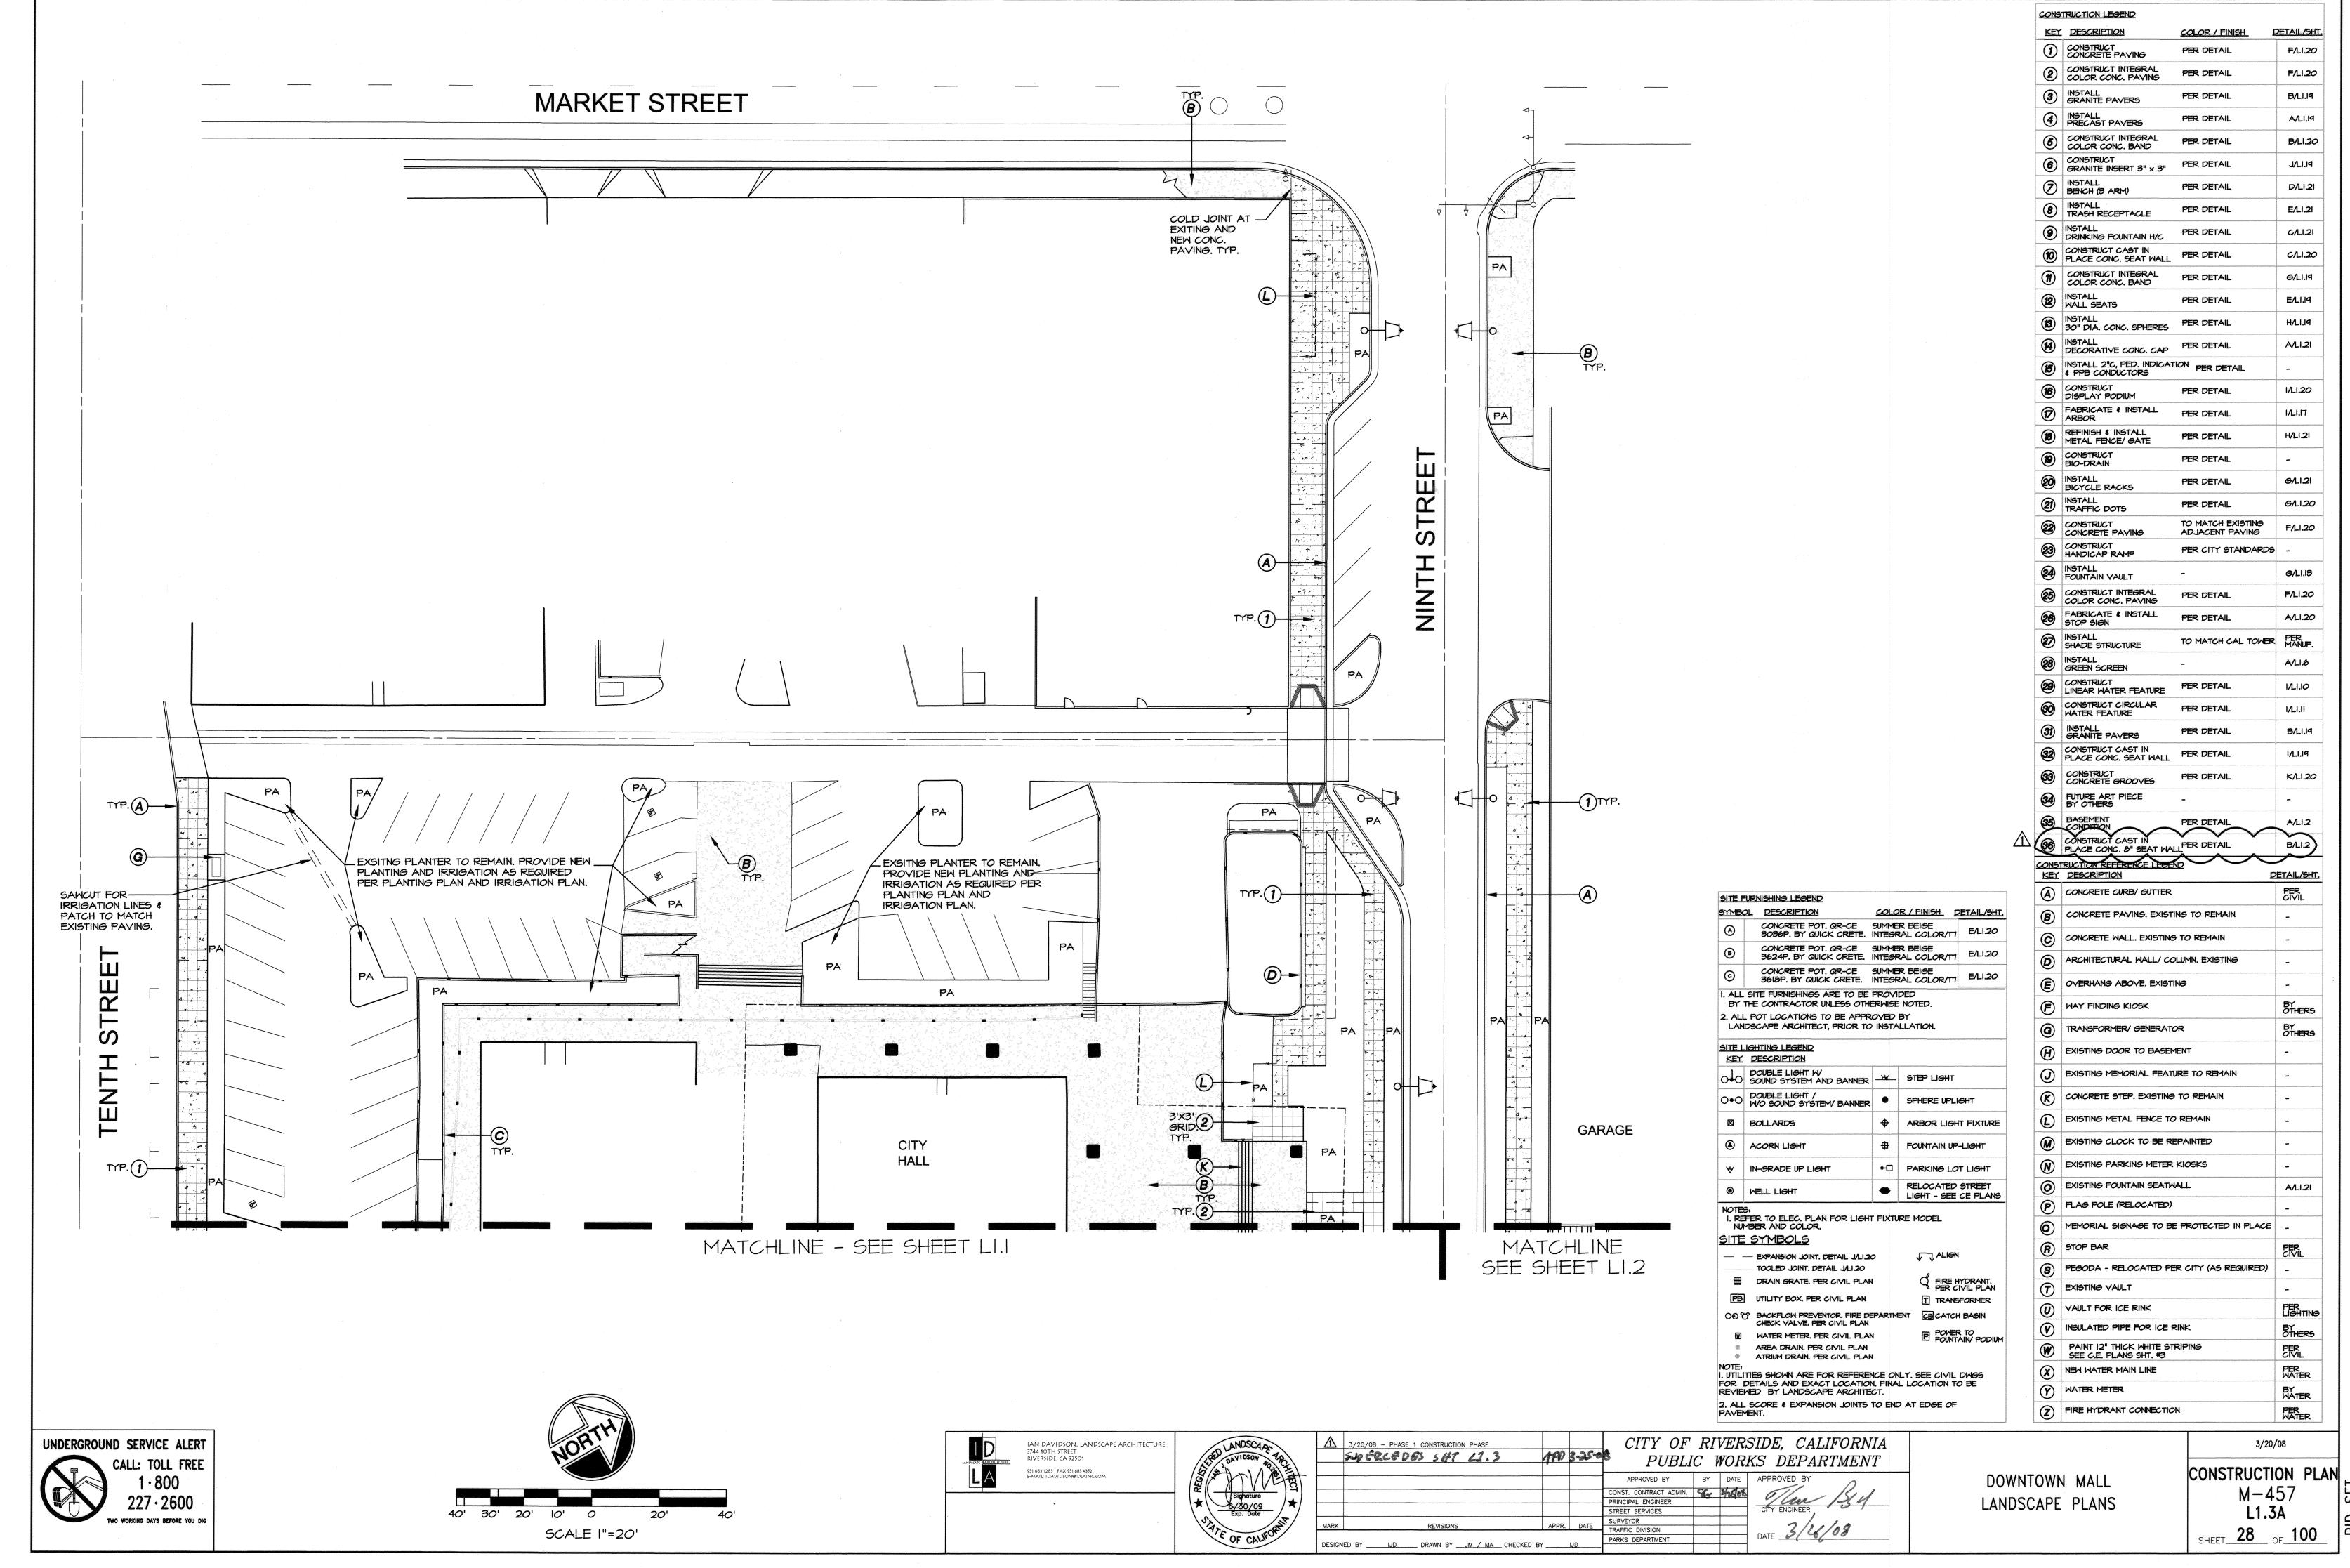


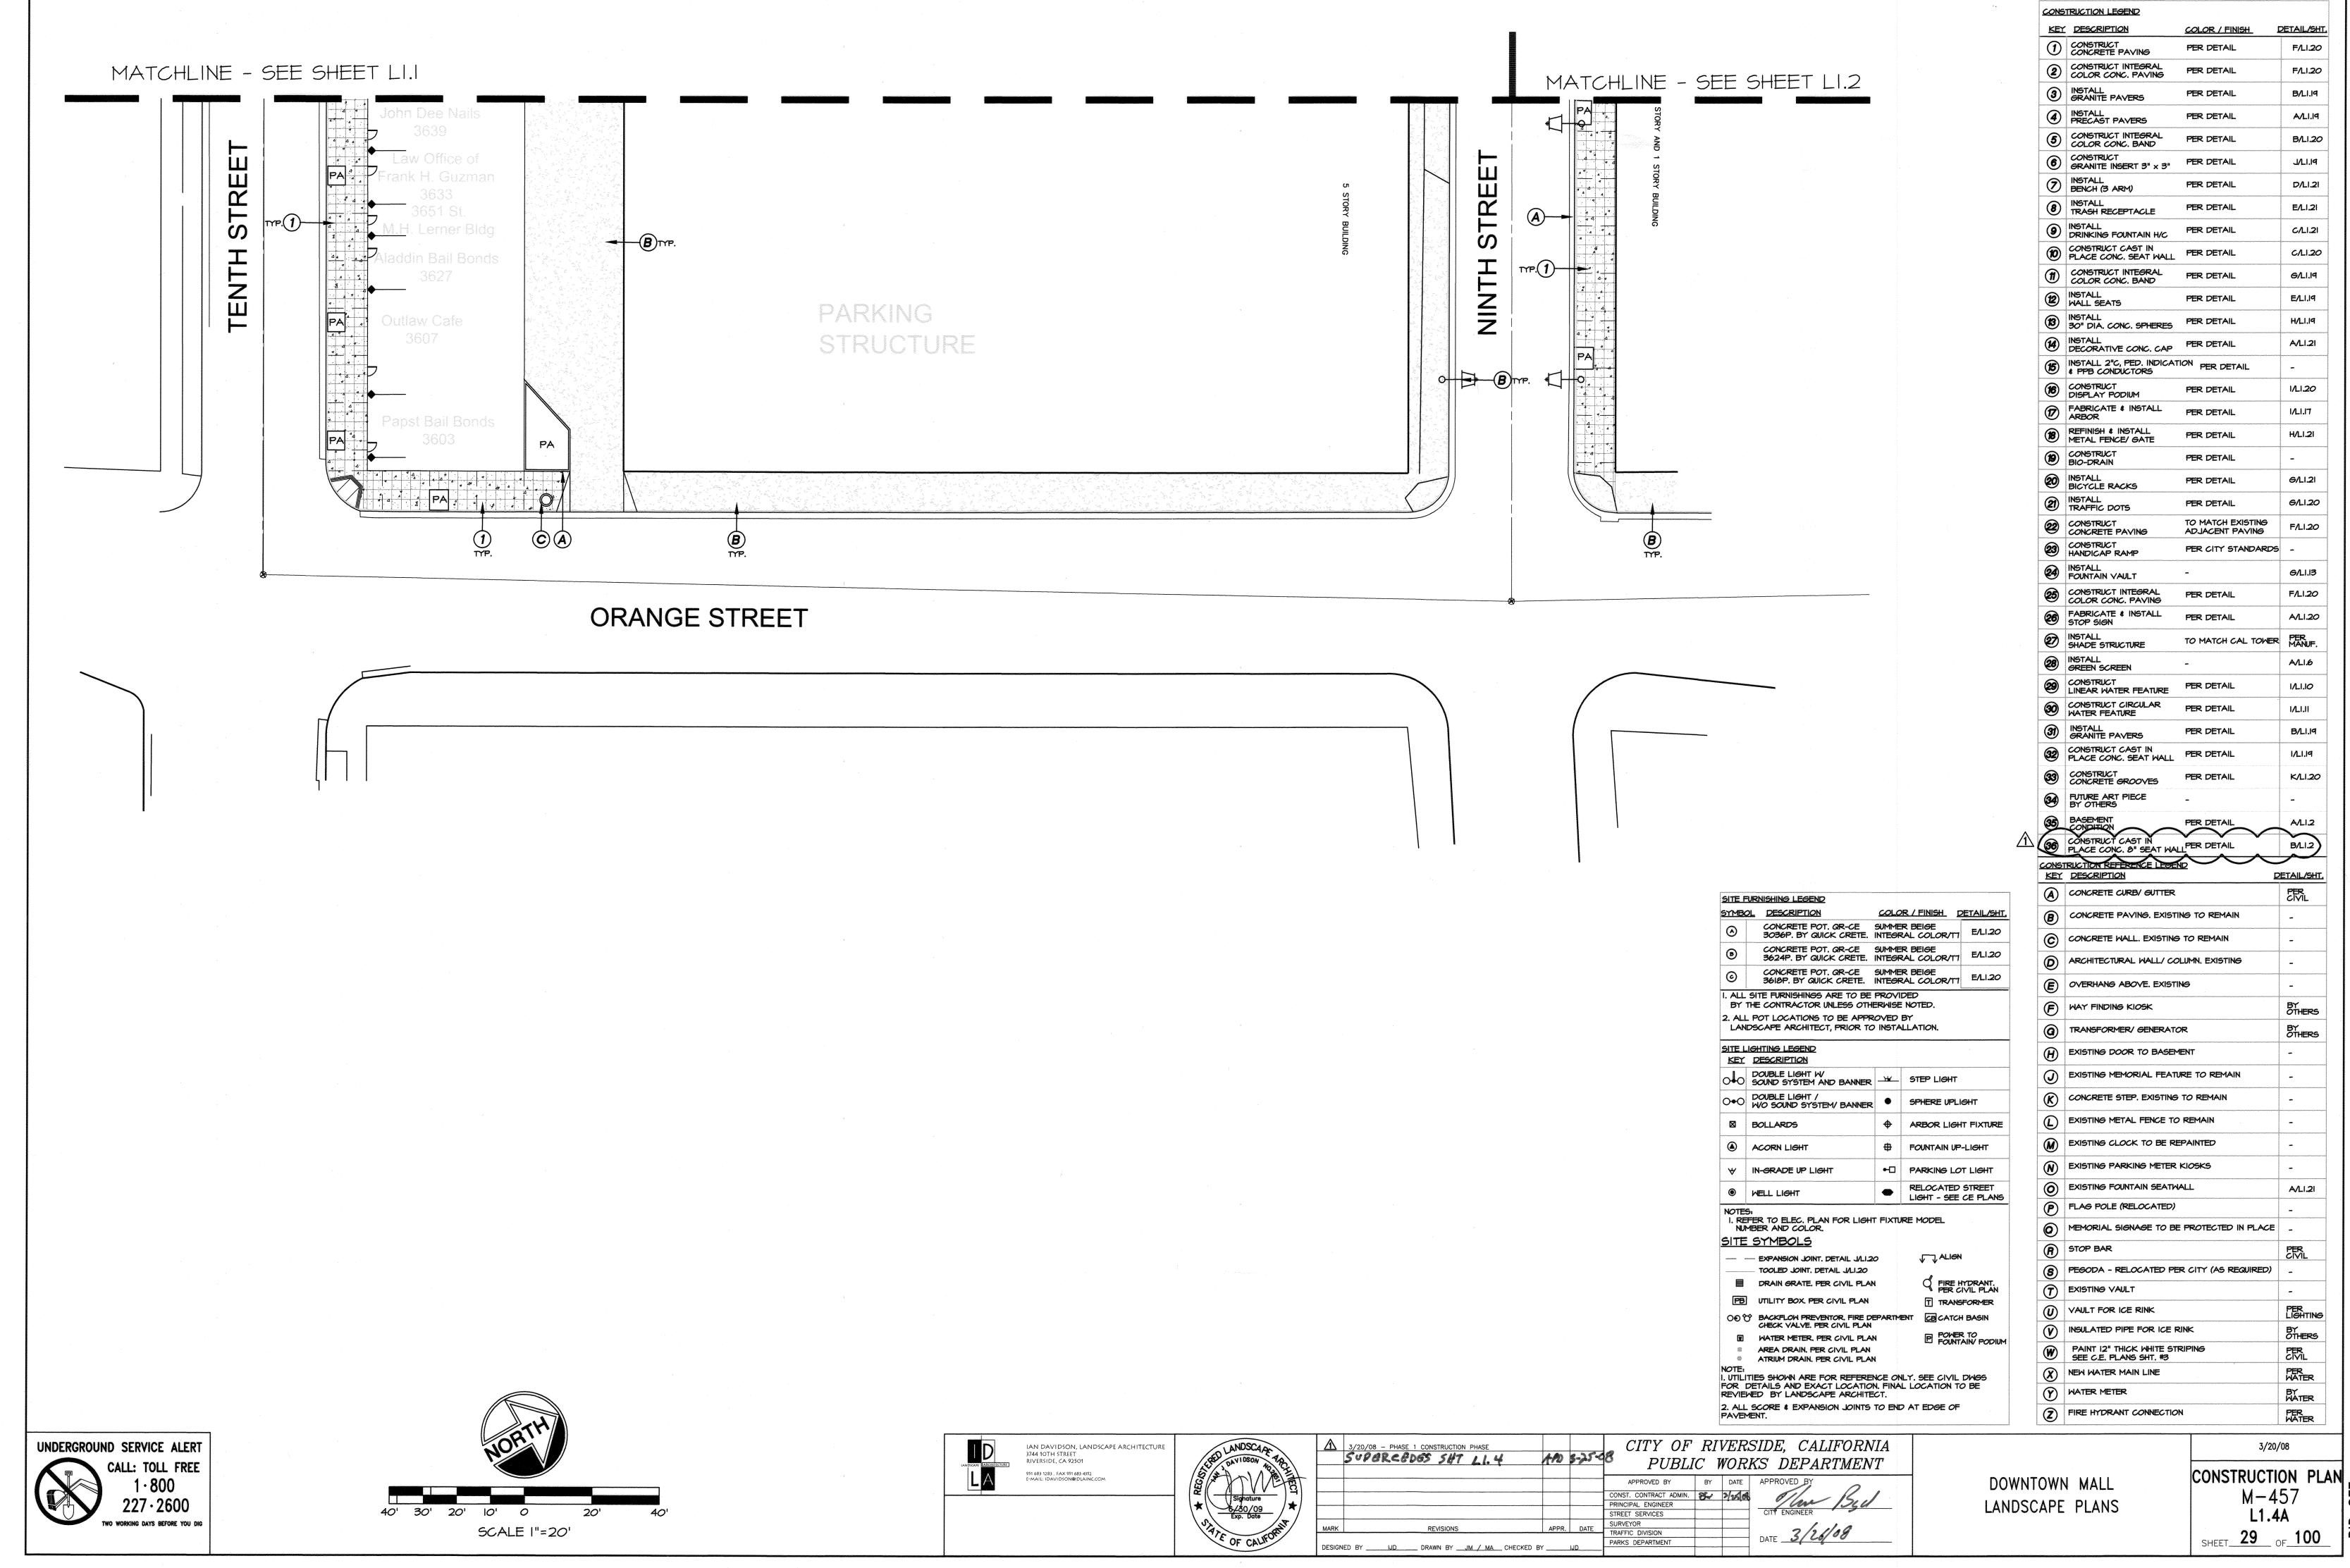

BID SET

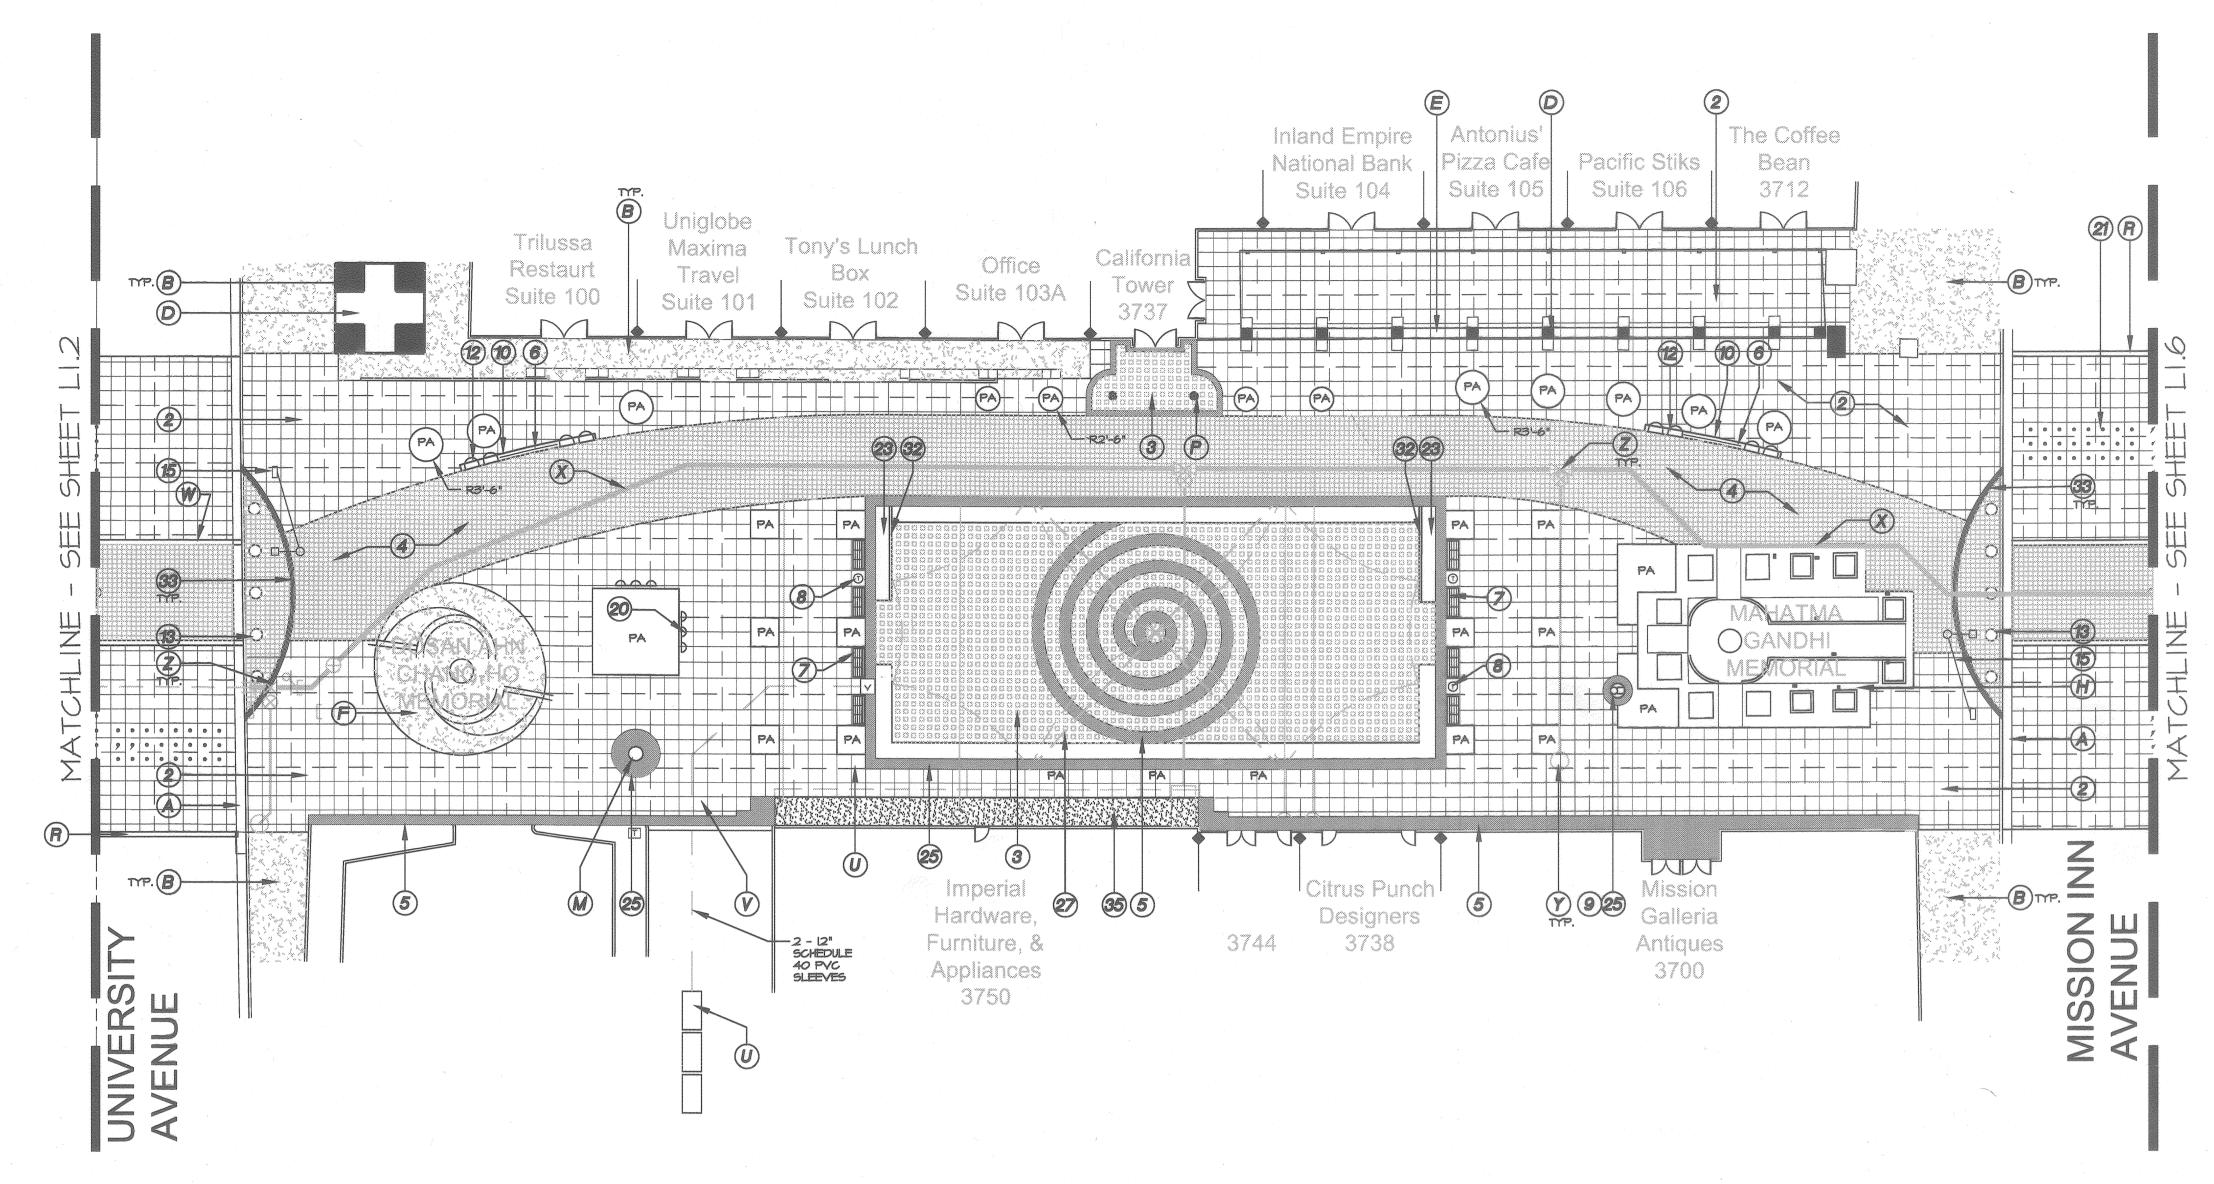

NOTE: CONTRACTOR TO COORDINATE TENSILE SHADE STRUCTURE TO BE INSTALLED BY OTHERS

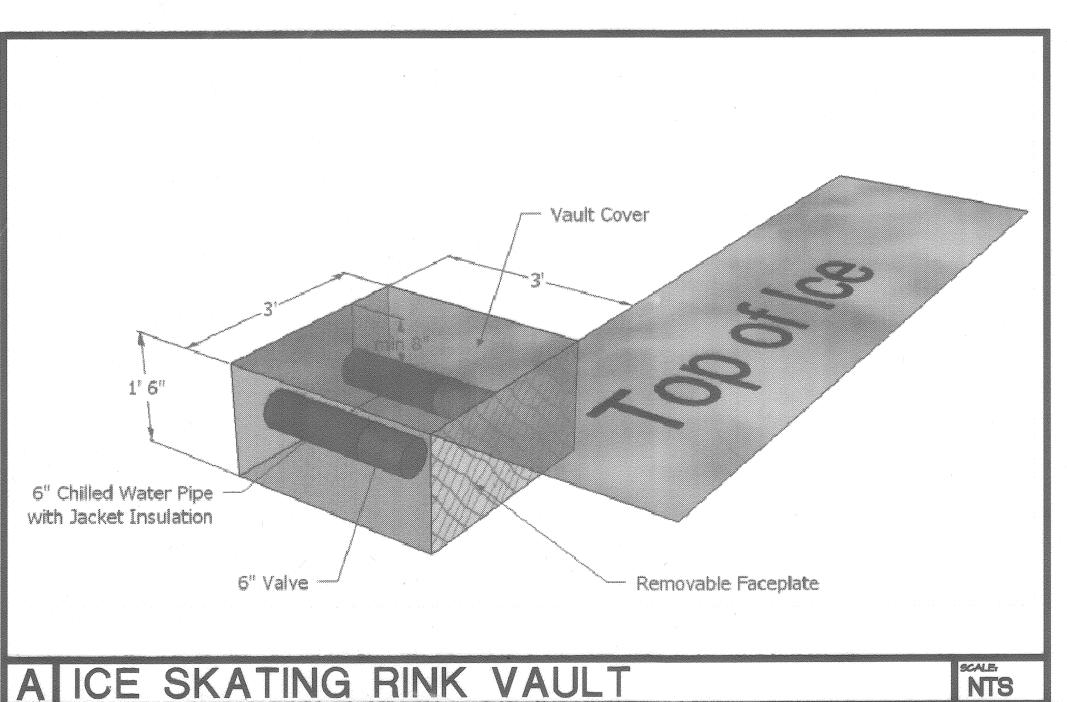


SITE FURNISHING LEGEND SYMBOL DESCRIPTION COLOR / FINISH DETAIL/SHT. CONCRETE POT. GR-CE SUMMER BEIGE 3036P. BY QUICK CRETE. INTEGRAL COLOR/TI CONCRETE POT. OR-CE SUMMER BEIGE 3624P. BY QUICK CRETE. INTEGRAL COLOR/TI E/LI.20 CONCRETE POT. QR-CE SUMMER BEIGE 3618P. BY QUICK CRETE. INTEGRAL COLOR/TT I. ALL SITE FURNISHINGS ARE TO BE PROVIDED BY THE CONTRACTOR UNLESS OTHERWISE NOTED. 2. ALL POT LOCATIONS TO BE APPROVED BY LANDSCAPE ARCHITECT, PRIOR TO INSTALLATION. SITE LIGHTING LEGEND KEY DESCRIPTION OOO SOUND SYSTEM AND BANNER YE STEP LIGHT DOUBLE LIGHT / WO SOUND SYSTEM/ BANNER SPHERE UPLIGHT ARBOR LIGHT FIXTURE BOLLARDS ACORN LIGHT 由 FOUNTAIN UP-LIGHT •- PARKING LOT LIGHT IN-GRADE UP LIGHT RELOCATED STREET LIGHT - SEE CE PLANS MELL LIGHT I. REFER TO ELEC. PLAN FOR LIGHT FIXTURE MODEL NUMBER AND COLOR. SITE SYMBOLS AT ALIGN - EXPANSION JOINT, DETAIL J/LI.20 ___ TOOLED JOINT, DETAIL JALI 20 DRAIN ORATE. PER CIVIL PLAN PB UTILITY BOX. PER CIVIL PLAN T TRANSFORMER 00 TO BACKFLOW PREVENTOR, FIRE DEPARTMENT CE CATCH BASIN CHECK VALVE, PER CIVIL PLAN WATER METER, PER CIVIL PLAN S AREA DRAIN, PER CIVIL PLAN ATRIUM DRAIN, PER CIVIL PLAN I. UTILITIES SHOWN ARE FOR REFERENCE ONLY. SEE CIVIL DWGS FOR DETAILS AND EXACT LOCATION, FINAL LOCATION TO BE

REVIEWED BY LANDSCAPE ARCHITECT.


2. ALL SCORE & EXPANSION JOINTS TO END AT EDGE OF



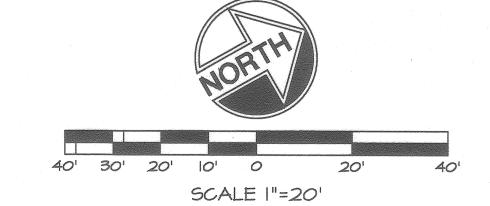





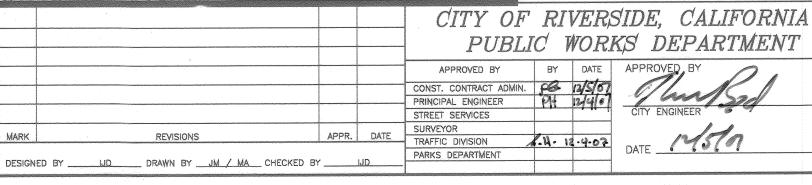

DOWNTOWN MALL LANDSCAPE PLANS

CONSTRUCTION LEGEND

KEY DESCRIPTION

O CONSTRUCT CONCRETE PAVING

3 INSTALL GRANITE PAVERS

INSTALL PRECAST PAVERS

(3 ARM)

8 INSTALL TRASH RECEPTACLE

(9) INSTALL DRINKING FOUNTAIN H/C

COLOR CONC. BAND

INSTALL 30" DIA. CONC. SPHERES

(2) INSTALL WALL SEATS

6 CONSTRUCT DISPLAY PODIUM

FABRICATE & INSTALL

REFINISH & INSTALL METAL FENCE/ GATE

MINSTALL BICYCLE RACKS

2 INSTALL TRAFFIC DOTS

2 CONSTRUCT CONCRETE PAVING

CONSTRUCT HANDICAP RAMP

MINSTALL FOUNTAIN VAULT

CONSTRUCT INTEGRAL COLOR CONC. PAVING

FABRICATE & INSTALL STOP SIGN

CONSTRUCT
LINEAR WATER FEATURE

GONSTRUCT CIRCULAR WATER FEATURE

CONSTRUCT CAST IN PLACE CONC. SEAT WALL

CONSTRUCTION REFERENCE LEGEND

(B) | CONCRETE PAVING. EXISTING TO REMAIN

ARCHITECTURAL WALL/ COLUMN, EXISTING

EXISTING MEMORIAL FEATURE TO REMAIN

CONCRETE STEP. EXISTING TO REMAIN

EXISTING METAL FENCE TO REMAIN

EXISTING CLOCK TO BE REPAINTED

(N) EXISTING PARKING METER KIOSKS

MEMORIAL SIGNAGE TO BE PROTECTED IN PLACE

(S) PEGODA - RELOCATED PER CITY (AS REQUIRED)

EXISTING FOUNTAIN SEATWALL

(P) FLAG POLE (RELOCATED)

(7) EXISTING VAULT

(II) VAULT FOR ICE RINK

NEW WATER MAIN LINE

(Y) WATER METER

(V) INSULATED PIPE FOR ICE RINK

SEE C.E. PLANS SHT. #3

Z FIRE HYDRANT CONNECTION

PAINT 12" THICK WHITE STRIPING

CONCRETE WALL. EXISTING TO REMAIN

E OVERHANG ABOVE, EXISTING

(Q) TRANSFORMER/ GENERATOR

(H) EXISTING DOOR TO BASEMENT

F WAY FINDING KIOSK

(A) CONCRETE CURB/ GUTTER

GONSTRUCT CONCRETE GROOVES

FUTURE ART PIECE BY OTHERS

BASEMENT CONDITION

KEY DESCRIPTION

(3) INSTALL GRANITE PAVERS

INSTALL SHADE STRUCTURE

28 INSTALL GREEN SCREEN

CONSTRUCT CAST IN PER DETAIL

INSTALL DECORATIVE CONG. CAP PER DETAIL

1 INSTALL 2"C, PED. INDICATION PER DETAIL PPB CONDUCTORS

(5) CONSTRUCT INTEGRAL COLOR CONC. BAND

6 CONSTRUCT GRANITE INSERT 3" x 3"

2 CONSTRUCT INTEGRAL COLOR CONC. PAVING

COLOR / FINISH

PER DETAIL

TO MATCH EXISTING

PER CITY STANDARDS

TO MATCH CAL TOWER MANUF.

AD JACENT PAYING

DETAIL/SHT.

F/LI.20

F/LI.20

B/L1.19

A/L1.19

B/LI20

J/L1.19

D/LI.21

E/LI.21

C/LI21

C/L1.20

G/L1.19

E/LI.19

H/LI.19

A/LI2I

I/L1.20

1/1.17

H/L121

G/L1.21

6/LI.20

F/LI.20

6/L1.13

F/LI.20

A/LI.20

A/LI6

1/1.10

1/1.11

B/L1.19

1/1.19

K/L120

A/LI2

DETAIL/SHT.

OTHERS

OTHERS

A/LI2I

PERLICHTING

BY OTHERS

PER WATER


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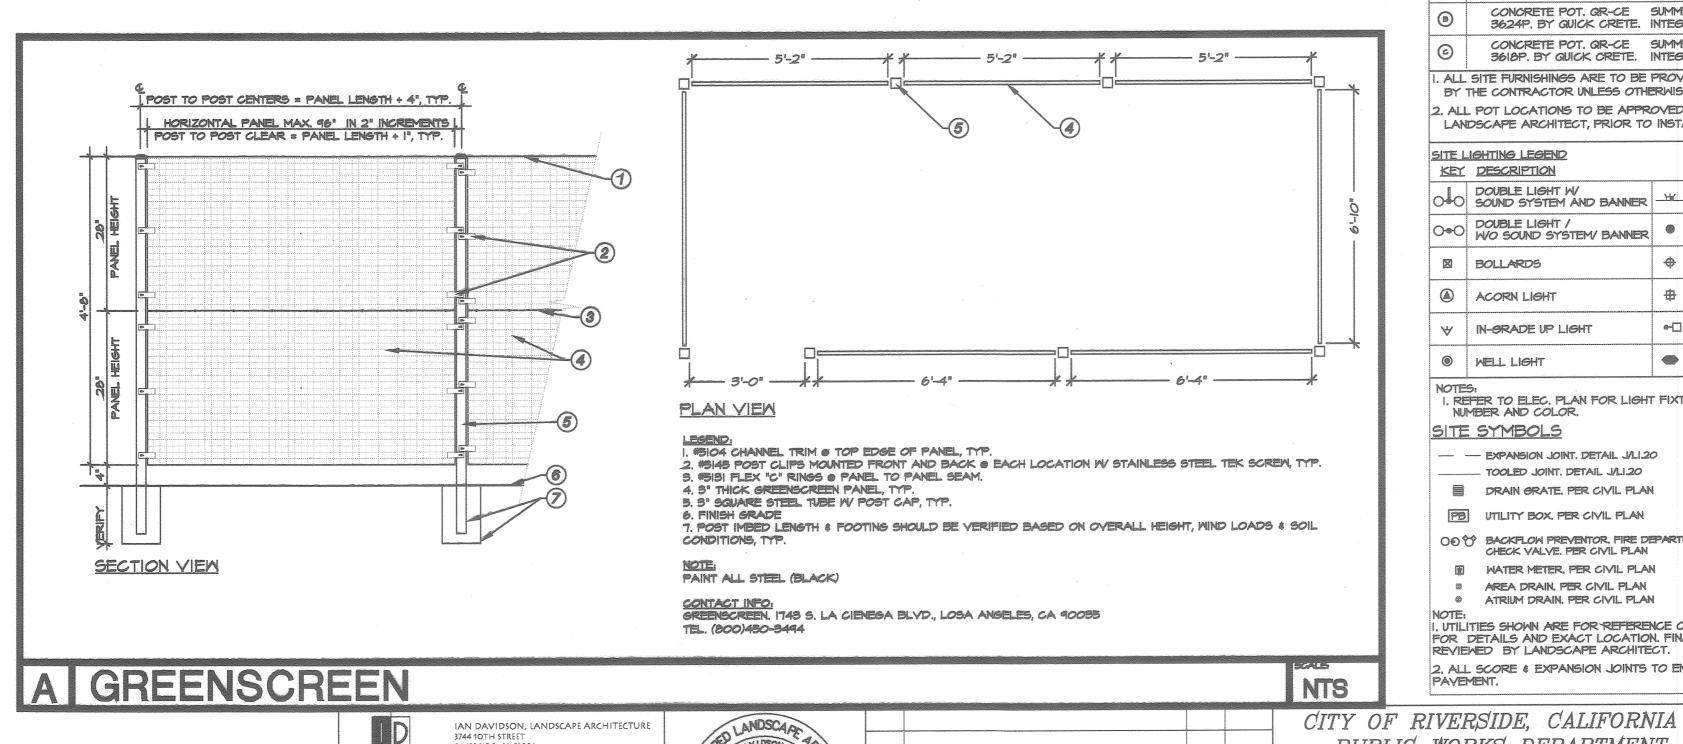
12/03/07

CONSTRUCTION PLAN
M-457
L1.5

SHEET 30 OF 100


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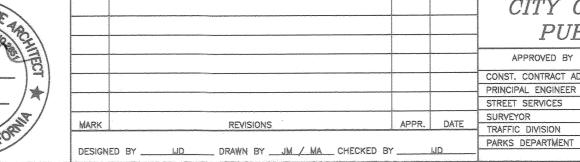
FUTURE ART PIECE BY DIHERS BASEMENT CONDITION CONSTRUCTION REFERENCE LEGEND KEY DESCRIPTION (A) CONCRETE CURB/ GUTTER SITE FURNISHING LEGEND B CONCRETE PAVING, EXISTING TO REMAIN COLOR / FINISH DETAIL/SHT. SYMBOL DESCRIPTION CONCRETE POT. GR-CE SUMMER BEIGE 3036P. BY QUICK CRETE. INTEGRAL COLOR/TI CONCRETE WALL. EXISTING TO REMAIN CONCRETE POT. GR-CE SUMMER BEIGE 3624P. BY QUICK CRETE. INTEGRAL COLOR/TI (6) ARCHITECTURAL WALL/ COLUMN. EXISTING CONCRETE POT. QR-CE SUMMER BEIGE 3618P. BY QUICK CRETE. INTEGRAL COLOR/TI (E) OVERHANG ABOVE. EXISTING . ALL SITE FURNISHINGS ARE TO BE PROVIDED (F) WAY FINDING KIOSK BY THE CONTRACTOR UNLESS OTHERWISE NOTED. 2. ALL POT LOCATIONS TO BE APPROVED BY (G) TRANSFORMER/ GENERATOR LANDSCAPE ARCHITECT, PRIOR TO INSTALLATION. (H) EXISTING DOOR TO BASEMENT SITE LIGHTING LEGEND KEY DESCRIPTION (J) EXISTING MEMORIAL FEATURE TO REMAIN CONCRETE STEP. EXISTING TO REMAIN OOO DOUBLE LIGHT / WO SOUND SYSTEM/ BANNER SPHERE UPLIGHT EXISTING METAL FENCE TO REMAIN ARBOR LIGHT FIXTURE BOLLARDS EXISTING CLOCK TO BE REPAINTED 串 FOUNTAIN UP-LIGHT ACORN LIGHT (N) EXISTING PARKING METER KIOSKS W IN-GRADE UP LIGHT o-□ PARKING LOT LIGHT (EXISTING FOUNTAIN SEATWALL RELOCATED STREET LIGHT - SEE CE PLANS WELL LIGHT FLAG POLE (RELOCATED) I. REFER TO ELEC. PLAN FOR LIGHT FIXTURE MODEL MEMORIAL SIGNAGE TO BE PROTECTED IN PLACE NUMBER AND COLOR. SITE SYMBOLS (R) STOP BAR T ALIGN - EXPANSION JOINT, DETAIL J/LI.20 8 PEGODA - RELOCATED PER CITY (AS REQUIRED) TOOLED JOINT, DETAIL J/LI.20 DRAIN GRATE, PER CIVIL PLAN (T) EXISTING VAULT PB UTILITY BOX. PER CIVIL PLAN T TRANSFORMER (V) VAULT FOR ICE RINK 00 TO BACKFLOW PREVENTOR FIRE DEPARTMENT CE CATCH BASIN (V) INSULATED PIPE FOR ICE RINK CHECK VALVE, PER CIVIL PLAN POWER TO FOUNTAIN PODIUM WATER METER, PER CIVIL PLAN PAINT I2" THICK WHITE STRIPING SEE C.E. PLANS SHT. #3 B AREA DRAIN, PER CIVIL PLAN ATRIUM DRAIN, PER CIVIL PLAN NEW WATER MAIN LINE I, UTILITIES SHOWN ARE FOR REFERENCE ONLY. SEE CIVIL DWGS FOR DETAILS AND EXACT LOCATION, FINAL LOCATION TO BE (Y) WATER METER REVIEWED BY LANDSCAPE ARCHITECT. 2. ALL SCORE & EXPANSION JOINTS TO END AT EDGE OF (Z) FIRE HYDRANT CONNECTION

UNDERGROUND SERVICE ALERT CALL: TOLL FREE

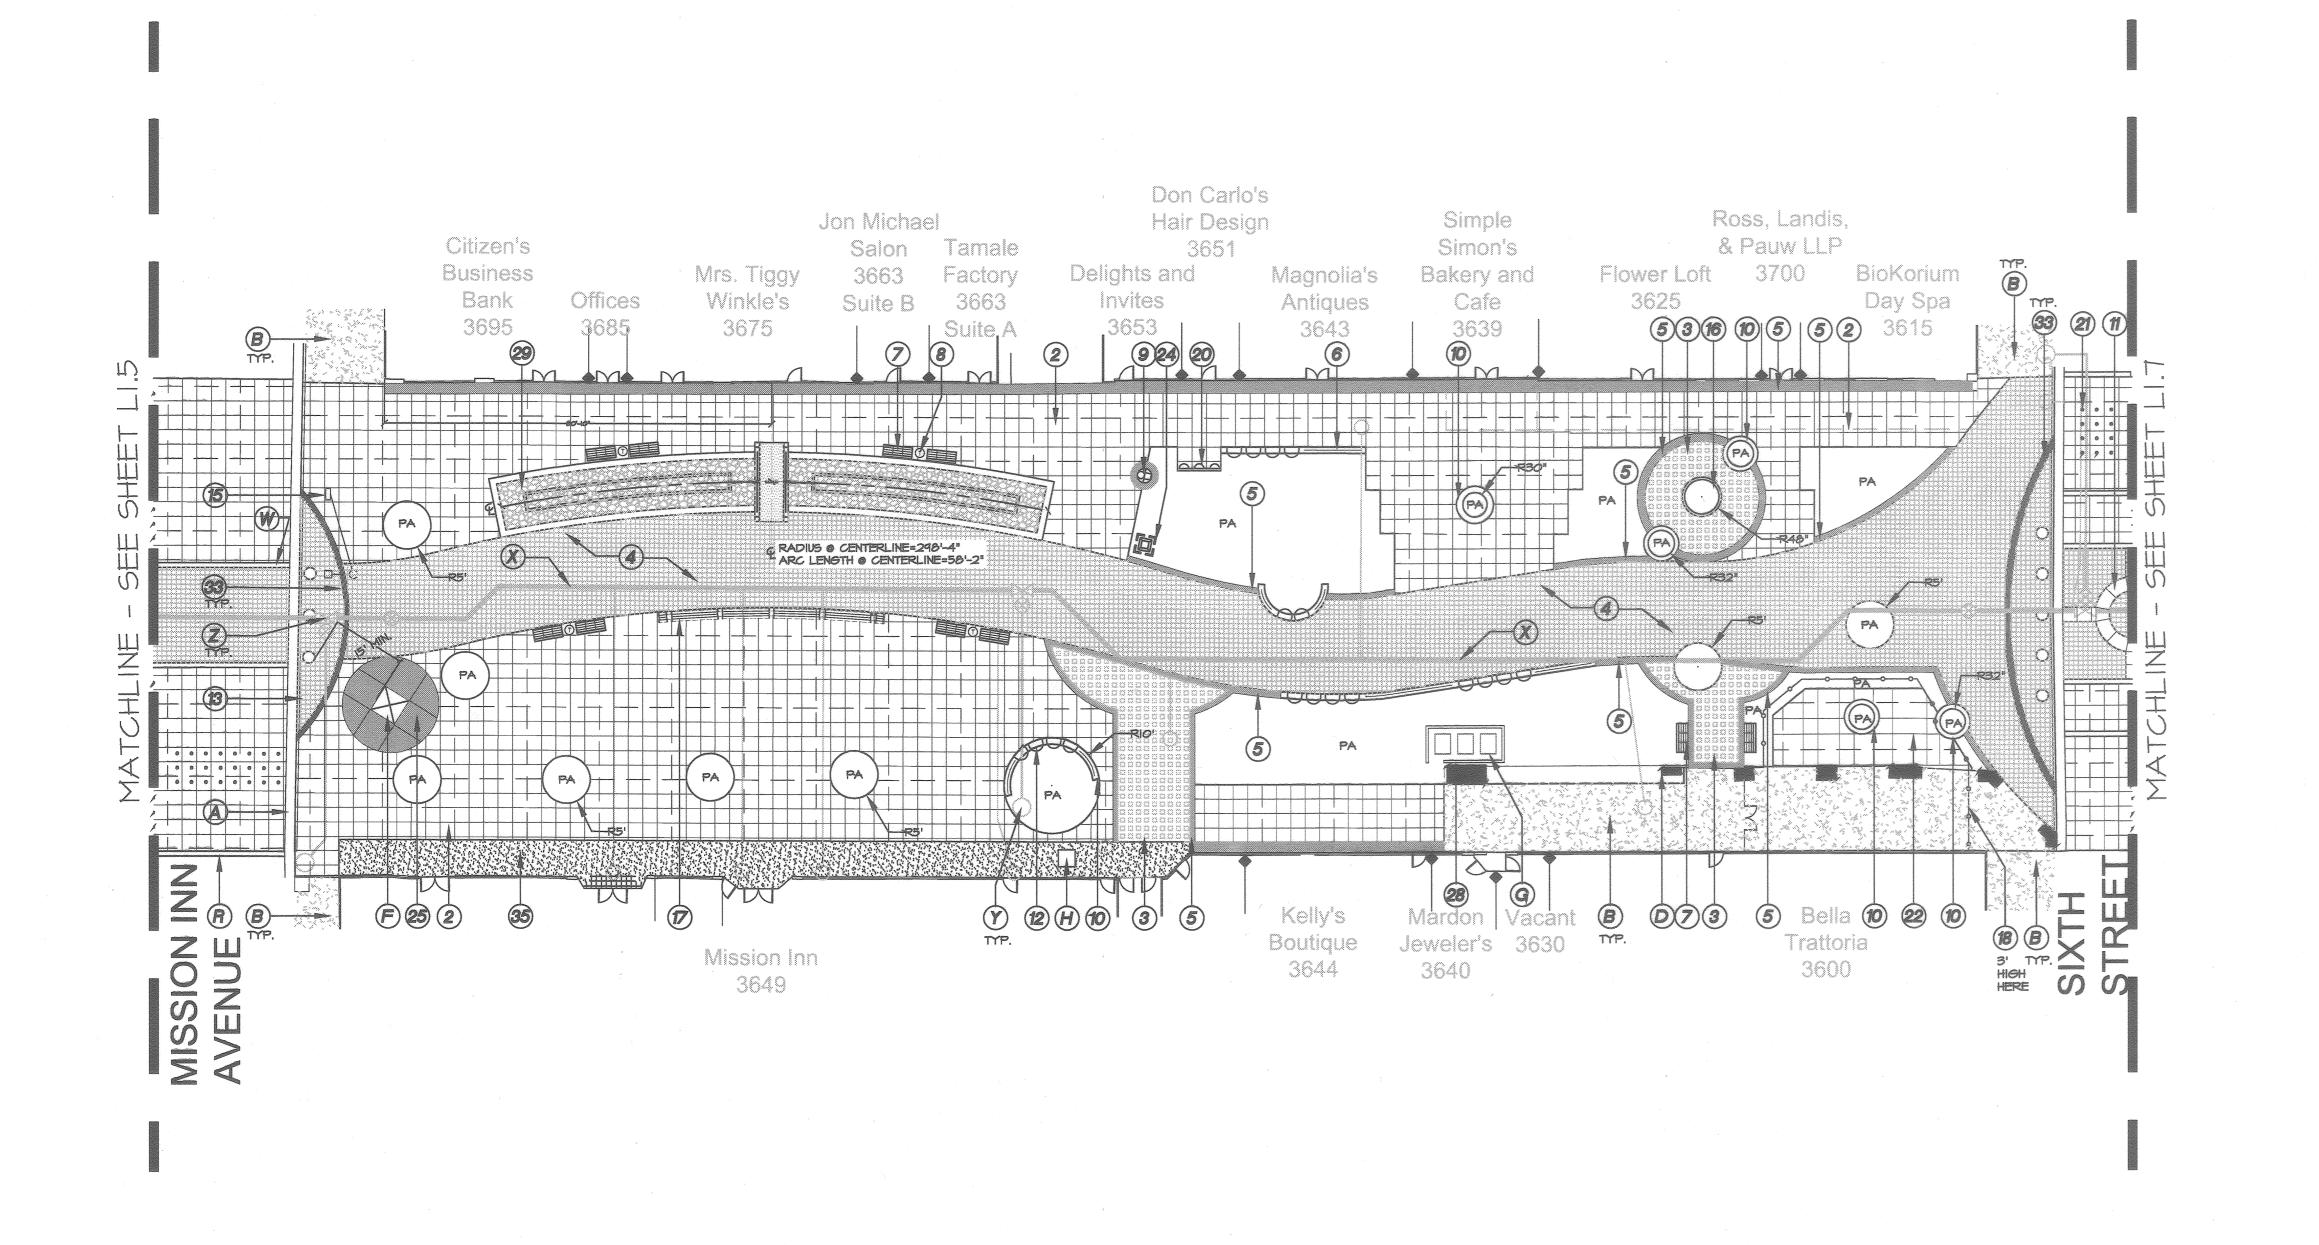





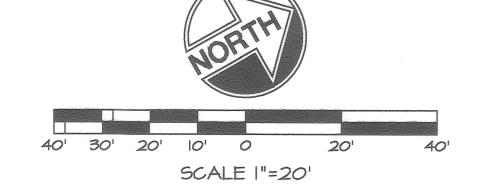

PUBLIC WORKS DEPARTMENT T.H. 12-4-02 DATE 175/01

DOWNTOWN MALL LANDSCAPE PLANS

CONSTRUCTION LEGEND

(1) CONSTRUCT CONCRETE PAVING

3 INSTALL GRANITE PAVERS

INSTALL PRECAST PAVERS

(7) INSTALL BENCH (3 ARM)

(5) CONSTRUCT INTEGRAL COLOR CONC. BAND

6 CONSTRUCT GRANITE INSERT 3" x 3"

INSTALL TRASH RECEPTACLE

9 INSTALL DRINKING FOUNTAIN H/C

O CONSTRUCT CAST IN PLACE CONC. SEAT WALL

INSTALL 30" DIA. CONC. SPHERES PER DETAIL

INSTALL DECORATIVE CONG. CAP PER DETAIL

(5) INSTALL 2"C, PED. INDICATION PER DETAIL

CONSTRUCT INTEGRAL COLOR CONC. BAND

(2) INSTALL WALL SEATS

6 CONSTRUCT DISPLAY PODIUM

FABRICATE & INSTALL ARBOR

REFINISH & INSTALL METAL FENCE/ GATE

6 CONSTRUCT BIO-DRAIN

1 INSTALL BICYCLE RACKS

CONSTRUCT CONCRETE PAVING

CONSTRUCT
HANDICAP RAMP

INSTALL FOUNTAIN VAULT

COLOR CONC. PAVING

FABRICATE & INSTALL STOP SIGN

CONSTRUCT
LINEAR WATER FEATURE

GONSTRUCT CIRCULAR WATER FEATURE

CONSTRUCT CONCRETE GROOVES

CONSTRUCT CAST IN PER DETAIL

(3) INSTALL GRANITE PAVERS

INSTALL SHADE STRUCTURE

INSTALL GREEN SCREEN

COLOR CONC. PAYING

2 CONSTRUCT INTEGRAL COLOR CONC. PAVING

KEY DESCRIPTION

COLOR / FINISH

PER DETAIL

TO MATCH EXISTING

PER CITY STANDARDS

TO MATCH CAL TOWER MANUF.

ADJACENT PAYING

DETAIL/SHT

F/LI.20

F/LI.20

B/L1.19

A/L1.19

B/LI.20

J/LI.19

D/L1.21

E/LI2I

C/L121

C/L1.20

G/L1.19

E/LI.19

H/L1.19

A/LI2I

1/L120

I/LI.IT

H/LI.21

6/LI.2I

6/L1.20

F/LI.20

6/LI.13

F/LI.20

A/L1.20

A/LI6

I/L1.10

1/1.11

B/L1.19

1/1.19

K/LI.20

A/LI2

DETAIL/SHT.

OTHERS

OTHERS

A/LI2I

PERITING

BY OTHERS


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WATER


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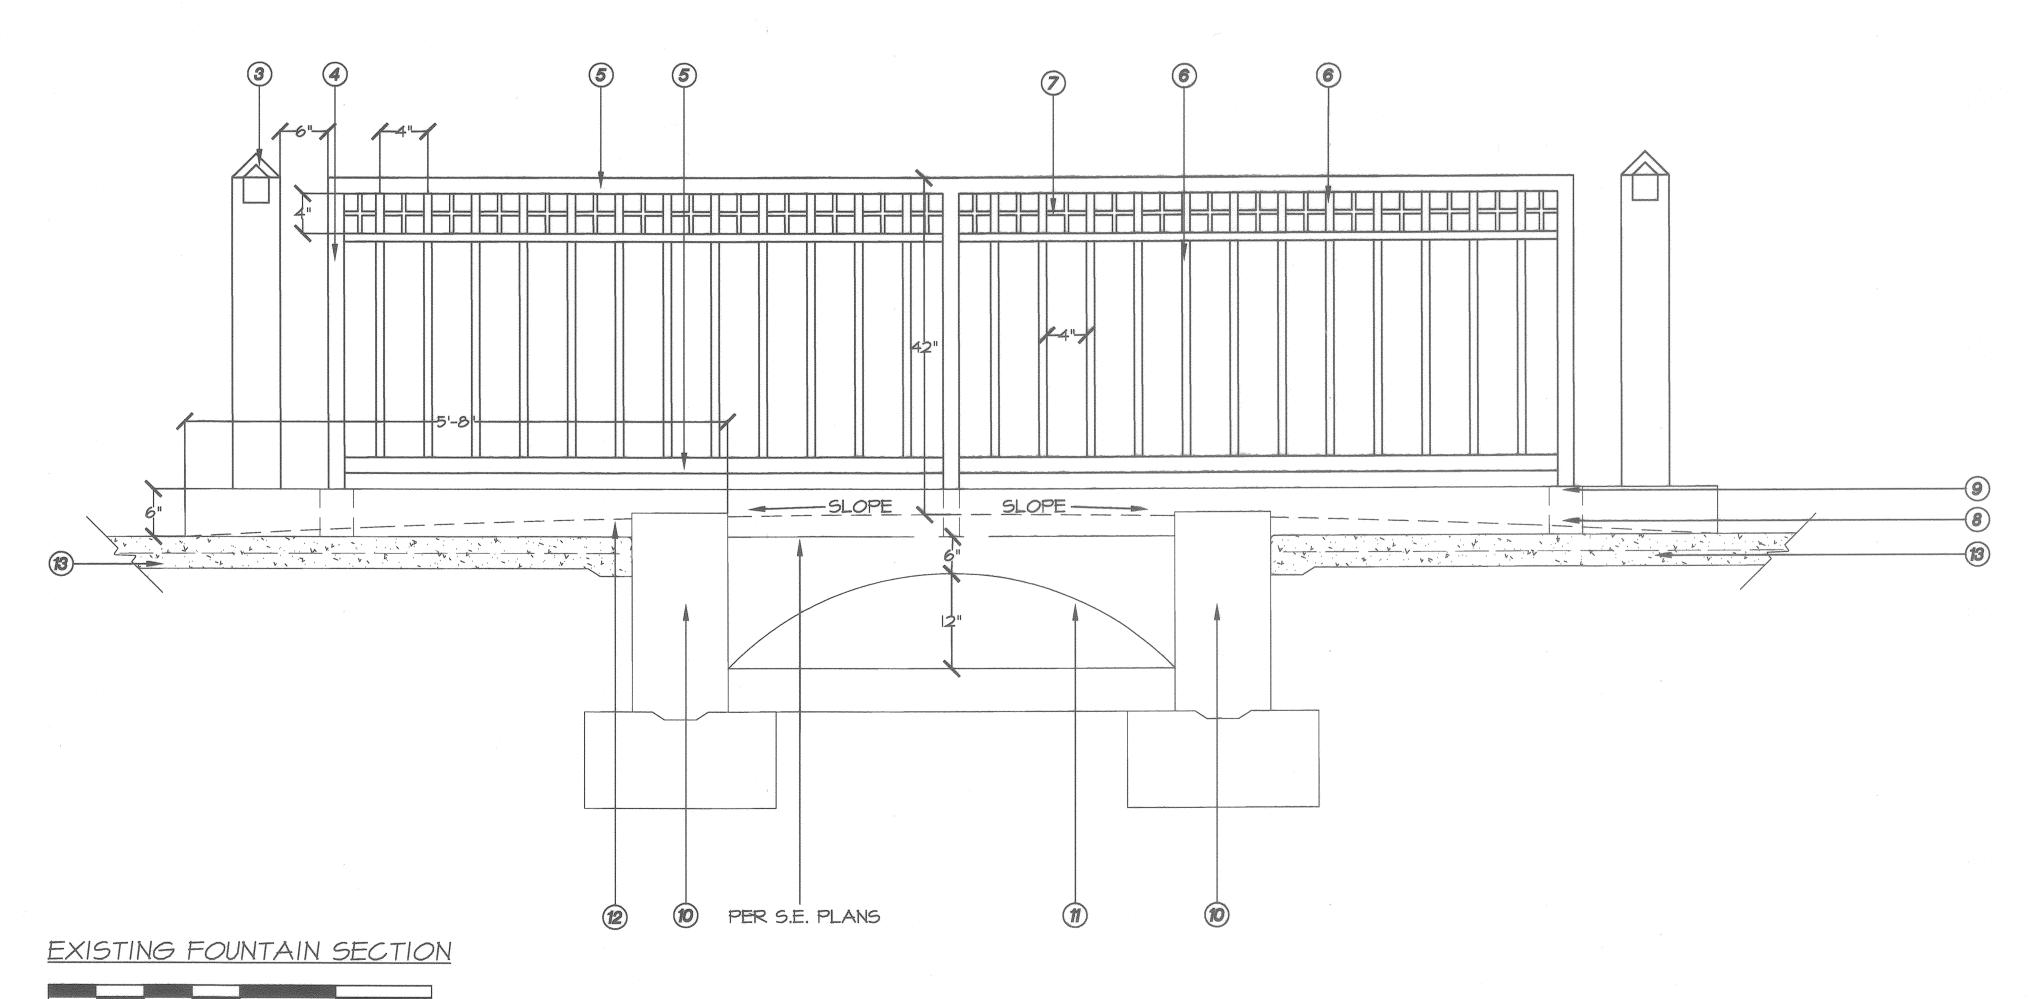
12/03/07 CONSTRUCTION PLAN M - 457SHEET 31 OF 100



DESIGNED BY <u>JD</u> DRAWN BY <u>JM / MA</u> CHECKED BY <u>JD</u>

CONSTRUCTION LEGEND

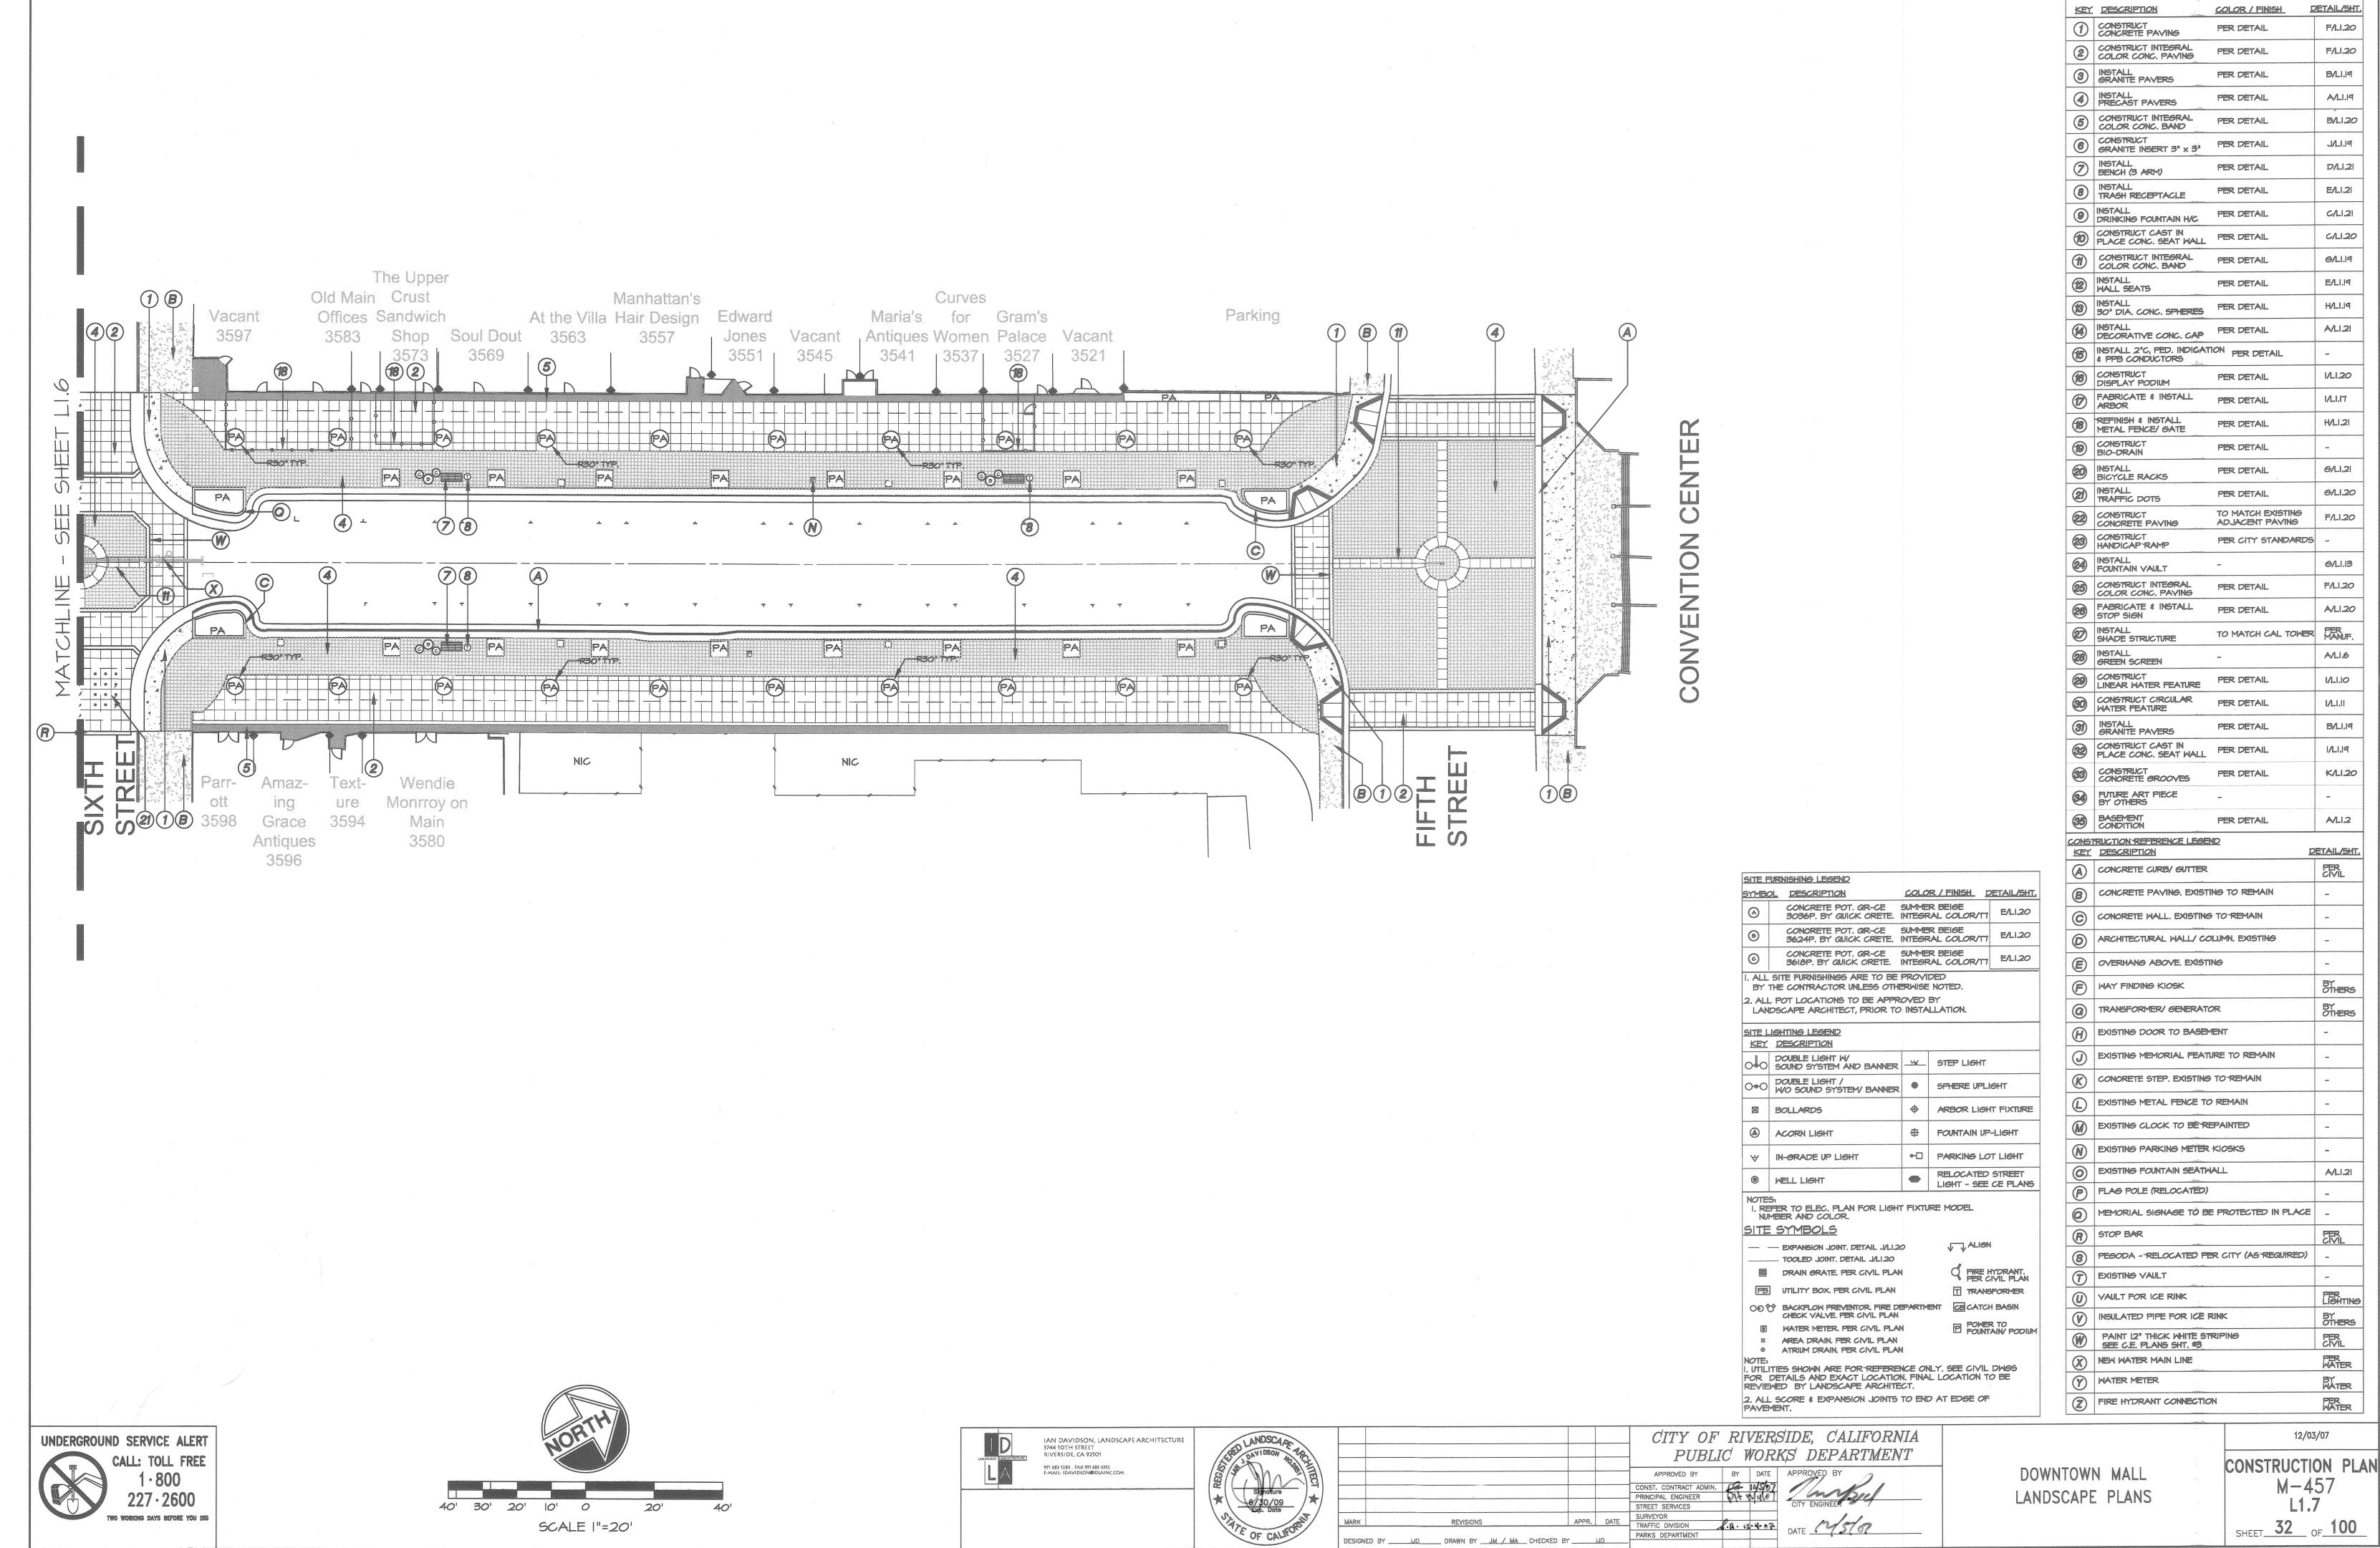

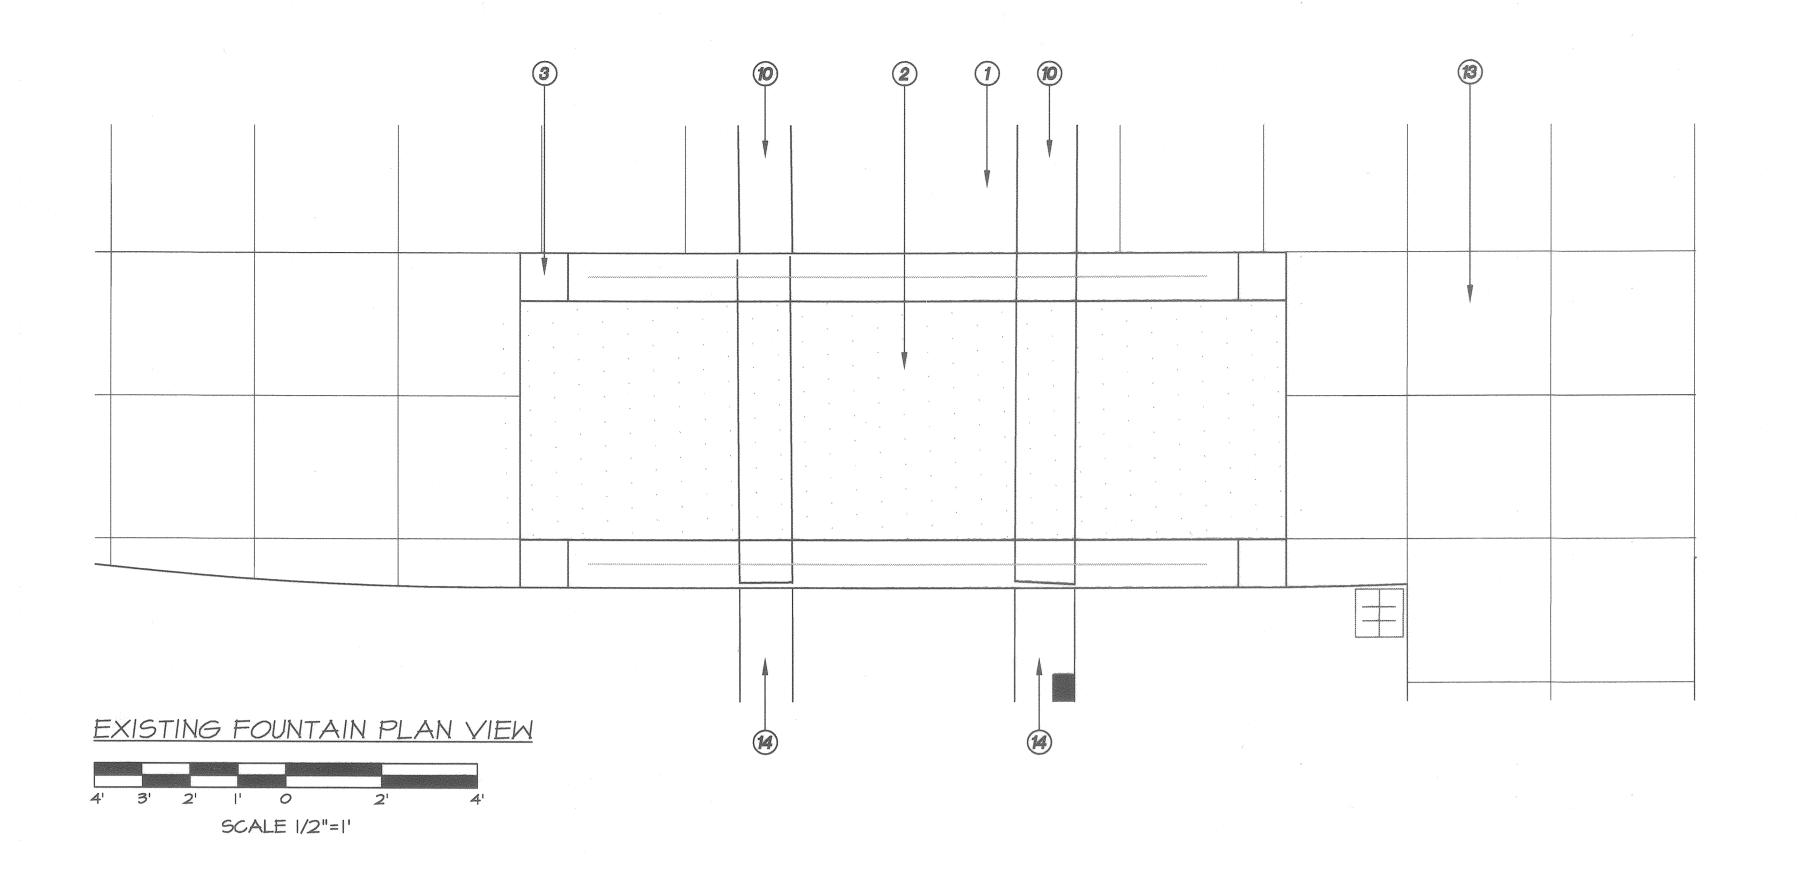

UNDERGROUND SERVICE ALERT

CALL: TOLL FREE

1 · 800

227 · 2600

TWO WORKING DAYS BEFORE YOU DIG

SCALE |"=|





CAPE ARCH								SIDE, CALIFORNIA KS DEPARTMENT
dire 09 ste					APPROVED BY CONST. CONTRACT ADMIN. PRINCIPAL ENGINEER STREET SERVICES	BY OW	DATE 12507	APPROVED BY CITY ENGINEER
ALIFORNIA	MARK DESIGNED BY JJD	REVISIONS DRAWN BYJM / MA CHECKED B	APPR.	DATE	SURVEYOR TRAFFIC DIVISION PARKS DEPARTMENT	P.W. V	-4-03-	DATE PSON

DOWNTOWN MALL

LANDSCAPE PLANS

LEGEND

4) 2" X 2" STEEL POST

(5) 2" X 2" STEEL RAILS

9 EPOXY POST IN PLACE

(11) ARCHWAY (OPEN)

(12) BRIDGE ARCH RAMP

1) EXISTING FOUNTAIN WATER ELEMENT

(3) LIGHT BOLLARD, SEE ELECTIRCAL PLANS

(8) 3" DIA. CORE DRILL IN CONC. (12" DEEP)

(10) REPAIR WALL TO MATCH EXISTING WALL ADJACENT

(13) CONC. PAVING PER DETAIL #F / SHEET #LI.20

2) BRIDGE CROSSING AND RAILINGS

(6) I" X I" STEEL PICKETS @ 5" O.C.


(14) EXISTING CONC. FOUNTAIN WALL

フ ゟ" x ゟ" STEEL TRIM ACCENT

12/03/07


FOUNTAIN / BRIDGE
M-457
L1.8


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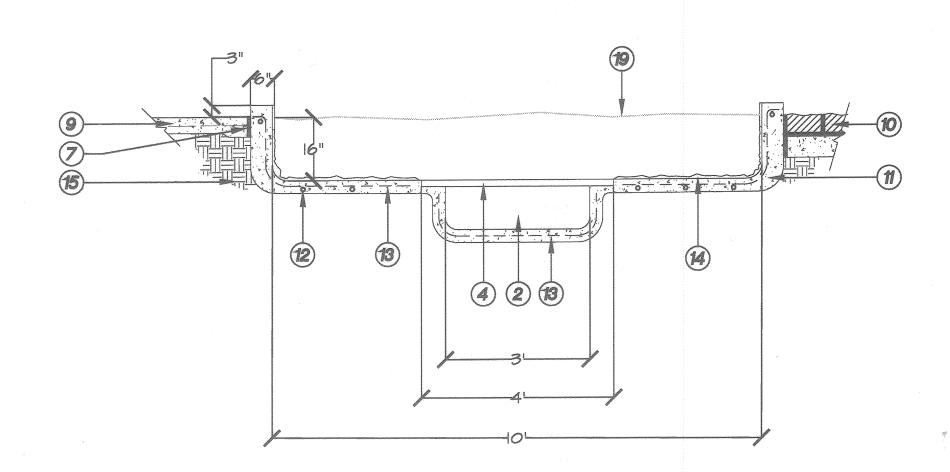


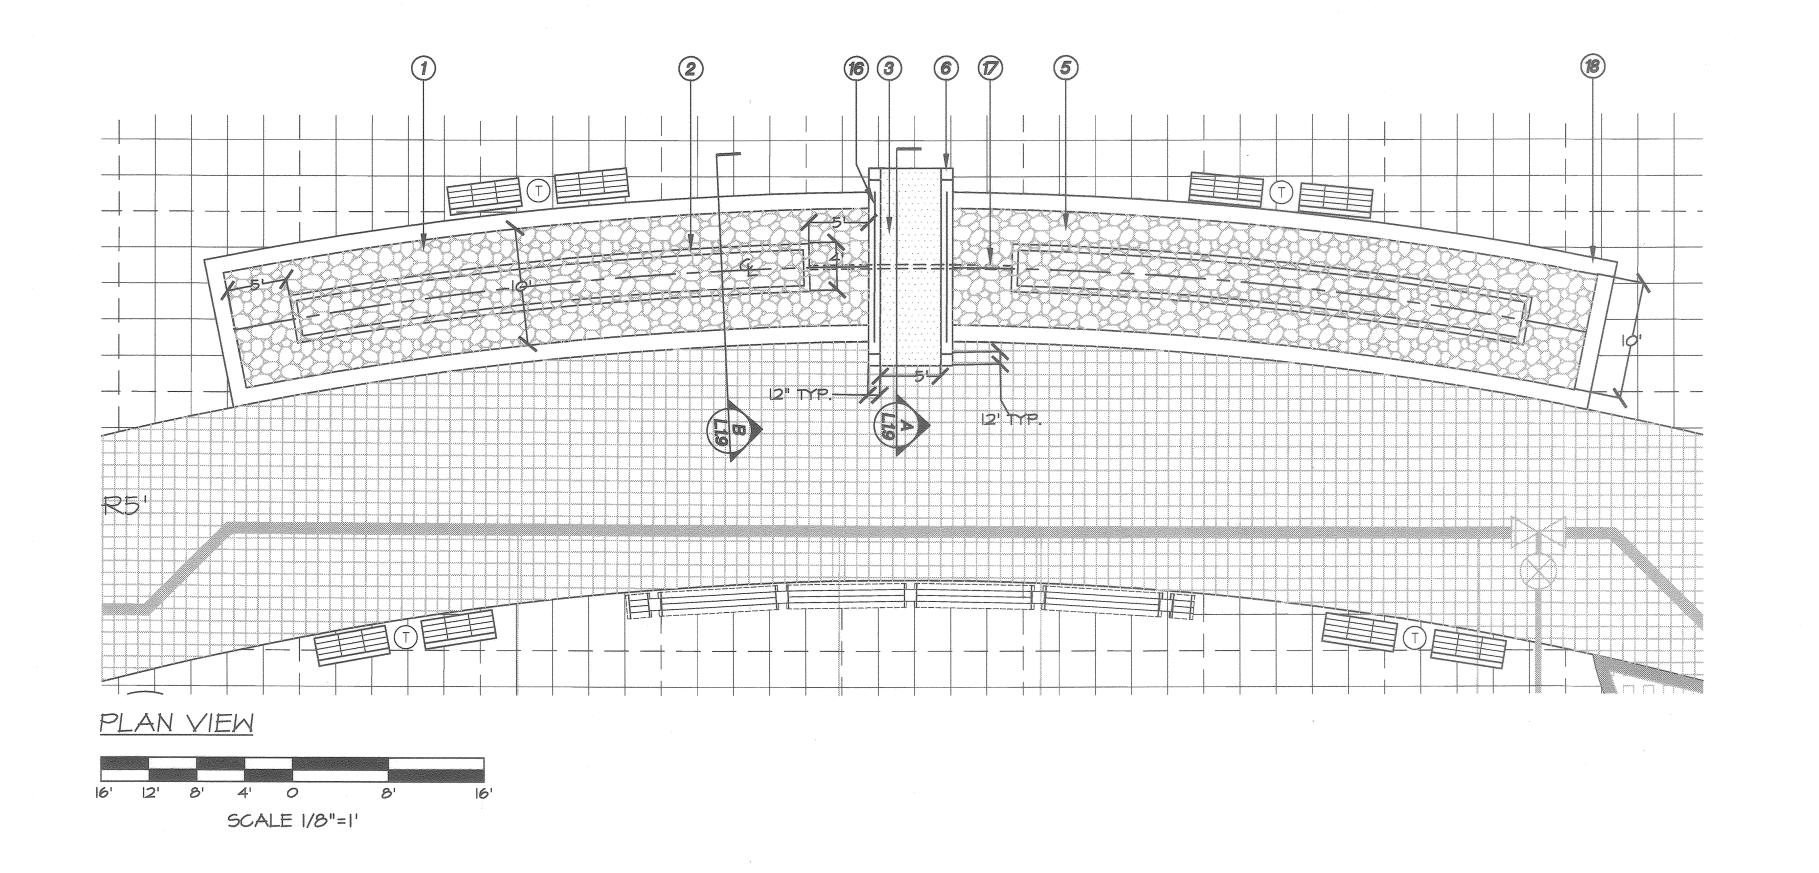
LEGEND

- 1) FOUNTAIN WATER ELEMENT
- 2 WATER TROUGH
- 3 BRIDGE CROSSING AND RAILINGS (CONC. BASE COLOR AND FINISH TO MATCH ADJACENT HARDSCAPE)
- 48" WIDE FIBERGLASS PLATE, MODEL#MS 5-200,BY MCNICHOLS CO. 4) 14108 E. ARBOR PLACE, CERRITOS, CA. 90703 TEL. (562) 921-3344
- 2'-3' DIA. BOULDER BY SOUTHWEST BOULDER, 5 5002 2ND STREET, FALLBROOK, CA. 92028 TEL. (760) 451-3335
- (6) LIGHT BOLLARD, SEE ELECTRICAL PLANS
- 7 EXPANSION JOINT PER DETAIL #F / SHEET LI.20
- (8) NOT USED
- (9) CONC. PAVING PER DETAIL #F / SHEET LI 20
- 10) PAVERS PER DETAILS #A / SHEET LI.19
- (1) CONC. FOUNTAIN WALL (CHARCOAL)
- 12) #3 REBAR @12" O.C. EACH WAY
- (13) #4 REBAR @ 12" O.C. EACH WAY
- (14) PEBBLETEC OR EQUIVALENT FINISH. COLOR: MOONLIGHT GREY. CONTACT: (800) 937-5058
- (15) COMPACTED SUBGRADE (95%)
- (16) BRIDGE RAILING, SEE DETAIL #B, SHEET LI.21
- (7) 4" PVC PIPE EQUALIZER
- (18) FOUNTAIN COPING
- 19 WATER LINE
- 20 BOND BREAKER



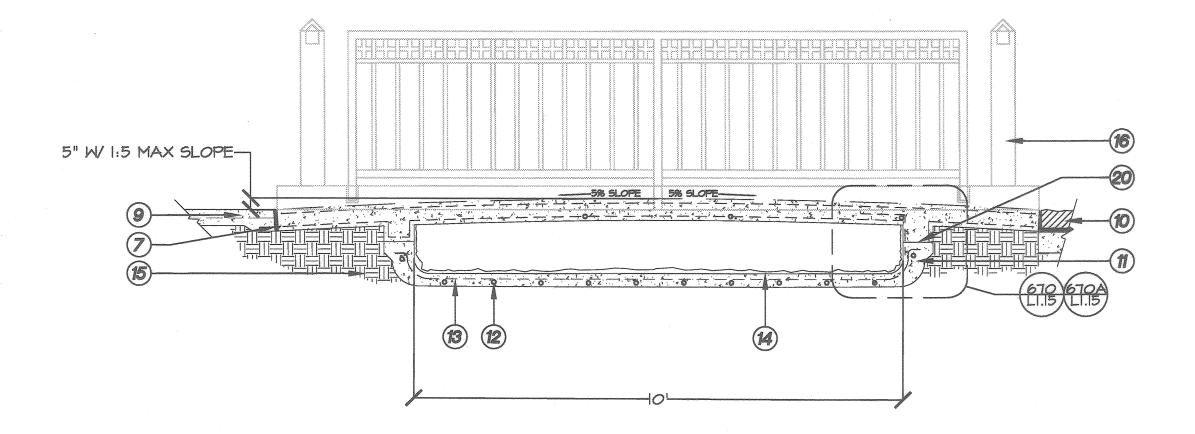


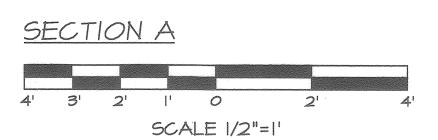


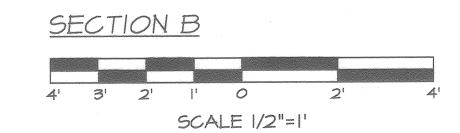





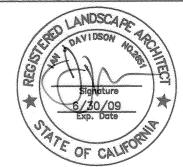

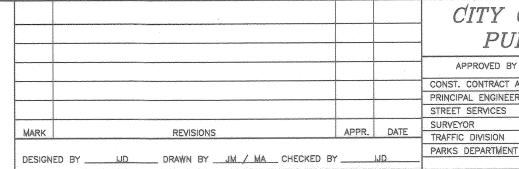


CITY OF RIVERSIDE, CALIFORNIA PUBLIC WORKS DEPARTMENT APPR. DATE SURVEYOR
TRAFFIC DIVISION PARKS DEPARTMENT

DATE SURVEYOR
TRAFFIC DIVISION
PARKS DEPARTMENT

DATE

DOWNTOWN MALL LANDSCAPE PLANS

12/03/07 FOUNTAIN / BRIDGE SHEET 34 OF 100

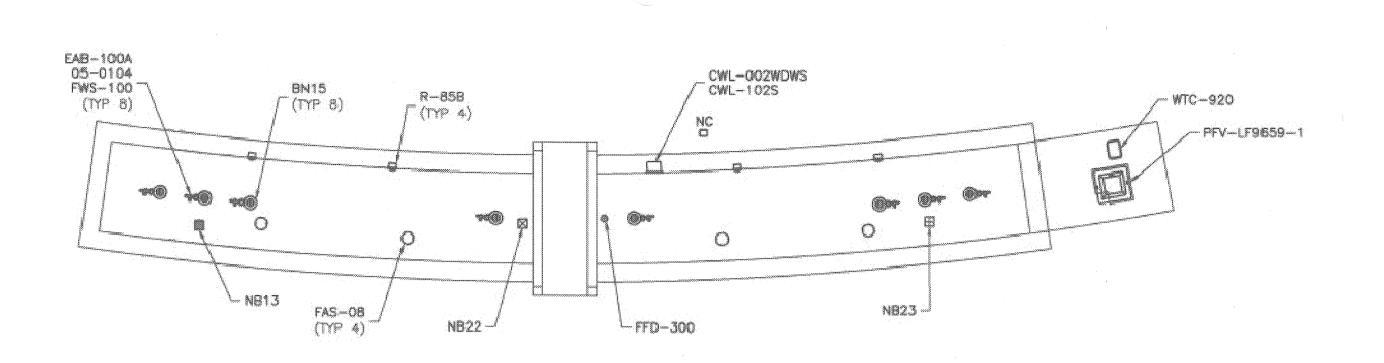

NOTE: FITTINGS "IN POOL" SCALED UP FOR CLARITY

untain

1. THIS DRAWING IS DIAGRAMMATIC IN NATURE. 2. LOCATIONS RECOMMENDED FOR COMPONENTS ARE APPROXIMATE.

3. LOCATION OF PUMPING SYSTEM IS SUBJECT TO SITE CONSIDERATIONS.

RIVERSIDE DOWNTOWN MALL

Design Concept: The visual effects for this water feature will be created by (8) Bubbler Nozzles operating at approximately 6" high. The nozzles will be located in an approximately 104' by 10" fountain basin. Each nozzle will be illuminated from the floor for night viewing.

EQUIPMENT LIST: Qty Component

1 PFV-LF9659

4 R-85B

4 FAS-08

1 FFD-300

Description

In-ground Vault System w/: effect pump and strainer; filter pump and strainer; sand filter; backwash discharge; valves; pressure gauges; vacuum gauges; water fill station with hose bib, solenoid valve and isolation valves; check valve for vault drainage; landscape lid; ventilation fan: UL Listed electronic controls including NEMA-12 enclosure, power distribution, GFCI light circuits, motor starters, time clocks, low water cutoff, labeled terminal strips for field connections; System pre-plumbed and pre-wired with sealed vault penetrations. Engineer sealed for inground placement.

1 WTC-920 In-Ground Chlorine - Bromine Feeder Assembly including valve box. isolation valves and (7) lb. capacity time release feeder 8 EAB-100A

1" Bubbler Nozzle with Snorkel, Copper and Bronze 1-1/2" Stream Eyeball Inlet, Cast Bronze 8" Anti-Vortex/Diverter Plate, Cast Bronze, w/ABS Sump 3" Floor Drain w/Plug and Waterstop, Cast Bronze

8 FWS-100 1" Cast Bronze Waterstop Coupling 8 05-0104 3/4" Ball Valve w/Stainless Handle 1 CWL-002WDWS Wall Water Level Sensor, Overflow Housing w/ Waterstop, Cast Bronze 1 GWL-1025 Water Level (Gube) Switch w/30' Gord

1 NC Flush Cast Bronze Junction Box w/(1) 3/4" Bottom Connection, (2) 1/2" Side Connections and Potting Compound 8 BN15 150W, 120V Underwater Cast Bronze Light & Rock Guard, Stainless

Steel Niche, w/Lamp 1 NB13 Flush Cast Bronze Junction Box w/(1) 3/4" Bottom Connection, (3) 3/4" Machined Brass Seals and Potting Compound

1 NB22 Flush Cast Bronze Junction Box w/(2) 3/4" Bottom Connections, (2) 3/4" Machined Brass Seals and Potting Compound 1 NB23 Flush Cast Bronze Junction Box w/(2) 3/4" Bottom Connections, (3) 3/4"

Machined Brass Seals and Potting Compound 1 DESIGN Schematic drawing to illustrate piping, wiring and utility connections; SERVICES Installation details for equipment list items; Specifications 3 OPERATION CD-ROM Operation and Maintenance Manuals

MANUALS 1 PERFORMANCE Water Effects Performance Guarantee GUARANTEE

One Year Equipment Warranty


Fountain People

1 PRODUCT

WARRANTY

RIVERSIDE DOWNTOWN MALL DESIGN CONCEPT - EQUIPMENT LIST 8 6 −19−07 1 === 1 THE FOUNTAIN PEOPLE, MC - PO BOX 807 - SAN MARCOS, TX 78867 - 512-392-1155

NOT ALL SYMBOLS ARE USED ON EVERY PROJECT BASIC DRAWING NOTATIONS ALL SIZES ARE INCHES UNLESS SPECIFIED OTHERWIDE

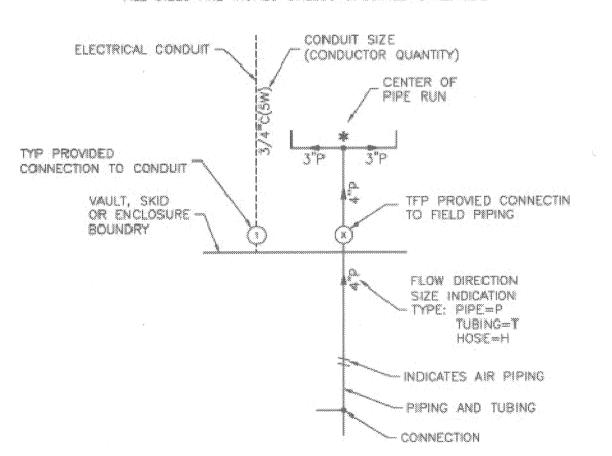


1. THESE DRAWINGS ARE DIAGRAMMATIC IN NATURE, REFER TO THE PROJECT PLANS AND SPECIFICATIONS FOR MORE COMPLETE DETAILS. 2. PIPE, FITTINGS, CONDUIT, WIRE, AND TUBING SHALL BE SUPPLIED BY THE CONTRACTOR. 3. CONDUIT LOCATED WITHIN THE POOL BASIN AND STUB-UPS THROUGH POOL

FLOOR OF WALLS INTO THE BASIN SHALL BE RED BRASS. 4. INSTALL DNLY STRANDED TYPE COPPER CONDUCTORS WITH WATERPROOF INSULATION BETWEEN UNDERWATER JUNCTION BOXES AND FOUNTAIN CONTROL PANEL SOLID COPPER CONDUCTORS SHALL NOT BE PERMITTED, CONTRACTOR SHALL SIZE WIRE BASED UPON CONDUIT RUNS AND CODE REQUIREMENTS. 5. REFER TO WIRING DIAGRAMS FOR CONDUCTOR QUANTITY AND CONNECTION INFORMATION. 6. UNDERWATER JUNCTION BOXES LOCATED INSIDE OR OUT OF THE FOUNTAIN

BASIN AND BELOW WATER LEVEL, SHALL BE TOTALLY ENCAPSULATED IN AN APPROVED POTTING COMPOUND. 7. MAKE PIPING SLOPE TO THE PUMP FOR DRAINAGE, IF PIPING CANNOT BE SLOPED TO PUMP, MAKE PROVISIONS FOR COMPLETE DRAINING OF EACH PIPE LINE CONNECTING MINIMUM A 1-1/2" DRAIN LINE AND VALVE TO LOWEST POINT IN PIPE RUN.

8. MAKE PIPE RUNS AS DIRECT AS POSSIBLE USING A MINIMUM NUMBER OF FITTINGS, INSTALL PIPING STRAIGHT AND TRUE WITHOUT LOOPS OR TRAPS. 9. PUMP SUCTION PIPING SHALL BE A STRAIGHT RUN INTO THE PUMP FREE OF PIPE BENDS OR TEES FOR A MINIMUM OF TEN PIPE DIAMETERS PRECEDING THE PUMP'S SUCTION CONNECTION UNLESS OTHERWISE INDICATED ON THE DRAWINGS.

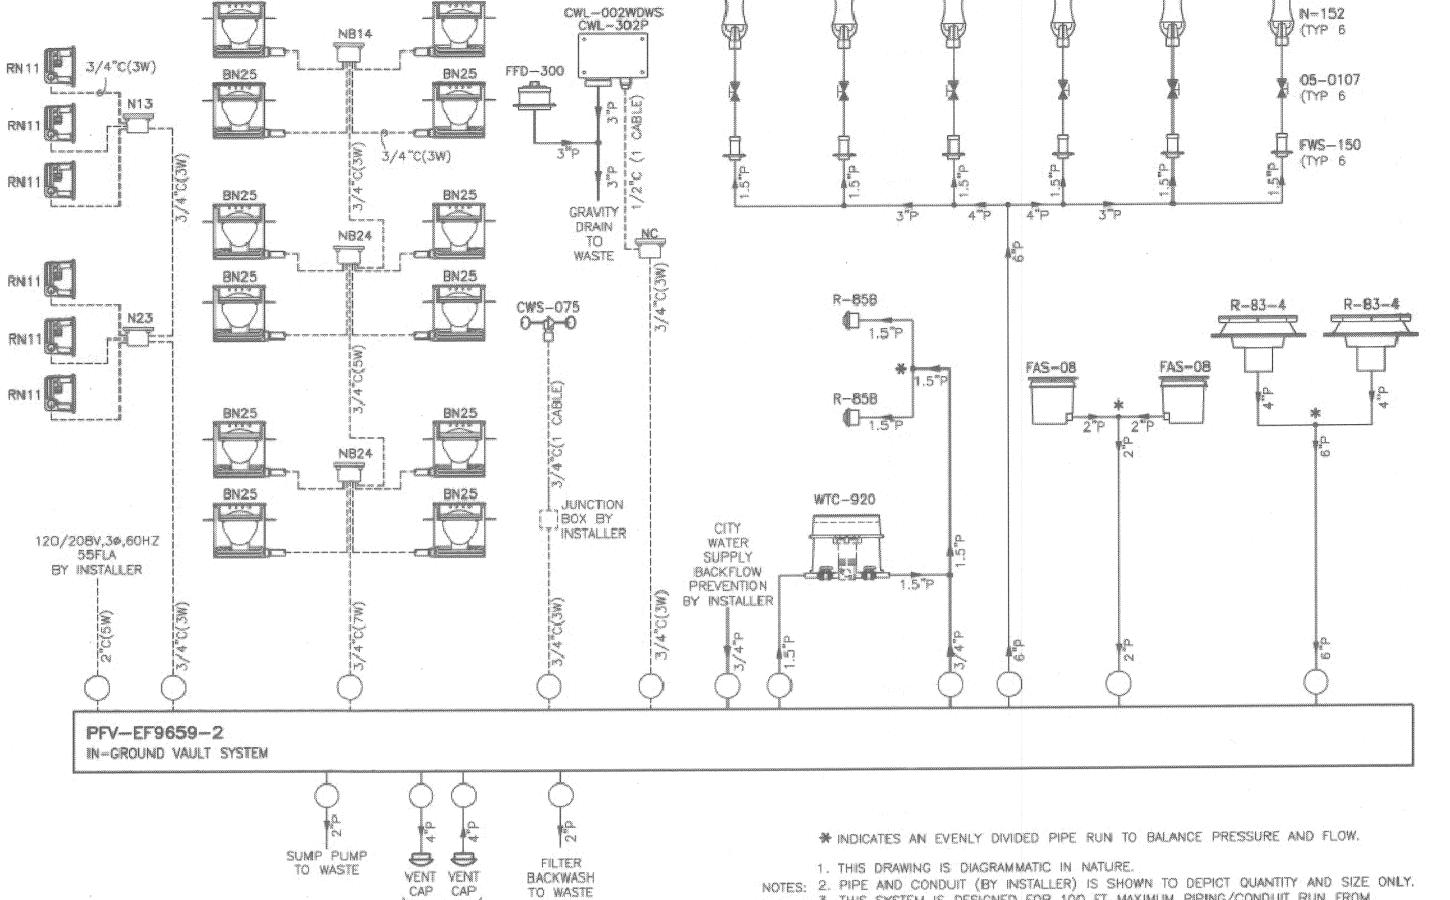

NOTES: 2. PIPE AND CONDUIT (BY INSTALLER) IS SHOWN TO DEPICT QUANTITY AND SIZE ONLY. 3. THIS SYSTEM IS DESIGNED FOR 100 FT MAXIMUM PIPING/CONDUIT RUN FROM

EQUIPMENT VAULT/SKID SYSTEM TO FOUNTAIN. 4. INSTALL PIPE RUNS AS DIRECT AS POSSIBLE USING A MINIMUM NUMBER OF FITTINGS. SLOPE PIPE TO PUMP FOR DRAINAGE AND FREE OF AIR TRAPS OR LOOPS.

 (\bullet)

CONNECTIONS

TO WASTE

PROVIDED

WITH VAULT

IDE, CALIFORNIA S DEPARTMENT

12/03/07 LINEAR FOUNTAIN M - 457L1.10 SHEET 35 OF

UNDERGROUND SERVICE ALERT CALL: TOLL FREE 227 - 2600


WORKING DAYS BEFORE YOU DIG


IAN DAVIDSON, LANDSCAPE ARCHITECTURE 3744 10TH STREET RIVERSIDE, CA 92501 951 683 1283 . FAX 951 683 4352 E-MAIL: IDAVIDSON@IDLAINC.COM



DSCAPE APP					CITY OF PUBLI		,	
BSON NO.				***************************************	APPROVED: BY	BY	DATE	Al
				<u> </u>	CONST. CONTRACT ADMIN.	SE	12/5/07	
molure 50/09					PRINCIPAL ENGINEER	PI	12/4/07	-7
. Data /_ /					STREET SERVICES	ļ	4	
	MARK	REVISIONS	APPR.	DATE	SURVEYOR TRAFFIC DIVISION	0 18	2-4-87-	
CALIFORNIA		ED DV LID SERVICE AND ALL CHECKED	mv	110	PARKS DEPARTMENT		2.4.04	D
	DESIGN	ED BY DRAWN BYJM / MA CHECKED	DT	ND				

DOWNTOWN MALL LANDSCAPE PLANS

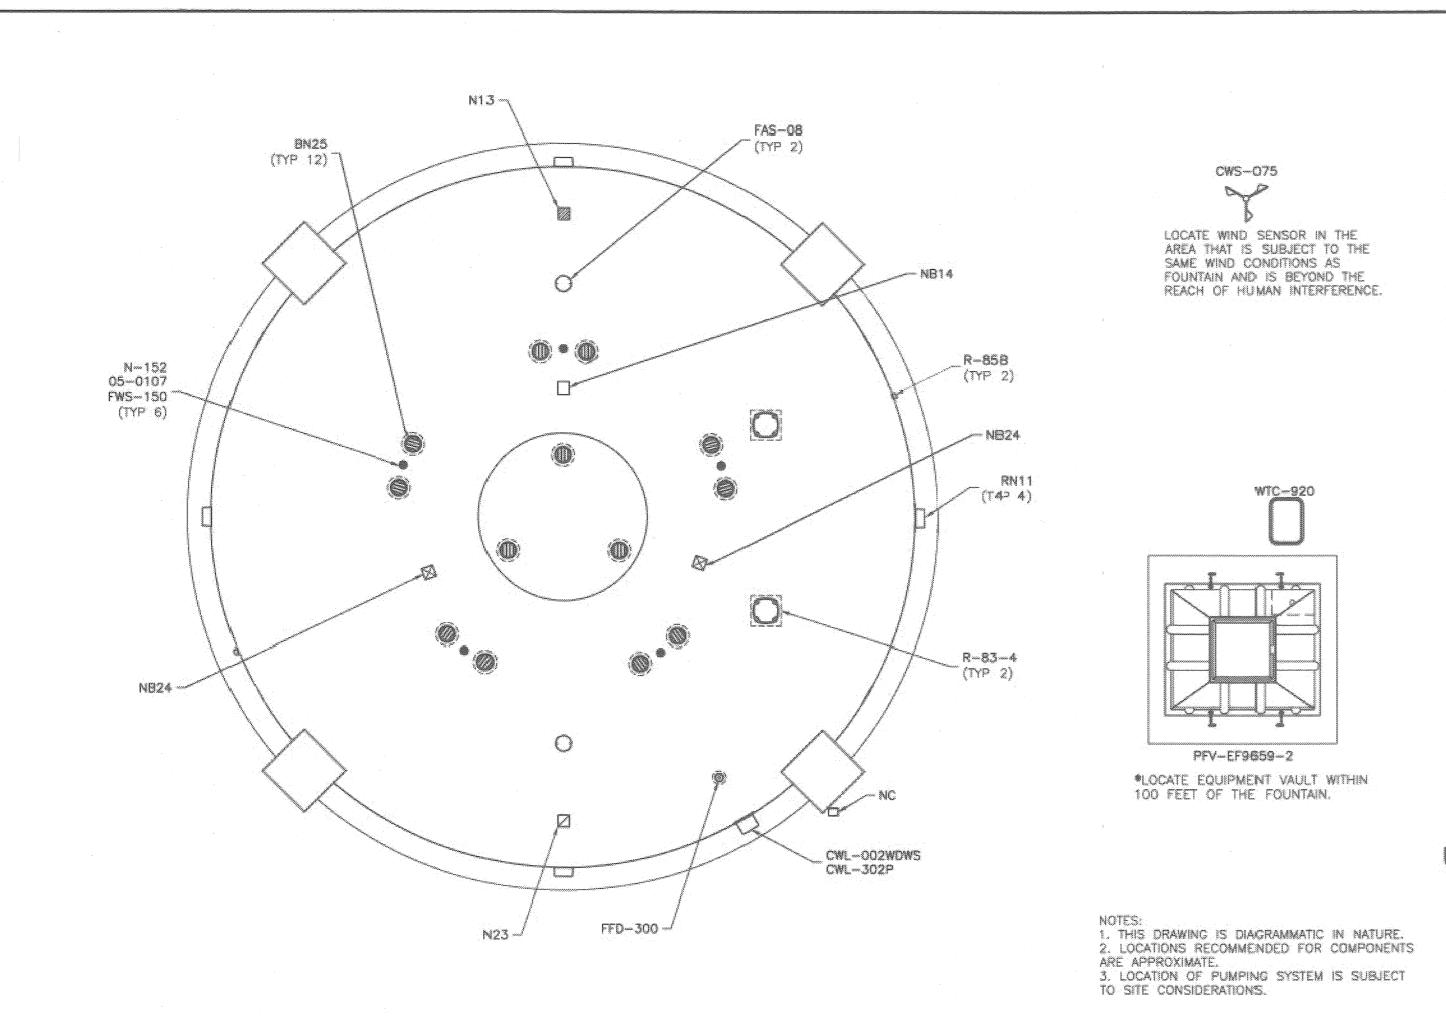

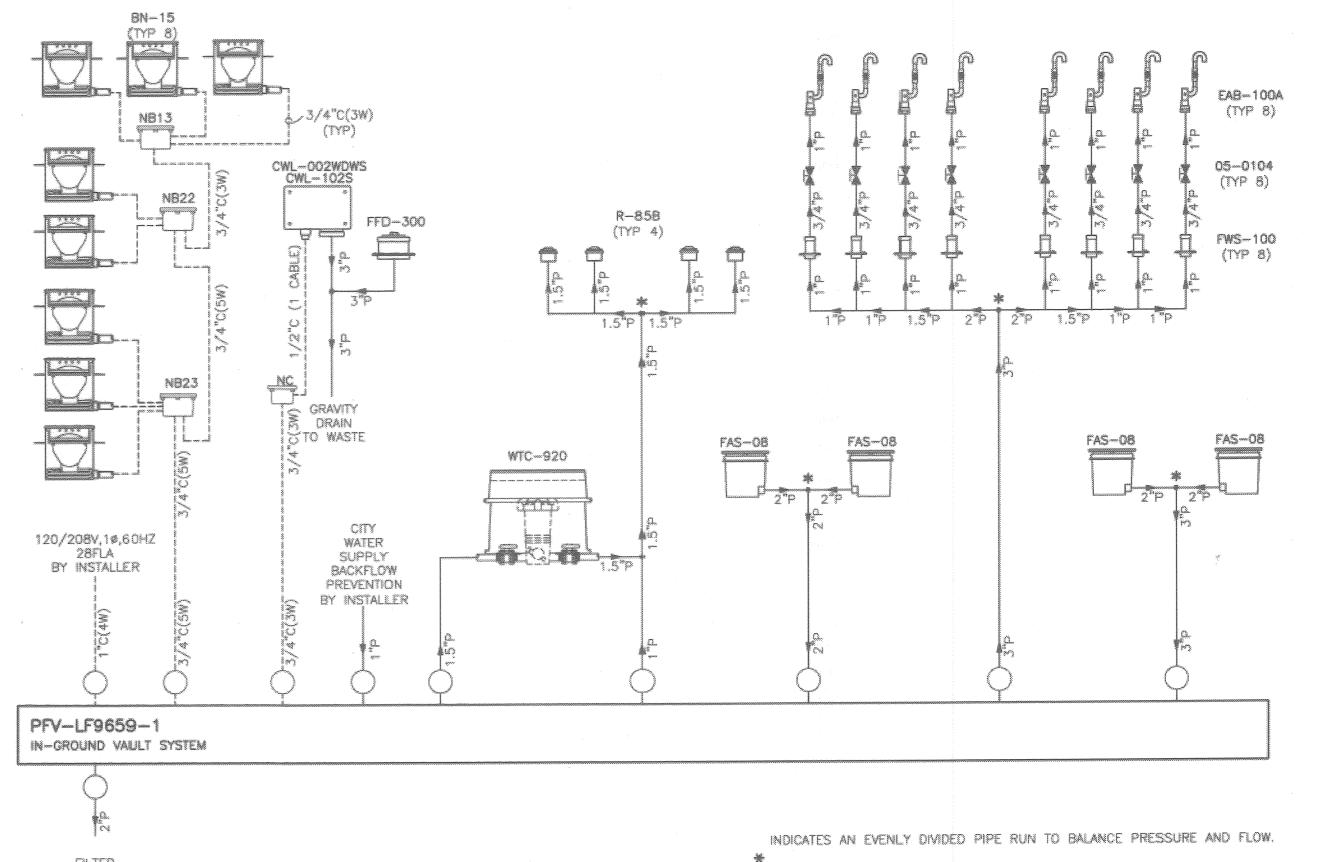

RIVERSIDE DOWNTOWN MALL-CASCADE FOUNTAIN

Bronze

Design Concept: The visual effects for this water feature will be created by (6) Geyer Nozzles located in a circular pattern, operating at approximately 8' high. Each nozzle will be illuminated from the floor with (2) 250-watt underwater niche lights for night viewing. There are an additional (6) 116-watt underwater niche lights located in the side wall to illuminate the pool.

EQUIPMENT LIST:

1 GWL-302P

2 NB24

City Component 1 PFV-EF9659-2 In-ground Vault System w/: effect pump and strainer; filter pump and strainer; sand filter; backwash discharge; valves; pressure gauges; vacuum gauges; water fill station with hose bib, solenoid valve and drainage; landscape lid; ventilation fan; enamel coated cast iron vent UL Listed electronic controls including NEMA-12 enclosure, power distribution, GFCI light circuits, motor starters, variable frequency drive, equipment only. time clocks, HOA switches, low water cutoff, dual stage wind control, labeled terminal strips for field connections; System pre-plumbed and pre-wired with sealed vault penetrations. Engineer sealed for in-ground PRODUCT WARRANTY placement. ™ WTC-920 In-Ground Chlorine - Bromine Feeder Assembly including valve box, isolation valves and (7) lb. capacity time release feeder 6 N-152 1-1/2" Geyser Nozzle, Machined Cast Bronze 2 **R-85B** 1-1/2" Stream Eyeball Inlet, Cast Bronze 2 FAS-08 8" Anti-Vortex/Diverter Plate, Gast Bronze, w/ABS Sump 2 **R-83-4** 13" Anti-Vortex/Diverter FRP Sump w/Cast Bronze Plate 1 FFD-300 3" Floor Drain w/Plug and Waterstop, Cast Bronze 6 FWS-150 1-1/2" Cast Bronze Waterstop Coupling 6 05-0107 t-1/2" Ball Valve w/Stainless Handle GWL-002WDWS Wall Water Level Sensor, Overflow Housing w/ Waterstop, Cast

1 CWS-075 Wind Speed Sensor Flush Cast Bronze Junction Box w/(1) 3/4* Bottom Connection, (2) 1/2" materials furnished by The Fountain People, Inc. 1 NC Side Connections and Potting Compound 250W, 120V Directional Underwater Cast Bronze Light & Rock Guard, 12 BN25 Stainless Steel Niche, w/Lamp 4 RN11 116W, 120V Directional Underwater Light and Bronze Niche w/Lamp Flush Cast Bronze Junction Box w/(1) 3/4" Side Connection, (3) 3/4" 1 N13 Machined Brass Seals and Potting Compound 1 N23 Machined Brass Seals and Potting Compound 1 NB14 Flush Cast Bronze Junction Box w/(1) 3/4" Bottom Connection, (4) 3/4"

Operating Water Level Sensor w/30/ Gord

Machined Brass Seals and Potting Compound Flush Cast Bronze Junction Box w/(2) 3/4" Bottom Connections, (4)

3/4" Machined Brass Seals and Potting Compound

SERVICES

1 DESIGN Schematic drawing to illustrate piping, wiring and utility connections; Installation details for equipment list items; Specifications 3 OPERATION CD-ROM Operation and Maintenance Manuals MANUALS

Description

1 PERFORMANCE Water Effects Performance Guarantee

GUARANTEE One Year Equipment Warranty

PERFORMANCE GUARANTEE

1 PRODUCT

WARRANTY


The Fountain People, Inc. shall guarantee the performance of the fountain design to produce isolation valves; sump pump with float switch and check valve for vault—the specified water effects provided all equipment is purchased and installed per our recommendations and all of the architectural details we provide are incorporated into the caps; entry ladder; vault interior light and convenience electrical outlet; fountain installation. In the event that others have provided the system design or our recommendations are not utilized, guarantee shall be limited to the performance of the furnished

The Fountain People, Inc. shall warrant all properly installed and maintained equipment (except lamps) for a period of one year from date of original shipment. For systems with a factory startup, the warranty shall extend 18 months from date of original shipment or one year from date of start-up, whichever comes first. The Fountain People, Inc., at their option, shall replace or repair any materials, components, or workmanship found to be defective within the warranty period when returned to the factory, freight pre-paid. No component may be returned to The Fountain People, Inc. for repair or replacement without an approved return materials authorization.

This warranty does not include damage resulting from lightning, vandalism, improper maintenance, operator error, or other conditions beyond the control of The Fountain People, Inc., nor labor, freight charges, or incidental materials required to facilitate fountain repairs. The Fountain People, Inc. shall not be held liable for damage to other equipment or materials, loss of time, profits, or any inconvenience directly or indirectly resulting from the failure of equipment or


No other warranty, expressed or implied, including the warranties of merchantability exists beyond that included in this statement.

Flush Cast Bronze Junction Box w/(2) 3/4" Side Connections, (3) 3/4" FOR ABOVE GROUND BOND BEAM SEE DETAIL #7 / LI.14

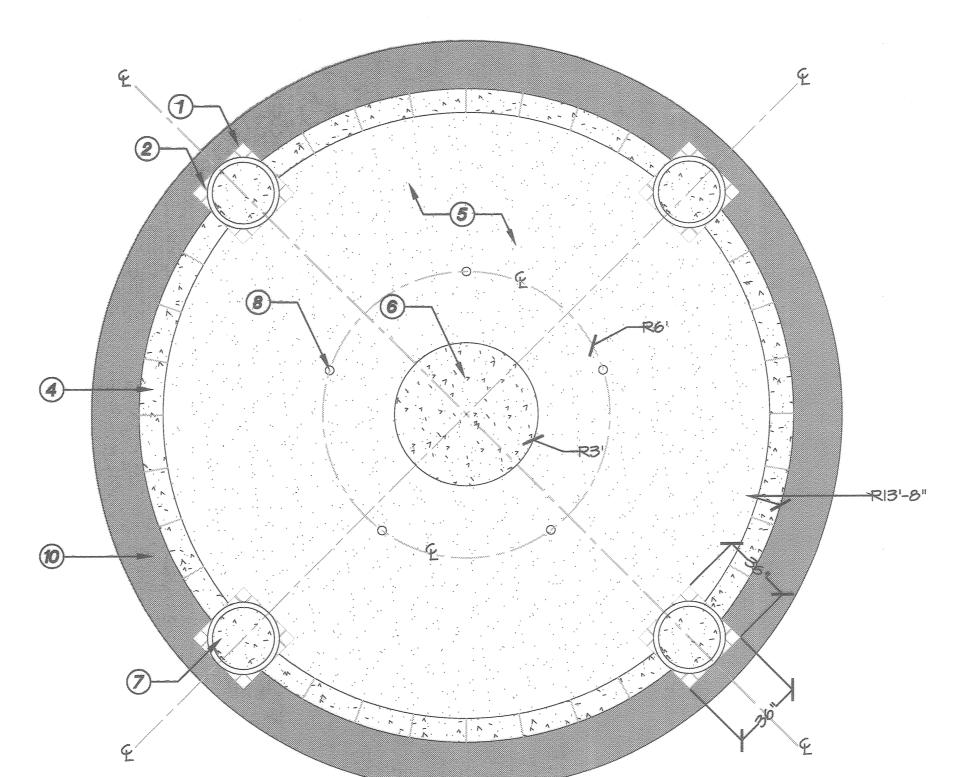


BACKWASH

TO WASTE

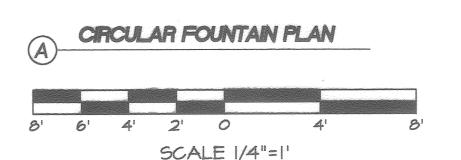

THIS DRAWING IS DIAGRAMMATIC IN NATURE. NOTES: 2. PIPE AND CONDUIT (BY INSTALLER) IS SHOWN TO DEPICT QUANTITY AND SIZE ONLY. 3. THIS SYSTEM IS DESIGNED FOR 100 FT MAXIMUM PIPING/CONDUIT RUN FROM EQUIPMENT VAULT/SKID SYSTEM TO FOUNTAIN.

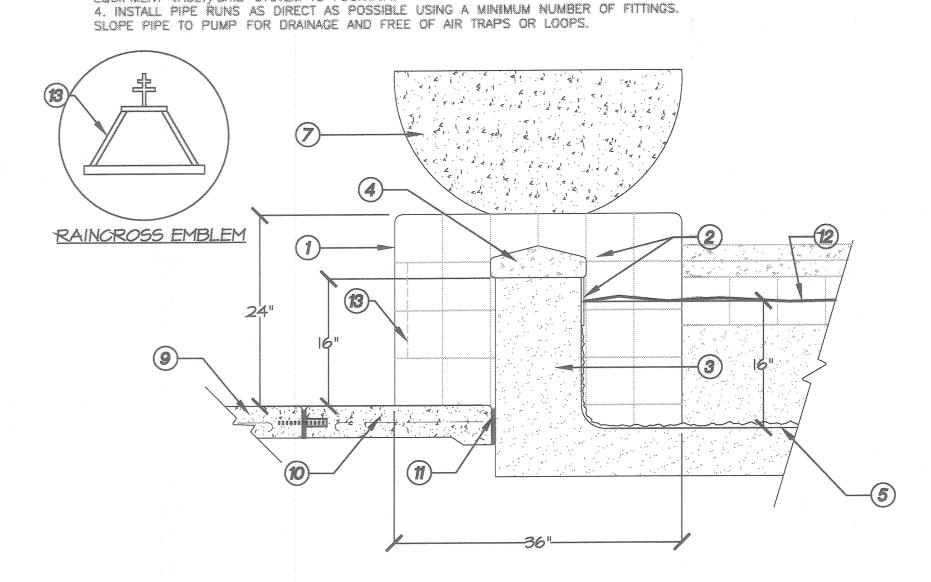

CIRCULAR FOUNTAIN SECTION 24" |8" |2" 6"

SCALE |"=|

LEGEND


- (1) TILE PODIUM
- (2) 6" X 6" CERAMIC TILE BY DALTILE MODEL: DMI4 COBALT CONTACT: 1132 DURYEA, IRVINE, CA. 92614 (949) 757-7060
- (3) POOL WALL, SEE DETAIL F / SHEET LIZI
- (4) CUSTOM PRECAST CONCRETE CAP BY QUICKCRETE COLOR: CHARCOAL INTEGRAL COLOR, FINISH: TT CONTACT: 731 PARKRIDGE AVE., NORCO, CA. 92860 (951) 737-6240 PER DETAIL #F / SHEET #LI2
- (5) PEBBLETEC OR EQUIVALENT FINISH. COLOR: JET BLACK. CONTACT: (800) 937-5058
- (6) DISPLAY PODIUM PER DETAIL I / SHEETLI.21
- OCONCRETE POT. QR-CE 3618P. BY QUICK CRETE, SEE DETAIL #L / SHEET LI.19

Ountain


6

- (8) GEYSER NOZZLE PER CASCADE FOUNTAIN PLAN / SHEET LI.II
- (9) CONC. PAVING PER DETAIL #F / SHEET LI 20
- (10) CONC. BAND PER DETAIL #B / SHEET LI.20
- (11) EXPANSION JOINT PER DETAIL #J / SHEET LI.20
- (12) WATER LINE
- (13) PRECAST CONC. RAINCROSS EMBLEM BY QUICKCRETE. COLOR: CHARCOAL TO BE ATTACHED TO PODIUM FACING AWAY FROM FOUNTAIN

UNDERGROUND SERVICE ALERT CALL: TOLL FREE 227 · 2600

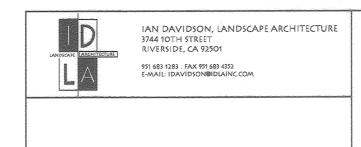





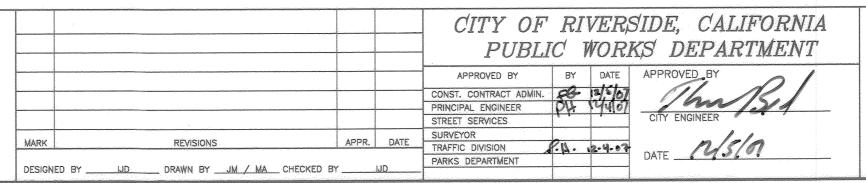


DOWNTOWN MALL LANDSCAPE PLANS

12/03/07 CIRCULAR FOUNTAIN SHEET 36 OF 100

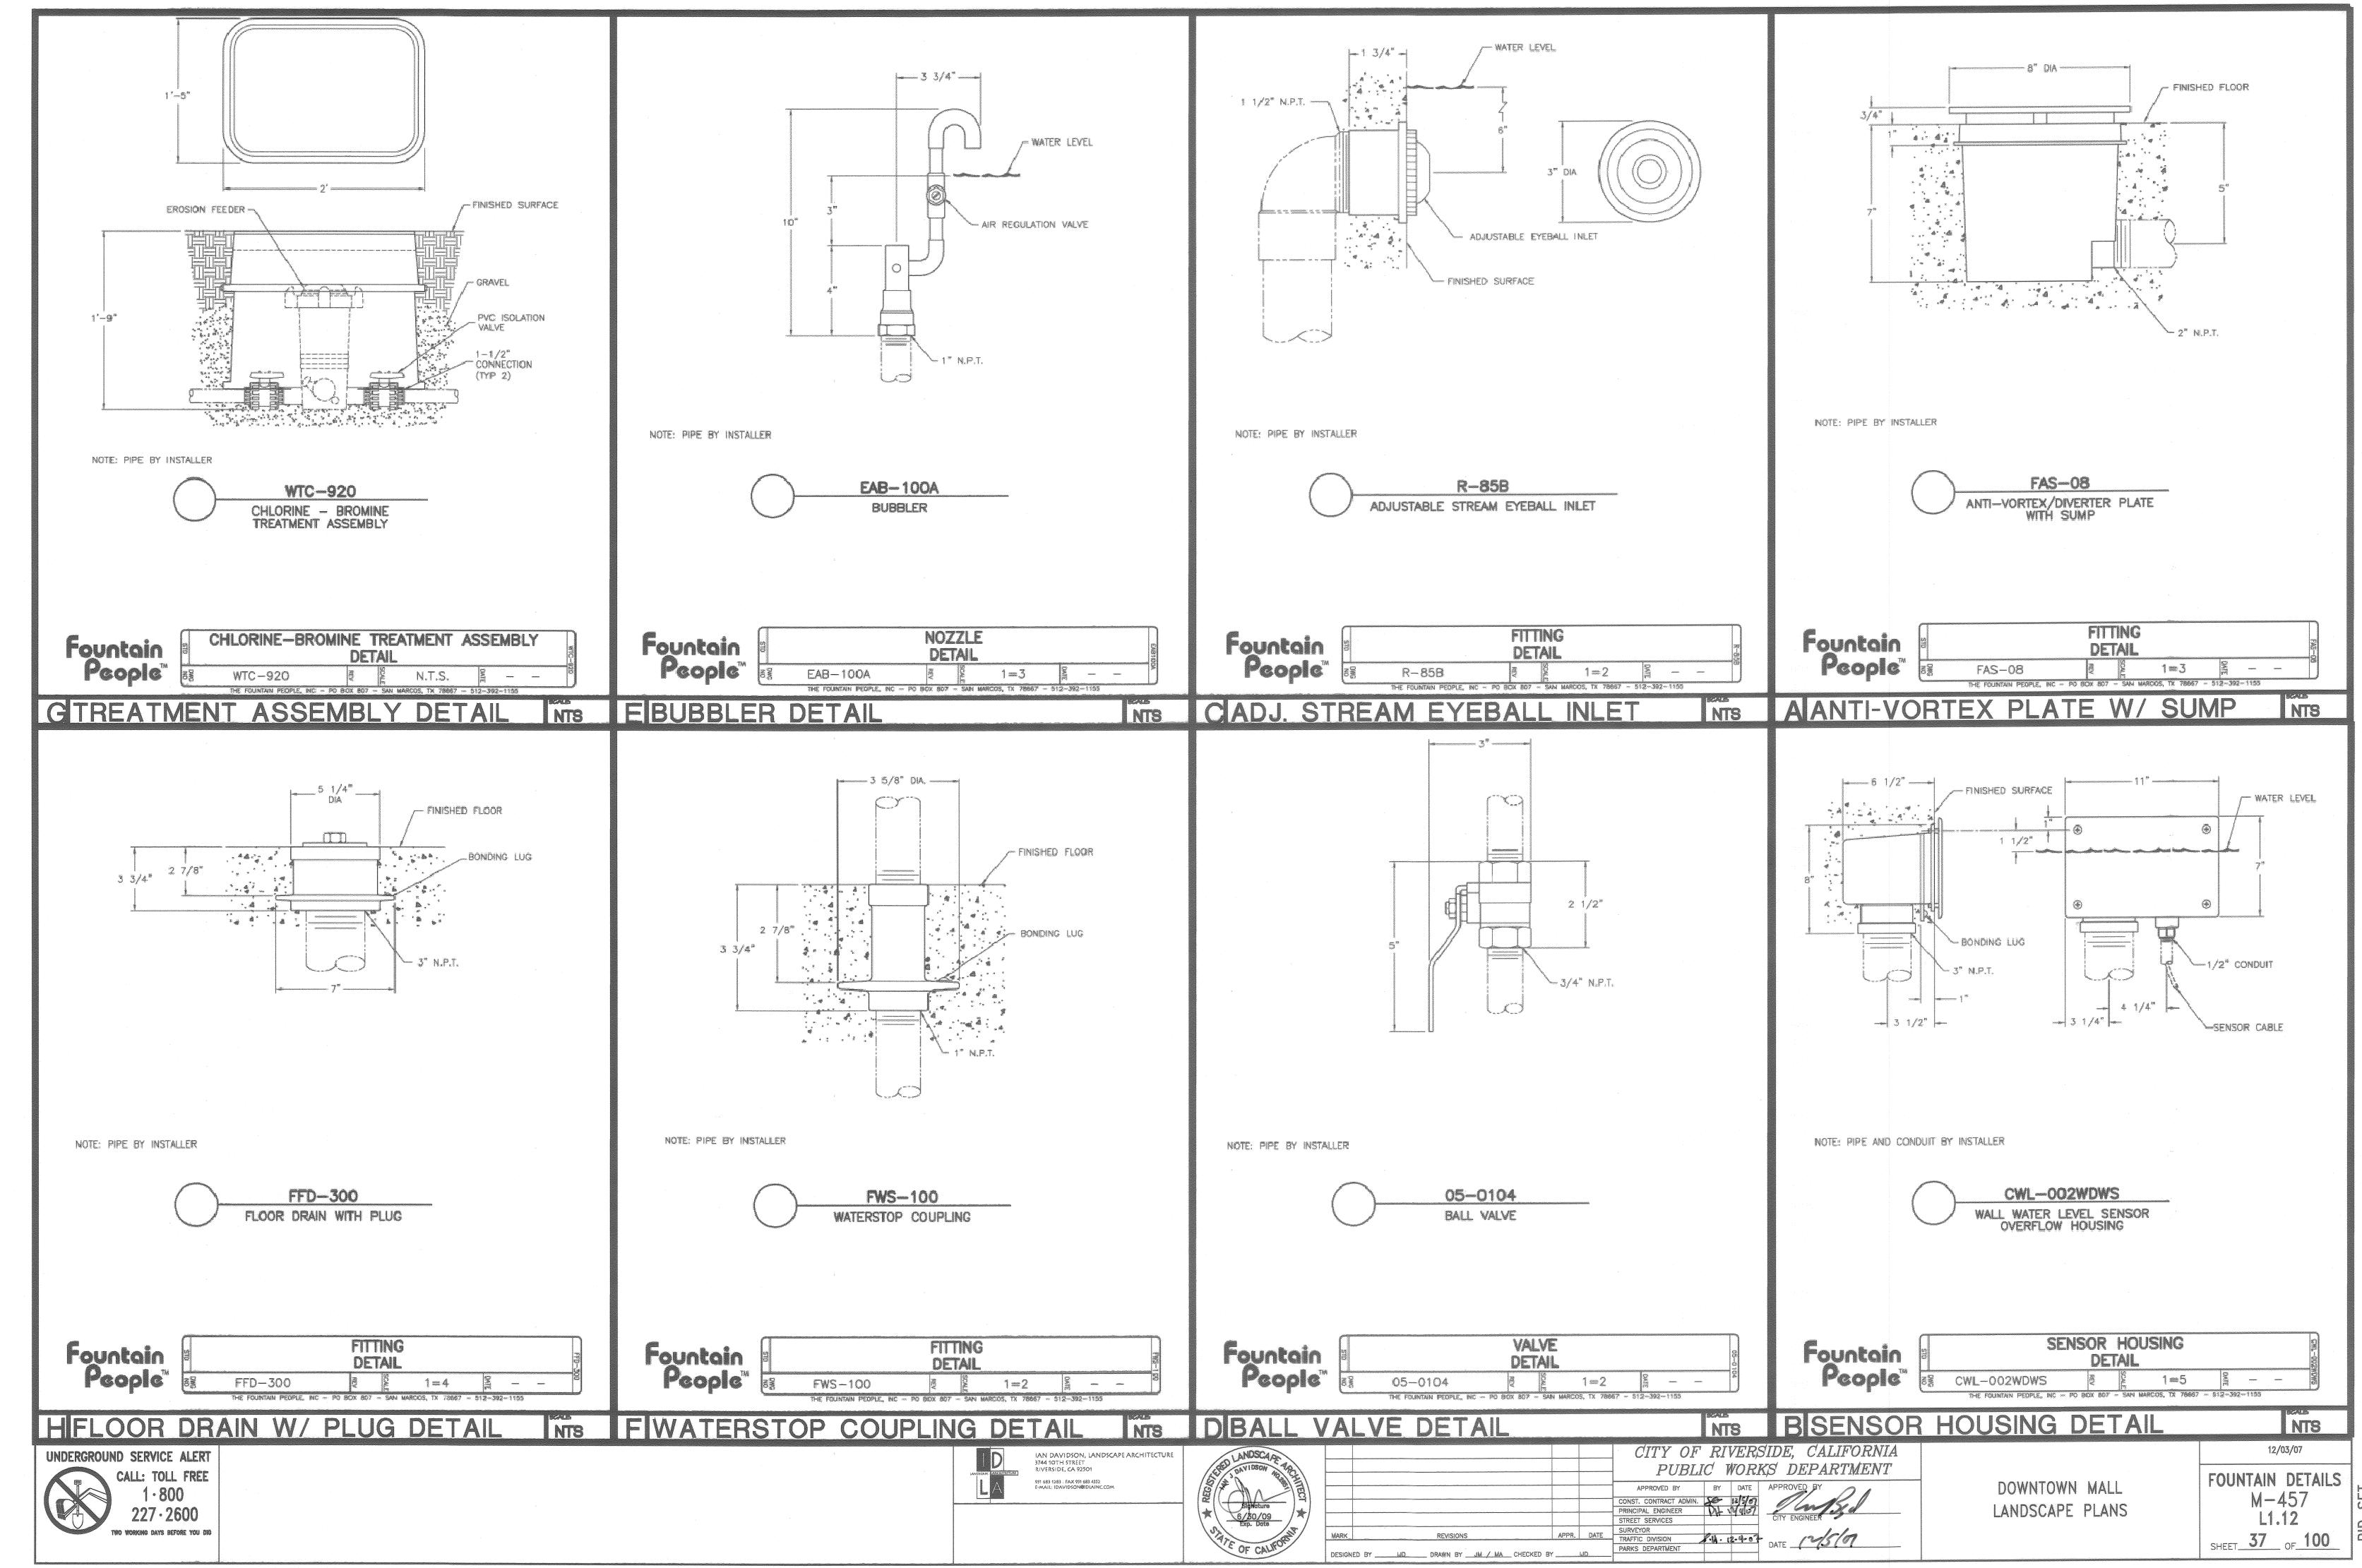


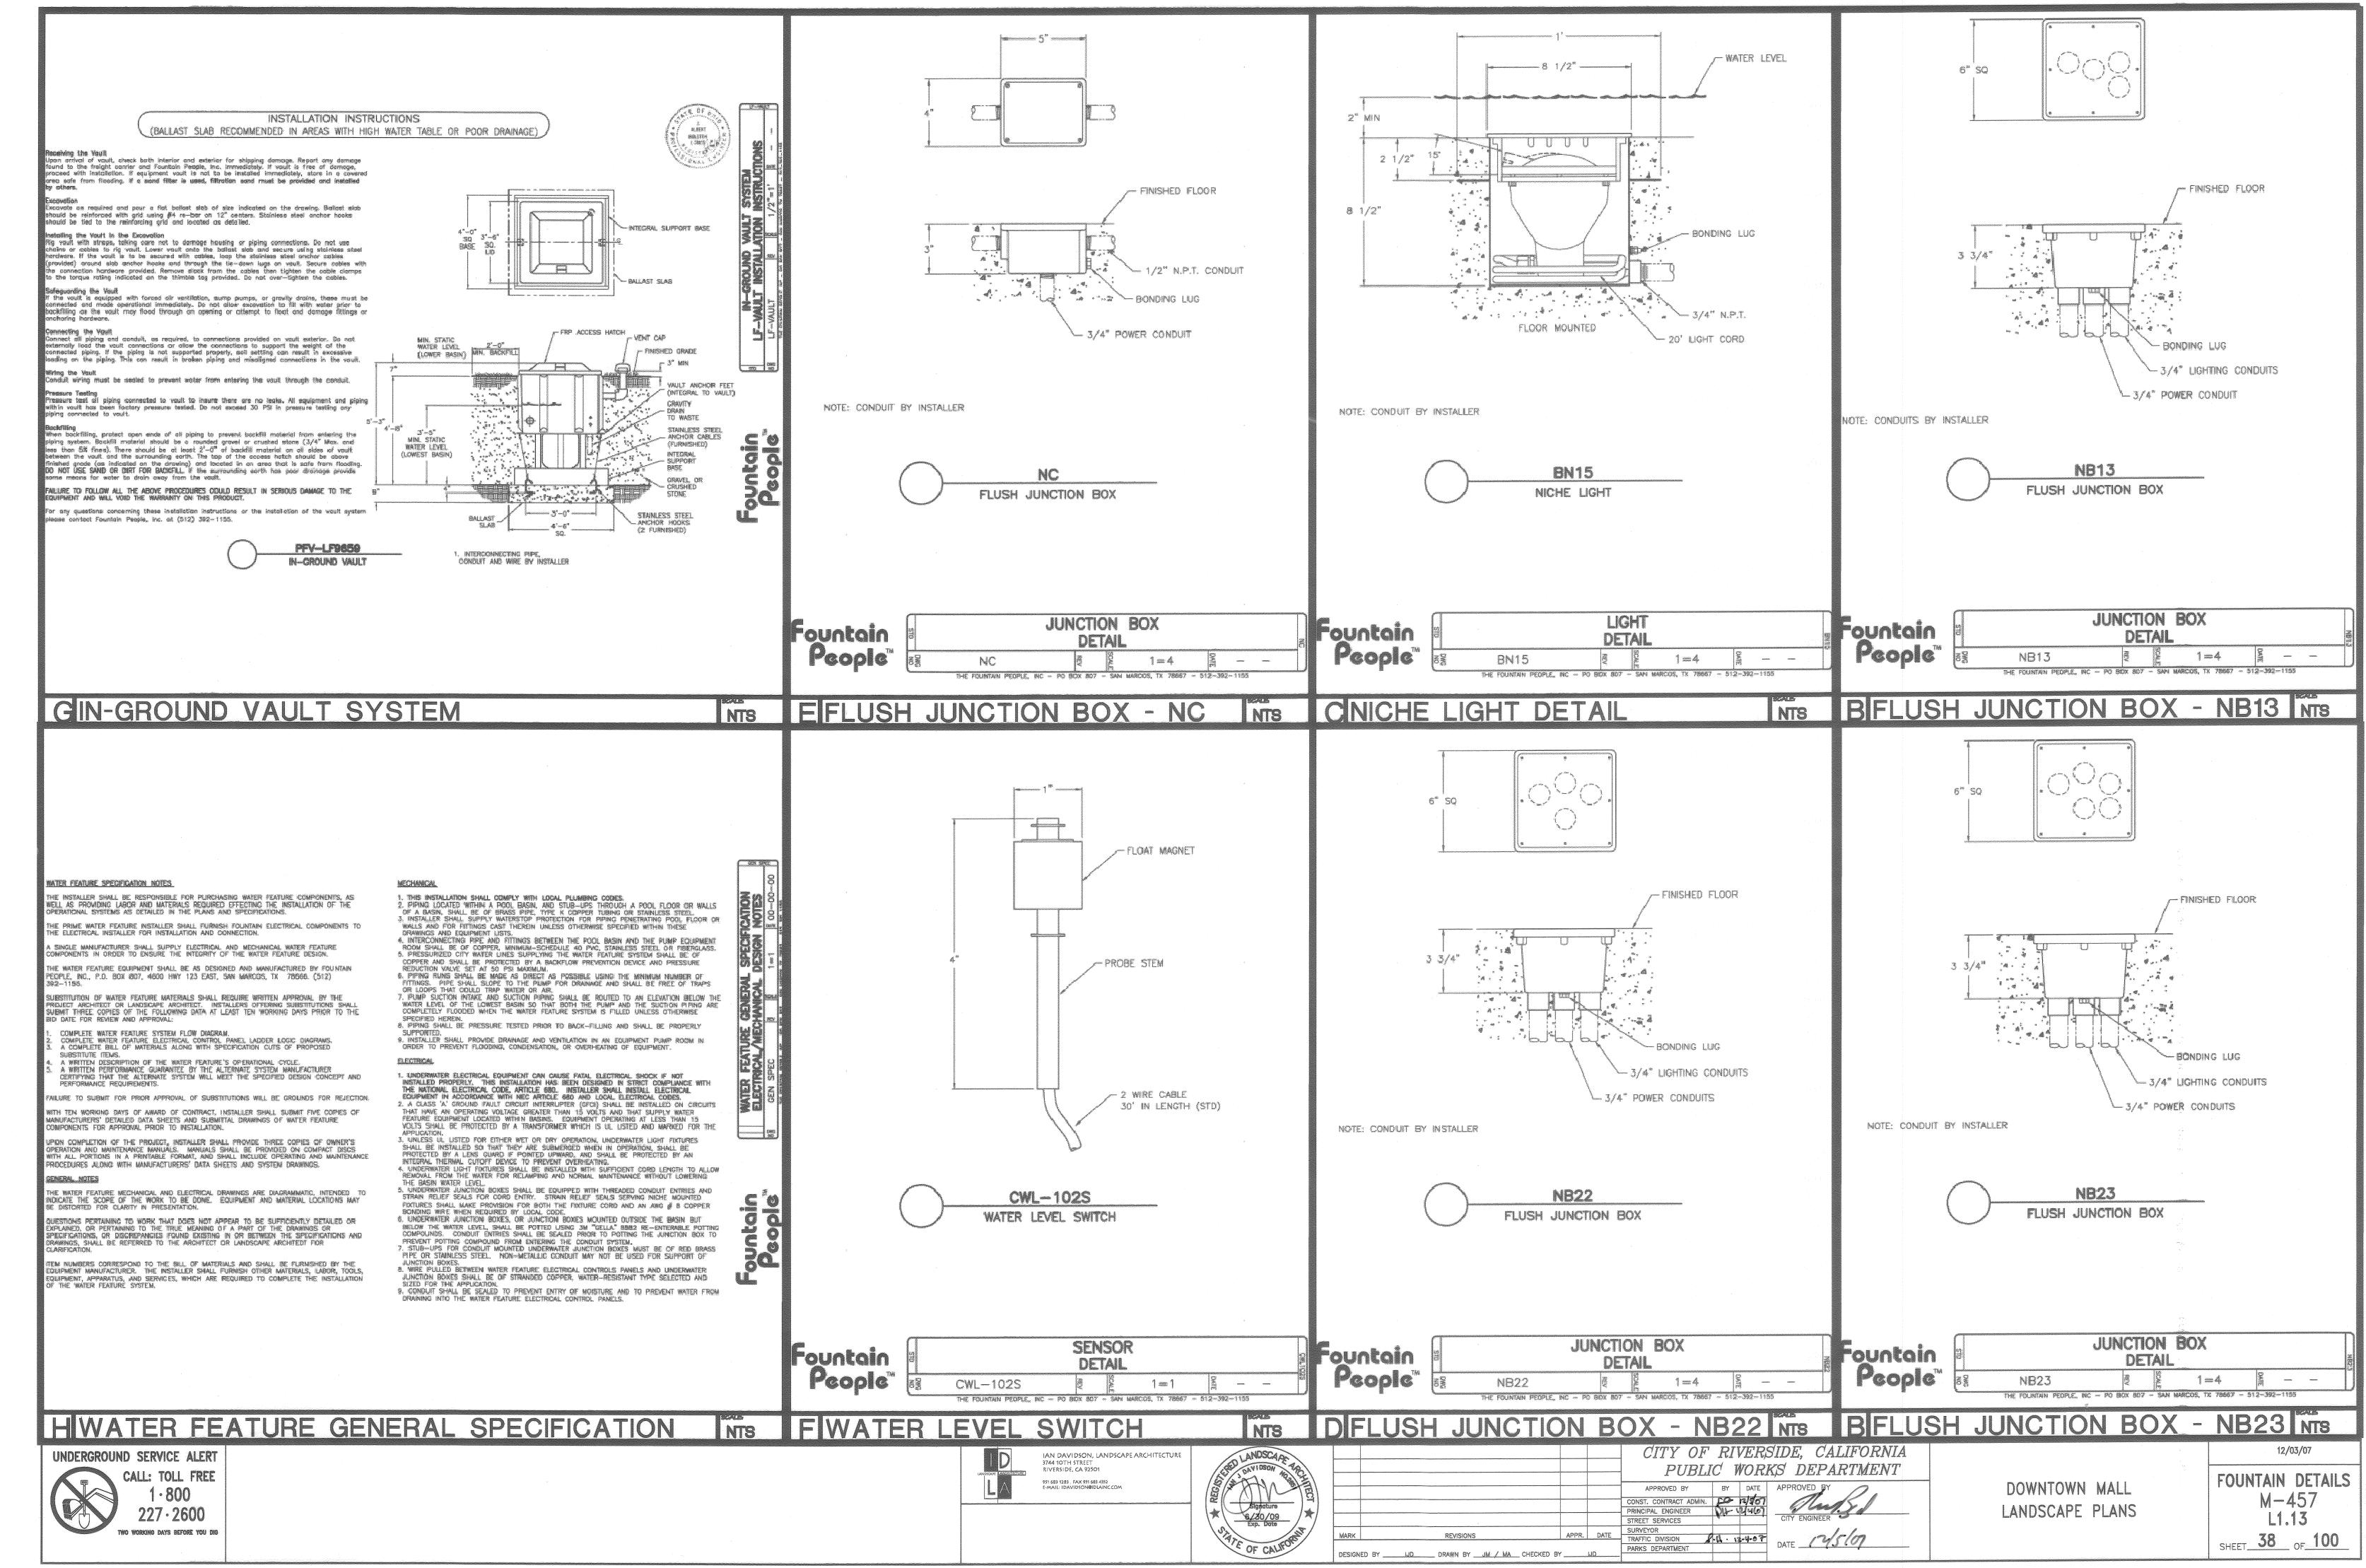


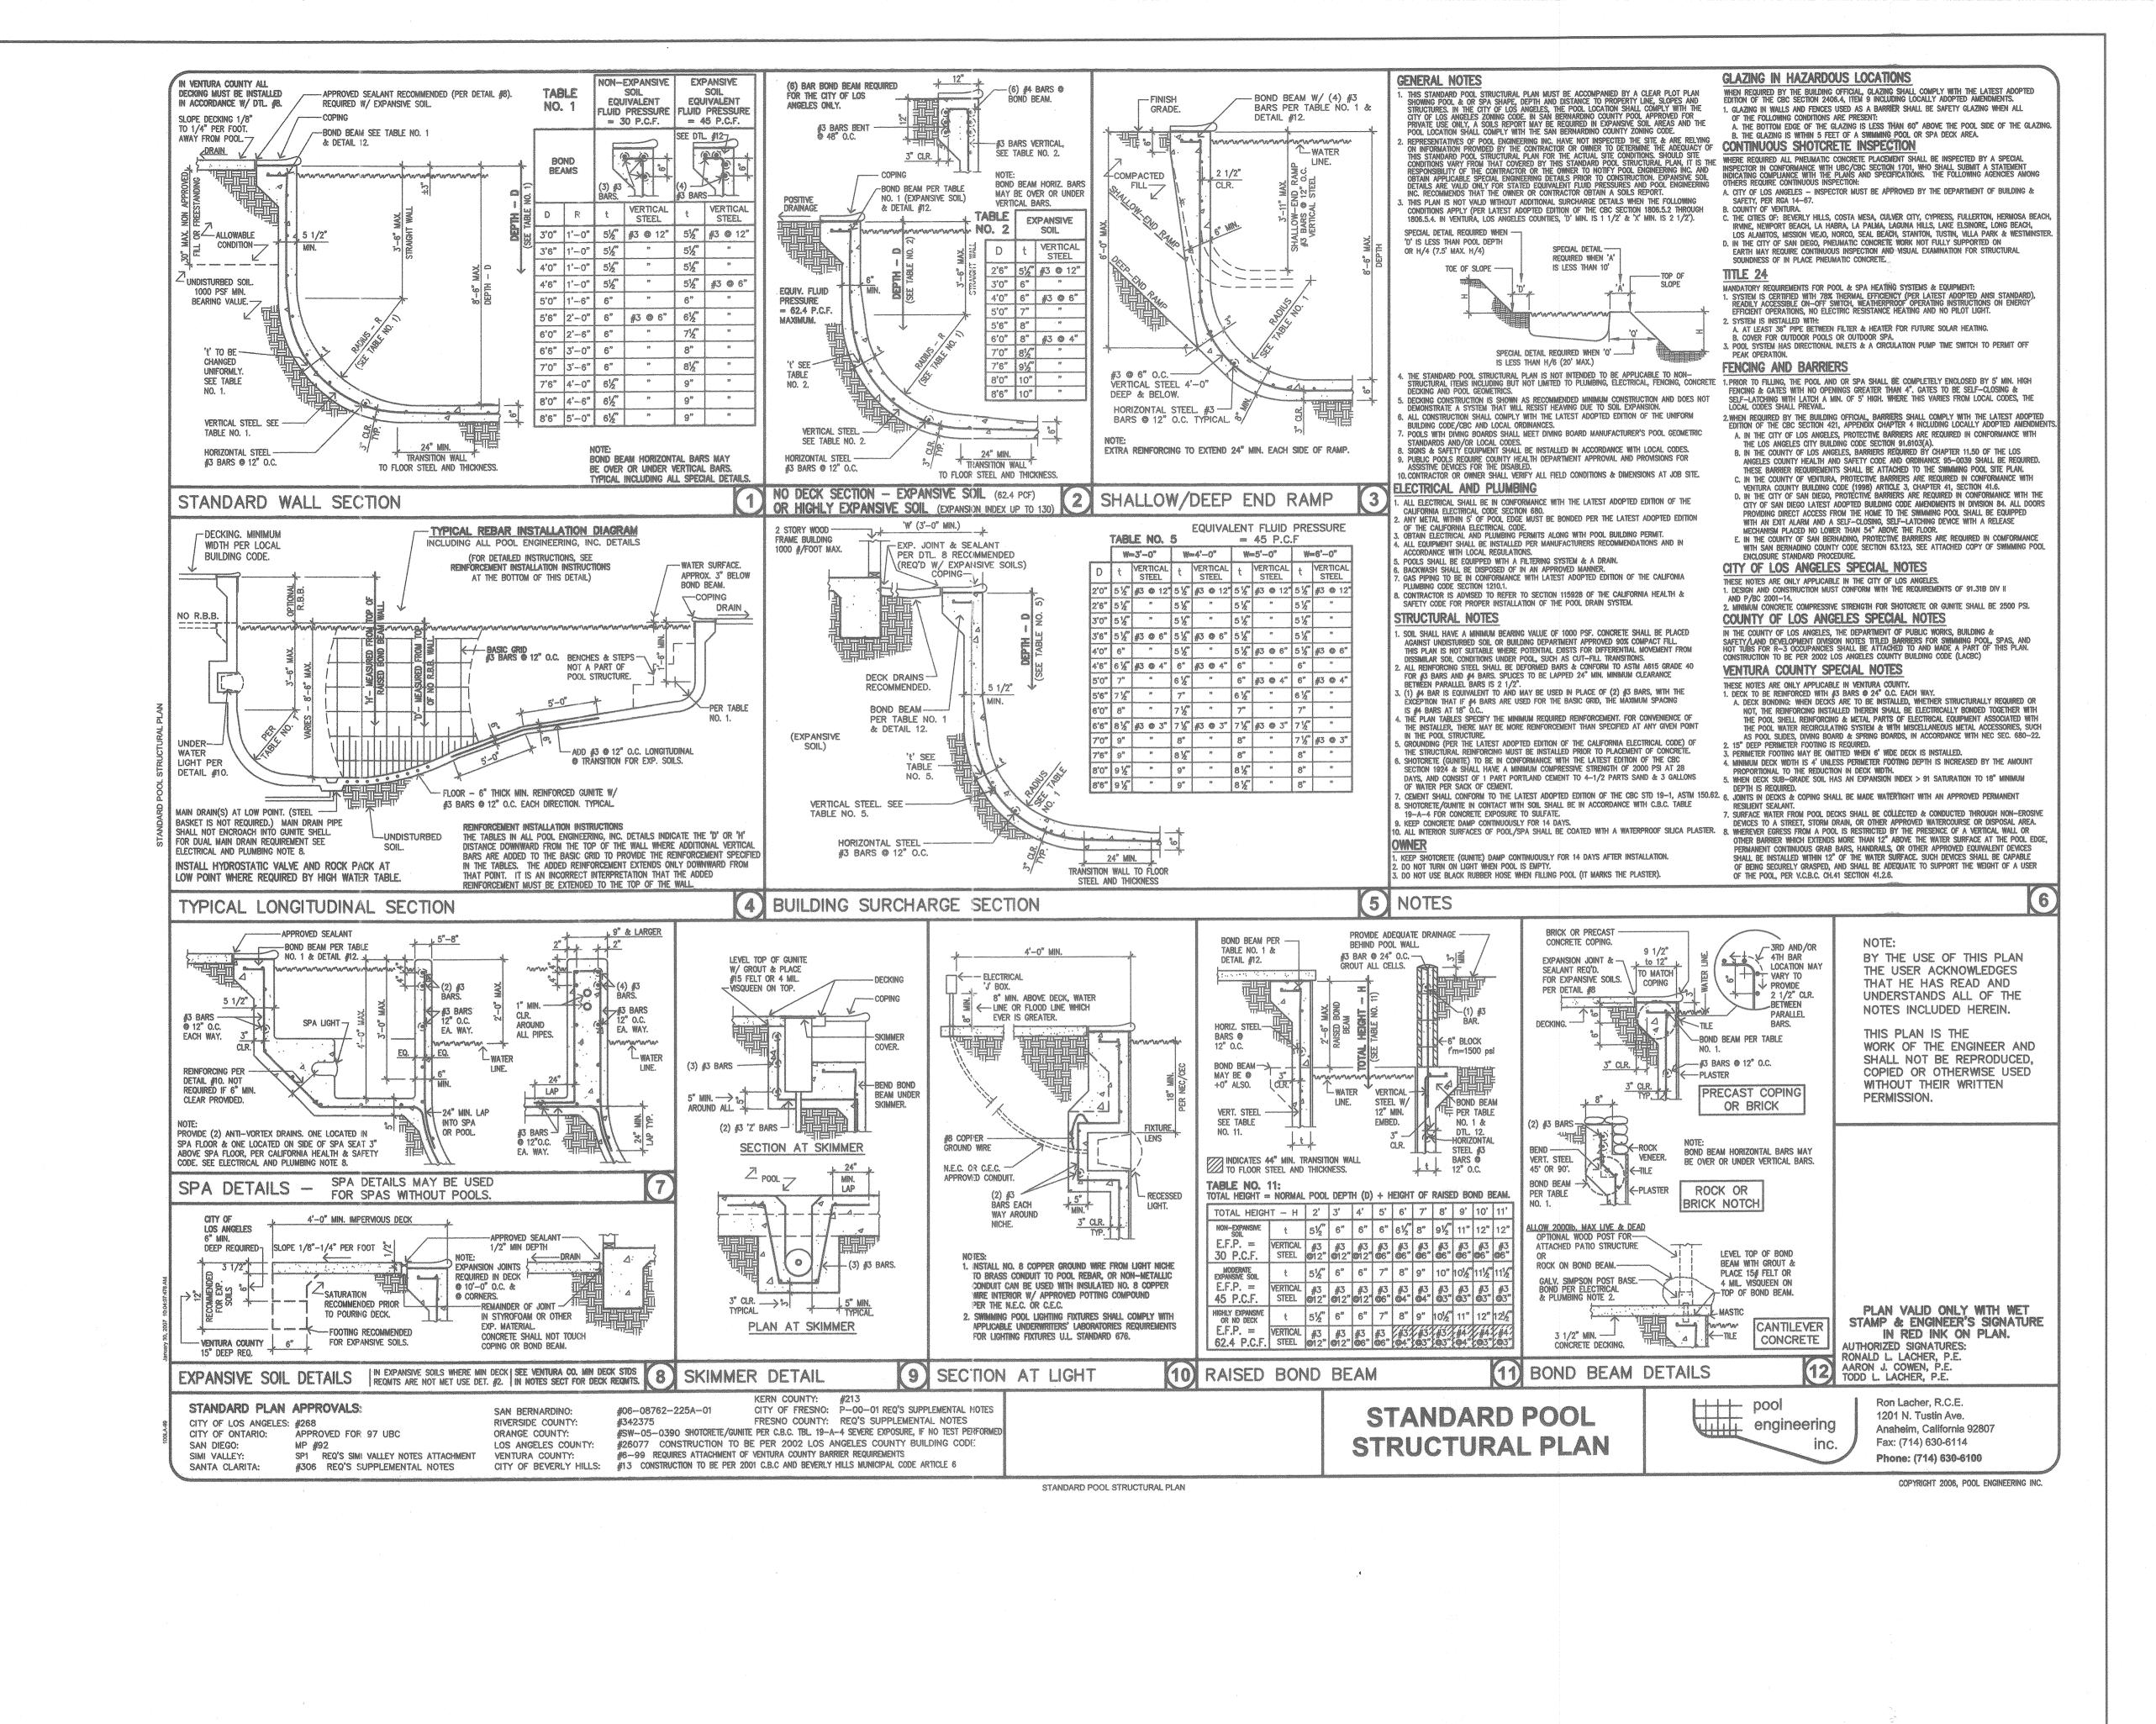





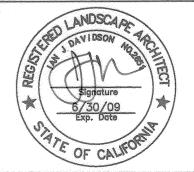

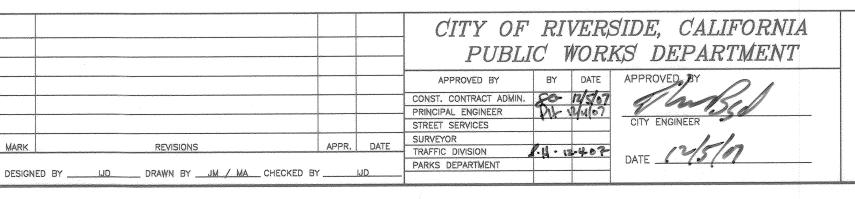


DOWNTOWN MALL LANDSCAPE PLANS 12/03/07

STRUCTURAL DETAILS

M-457

L1.14

SHEET 39 OF 100

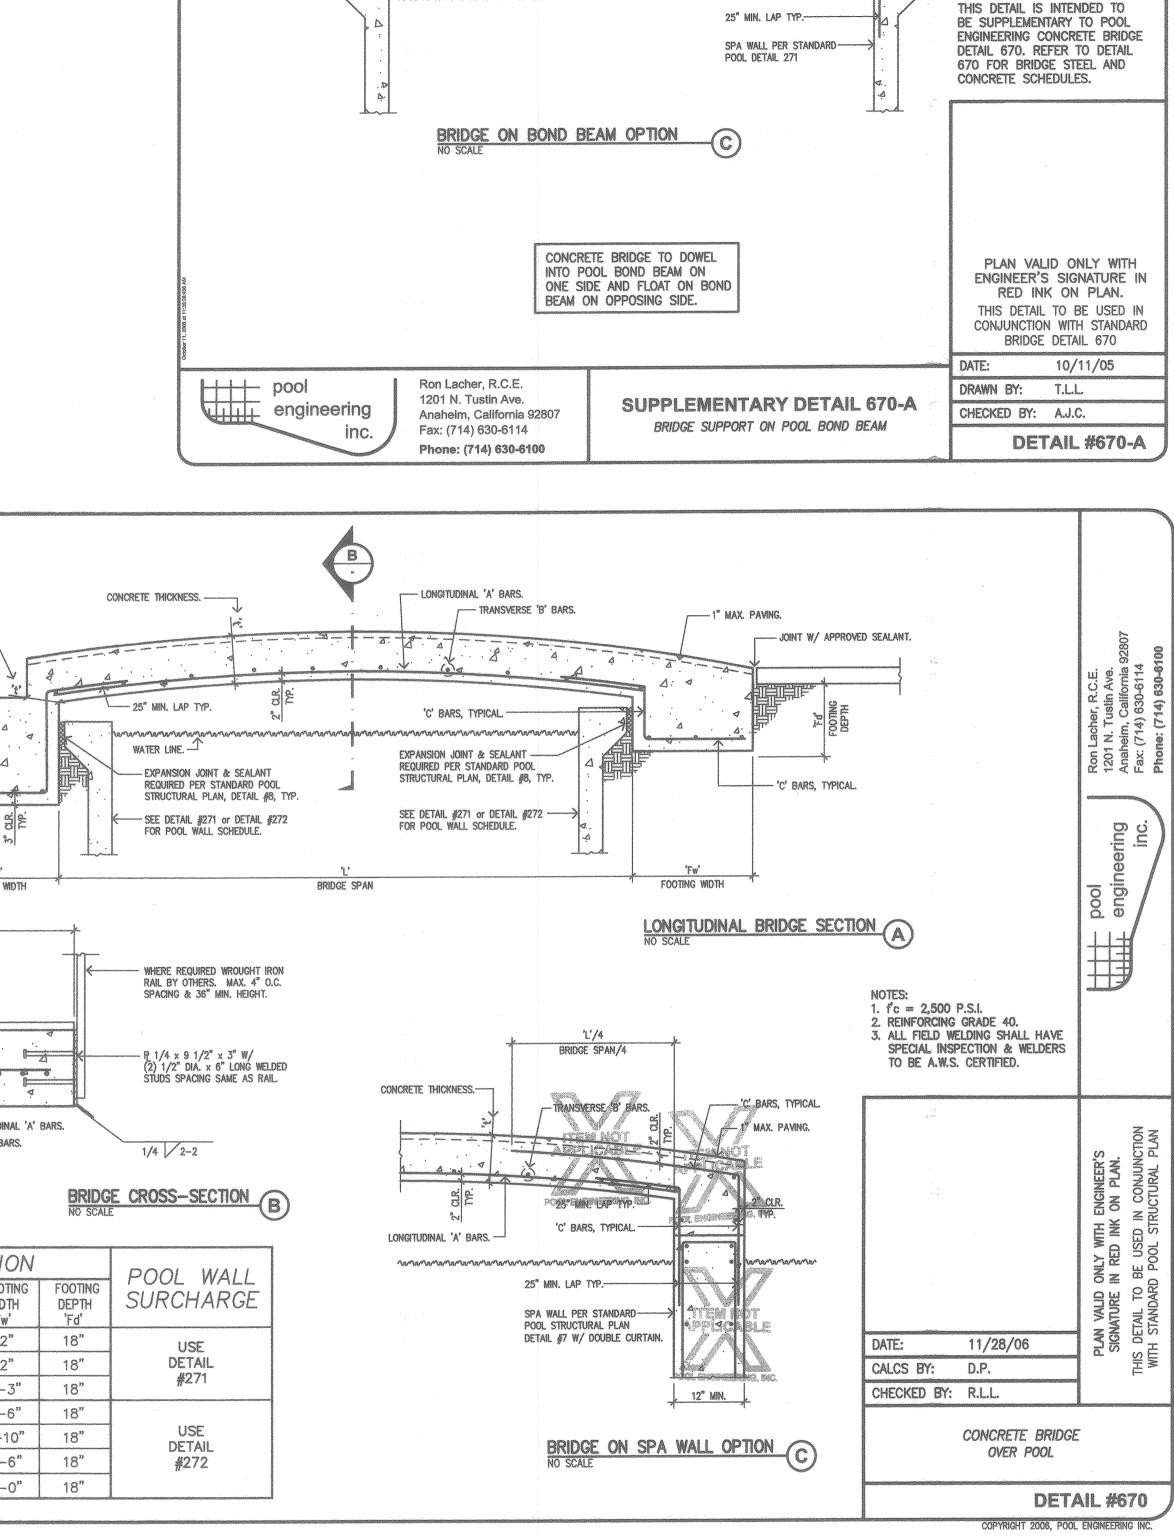

8'-0" MAX. SPAN

CONCRETE THICKNESS.


-TRANSVERSE 'B' BARS.

PLACE 15# FELT OR — 4 MIL. VISQUEEN ON TOP OF BOND BEAM.

TRANSVERSE 'B' BARS.


'A' BAR DOWELS INTO -POOL BOND BEAM

___1" MAX. PAVING.

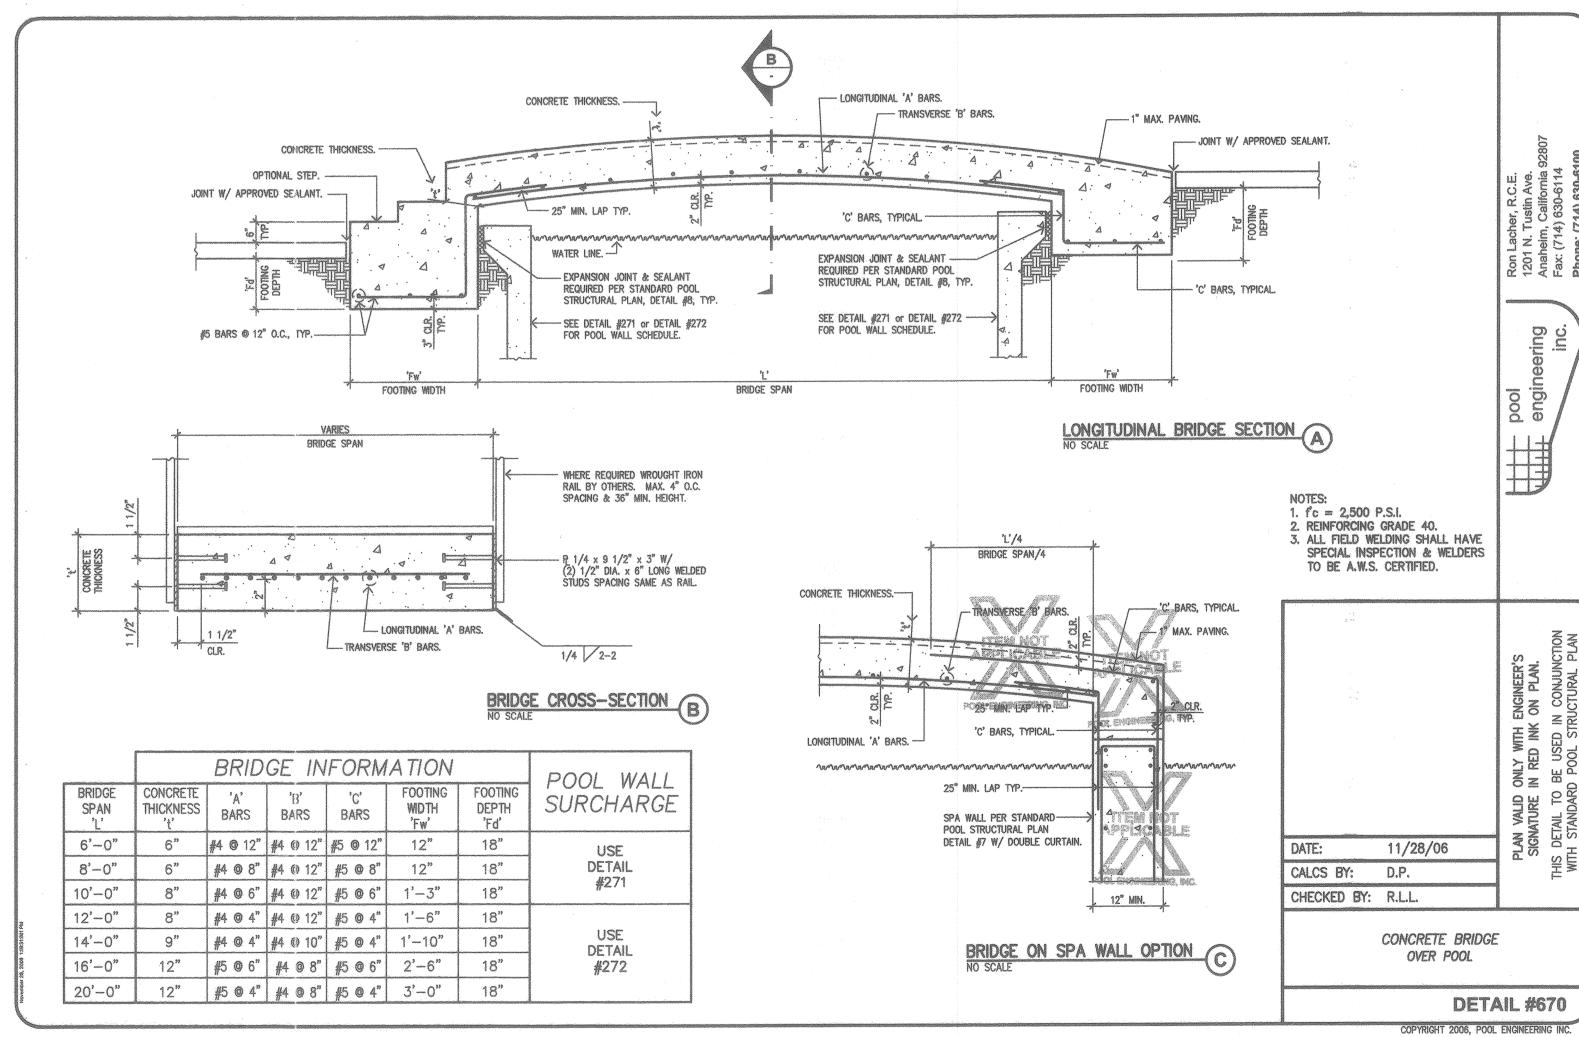






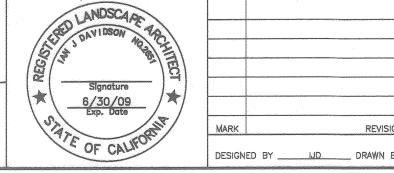

				CITY OF RIVERSIDE, CALIFORNIA PUBLIC WORKS DEPARTMENT
				APPROVED BY CONST. CONTRACT ADMIN. PRINCIPAL ENGINEER STREET SERVICES BY DATE APPROVED BY CITY ENGINEER CITY ENGINEER
MAR	REVISIONS GNED BY	APPR,	DATE UD	SURVEYOR TRAFFIC DIVISION PARKS DEPARTMENT DATE 12/5/07

DOWNTOWN MALL LANDSCAPE PLANS


12/03/07 STRUCTURAL DETAILS M - 457SHEET 40 OF

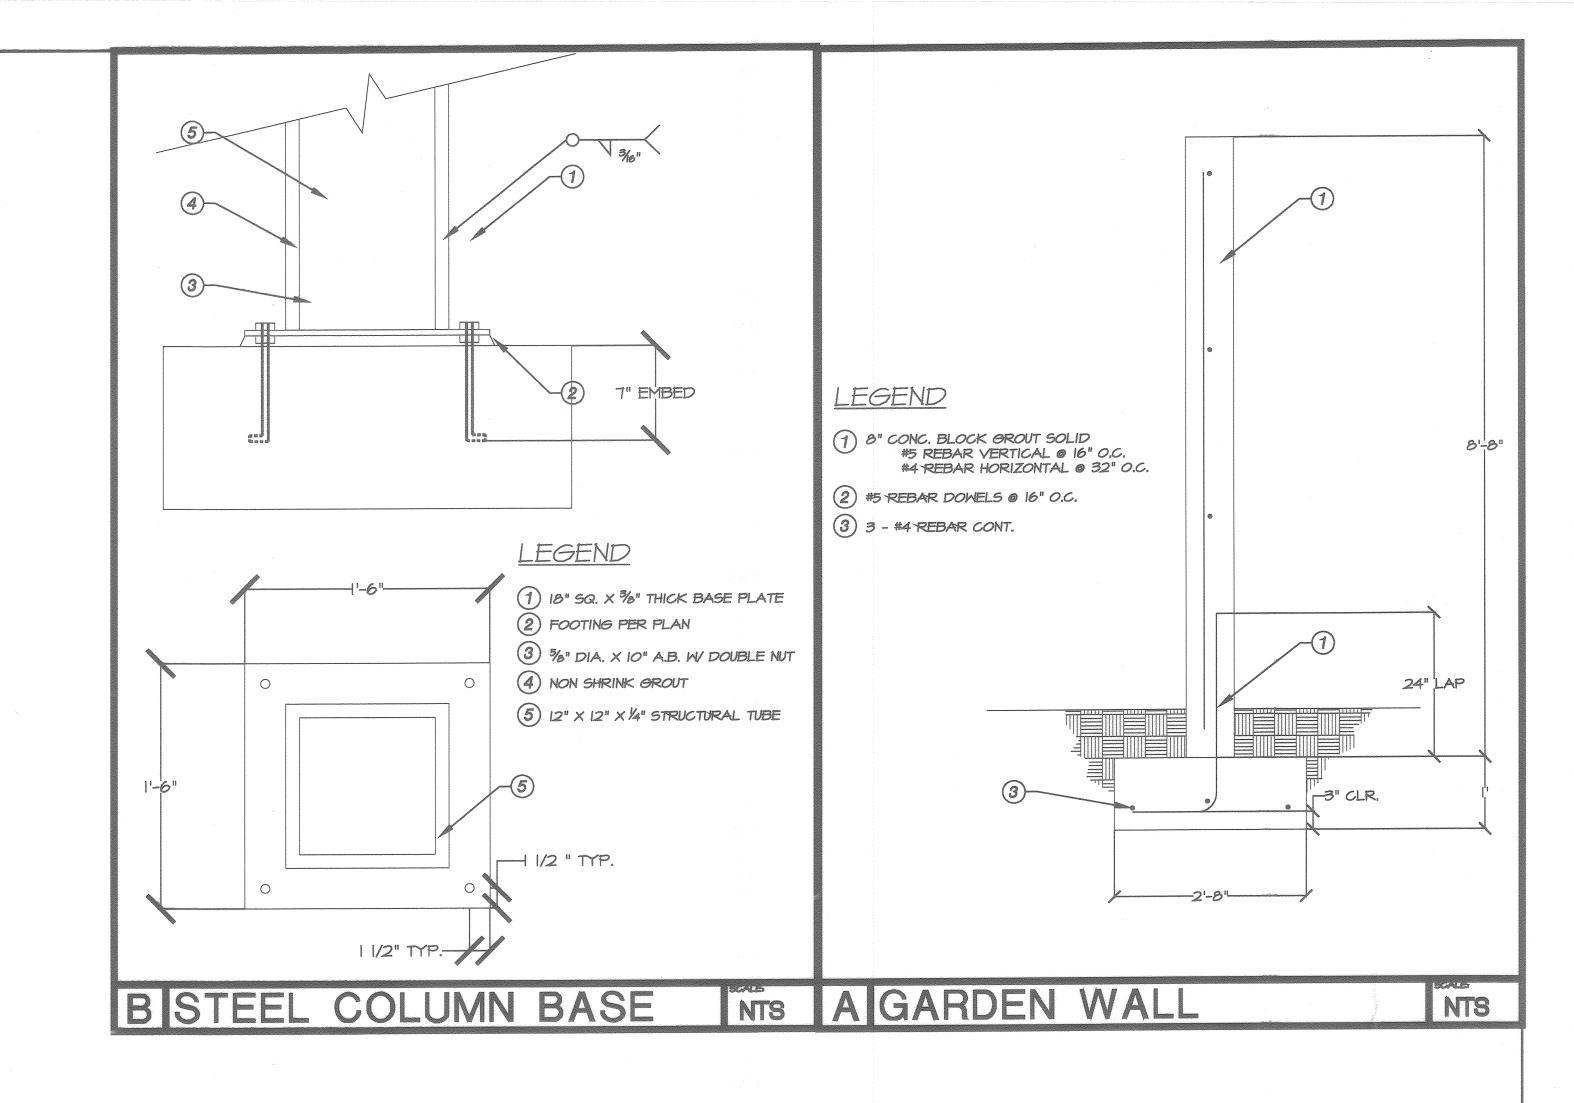

UNDERGROUND SERVICE ALERT
CALL: TOLL FREE
1 · 800
227 · 2600
TWO WORKING DAYS BEFORE YOU DIG

IAN DAVIDSON, LANDSCAPE ARCHITECTURE
3744 10TH STREET
RIVERSIDE, CA 92501


951 683 1283 . FAX 951 683 4352
E-MAIL: IDAVIDSON@IDLAINC.COM

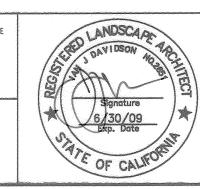


						SIDE, CALIFORNIA KS DEPARTMENT
				APPROVED BY CONST. CONTRACT ADMIN. PRINCIPAL ENGINEER STREET SERVICES	BY DATE	APPROVED BY CITY ENGINEER
MARK DESIGNED BY	REVISIONS JD DRAWN BY JM / MA	APPR.	DATE	SURVEYOR TRAFFIC DIVISION PARKS DEPARTMENT	1.4. 12.4.67	DATE 145/01

DOWNTOWN MALL
LANDSCAPE PLANS

STRUCTURAL DETAILS
M-457
L1.16
SHEET 41 OF 100

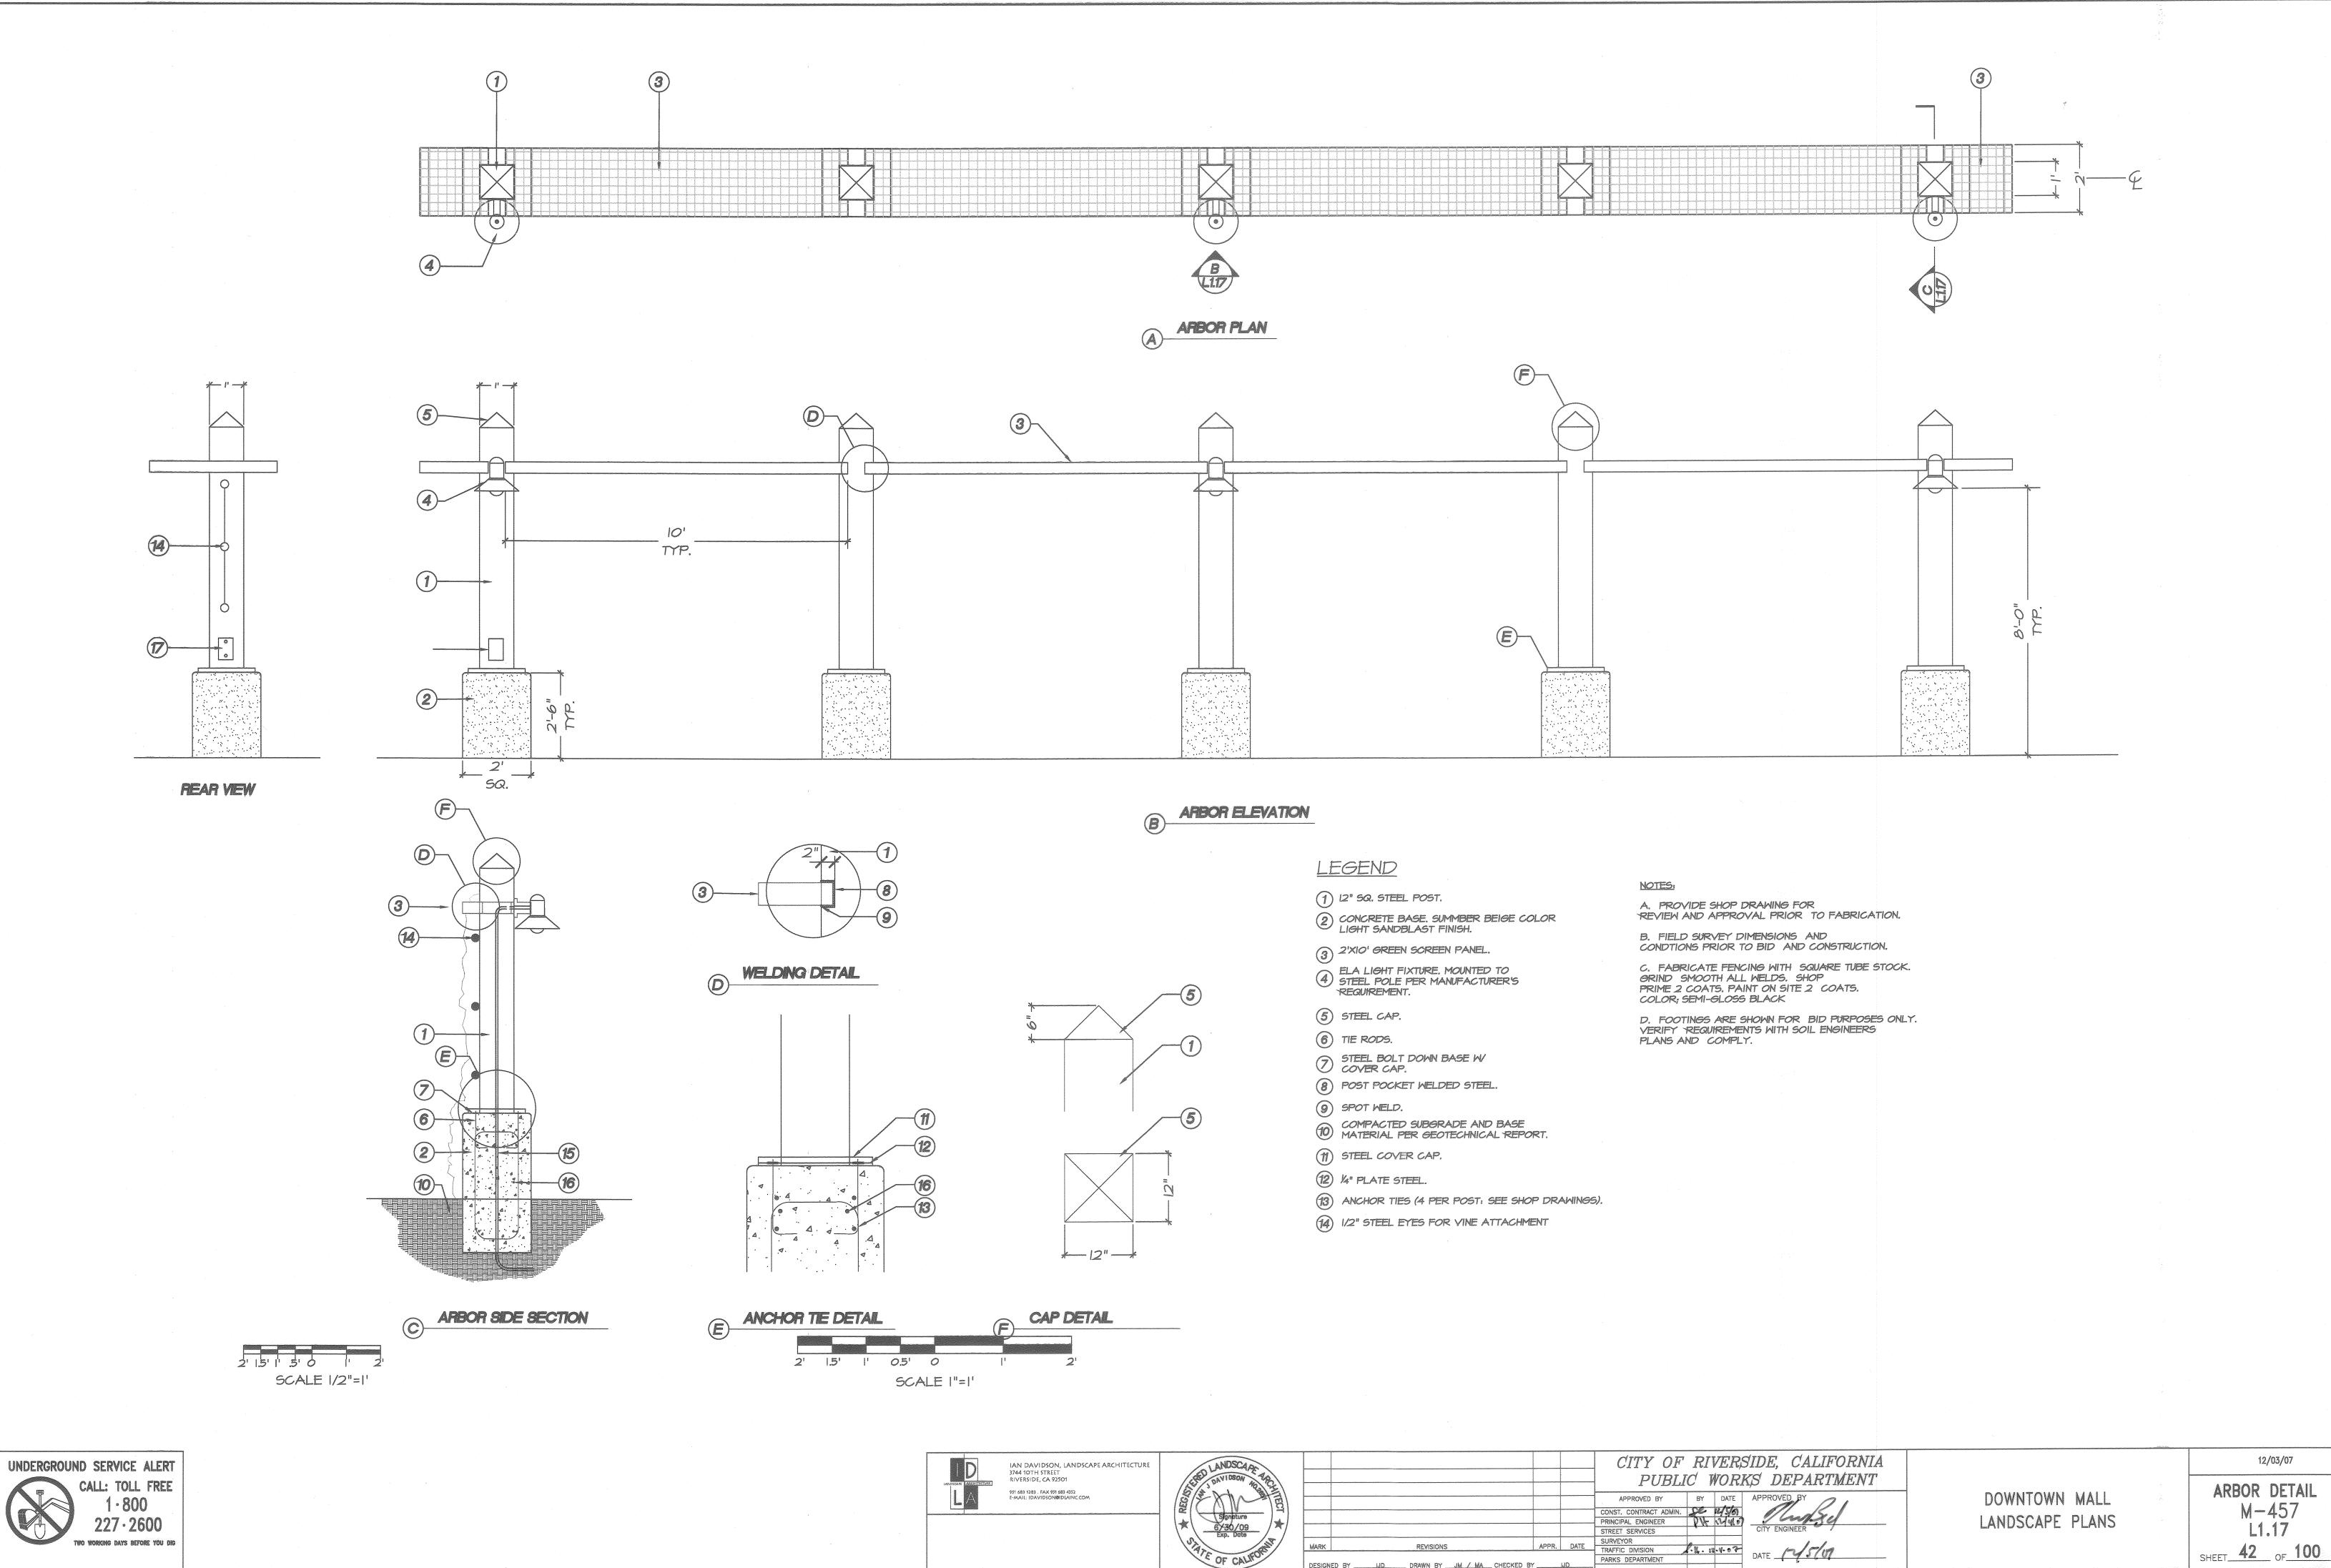

DESIGNED BY ______ DRAWN BY __JM / MA __CHECKED BY ______ JD__

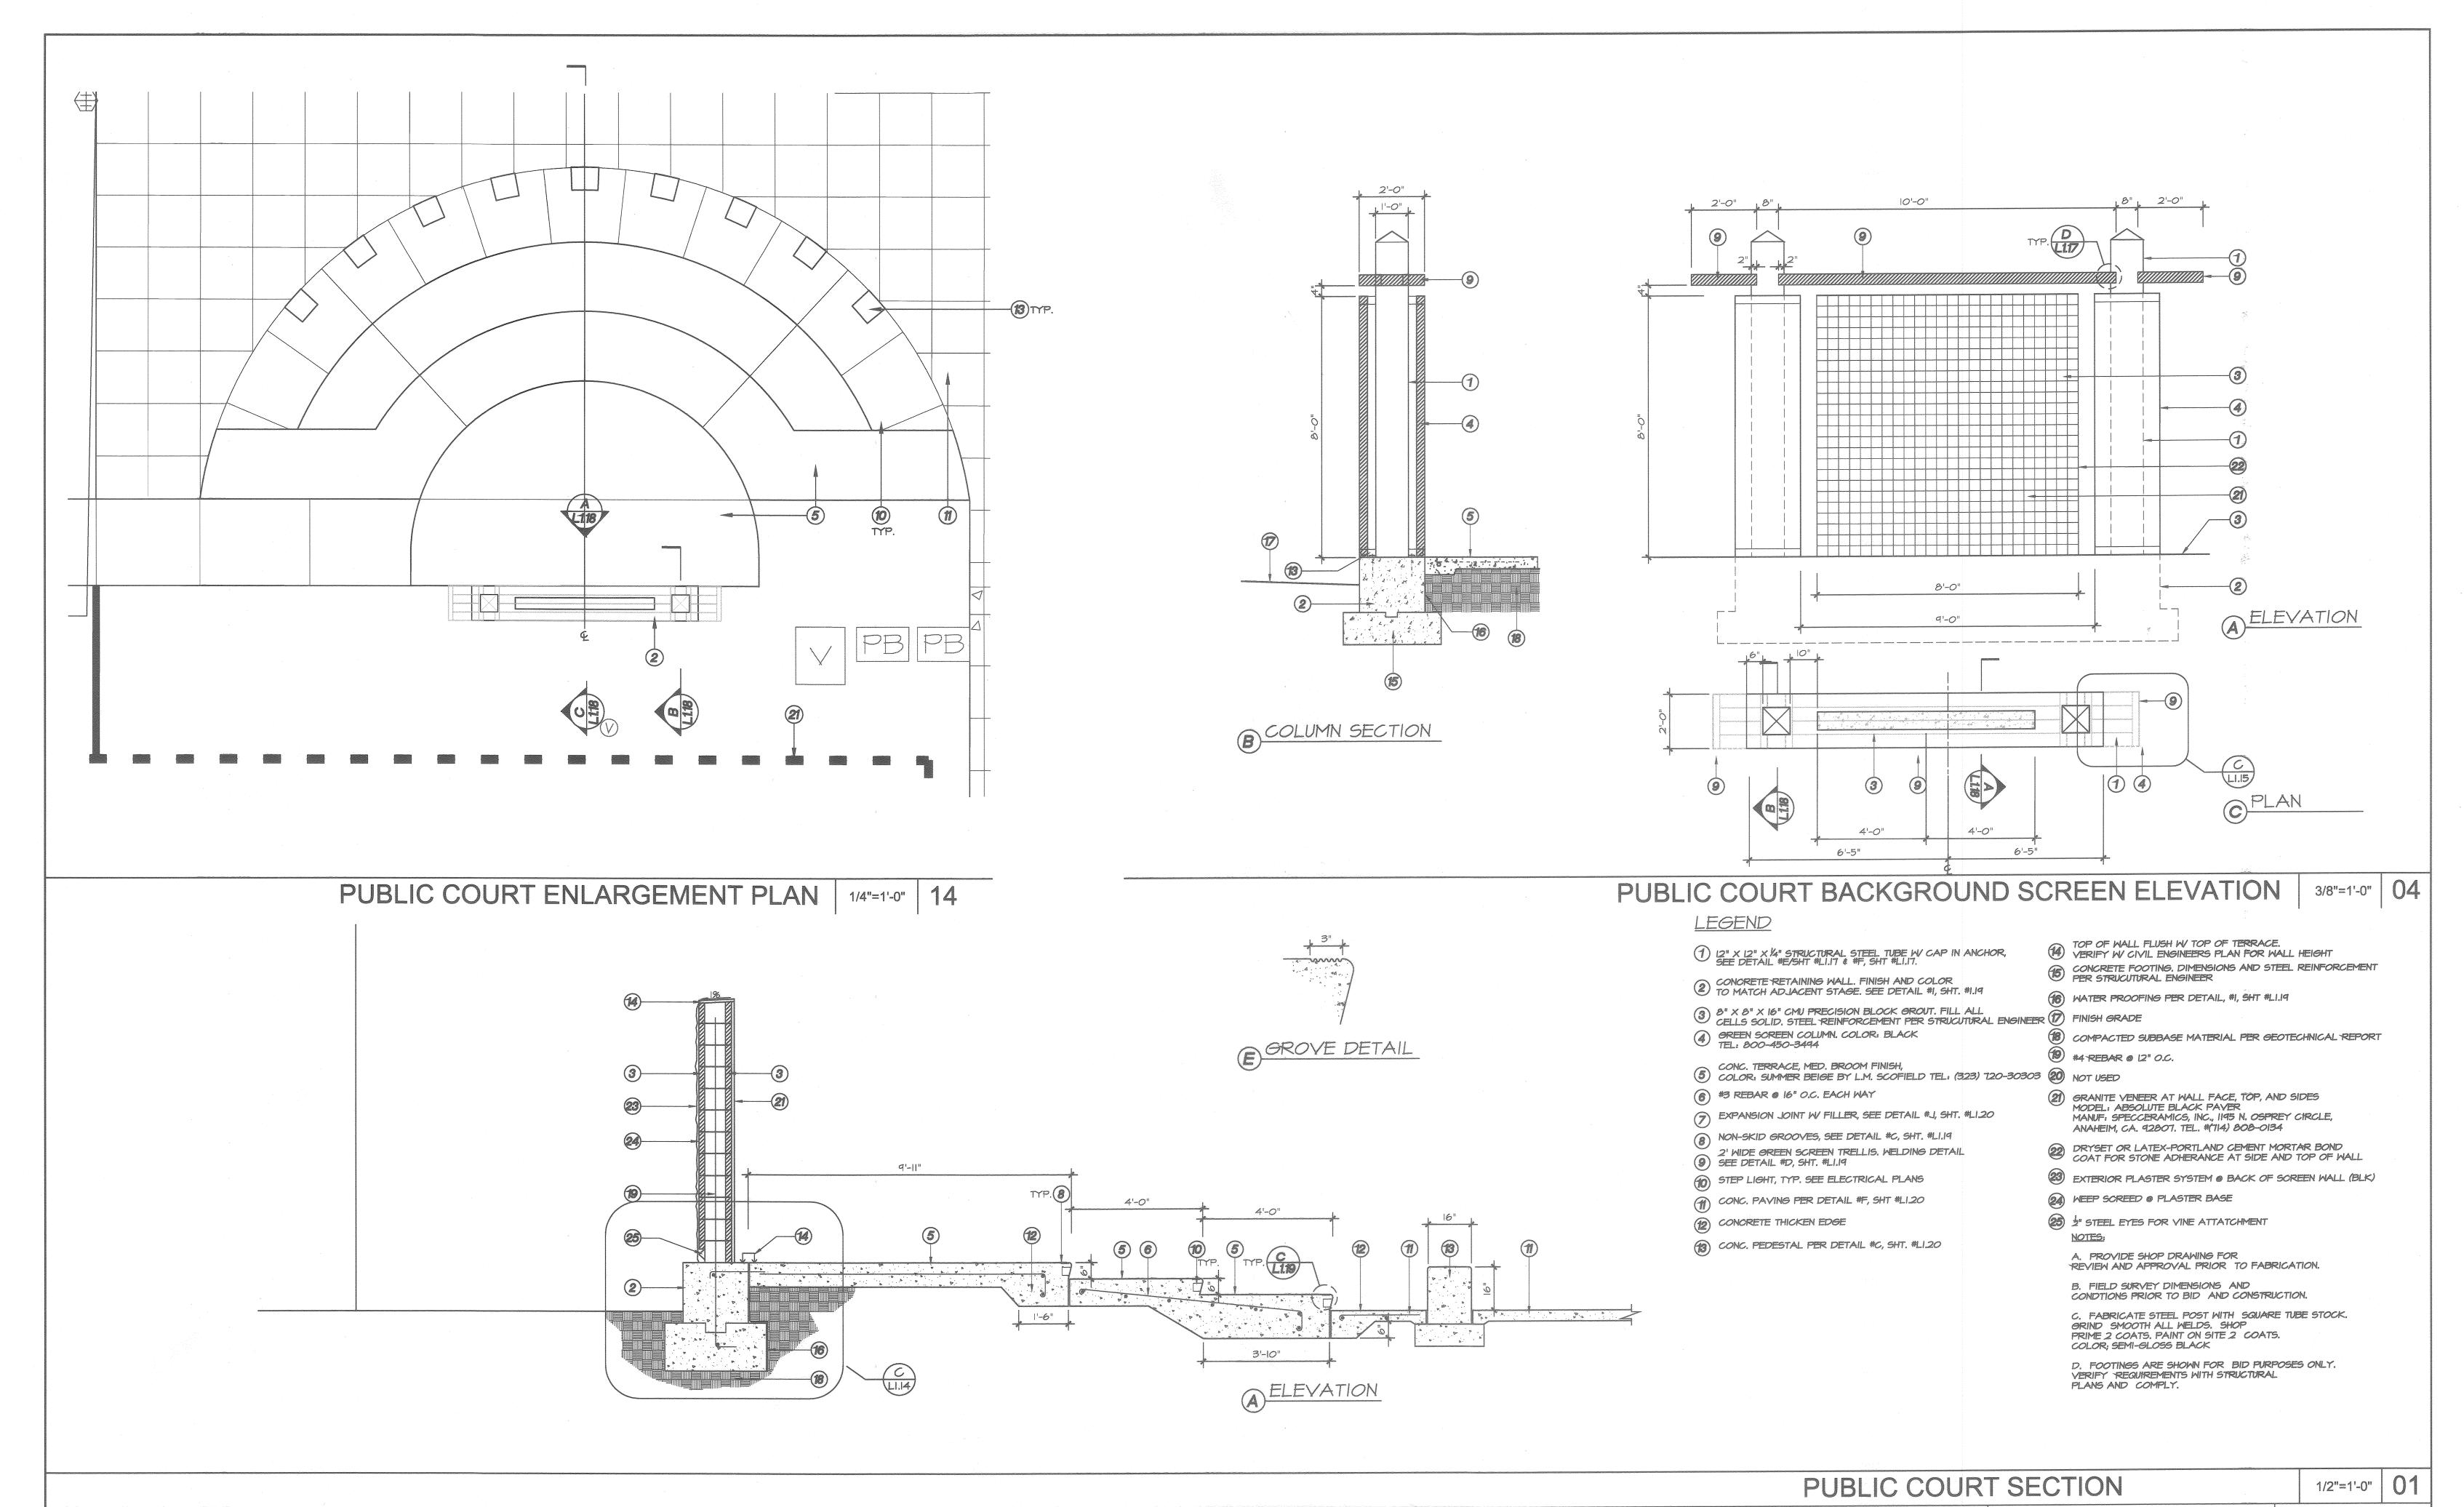

UNDERGROUND SERVICE ALERT CALL: TOLL FREE

IAN DAVIDSON, LANDSCAPE ARCHITECTURE
3744 10TH STREET RIVERSIDE, CA 92501 APPR. DATE SURVEYOR TRAFFIC DIVISION SURVEYOR DATE /45/07 DESIGNED BY ______ DRAWN BY ______ / MA __ CHECKED BY _____

PUBLIC WORKS DEPARTMENT DOWNTOWN MALL APPROVED BY

CONST. CONTRACT ADMIN.

PRINCIPAL ENGINEER

STREET SERVICES

BY DATE APPROVED BY

CITY ENGINEER


CITY ENGINEER LANDSCAPE PLANS


CITY OF RIVERSIDE, CALIFORNIA


PUBLIC COURT M - 457

SHEET 43 OF 100

12/03/07

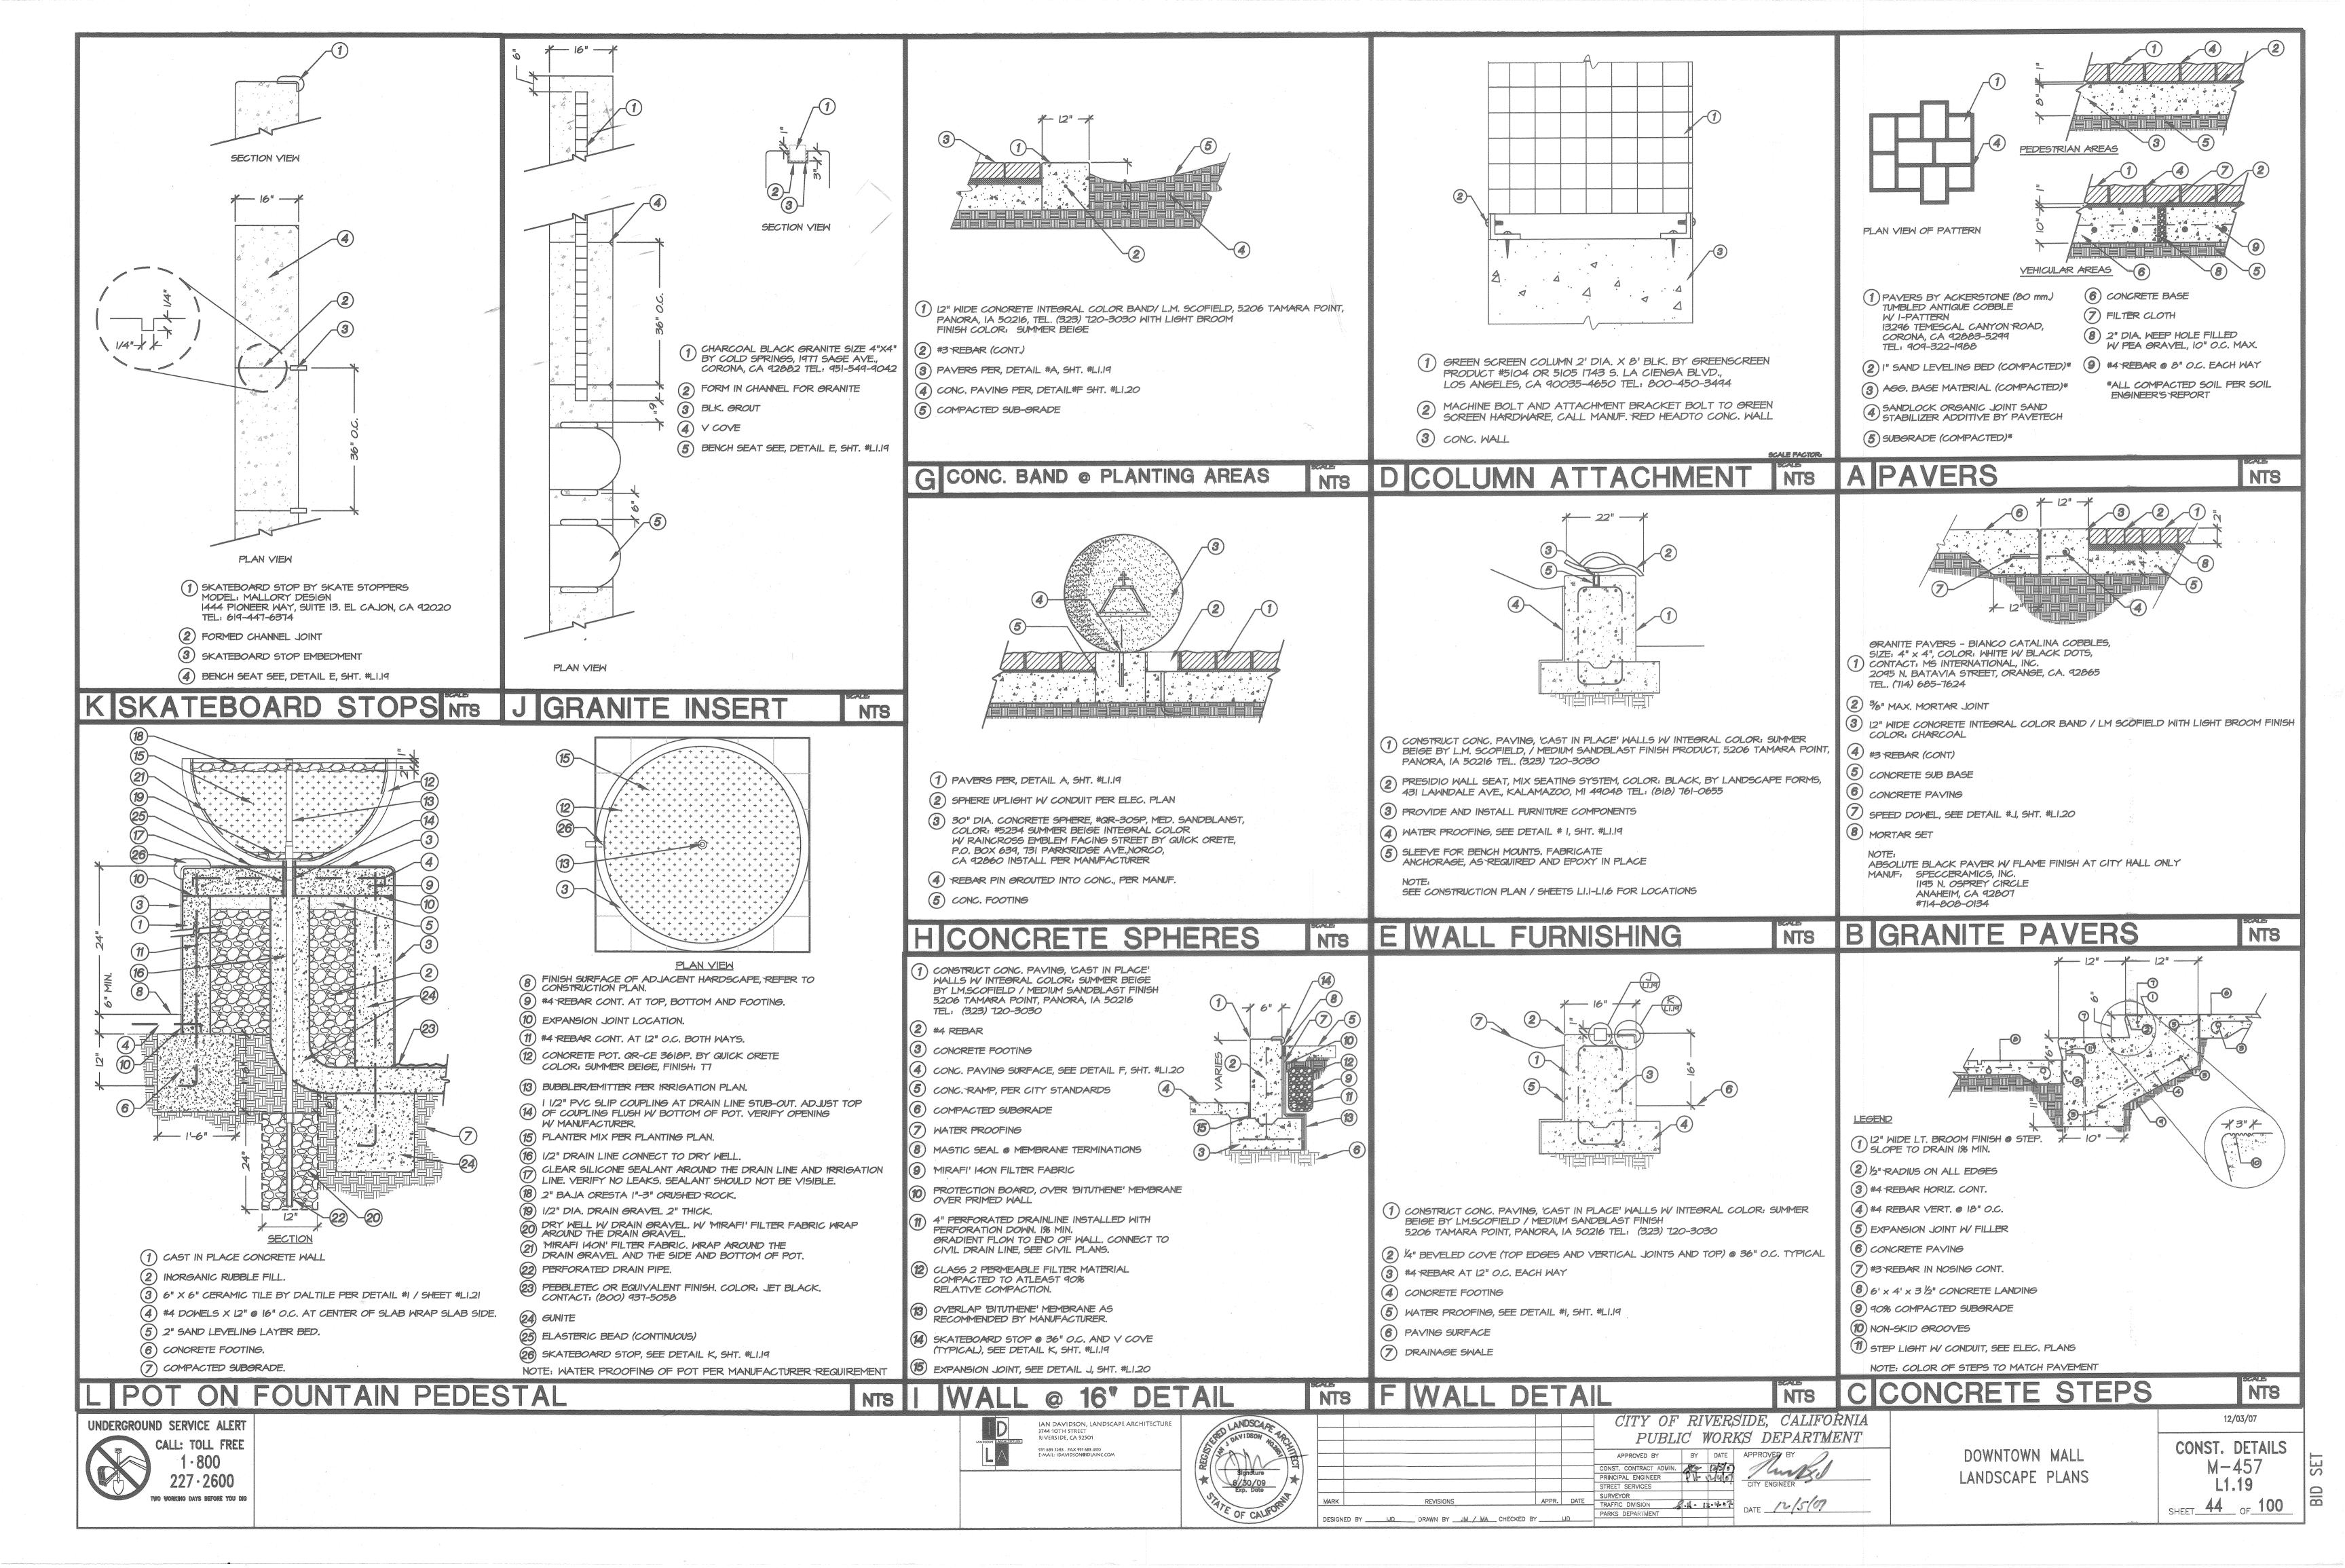

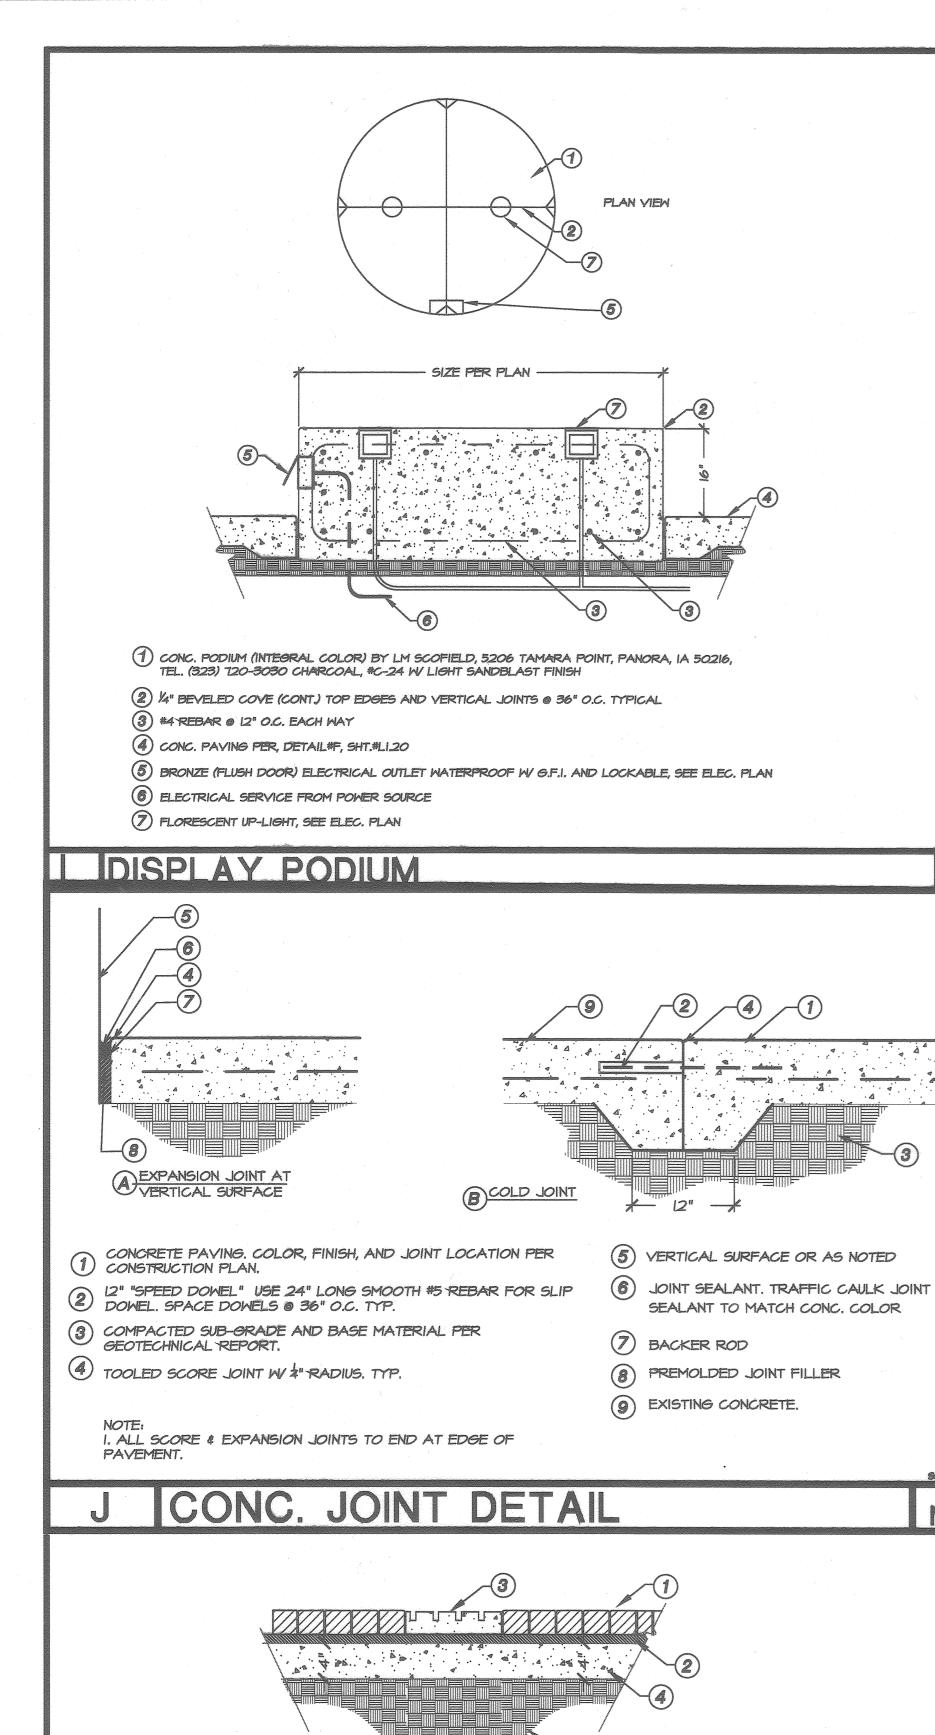

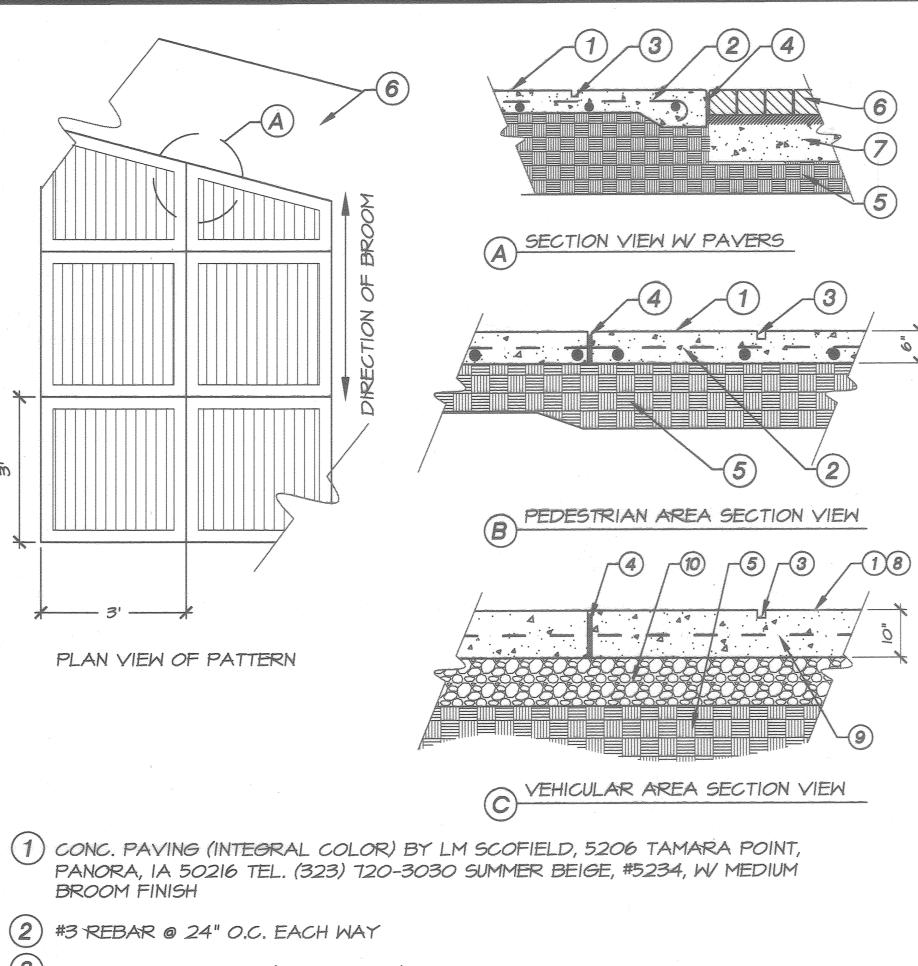

- 3) TOOLED SCORE LINE (3' X 3' ORID)
- 4 EXPANSION JOINT W FILLER @ 15' O.C. EACH WAY, PER DETAIL J, SHT. #LI.20
- (5) 90% COMPACTED SUB-GRADE
- (6) PAVER PER, DETAIL A, SHT.# LI.19
- (7) CONC. SUB BASE

NTS


- 8 6" THK. P.C.C. PAVEMENT 2500 PSI @ 28 DAYS
- 9 #4 REBAR @12" O.C. EXP. JT. TO HAVE 12" LONG SPEED DOWEL 24" O.C. 12" LONG SPEED DOWEL 24" O.C.
- (10) 6" CL-II AGG. BASE PER STRUCTURAL SOILS REPORT
- USE #C-24 CHARCHOAL W/ MED. BROOM FINISH
- FOR CALL OUT # 25
- (5) COMPACTED SUBGRADE (6) EXPANSION JOINT, SEE DETAIL #J, SHT. #LI.20

(4) CONC. PAVING PER DETAIL F, SHT# LI.20


- ONSTRUCT (CAST IN PLACE) CONC. BENCH W INTEGRAL COLOR: SUMMER BEIGE #5234, BY L.M. SCOFIELD COMPANY, 5206 TAMARA POINT, PANORA, IA 50216, TEL. (323) 720-3030 MED. SANDBLAST FINISH
- (2) 1/4" BEVEL (ALL EDGES)
- (3) #4 REBAR @ 12" O.C. (4) CONC. PAVING PER DETAIL F, SHT# LI.20
- (5) COMPACTED SUBGRADE
- (6) EXPANSION JOINT, SEE DETAIL #J, SHT. #LI.20

LEGEND

- (1) 3" STEEL BALL
- (2) BLACK EDGE (3) WHITE LETTERING
- (4) RED BACKGROUND
- (5) BACK OF SIGN COLOR: BLACK
- 6 2" X 2" STEEL POST COLOR: BLACK
- (7) CONCRETE FOOTING

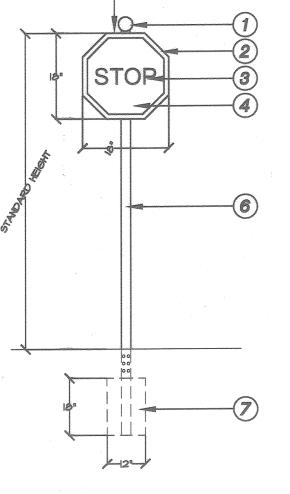

A CUSTOM STOP SIGN C SEAT WALL NTS

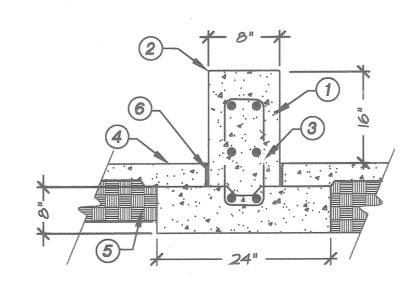

- (1) 12" WIDE CONCRETE INTEGRAL COLOR BAND/ L.M. SCOFIELD, 5206 TAMARA POINT, PANORA, IA 50216 TEL. (323)720-3030 WITH LIGHT BROOM FINISH COLOR: CHARCOAL, #C-24 ONSTRUCT (CAST IN PLACE) EXPOSED AGOREGATE CONC. WALL (TO MATCH EXISTING)
 - (2) #3 REBAR (CONT.)
 - (3) ORANITE PAVERS PER, DETAIL #B, SHT. #LI.19
 - (4) CONC. PAVING PER, DETAIL#F, SHT. # LI.20
 - 5 6" THICK EDGE @ CONC. BAND
 - 6 COMPACTED SUB-GRADE
 - (7) #3 REBAR HOOK
 - 8 SPEED DOWEL, SEE DETAIL #J, SHT. #LI.20

F CONCRETE PAVING 3' X 3' GRID





D EX. AGG. SEAT WALL

(2) 1/4" BEVEL (ALL EDGES,

(3) #4 REBAR @ 12" O.C.

NTS B CONC. BAND @ PAVING NTS

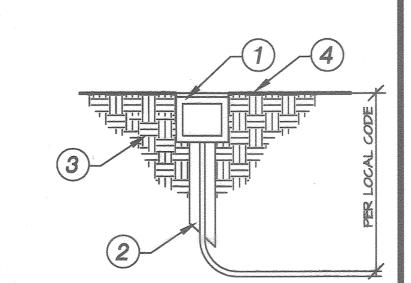


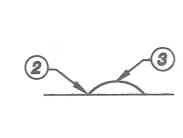

TEL. (973)-541-6691

(2) EPOXY TO PAYING SURFACE

(3) CONC. PAVING, SEE DETAIL #F, SHT. LI.20

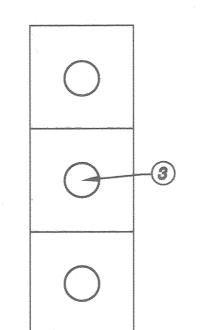


- 1 POT SEE PLANTING PLAN AND POT SCHEDULE WATERPROOF PRIOR TO PLANTING
- 2 OF PEA GRAVEL
- (3) COMPACTED SUBORADE

LEGEND

- 3" SCH. 40 PVC PIPE TO 12" DIA., 18" DEEP DRAINAGE SUMP
- DRAINAGE SUMP W DRAIN GRAVEL W

 'MIRAFI'FILTER FABRIC WRAP AROUND
 THE DRAIN GRAVEL
- (6) I" BUSHING SEALED W SILICON TO POT
- (7) CONCRETE SEE CONSTRUCTION PLAN
- (8) SEE IRRIGATION PLAN FOR TUBING SPECS.
- (9) SEE IRRIGATION PLAN FOR NOZZLE TYPE

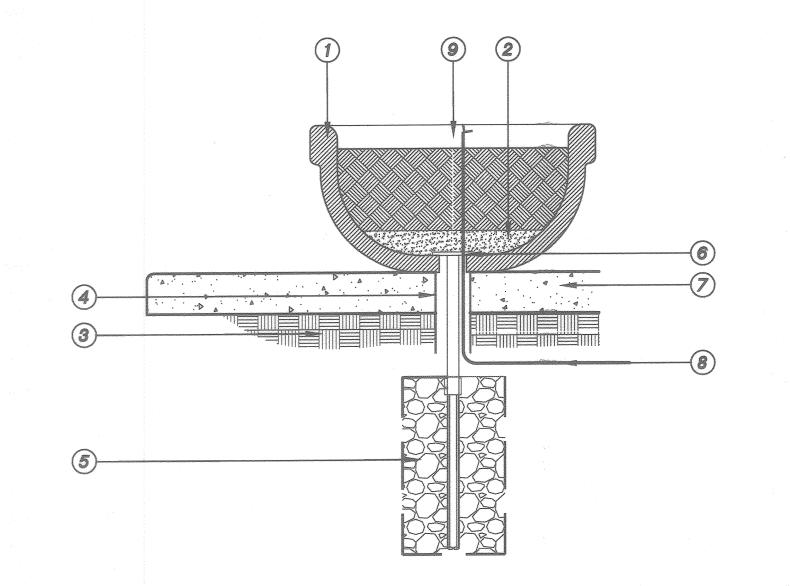

1 ORANITE PAVERS BY COLD SPRINGS ORANITE, SIZE: 3" x 3", COLOR: CHARCOAL BLACK, 1977 SAGE AVE., CORONA, CA 92882 TEL: (951) 546-9042

(3) SAW CUT GROVES, COLOR: SUMMER BEIGE BY L.M. SCOFIELD

- (2) SANDLOCK ORGANIC JOINT SAND STABILIZER ADDITIVE BY PAVETECH
- (4) CONCRETE SUB BASE
- (5) COMPACTED SUB-BASE

NTS H LIGHT DETAIL

(4) FINISH GRADE

(1) FLORESCENT UP-LIGHT, TYP.


(3) COMPACTED SUB-GRADE

(2) CONDUIT OR DIRECT BURIAL ROMEX


NTS G TRAFFIC DOTS NTS E POT DETAIL



UNDERGROUND SERVICE ALERT CALL: TOLL FREE 227 - 2600

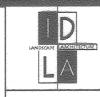

RIVERSIDE, CA 92501

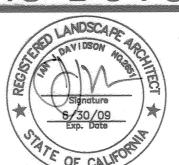

1) CERAMIC 6" BOTTS DOT, COLOR: BLACK, GLAZED FINISH PER CITY REQUIREMENT BY HY-VIZ'S

DESIGNED BY ______ DRAWN BY _____ / MA __ CHECKED BY _____

CITY OF RIVERSIDE, CALIFORNIA PUBLIC WORKS DEPARTMENT


8-4-12-4-07 DATE 1-15/01


DOWNTOWN MALL LANDSCAPE PLANS


12/03/07 CONST. DETAILS M - 457L1.20 SHEET 45 OF 100

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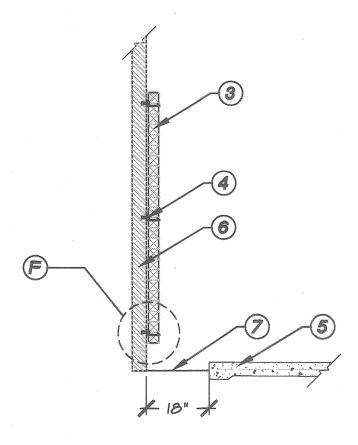





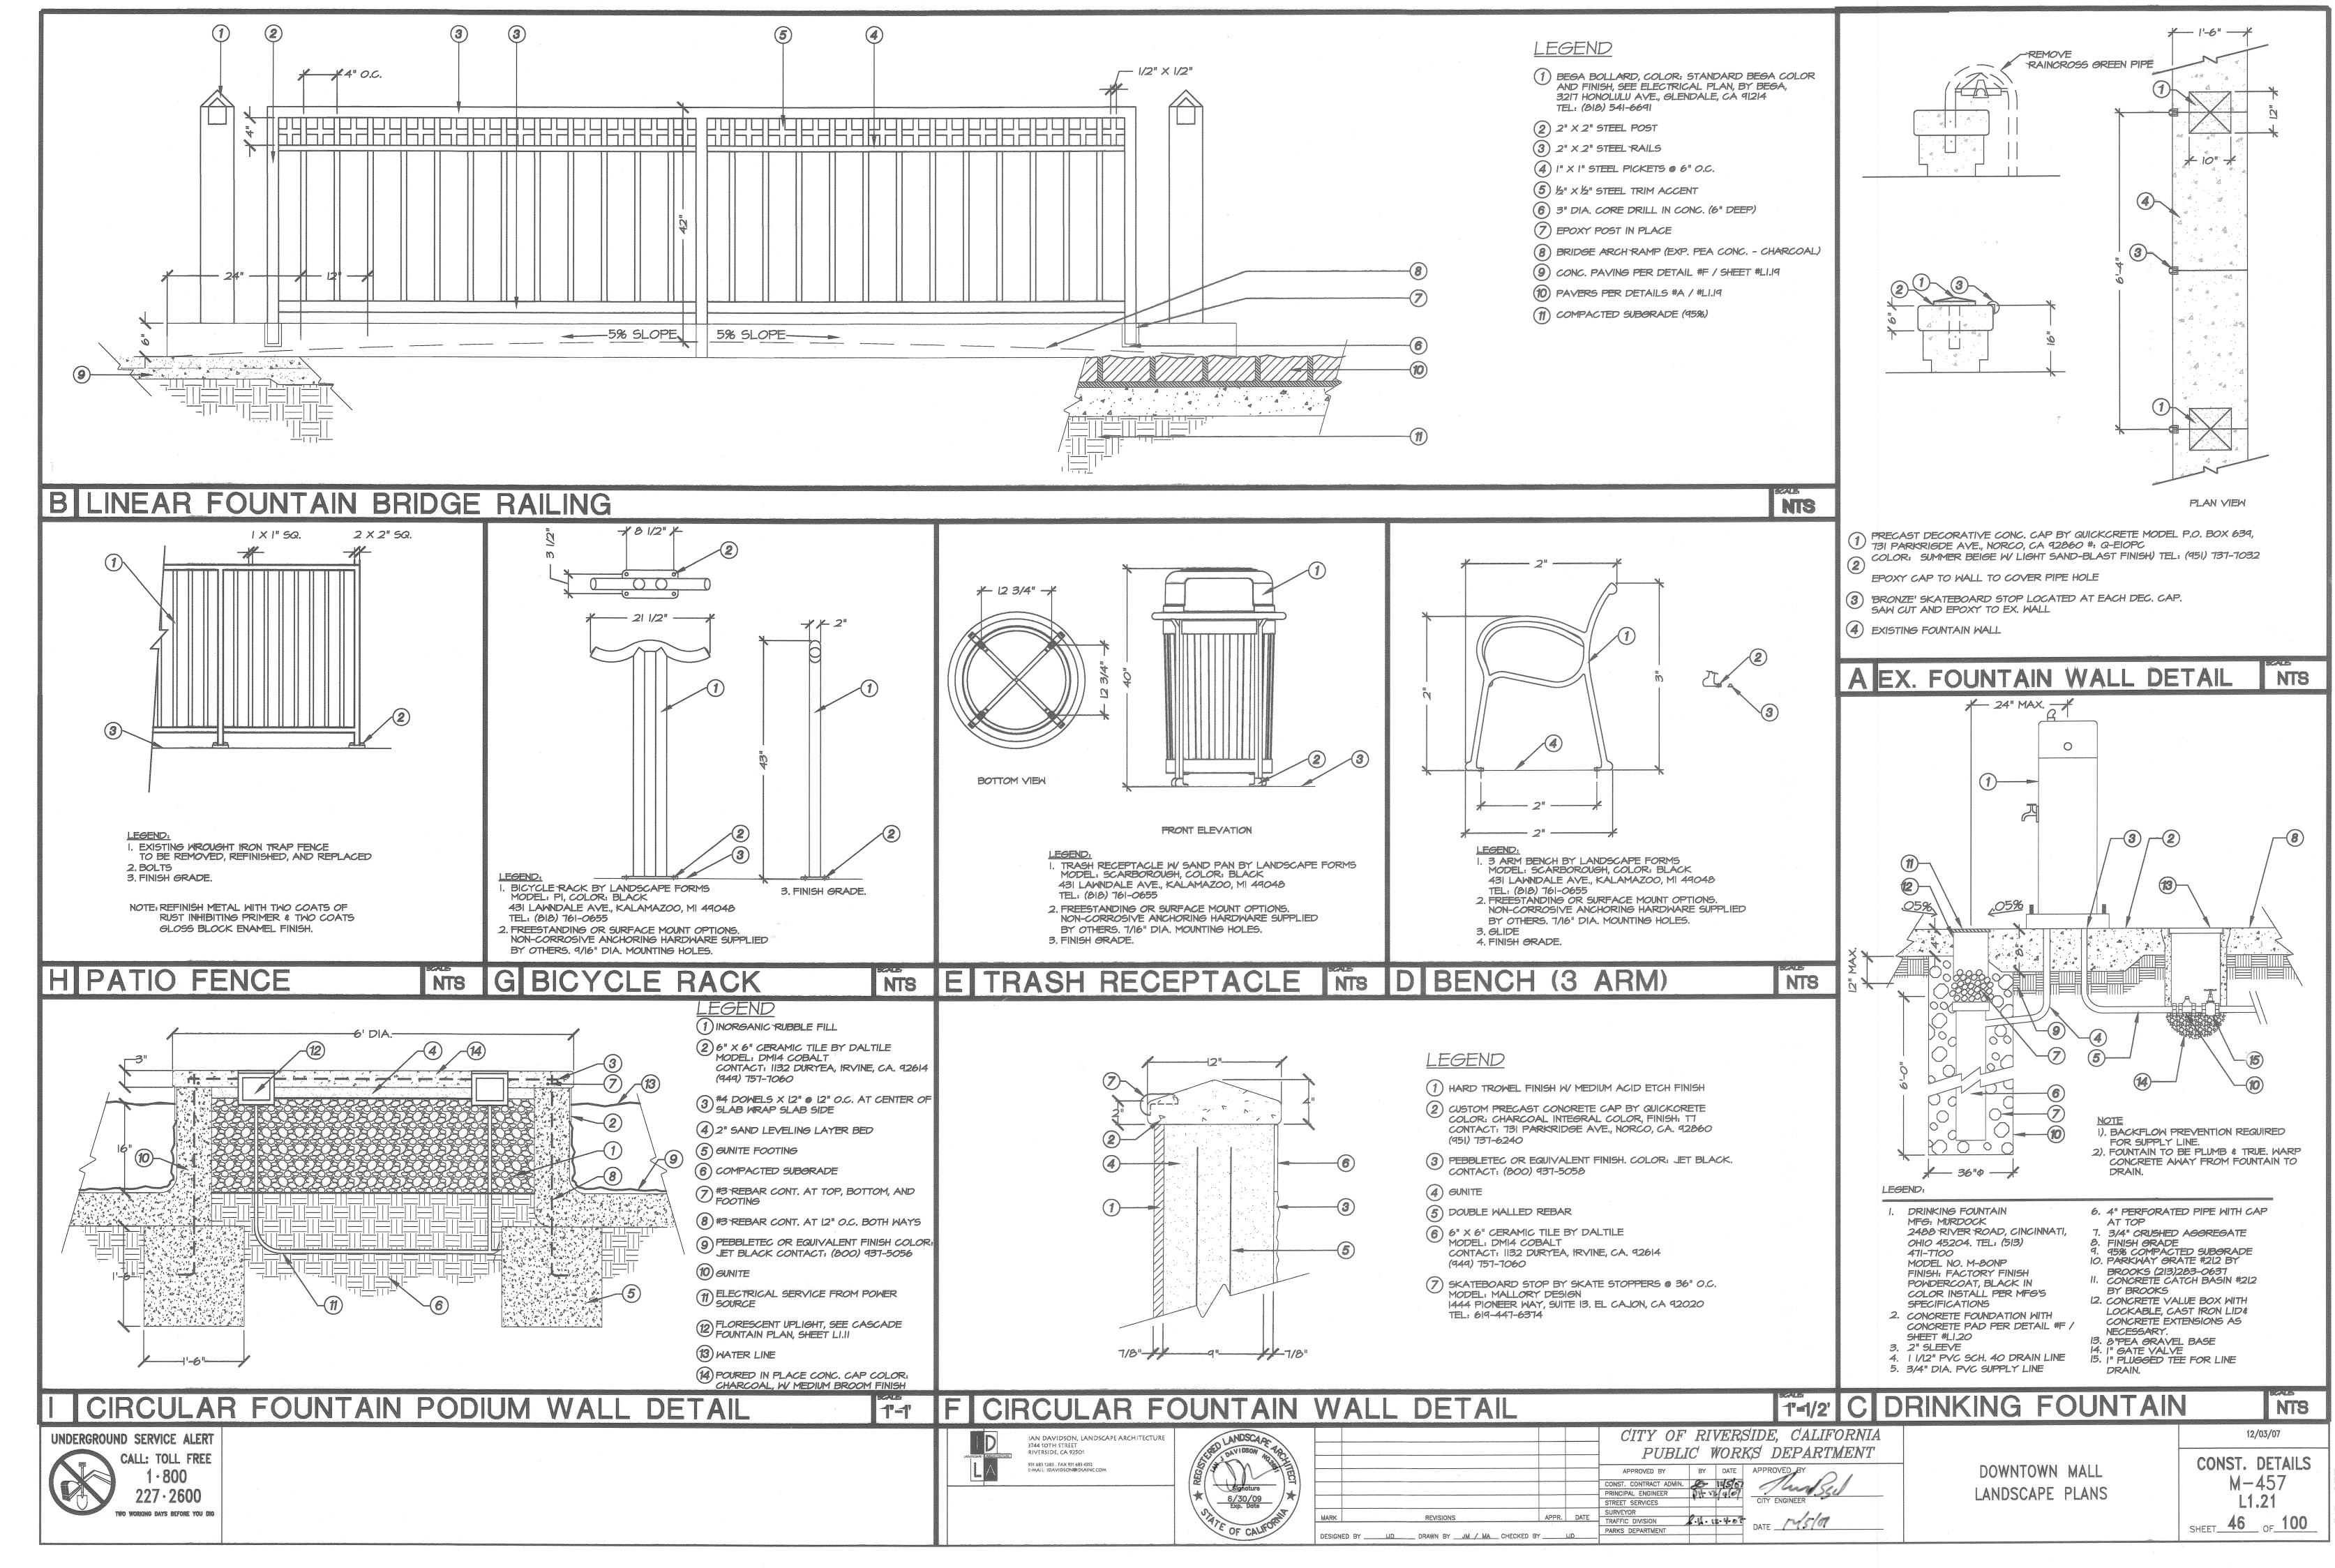


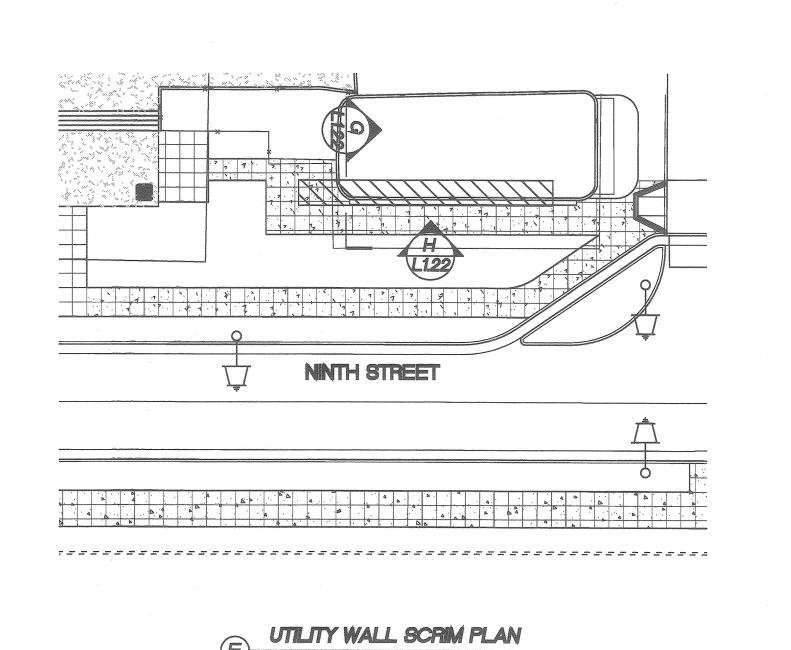

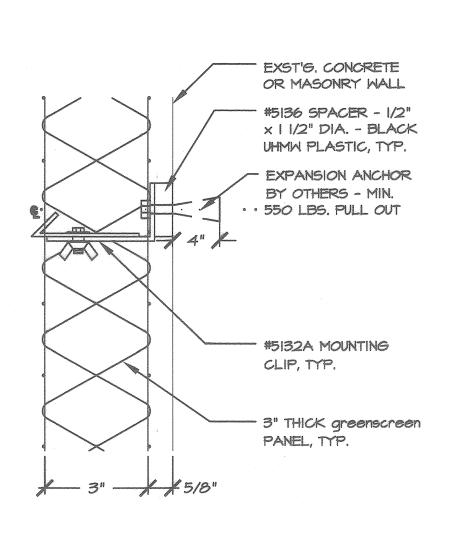45132A GREENSCREEN CLIP



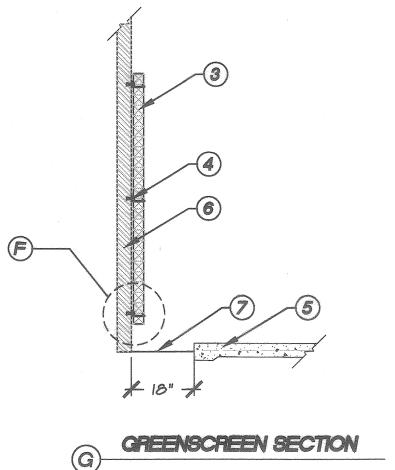


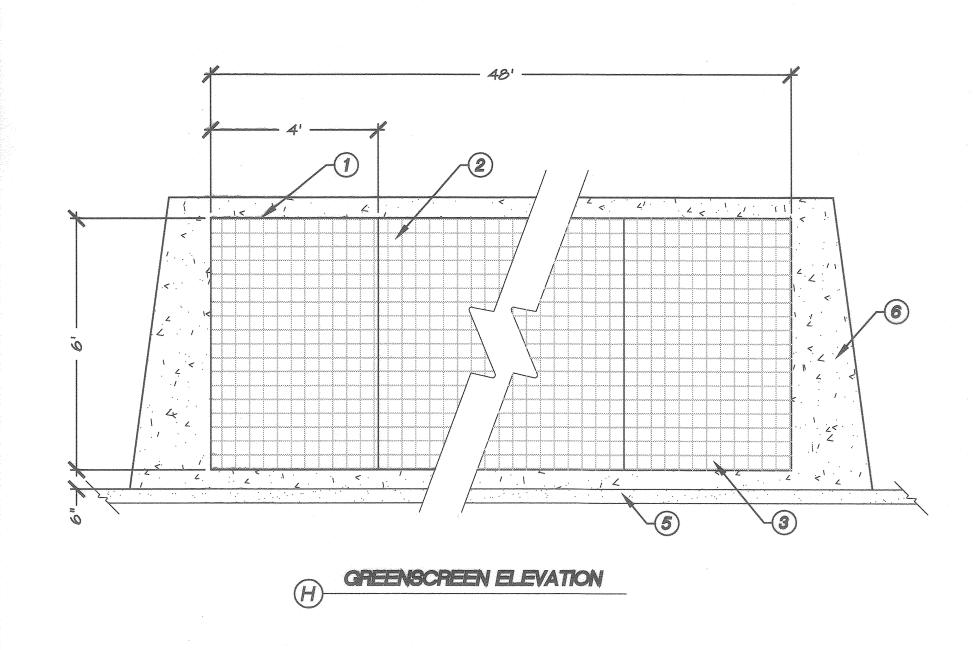


<u>LEGEND:</u> I. SAW CUT EDGE

- 2. PAINT EXISTING WALL BEHIND SCRIM W ANTI-GRAFFITI PAINT
- 3, 4' X 6' GREENSCREEN PANEL. COLOR: BLACK
- 4. GREENSCREEN #5132 A ADJUSTABLE MOUNTING CLIP. (6) PER PANEL. COLOR: BLACK
- 5. CONC. PAVING, SEE DETAIL #F, SHT. #LI.20
- 6. EXISTING UTILITY WALL
- 7. PLANTING AREA

SECURE CLIP TO EXISTING WALL W LAG BOLT, LOCK WASHER, AND EXPANSION SHIELD.

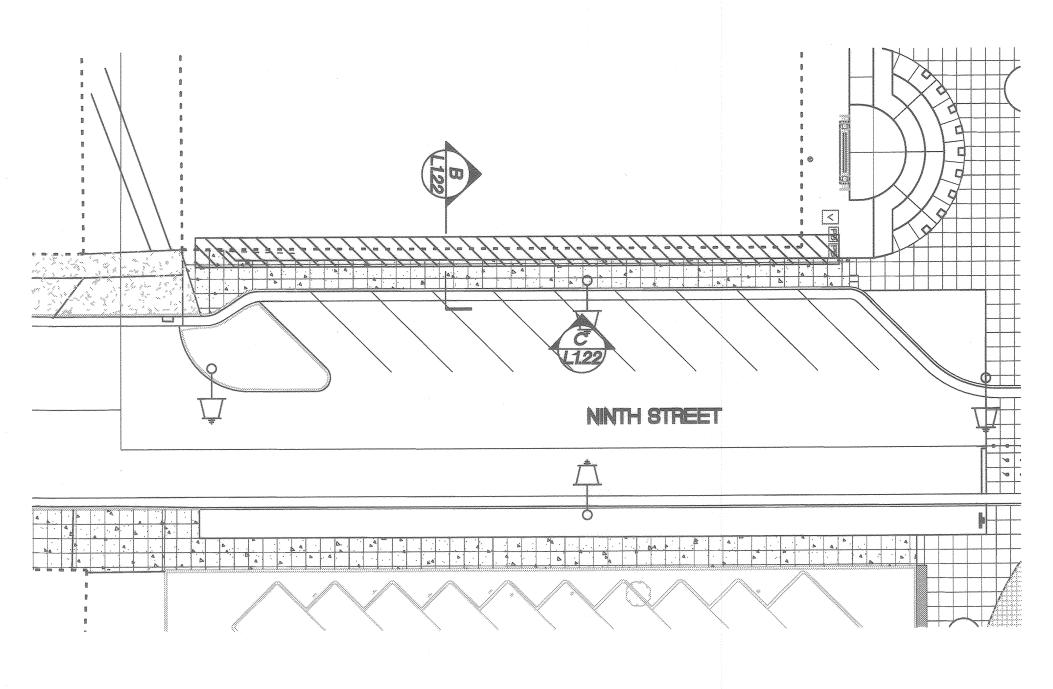


PARKING STRUCTURE WALL SCRIM PLAN

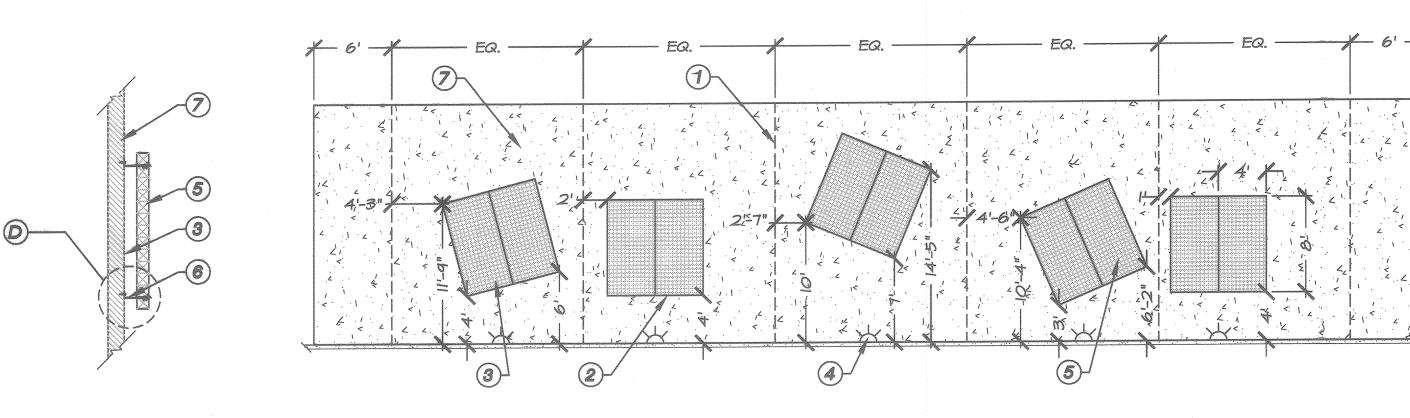

GREENSCREEN SECTION



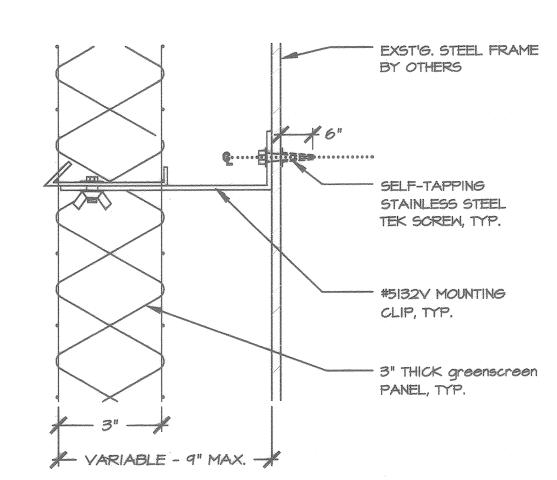

LEGEND: I. SAW CUT

- 2. SAW CUT EDGE
- 3. PAINT EXISTING WALL BEHIND SCRIM W/ ANTI-GRAFFITI PAINT
- 4. SCRIM UP-LIGHTS
- 5. 8' SQ. GREENSCREEN. 2 4' X 8' PANELS FOR ART ELEMENTS. COLOR: BLACK
- 6. GREENSCREEN #5132 V ADJUSTABLE MOUNTING CLIP. (8) PER PANEL. COLOR: BLACK
- 7. EXISTING PARKING STRUCTURE WALL

I. EXACT LOCATION OF GREENSCREENS TO BE VERIFIED IN 2. SECURE CLIP TO EXISTING WALL W LAG BOLT, LOCK WASHER, AND EXPANSION SHIELD

B UTILITY WALL SCRIM

MTS A PARKING STRUCTURE WALL SCRIM

12/03/07 ART ELEMENTS

NTS


UNDERGROUND SERVICE ALERT CALL: TOLL FREE

IAN DAVIDSON, LANDSCAPE ARCHITECTURE 3744 10TH STREET RIVERSIDE, CA 92501



			CITY OF RIVERSIDE, CALIFORNIA PUBLIC WORKS DEPARTMENT
			APPROVED BY CONST. CONTRACT ADMIN. PRINCIPAL ENGINEER APPROVED BY APPROVED BY
MARK	REVISIONS	APPR. DATE	STREET SERVICES SURVEYOR TRAFFIC DIVISION
DESIGNED BY	JD DRAWN BY JM / MA C	HECKED BY <u>UD</u>	PARKS DEPARTMENT DATE

DOWNTOWN MALL LANDSCAPE PLANS

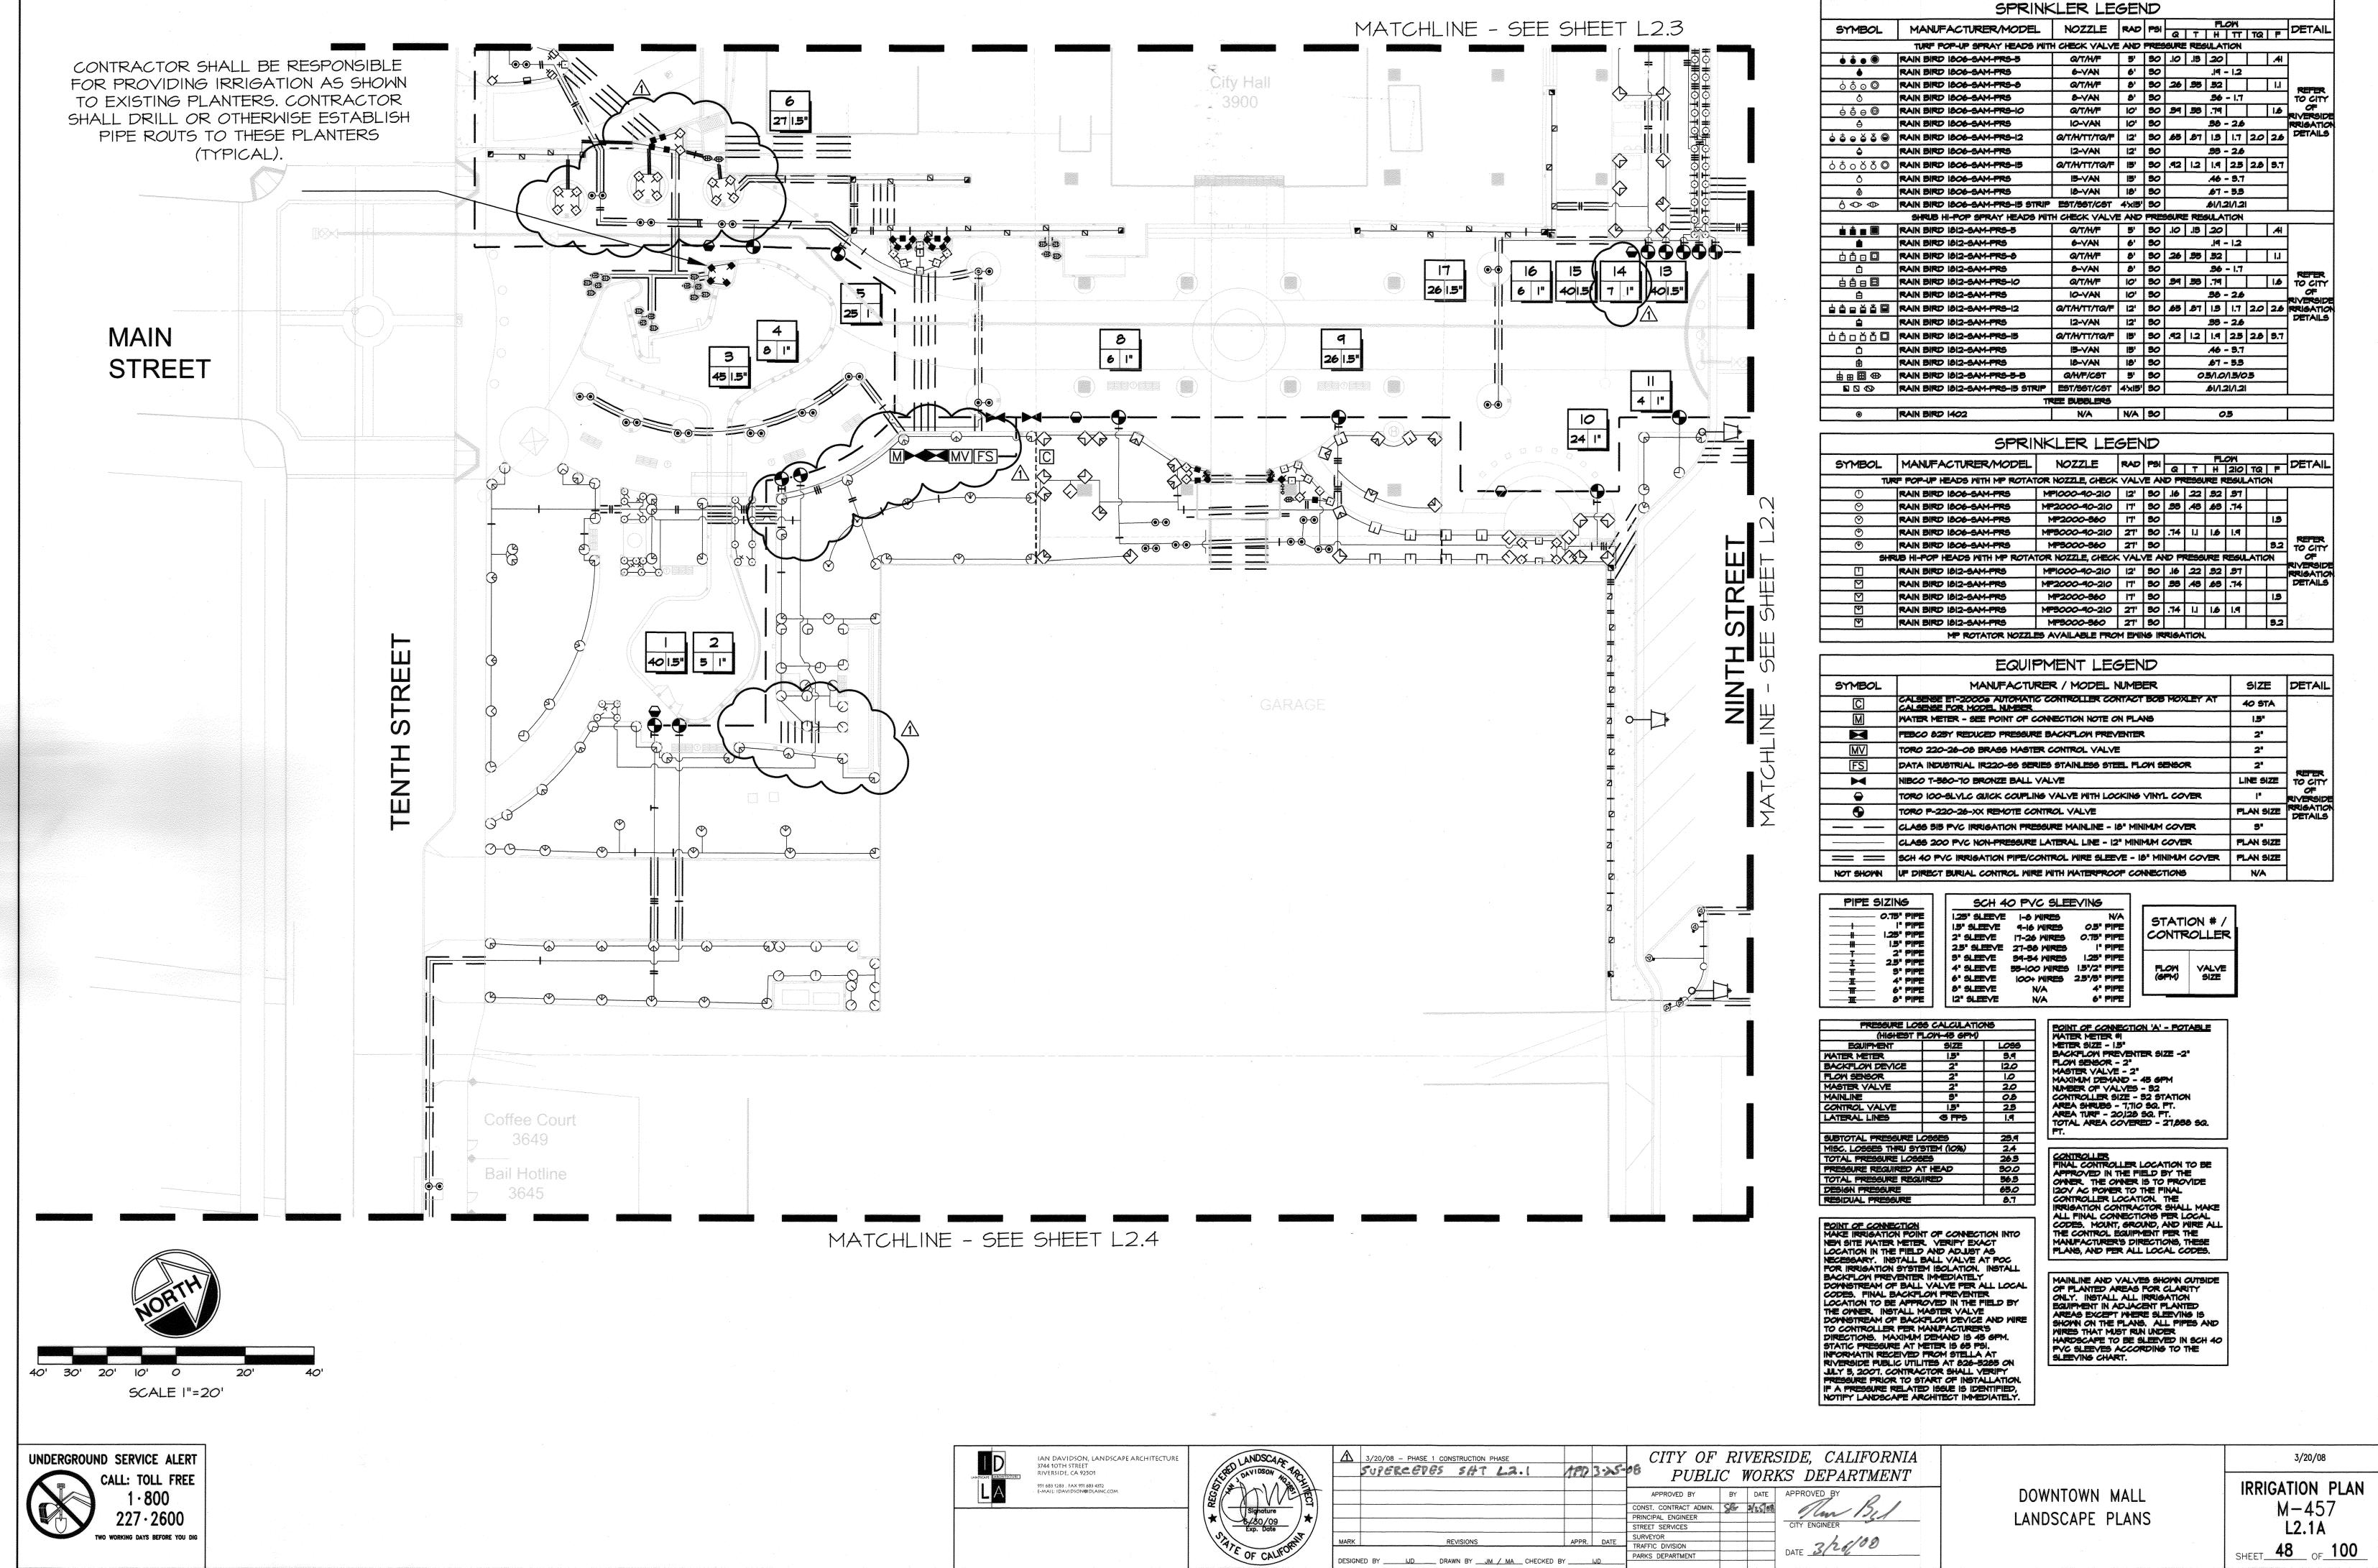


TWO WORKING DAYS BEFORE YOU DIG

SHEET 48

DATE 3/26/08

PARKS DEPARTMENT

DESIGNED BY JD DRAWN BY JM / MA CHECKED BY JD

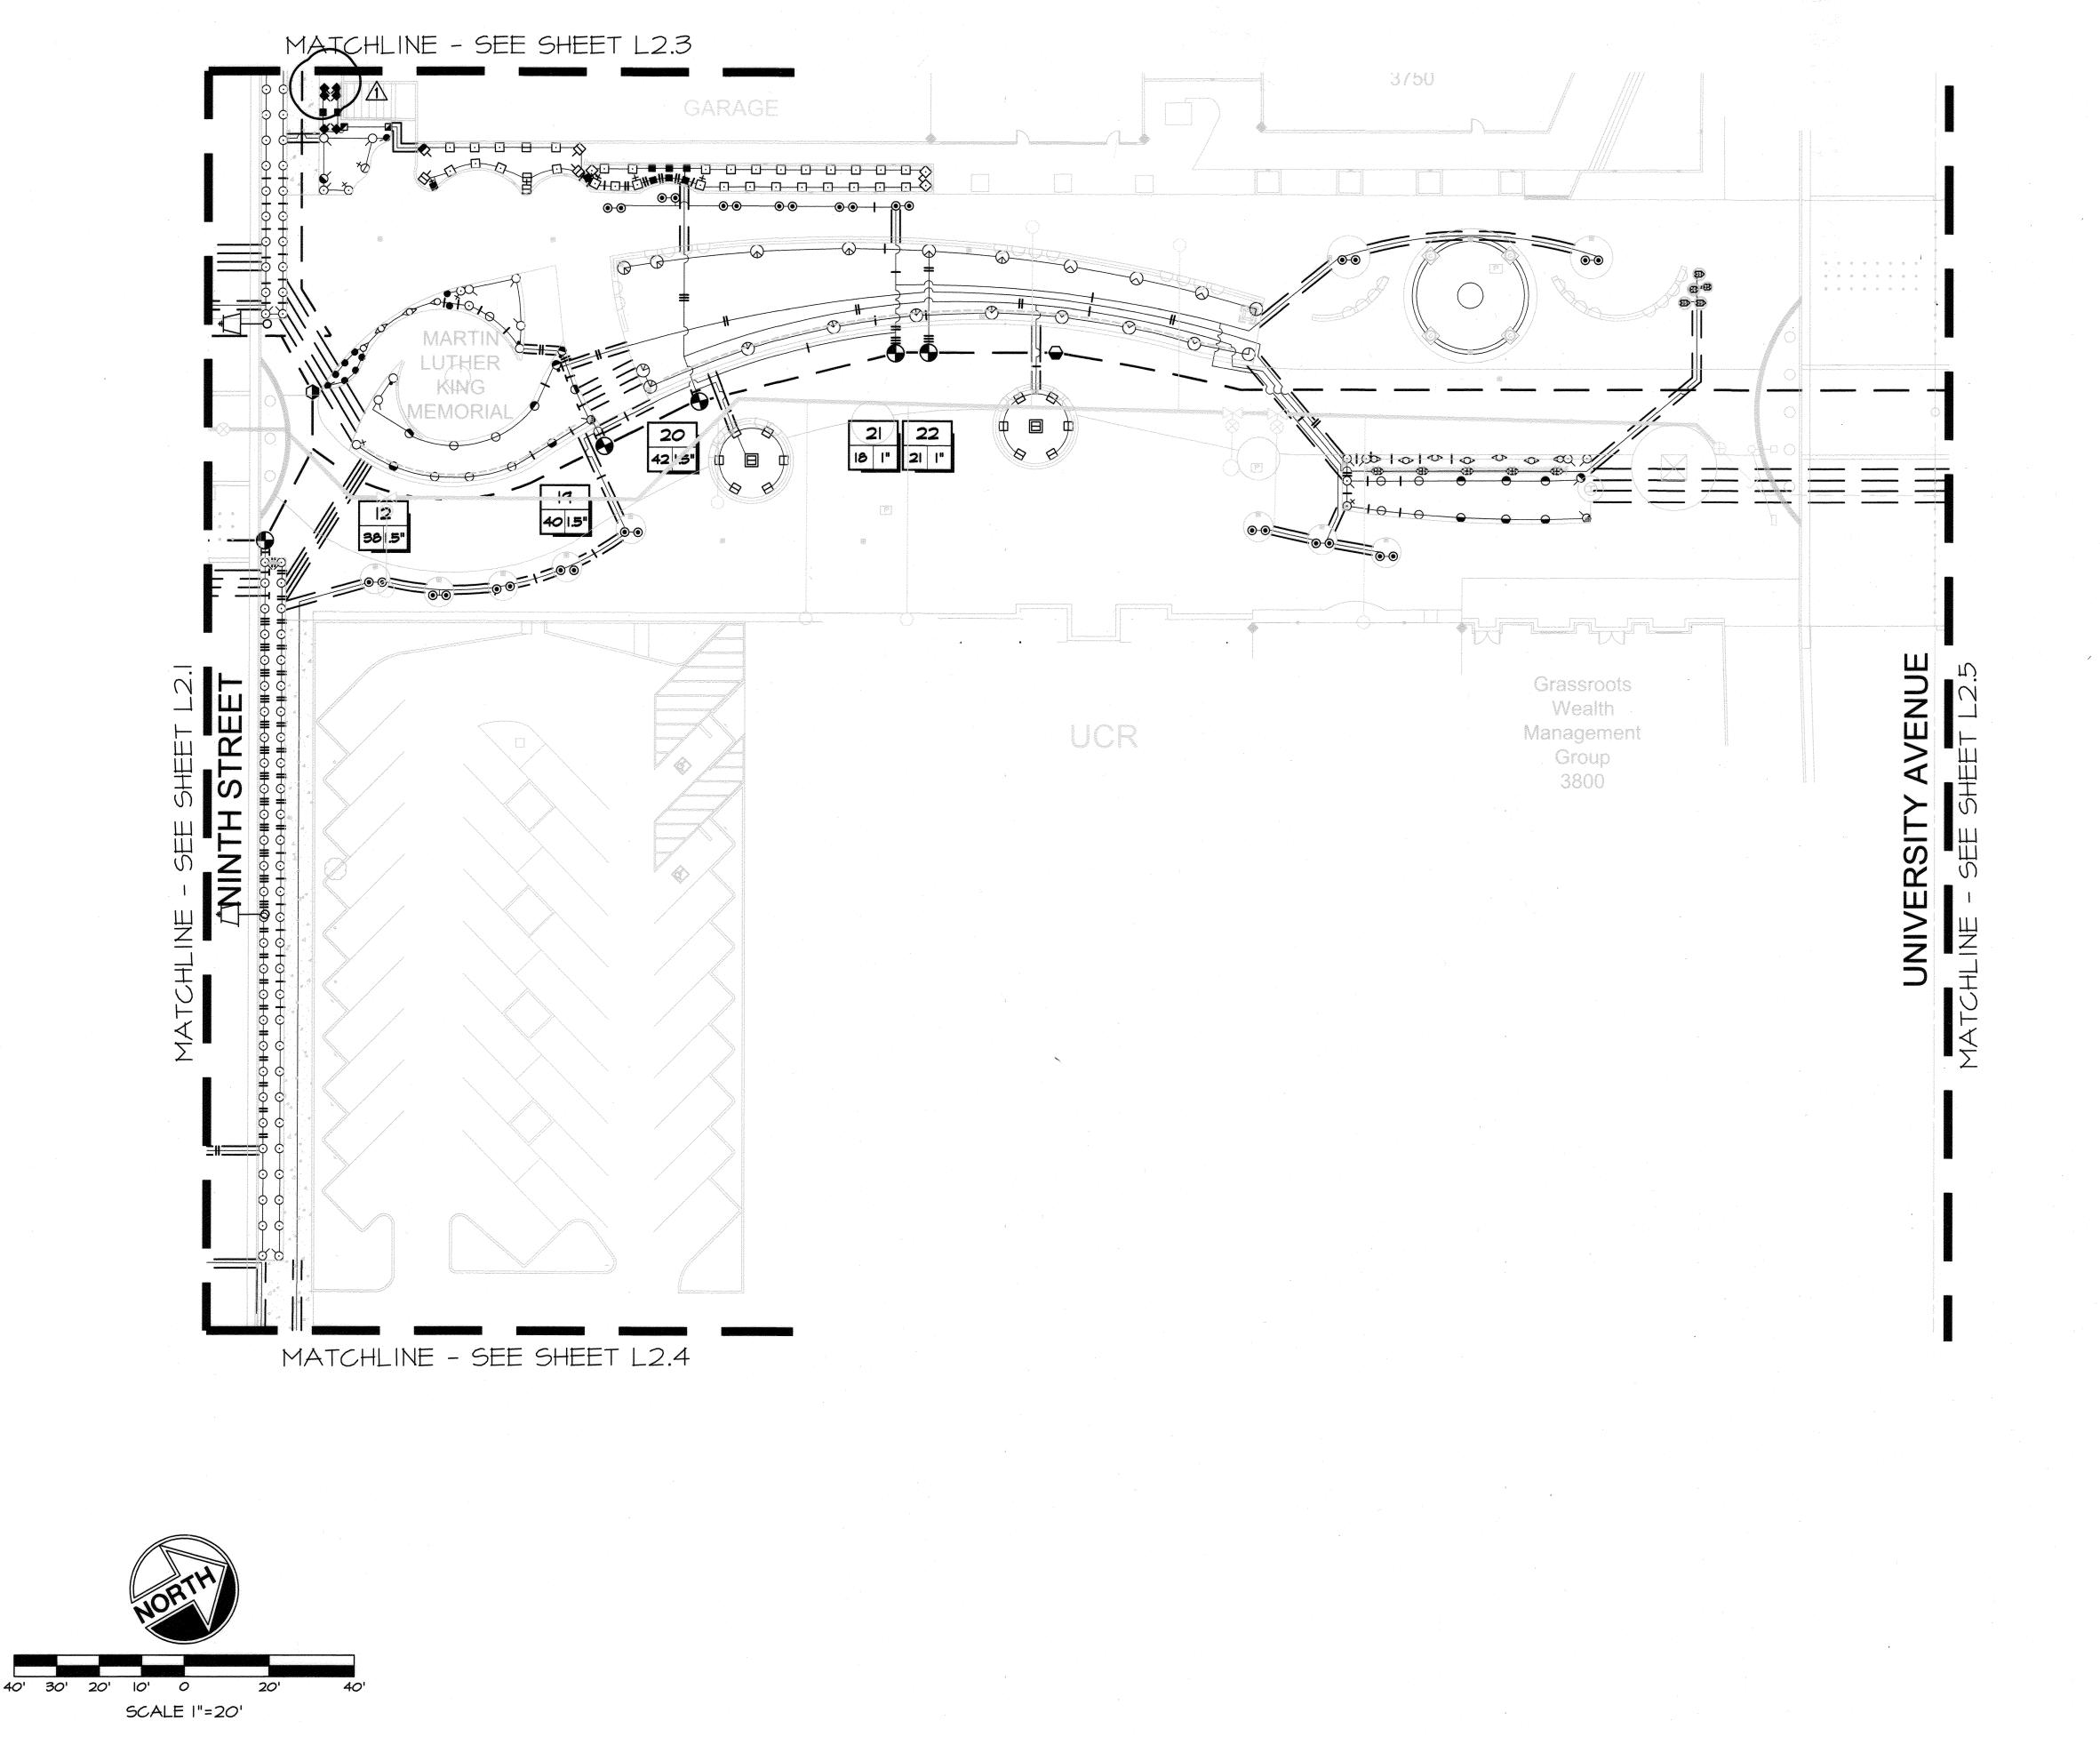

	SPRINE	<pre><ler le<="" pre=""></ler></pre>	GEN	W						
SYMBOL	MANUFACTURER/MODEL	NOZZLE	RAD	PSI			-OM			DETAIL
	TURF POP-UP SPRAY HEADS WIT	H CHECK VALVE	AMD		Q T	H		TQ	F	L
♦ • • ●	RAIN BIRD 1806-SAM-PRS-5	Q/T/H/F	S'	30	10 15			T	.41	
	RAIN BIRD 1806-SAM-PRS	6-VAN	6'	30	.10 .10		1 - 12	<u> </u>	1	ł
ბბი©	RAIN BIRD 1806-SAM-PRS-8	Q/T/H/F	8'	30	26 3			T	Ti.	
<u> </u>	RAIN BIRD 1806-SAM-PRS	8-VAN	8'	30	20 0		- 1.7	L	<u> </u>	REFER
	RAIN BIRD 1806-SAM-PRS-10	G/T/H/F	10'	50	39 59	<u> </u>		_	1.6	TO CITY
Å	RAIN BIRD 1806-SAM-PRS	IQ-VAN	10'	30	<u> </u>			<u> </u>	1.0	RIVERSID
4 4 4 4 4 4 4 4 4 4 4 4 4 4 4 4 4 4 4	RAIN BIRD 1806-SAM-PRS-12	Q/T/H/TT/TQ/F	12'	90	65 B				2.6	DETAIL
<u> </u>	RAIN BIRD 1806-SAM-PRS	I2-VAN	12'	90	20 0		- 26	<u> </u>	1	1
<u>.</u> ბგიგზ©	RAIN BIRD 1806-SAM-PRS-15	Q/T/H/TT/TQ/F	15'	90	92 13	\neg		2.8	9.7	
	RAIN BIRD 1806-SAM-PRS	IS-VAN	15'	50	,7a8 1ad		- 3.7	120	9.1	ł
<u></u>	RAIN BIRD 1806-SAM-PRS	IS-VAN	18'	30			- 5.1 - 5.5			
A <> <	RAIN BIRD 1806-SAM-PRS-15 STRIP	.	4'x 5'	30			21/1.2	<u> </u>		
0 0 0	SHRUB HI-POP SPRAY HEADS WIT			LYY	LAIDE O					<u> </u>
	RAIN BIRD 1812-SAM-PRS-5	Q/T/H/F	5'	90	.10 .15			Г	AI	
	RAIN BIRD 1812-SAM-PRS	6-VAN	6'	30				L	1	ł
	RAIN BIRD 1812-SAM-PRS-8	Q/T/H/F	B'	30	26 9				1.1	
<u> </u>	RAIN BIRD 1812-SAM-PRS	8-VAN	8'	30			-17	<u> </u>	L.'''	
自自自目	RAIN BIRD 1812-SAM-PRS-10	Q/T/H/F	10'	90	.94 .56	79	T	Г	1.6	TO CITY
8	RAIN BIRD 1812-SAM-PRS	IO-VAN	10'	30			- 26	L	L,	OF
	RAIN BIRD 1812-SAM-PRS-12	Q/T/H/TT/TQ/F	12'	30	65 8	1113	T 1.7	2.0	2.6	RIVERSID
<u> </u>	RAIN BIRD 1812-SAM-PRS	I2-VAN	12'	30		.33	- 26			DETAILS
	RAIN BIRD 1812-SAM-PRS-15	Q/T/H/TT/TQ/F	15'	30	.42 1.2	_	_	2.8	9.7	
	RAIN BIRD 1812-SAM-PRS	IS-VAN	15'	30		ــــــــــــــــــــــــــــــــــــــ	- 9.7		L	
O	RAIN BIRD 1812-SAM-PRS	IB-VAN	18'	50			- 5.5	-		
####₩	RAIN BIRD 1812-SAM-PRS-5-B	Q/H/F/CST	5'	30	1	0.5/1.0		5		1
	RAIN BIRD 1812-SAM-PRS-15 STRIP	EST/SST/CST	4'x15'	30			21/1.2		*****	1
		REE BUBBLERS						-		
• •	RAIN BIRD 1402	N/A	NA	30			25			

SYMBOL	MANUFACTURER/MODEL	NOZZLE	RAD	mei			DETAIL					
SIMBOL	MANOLACIONENTIODEL	NOZZLE	N	rai	Ø	T	H	210	TQ	F	DEIAIL	
TU	RF POP-UP HEADS WITH MP ROTAT	OR NOZZLE, CHECK	VALY	作み	D P	TESS!	re f	REGUL	ATION	1		
Ф	RAIN BIRD 1806-SAM-PRS	MP1000-40-210	12'	90	.16	.22	.32	.97				
0	RAIN BIRD 1806-SAM-PRS	MP2000-40-210	17'	90	.98	.48	<i>6</i> 9	.74				
8	RAIN BIRD 1806-SAM-PRS	MP2000-860	17'	30						1.3		
O	RAIN BIRD 1806-SAM-PRS	MP9000-40-210	27'	30	.74	1.1	1.6	1.9				
®	RAIN BIRD 1806-SAM-PRS	MP5000-360	27'	30						9.2	TO CITY	
SH	RUB HI-POP HEADS WITH MP ROTA	TOR NOZZLE, CHECK	(VAL)	Æ A	W P	RESS	URE I	REGU.	ATIO	4	OF	
U	RAIN BIRD 1812-SAM-PRS	MP1000-40-210	12'	30	.16	.22	.92	.97			RIVERSID	
	RAIN BIRD 1812-SAM-PRS	MP2000-90-210	ידו	50	.99	.48	.69	.74			DETAILS	
	RAIN BIRD 1812-SAM-PRS	MP2000-860	17'	30						1.5		
Y	RAIN BIRD 1812-SAM-PRS	MP3000-90-210	27'	90	.74	1.1	1.6	1.9				
Y	RAIN BIRD 1812-SAM-PRS	MP9000-960	27'	90						9.2	ŀ	

SYMBOL	MANUFACTURER / MODEL NUMBER	SIZE	DETAIL
C	CALSENSE ET-20000 AUTOMATIC CONTROLLER CONTACT BOB MOXLEY AT CALSENSE FOR MODEL NUMBER	40 STA	
M	WATER METER - SEE POINT OF CONNECTION NOTE ON PLANS	1.5°	
B	FEBCO 825Y REDUCED PRESSURE BACKFLOW PREVENTER	2"	
MV	TORO 220-26-06 BRASS MASTER CONTROL VALVE	2'	
FS	DATA INDUSTRIAL IR220-99 SERIES STAINLESS STEEL FLOW SENSOR	2"	
M	NIBCO T-560-70 BRONZE BALL VALVE	LINE SIZE	TO CITY
0	TORO 100-SLYLC GUICK COUPLING VALVE WITH LOCKING VINYL COVER	l.	RIVERSID
9	TORO P-220-26-XX REMOTE CONTROL VALVE	PLAN SIZE	RRIGATIO
	CLASS SIS PVC IRRIGATION PRESSURE MAINLINE - 18" MINIMUM COVER	9"	
	CLASS 200 PVC NON-PRESSURE LATERAL LINE - 12" MINIMUM COVER	PLAN SIZE	
	SCH 40 PVC IRRIGATION PIPE/CONTROL WIRE SLEEVE - 18" MINIMUM COVER	PLAN SIZE	
NOT SHOWN	UF DIRECT BURIAL CONTROL WIRE WITH WATERPROOF CONNECTIONS	N/A	1

	C SLEEVING	
PIPE	WIRES 0.5" PIPE ONTROL	
2" PIPE 5" PIPE 9" PIPE 4" PIPE 6" SLEEVE 6" SLEEVE 6" SLEEVE 6" SLEEVE	4 MIRES 1.25" PIPE FLOW V	ALVE BIZE
7 FIFE 1 1 1 1 1 1 1 1 1 1 1 1 1 1 1 1 1 1		70 1112

PRESSURE LOS	S CALCULATIO	ONS	POINT OF CONNECTION 'A' - POTABLE
(HIGHEST F	LOW-45 GPM)		WATER METER #1
EQUIPMENT	SIZE	LOSS	METER SIZE - 15"
WATER METER	1.5°	3.9	BACKFLOW PREVENTER SIZE -2"
BACKFLOW DEVICE	2"	12.0	FLOW SENSOR - 2"
FLOW SENSOR	2"	1.0	MASTER VALVE - 2" MAXIMUM DEMAND - 45 GPM
MASTER VALVE	2"	2.0	NUMBER OF VALVES - 92
MAINLINE	8"	0.8	CONTROLLER SIZE - 52 STATION
CONTROL VALVE	15*	2.5	AREA SHRUBS - 7,710 SQ. FT.
LATERAL LINES	Ø FPS	1.9	AREA TURF - 20,128 SQ. FT. TOTAL AREA COVERED - 27,838 SQ.
			FT.
SUBTOTAL PRESSURE L	099E9	29.9	
MISC. LOSSES THRU SY	STEM (10%)	2.4	
TOTAL PRESSURE LOSSES		26.5	CONTROLLER
PRESSURE REGUIRED A	T HEAD	30.0	FINAL CONTROLLER LOCATION TO BE APPROVED IN THE FIELD BY THE
TOTAL PRESSURE REGI	IRED	56.3	OWNER THE OWNER IS TO PROVIDE

201	T OF CONNECTION
	E IRRIGATION POINT OF CONNECTION INTO
	SITE WATER METER. VERIPY EXACT
	ATION IN THE FIELD AND ADJUST AS
A CONTRACTOR OF	SSARY. INSTALL BALL VALVE AT POC IRRIGATION SYSTEM ISOLATION. INSTALL
	CFLOW PREVENTER IMMEDIATELY
	ISTREAM OF BALL VALVE PER ALL LOCAL
	S. FINAL BACKFLOW PREVENTER
LOC	ATION TO BE APPROVED IN THE FIELD BY
THE	OWNER. INSTALL MASTER VALVE
7	istream of Backflow Device and Wire
Acres Validations	ONTROLLER PER MANUFACTURER'S
32 San (47)	CTIONS. MAXIMUM DEMAND IS 45 GPM.
And States of	IC PRESSURE AT METER IS 65 PSI. RMATIN RECEIVED FROM STELLA AT
15 miles 1 miles	RSIDE PUBLIC UTILITES AT 826-5285 ON
	5, 2007. CONTRACTOR SHALL VERIFY
	SURE PRIOR TO START OF INSTALLATION.
and the same of the same of	PRESSURE RELATED ISSUE IS IDENTIFIED.
Artest Military	Y LANDSCAPE ARCHITECT IMMEDIATELY.

CONTROLLER
FINAL CONTROLLER LOCATION TO BE
APPROVED IN THE FIELD BY THE
OWNER. THE OWNER IS TO PROVIDE
IZOV AC POWER TO THE FINAL
CONTROLLER LOCATION. THE
IRRIGATION CONTRACTOR SHALL MAKE
ALL FINAL CONNECTIONS PER LOCAL
CODES. MOUNT, GROUND, AND MIRE ALL
THE CONTROL EQUIPMENT PER THE
MANUFACTURER'S DIRECTIONS, THESE
PLANS, AND PER ALL LOCAL CODES.

MAINLINE AND VALVES SHOWN OUTSIDE OF PLANTED AREAS FOR CLARITY ONLY. INSTALL ALL IRRIGATION EQUIPMENT IN ADJACENT PLANTED AREAS EXCEPT WHERE SLEEVING IS SHOWN ON THE PLANS. ALL PIPES AND WIRES THAT MUST RUN UNDER HARDSCAPE TO BE SLEEVED IN SCH 40 PVC SLEEVES ACCORDING TO THE SLEEVING CHART.

UNDERGROUND SERVICE ALERT
CALL: TOLL FREE 1.800
227 · 2600
TWO WORKING DAYS BEFORE YOU DIG


LANDSCAPE ARCHITECTURE	IAN DAVIDSON, LANDSCAPE ARCHITECTURE 3744 10TH STREET RIVERSIDE, CA 92501
LA	951 683 1283 , FAX 951 683 4352 E-MAIL: IDAVIDSON@IDIAINC.COM


REGISTE	ANDSCAPE VACE OF THE PROPERTY
*	Signature 6/80/09 Exp. Date


Λ	3/20/08 - PHASE 1 CONSTRUCTION PHASE SUPERCEDES SHT 42.2	AFD	3·25·	A P			SIDE, CALIFORNIA KS DEPARTMENT
				APPROVED BY	BY	DATE	APPROVED BY
				CONST. CONTRACT ADMIN. PRINCIPAL ENGINEER	Ser	425/18	Jun 1314
			1	STREET SERVICES			CITY ENGINEER
MARK	REVISIONS	APPR.	DATE	SURVEYOR			1 100
IVIDALAN	T REVISIONS	I AFFR.	DATE	TRAFFIC DIVISION			DATE 3/4/08
DESIGN	IED BY <u>IJD</u> DRAWN BY <u>JM / MA</u> CHECKED	BY	IJD	PARKS DEPARTMENT			DATE

DOWNTOWN MALL LANDSCAPE PLANS

3/20/08 IRRIGATION PLAN M - 457SHEET 49 OF 100

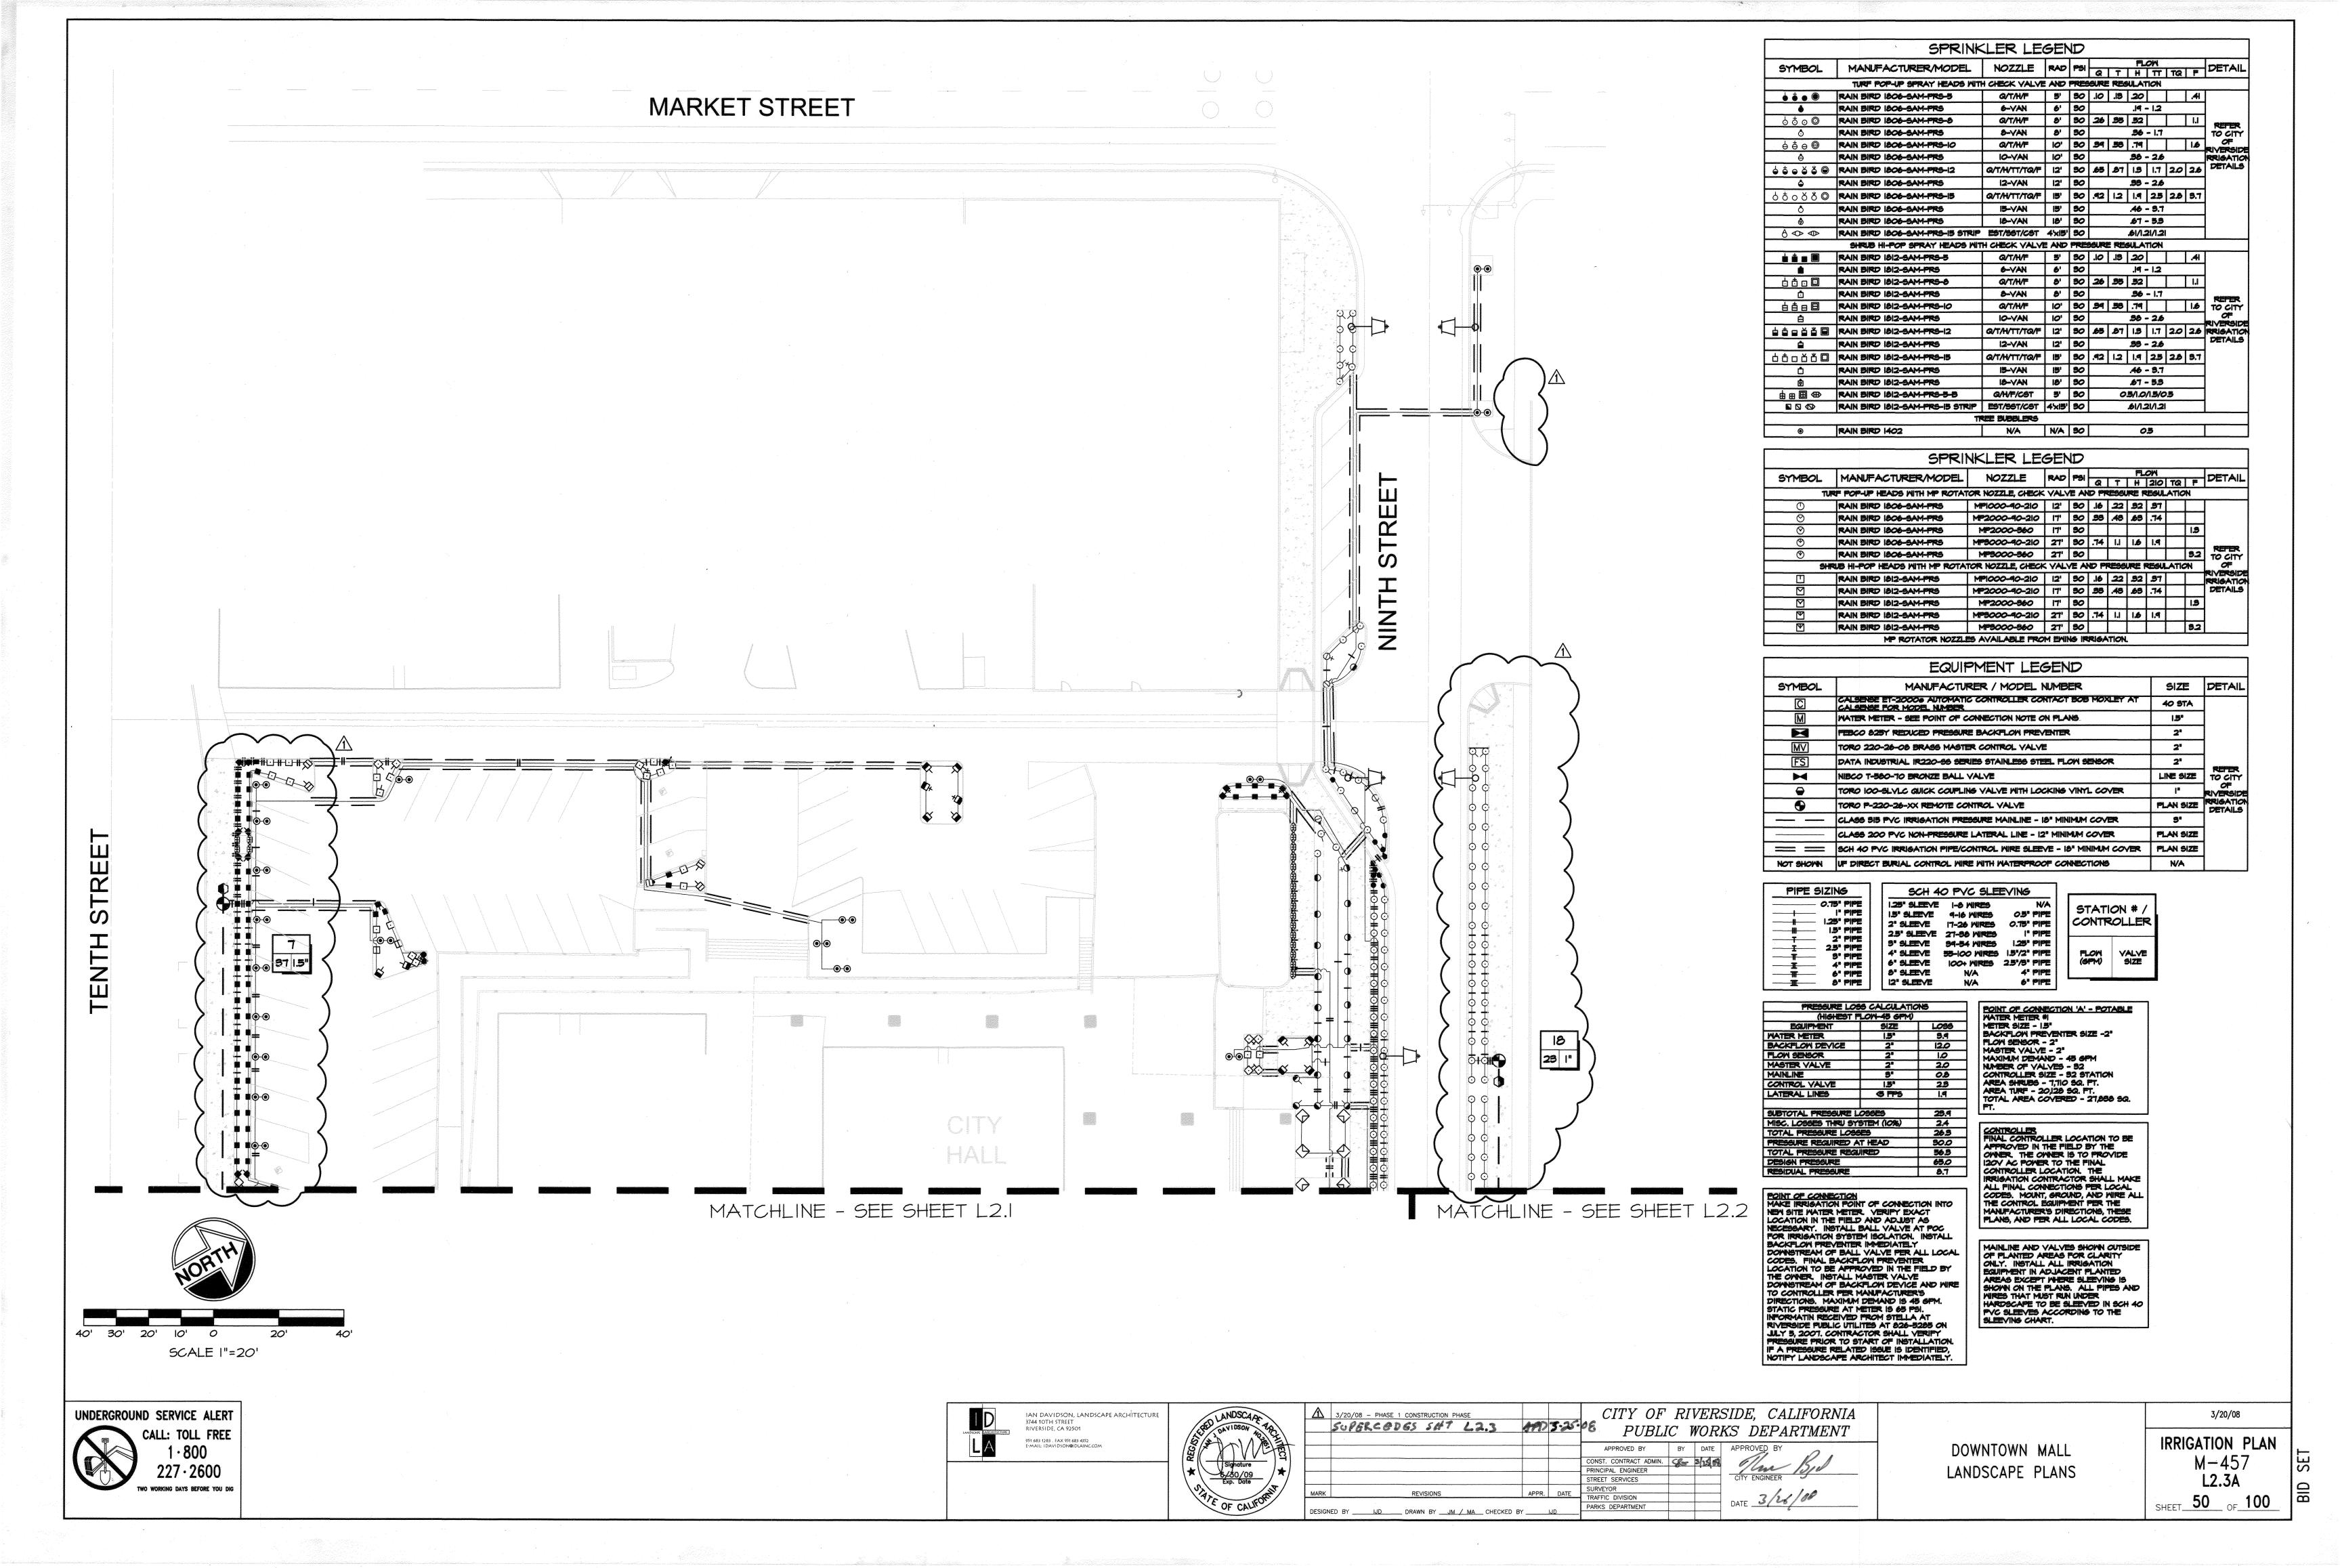

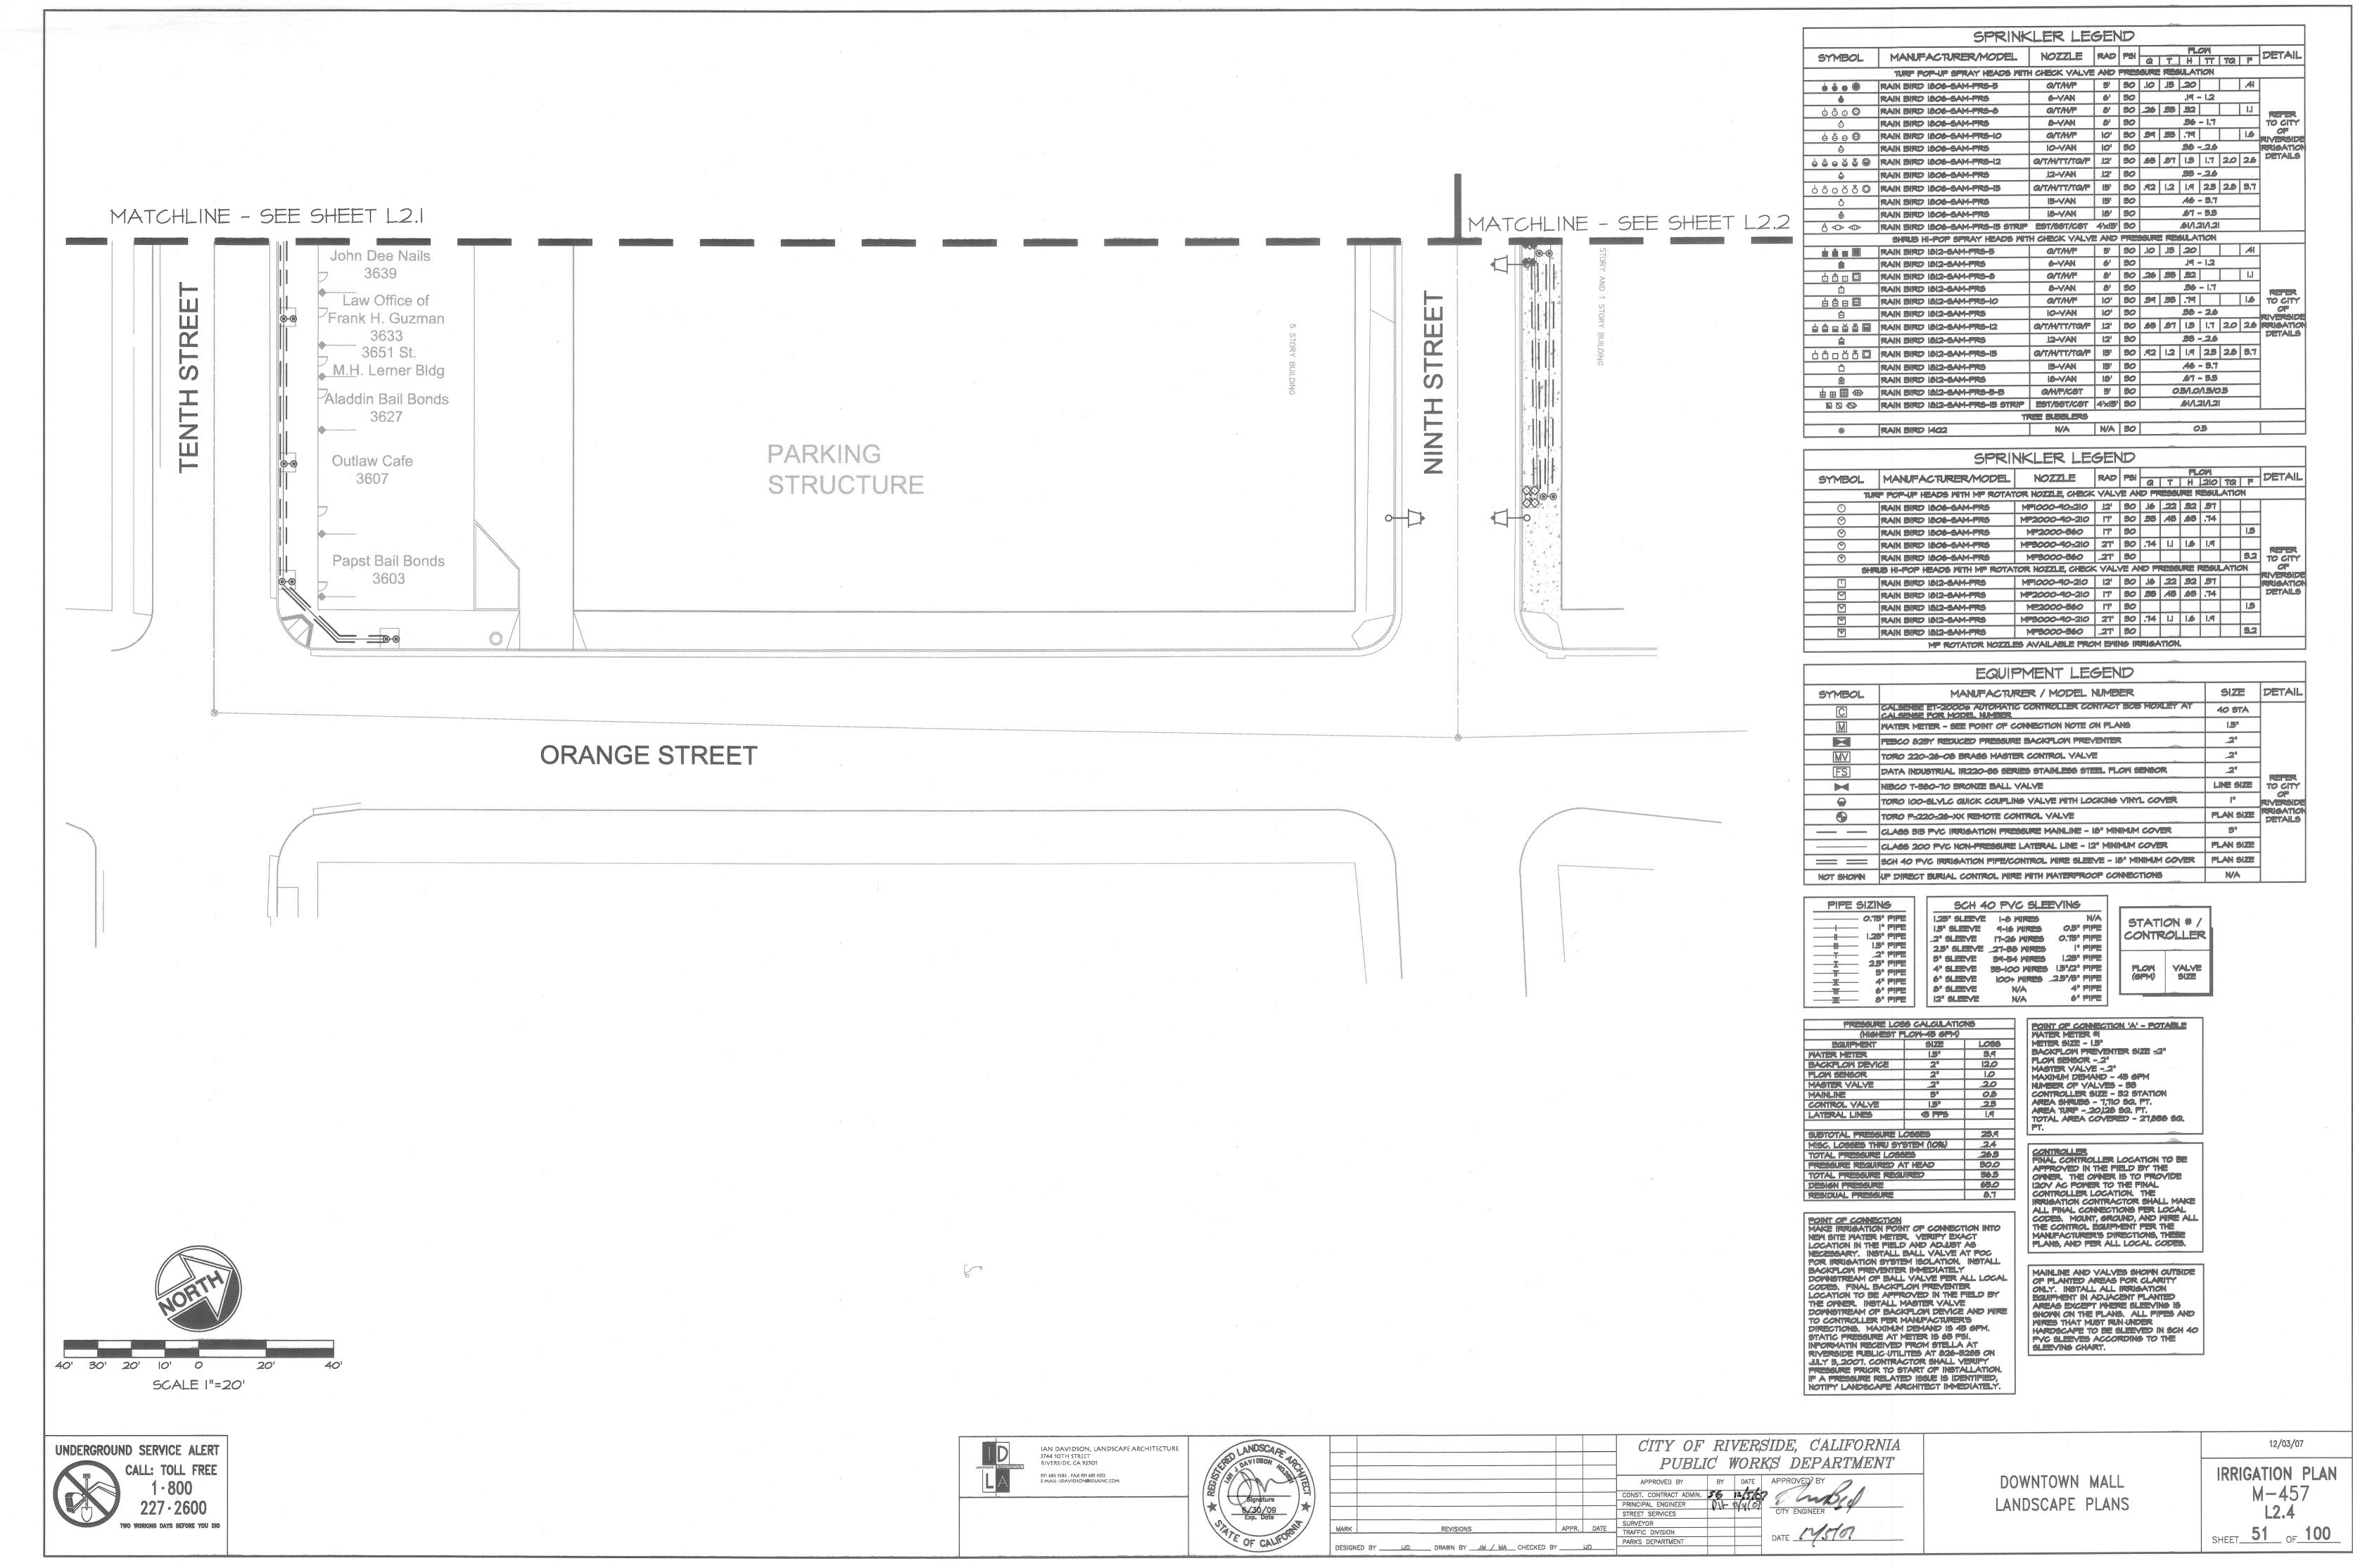

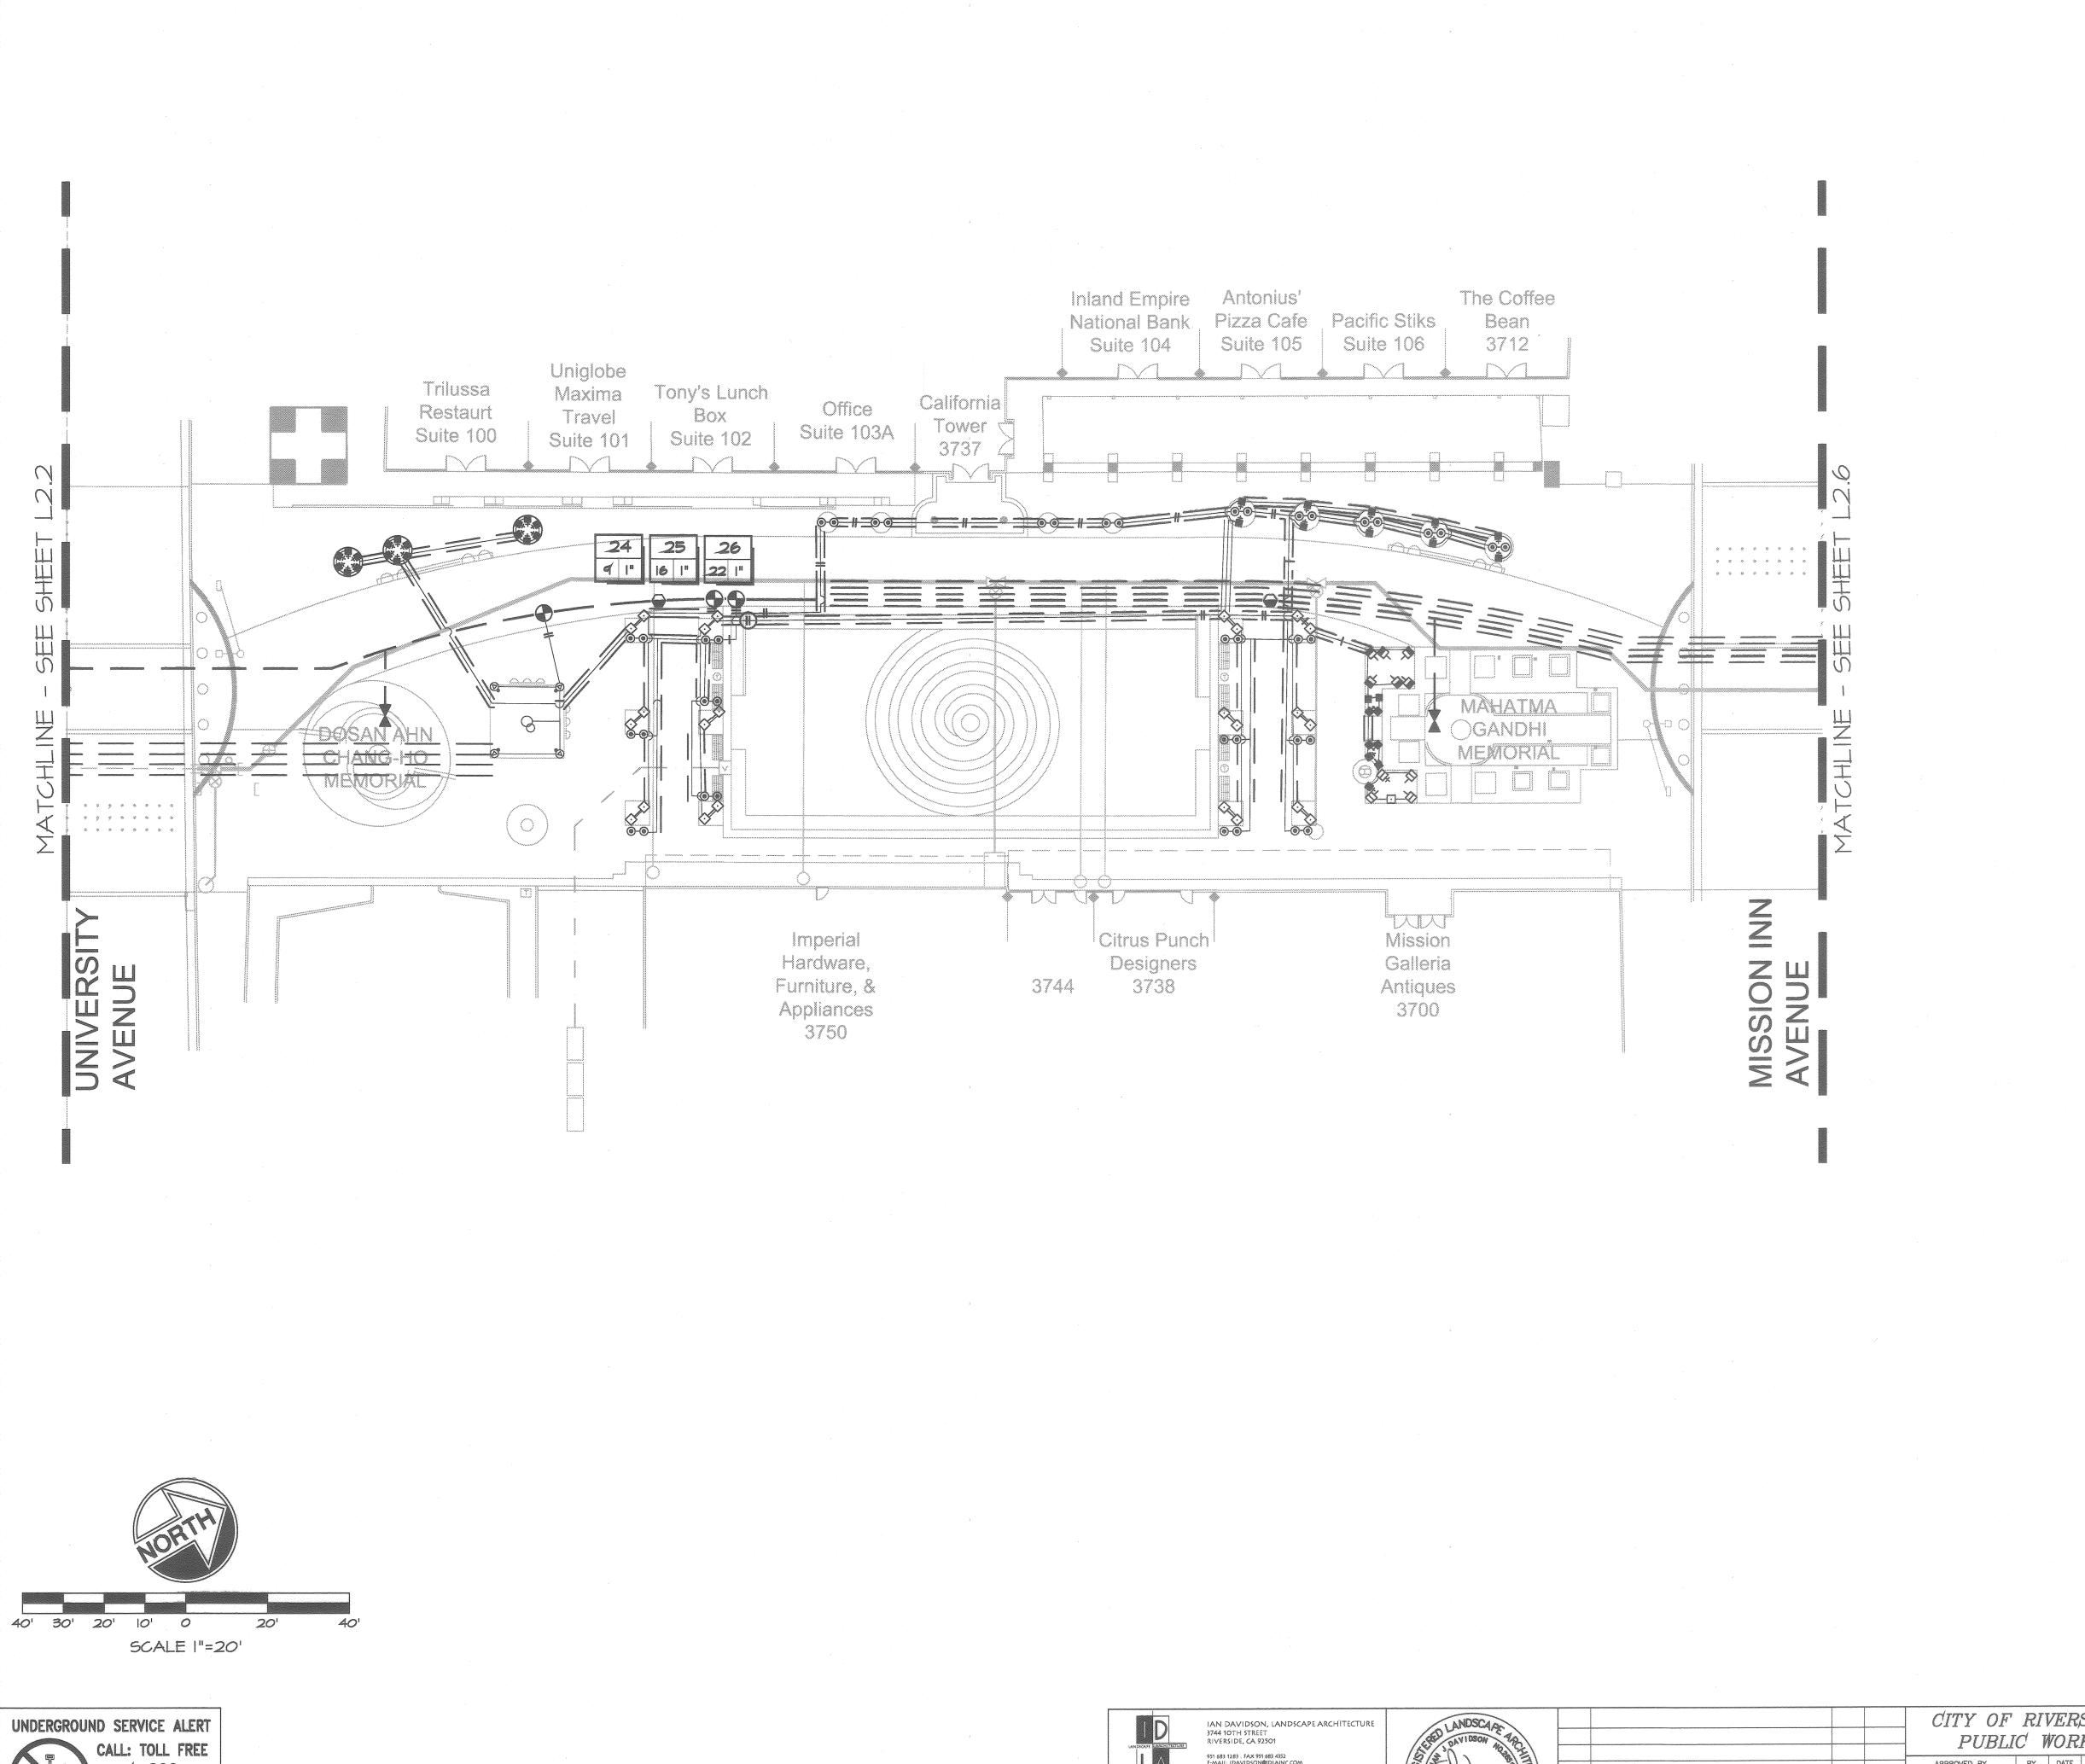

227 · 2600

TWO WORKING DAYS BEFORE YOU DIG

SPRINKLER LEGEND SYMBOL MANUFACTURER/MODEL NOZZLE RAD PSI RIT IN TO TREE DETAIL TURF POP-UP SPRAY HEADS WITH CHECK VALVE AND PRESSURE RESULATION 6 6 0 RAIN BIRD 1806-SAM-FRS-5 Q/TAVP 5' 90 .10 .18 .20 .41 & RAIN BIRD 1806-SAM-FRS 6-YAN 6' 30 .19 - 1.2 Q/T/N/F 8' 80 26 95 32 | I.I o o o o rain bird 1806-sam-pre-s 8-VAN 8' 80 .96 - 1.7 RAIN BIRD 1806-SAM-FRS Q/TAVF 10' 80 84 88 .74 16 RIVERSIDE 6 6 8 RAIN BIRD 1806-SAM-PRS-10 38 - 26 10-VAN 10' 90 AIN BIRD 1806-SAM-PRS Q/T/N/TT/TQ/F 12' 30 65 87 13 1.7 2.0 26 DETAILS 6 6 6 6 6 RAIN BIRD 1806-SAM-PRS-12 A RAIN BIRD 1806-SAM-PRS Q/T/H/TT/TQ/F 15' 50 .42 12 1.4 25 28 5.7 6 5 0 8 6 RAIN BIRD 1806-SAM-PRS-15 15-YAN 15' 90 46 - 9.7 RAIN BIRD 1806-SAM-FRS *6*7 - 5.5 RAIN BIRD 1806-SAM-PRS A O O RAIN BIRD 1806-SAM-PRS-15 STRIP EST/99T/CST 4'x15' 90 61/1.21/1.21 SHRUB HI-POP SPRAY HEADS WITH CHECK VALVE AND PRESSURE RESULATION RAIN BIRD 1812-SAM-PRS-5 Q/TAVF 5' 30 .10 .15 20 .41 6-YAN 6' 50 .19 - 1.2 Q/T/N/F 8' 90 26 98 52 | I.i HAIN BIRD 1812-SAM-FRS-8 8-YAN 8' 90 .36 - 1.7 RAIN BIRD 1812-SAM-PRS Q/T/N/F 10' 30 39 33 .79 16 TO CITY 自自日 RAIN BIRD 1812-SAM-FRS-10 10-VAN 10' 30 36 - 26 RAIN BIRD 1812-SAM-FRS @/TAYTT/T@/F 12' 80 65 87 13 1.7 2.0 26 RRIGATIO 占古日首日 RAIN BIRD ISI2-SAM-PRS-12 29 - 26 12-VAN 12' 80 A RAIN BIRD 1812-SAM-FRS Q/T/N/TT/TQ/F 15' 30 .42 12 1.4 25 28 5.7 占古□首古□ RAIN BIRD ISI2-SAM-PRS-IS 15-YAN 15' 80 A6 - 9.7 AIN BIRD 1812-SAM-FRS *.*67 - 5.5 18-VAN 18' 50 RAIN BIRD 1812-SAM-PRS 05/1.0/15/05 由田田 ⊕ RAIN BIRD IBI2-SAM-PRS-S-B G/H/F/CST 5' 90 .61/1.21/1.21 EST/SST/CST 4'xIB' 90 NO RAIN BIRD 1812-SAM-PRS-19 STRIP TREE BUEBLERS 0.5 N/A N/A BO 6 RAIN BIRD 1402

DETA			FL			PSI	RAD	NOZZLE		
PEIL	anno antigo de la companya de la co	210 TG	Service Commence	T	Q				MANUFACTURER/MODEL	SYMBOL
	HON	EGULATI	re r	ESSU	DP	E AN	VALV	OR NOZZLE, CHECK	RF POP-UP HEADS WITH MP ROTA	TU
		.97	.22	22	.16	90	12'	MP1000-40=210	RAIN BIRD 1806-SAM-FRS	0
		.74	.63	<i>A</i> 8	.98	30	17'	MP2000-90-210	RAIN BIRD 1806-SAM-FRS	0
	19					90	17'	MP2000-960	RAIN BIRD 1806-SAM-PRS	Ø
		1,9	1.6	1,1	.74	30	27'	MP9000-40-210	RAIN BIRD 1806-SAM-FRS	®
2 10 61	9.2					30	27'	MP3000-360	RAIN BIRD 1806-SAM-PRS	®
OP RIVERS	TION	ESULAT	ref	CESS!	d p	VE A	(VAL	tor nozzle, check	RUB HI-POP HEADS WITH MP ROTA	Sil
RRIGAT		.91	.32	.22	.16	90	12'	MP1000-40-210	RAIN BIRD 1812-SAM-PRS	<u>u</u>
DETAI		.74	.63	.48	.98	90	17"	MP2000-40-210	RAIN BIRD 1812-SAM-PRS	\boxtimes
	1.9					90	17'	MP2000-860	RAIN BIRD 1812-SAM-PRS	Ø
		1.9	lø	1,1	.74	50	27'	MP9000-40-210	RAIN BIRD 1812-SAM-PRS	<u> </u>
2	92					30	27'	MP3000-360	RAIN BIRD 1812-SAM-PRS	Ø

	EQUIPMENT LEGEND		
SYMBOL	MANUFACTURER / MODEL NUMBER	SIZE	DETAI
	CALSENSE ET-20008 AUTOMATIC CONTROLLER CONTACT BOS MOXLEY AT	40 STA	
M	WATER METER - SEE POINT OF CONNECTION NOTE ON PLANS	1,9"	
	FEBCO 825Y REDUCED PRESSURE BACKFLOW PREVENTER	2'	
MV	TORO 220-26-08 BRASS MASTER CONTROL VALVE	2'	
FS	DATA INDUSTRIAL IR220-SS SERIES STAINLESS STEEL FLOW SENSOR	2"	REFER
M	NIBCO T-580-TO BRONZE BALL VALVE	LINE SIZE	TO CITY
0	TORO 100-SLYLC GUICK COUPLING VALVE WITH LOCKING VINYL COVER	l.	RIVERSIE
0	TORO P-220-26-XX REMOTE CONTROL VALVE	PLAN SIZE	PETAILS
	CLASS SIS PVC IRRIGATION PRESSURE MAINLINE - 18" MINIMUM COVER	9"	
	CLASS 200 PVC NON-PRESSURE LATERAL LINE - 12" MINIMUM COVER	FLAN SIZE	
	SCH 40 PVC IRRIGATION PIPE/CONTROL MIRE SLEEVE - 18" MINIMUM COVER	FLAN SIZE	
NOT SHOWN	UF DIRECT BURIAL CONTROL WIRE WITH WATERFROOF CONNECTIONS	NA	

PIPE SIZING	SCH 40 PVC SLEEVIN	NG
O.75' PIPE	2" SLEEVE 17-26 MIRES 0.7 25" SLEEVE 27-38 MIRES 1.2 4" SLEEVE 38-100 MIRES 1.5"/ 6" SLEEVE 100+ MIRES 2.5"/ 8" SLEEVE N/A	N/A OS' PIPE

(HIGHEST F	LOW-45 GPM)		
EGUIPMENT	SIZE	LOSS	
VATER METER	15"	9.9	
BACKFLOW DEVICE	2"	12.0	
Low sensor	2'	0.0	
1ASTER VALVE	2"	2.0	
MAINLINE	9"	0.8	
ONTROL VALVE	15"	2.5	
ATERAL LINES	9 PP9	1,9	
UBTOTAL PRESSURE L	0888	25.9	
196, LOSSES THRU SY	STEM (IOS)	24	
OTAL PRESSURE LOS	.	269	
RESSURE REGULARD A	IT HEAD	30.0	
OTAL PRESSURE REGI	JIRED.	56,9	
ASIGN PRESURE		65.0	
GOIFIAH BREISIRE		8.7	

POINT OF CONNECTION
MAKE IRRIGATION POINT OF CONNECTION INTO
NEW SITE WATER METER. VERIFY EXACT
LOCATION IN THE FIELD AND ADJUST AS
NECESSARY. INSTALL BALL VALVE AT FOC
FOR IRRIGATION SYSTEM ISOLATION. INSTALL
BACKFLOW PREVENTER IMMEDIATELY
DOWNSTREAM OF BALL VALVE PER ALL LOCAL
CODES. FINAL BACKFLOW PREVENTER
LOCATION TO BE APPROVED IN THE FIELD BY
THE OWNER. INSTALL MASTER VALVE
DOWNSTREAM OF BACKFLOW DEVICE AND WIRE
TO CONTROLLER PER MANUFACTURER'S
DIRECTIONS. MAXIMM DEMAND IS 45 GPM.
STATIC PRESSURE AT METER IS 65 FSI.
INFORMATIN RECEIVED FROM STELLA AT
RIVERSIDE FUBLIC UTILITIES AT 826-5265 ON
JULY 5, 2007. CONTRACTOR SHALL VERIFY
PRESSURE PRIOR TO START OF INSTALLATION.

IF A PRESSURE RELATED ISSUE IS IDENTIFIED,

NOTIFY LANDSCAPE ARCHITECT IMMEDIATELY.

POINT OF CONNECTION 'A' - POTABLE MATER METER 91
METER SIZE - 1.5"
BACKPLOM PREVENTER SIZE -2"
FLOM SENSOR - 2"
MASTER VALVE - 2"
MAXIMUM DEMAND - 45 GPM
NUMBER OF VALVES - 95
CONTROLLER SIZE - 92 STATION
AREA SHRUBS - 1,710 9Q. PT.
AREA TURF - 20,126 SQ. FT.
TOTAL AREA COVERED - 27,696 SQ. PT.

CONTROLLER
FINAL CONTROLLER LOCATION TO SE
APPROVED IN THE FIELD BY THE
OWNER. THE OWNER IS TO PROVIDE
120V AC POWER TO THE FINAL
CONTROLLER LOCATION. THE
IRRIGATION CONTRACTOR SHALL MAKE
ALL FINAL CONNECTIONS PER LOCAL
CODES. MOUNT, SROUND, AND WIRE ALL
THE CONTROL EQUIPMENT FER THE
MANUFACTURER'S DIRECTIONS, THESE
PLANS, AND PER ALL LOCAL CODES.

MAINLINE AND VALVES SHOWN OUTSIDE OF PLANTED AREAS FOR CLARITY ONLY. INSTALL ALL IRRIGATION EQUIPMENT IN ADJACENT PLANTED AREAS EXCEPT WHERE SLEEVING IS SHOWN ON THE PLANS. ALL PIPES AND WIRES THAT MUST RUN VADER HARDSCAPE TO SE SLEEVED IN SCH 40 PVC SLEEVES ACCORDING TO THE SLEEVING CHART.


IAN DAVIDSON, LANDSCAPE ARCHÎTECTURE
3744 10TH \$TREET
RIVERSIDE, CA 92501
951 683 1283 . FAX 951 683 4352
E-MAIL: IDAVIDSON®IDLAINC.COM




		CITY OF RIVERSIDE, PUBLIC WORKS D	CALIFORNIA EPARTMENT
		APPROVED BY BY DATE APPROV	/ED_BY
		CONST. CONTRACT ADMIN. PRINCIPAL ENGINEER STREET SERVICES CITY EI	NGINEER SU
MARK REVISIONS	APPR. DATE	SURVEYOR TRAFFIC DIVISION	12/5/07
DESIGNED BY DRAWN BY MA CHECKED BY	/ UD	PARKS DEPARTMENT DATE	(-1010:

DOWNTOWN MALL
LANDSCAPE PLANS

IRRIGATION PLAN
M-457
L2.5
SHEET 52 OF 100

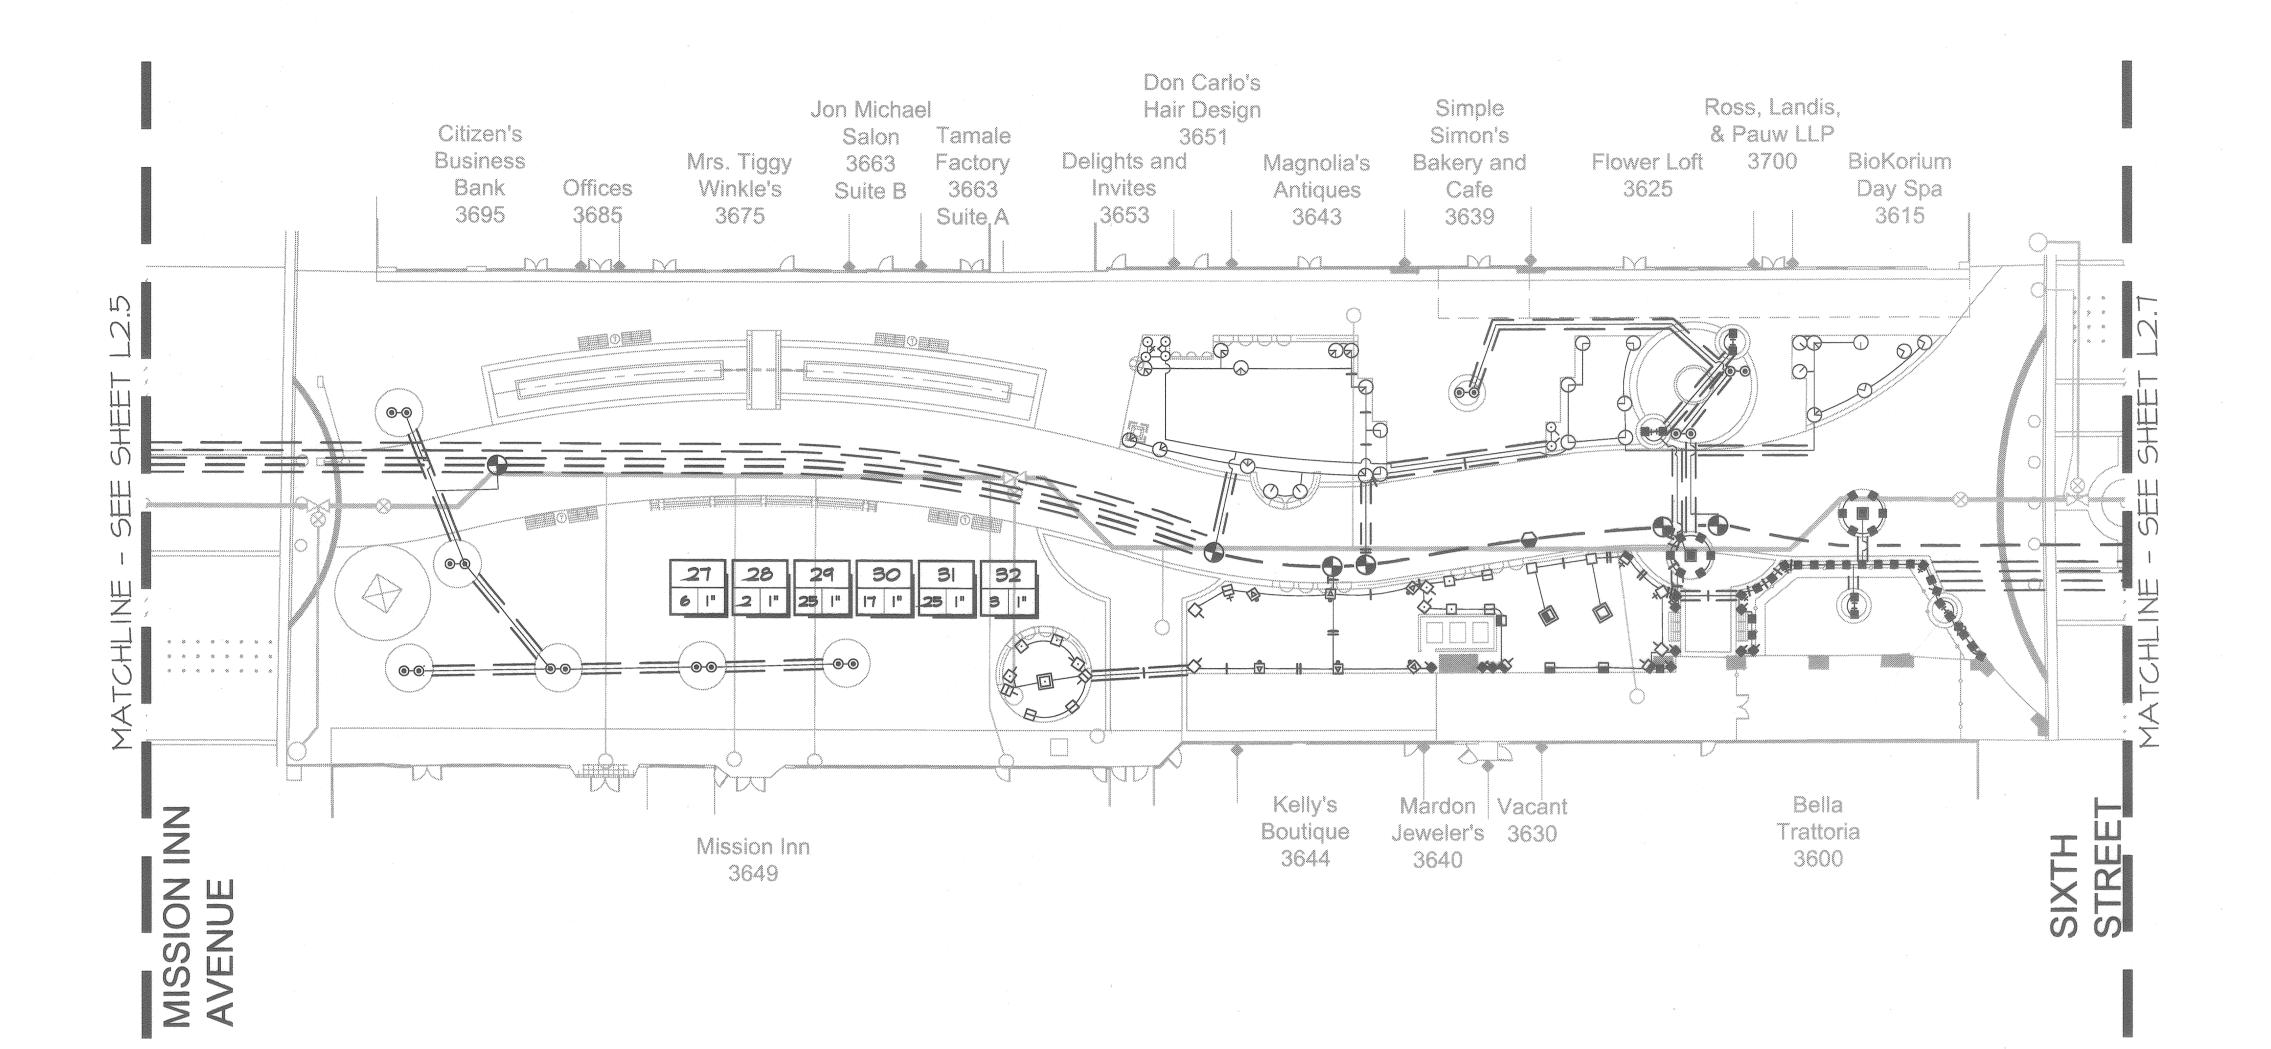

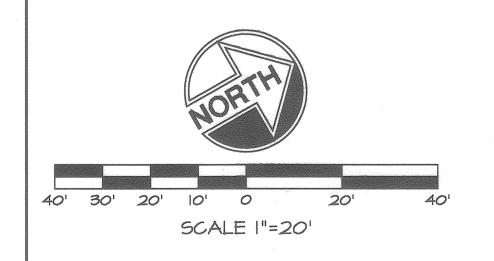

UNDERGROUND SERVICE ALERT
CALL: TOLL FREE
1 · 800
227 · 2600
TWO WORKING DAYS BEFORE YOU DIG





			CITY OF RIVERSIDE, CALIFORNIA PUBLIC WORKS DEPARTMENT
			APPROVED BY CONST. CONTRACT ADMIN. PRINCIPAL ENGINEER STREET SERVICES BY APPROVED BY CITY ENGINEER CITY ENGINEER
MARK DESIGNE	REVISIONS APPR. D BY	DATE	SURVEYOR TRAFFIC DIVISION PARKS DEPARTMENT DATE PARES DATE
A			

	TURCY FOR-UP ST	tat reads min	H CHECK YALVE	Per	i Palantai		Part		1000.10			
6600	RAIN BIRD 1806-5/	M-FRS-S	Q/T/H/P	5 '	30	.10	.19	20			.41	
ð	RAIN BIRD 1806-8/	M-PRS	6-YAN	61	90			.I9 ·	- 1.2			
6 6 0 ©	RAIN BIRD 1806-6/	M-PRS-8	Q/T/H/F	8'	90	26	.93	.52			1.1	K-F-K
ô	RAIN BIRD 1806-8/	W-PRS	8-VAN	81	90			.36	-1.7			TO CITY
6666	RAIN BIRD 1806-8/	M-PR9-10	@/T/H/F	10'	90	.99	.99	.79			1.6	RIVERSID
ê	RAIN BIRD 1806-5/	W-FRS	IO-VAN	10'	90			38 .	2.6			RRIGATIO
66666	RAIN BIRD 1806-6/	M-PRS-12	Q/T/H/TT/TQ/F	12'	30	.65	27	1.9	1.7	2.0	2.6	DETAILS
٥	RAIN BIRD 1806-5/	W-178	J2-VAN	12'	90			.99 .	-26		-	
5008 ©	RAIN BIRD 1806-6/	VM-PRS-15	Q/T/H/TT/TQ/F	15'	30	.92	1.2	1.9	2.5	2.8	9.7	
ð	RAIN BIRD 1806-S	AM-PRS	IS-VAN	15'	30			Ab.	- 9.7			
• 💩	RAIN BIRD 1806-SA	M-PRS	IB-YAN	18'	90		-	67	- 5.8			
800	RAIN BIRD 1806-5/	M-PRS-IS STRIP	EST/SST/CST	4'x 5'	90			.61/1 <i>.</i> 2	21/1.21			
*.	SHRUB HI-POP 9	PRAY HEADS WIT	H CHECK VALVE	EAND	FRE	SURE	RE	BULA:	TION			
dian	RAIN BIRD 1812-6A	M-PRS-5	Q/T/H/F	5'	90	.10	.IB	.20			.41	
	RAIN BIRD 1812-SA	M-FR9	6-VAN	6'	30			.let	- 1.2			
A å a 👨	RAIN BIRD 1812-8A	M-PRS-9	G/T/N/F	81	90	_26	.95	.52			1,1	
ů	RAIN BIRD 1812-SA	M-PR9	8-VAN	8'	30			.26	- 1.7		possissioner and see	REFER
占自自国	RAIN BIRD 1812-SA	M-PRS-10	Q/T/H/F	10'	30	.99	.59	.79			1.6	TO CITY
ê	RAIN BIRD 1812-SA	M-PRS	IO-VAN	10'	90			38	- 2.6	plantanion	physical control and the second	OF RIVERSID
	RAIN BIRD 1812-SA	M-PR9-12	Q/T/H/TT/TQ/F	12'	90	.65	.57	I.S	1.7	20	2.6	RRIGATIO
â	RAIN BIRD 1812-SA	M-PIS	12-VAN	12'	90			.99	-26			DETAILS
	RAIN BIRD 1812-SA	M-PRS-15	Q/T/H/TT/TQ/F	15'	30	.92	12	1.9	25	2.8	9. 7	
Ô	RAIN BIRD 1812-SA	M-FRS	IS-VAN	15'	90			.46	- 9.7			
Ġ	RAIN BIRD 1812-8A	M-PRS	IB-VAN	18'	30			.67	- 5.9			
由田田田	RAIN BIRD 1812-SA	M-PRS-5-5	Q/H/F/CST	5'	90		0	5/1.0	/1.5/0),5		
	RAIN BIRD 1812-SA	M-PRS-15 STRIP	EST/SST/CST	4'x15'	30			.61/L:	21/12			
		11	REE BUBBLERS							***************************************		
0	RAIN BIRD 1402		NA	NA	30			G),5		nagturnomarktiniskist	
		SPRINK	LER LE	SEN	D		40.00					,
				·	-	NATIONAL PROPERTY OF THE PARTY		District Control of the Control of t	THE RESERVE OF THE PERSON NAMED IN	europealoogosientiasi	TO STATE OF THE PARTY OF THE PA	T
SYMBOL	MANUFACTURE	RIMODEL	NOZZLE	RAD	PSI	a	ella	SECONDARIO DE COMP	0M 1210	TO		DETAIL

SPRINKLER LEGEND

SYMBOL MANUFACTURER/MODEL NOZZLE RAD PSI G T H TT TQ P DETAIL
TURF POP-UP SPRAY HEADS WITH CHECK VALVE AND PRESSURE RESULATION

		LIATTE	m A m	mei		and the same		OM			DETAIL
SYMBOL	MANUFACTURER/MODEL		RAD	L	Q	T	CONTRACTOR DESCRIPTION OF THE PARTY OF THE P	A PROPERTY AND A PARTY AND A P	TO		
TU	RF POP-UP HEADS WITH MP ROTA	ATOR NOZZLE, CHECK	VAL	/E AN	DP		re f	EGUL	ATION	neprepalation p	
0	RAIN BIRD 1806-SAM-PRS	MP1000-40-210	12'	90	.16	_22	.22	.97			
0	RAIN BIRD 1806-SAM-PRS	MP2000-40-210	17'	30	.98	.48	.69	.74			
8	RAIN BIRD 1806-SAM-PRS	MP2000-360	17'	90						3	
8	RAIN BIRD 1806-SAM-FRS	MP9000-40-210	27'	30	.74	1.1	1.6	1.9			REFER
®	RAIN BIRD 1806-SAM-PRS	MP9000-960	27'	30					8	3.2	TO CITY
SH	RUB HI-POP HEADS WITH MP ROT	ATOR NOZZLE, CHECH	VAL'	VE A	W P	7229	RE I	REGU	LATION		of Riversidi
Ш	RAIN BIRD 1812-SAM-PRS	MP1000-40-210	12'	30	.16	.22	32	.37			RRIGATIO
M	RAIN BIRD 1812-SAM-PRS	MP2000-40-210	17'	30	.98	.48	.69	.74			DETAILS
	RAIN BIRD 1812-SAM-FRS	MP2000-860	17'	30						3	
Y	RAIN BIRD 1812-SAM-PRS	MP9000-90-210	27'	90	.74	1.1	1.6	1.9			
V	RAIN BIRD 1812-SAM-FRS	MP9000-960	27'	80					8	12	
	MP ROTATOR NOZZ	LES AVAILABLE PRO	M ENII	NS IF	RIG/	MOITA	i		and the second second second second		

	EQUIPMENT LEGEND		
SYMBOL	MANUFACTURER / MODEL NUMBER	SIZE	DETAIL
[C]	CALSENSE FOR MODEL NUMBER	40 STA	
M	MATER METER - SEE POINT OF CONNECTION NOTE ON PLANS	1,5"	
	FEBCO 825Y REDUCED PRESSURE BACKFLOW PREVENTER	2"	
MV	TORO 220-26-08 BRASS MASTER CONTROL VALVE	2"	
FS	DATA INDUSTRIAL IR220-SS SERIES STAINLESS STEEL FLOW SENSOR	2"	REFER
M	NIBCO T-500-70 BRONZE BALL VALVE	LINE SIZE	TO CITY
0	TORO 100-SLYLC GUICK COUPLING VALVE WITH LOCKING VINYL COVER	l _u	RIVERSID
0	TORO P-220-26-XX REMOTE CONTROL VALVE	PLAN SIZE	RRIGATIO
	CLASS SIS PVC IRRIGATION PRESSURE MAINLINE - 18" MINIMUM COVER	9"	
	CLASS 200 PVC NON-PRESSURE LATERAL LINE - 12" MINIMUM COVER	FLAN SIZE	
	SCH 40 PVC IRRIGATION PIFE/CONTROL WIRE SLEEVE - 18" MINIMUM COVER	PLAN SIZE	
NOT SHOWN	UF DIRECT BURIAL CONTROL WIRE WITH WATERPROOF CONNECTIONS	NA	

	PIPE SIZING	SCH 40 PVC SLEEVING	
	0.75' PIPE 1' PIPE 1.25' PIPE 1.5' PIPE 1.5' PIPE	1.25" SLEEVE 1-0 MIRES N/A 1.5" SLEEVE 9-16 MIRES 0.5" PIPE 2" SLEEVE 17-26 MIRES 0.75" PIPE 2.5" SLEEVE 27-30 MIRES 1" PIPE	STATION # CONTROLLE
	7 2' PIPE 1 25' PIPE T 9' PIPE 1 4' PIPE	9" SLEEVE 99-34 WIRES 1.25" PIPE 4" SLEEVE 53-100 WIRES 1.5"/2" PIPE 6" SLEEVE 100+ WIRES 2.5"/3" PIPE 8" SLEEVE N/A 4" PIPE	FLOW VALVI (GPM) SIZE
- Company	8' PIPE	12" SLEEVE N/A 6" PIPE	

(HIGHEST F	LOW-45 GPM)		
EGUIPMENT	SIZE	LOSS	
WATER METER	1.5"	5.9	
BACKFLOW DEVICE	2"	12.0	
FLON SENSOR	2"	10	
MASTER VALVE	2"	20	
MAINLINE	9"	0.8	
CONTROL VALVE	1.5"	23	
LATERAL LINES	GFB	1.9	
SUBTOTAL PRESSURE L		29.9	L
MISC. LOSSES THRU SY		2.4	
TOTAL PRESSURE LOSS	JE9	263	
Pressure regulato A	IT HEAD	30.0	
TOTAL PRESSURE REGI	JIRED .	56.5	
ZEJIGN FRESURE		65.0	
RESIDENCE		8.7	-

POINT OF CONNECTION 'A' - POTABLE
MATER METER *I
METER SIZE - 15"
BACKLOW PREVENTER SIZE -2"
FLOW SENSOR - 2"
MASTER VALVE - 2"
MAXIMM DEMAND - 45 GPM
NUMBER OF VALVES - 35
CONTROLLER SIZE - 32 STATION
AREA SHRUBS - 1,710 SQ. FT.
AREA TURF - 20,126 SQ. FT.
TOTAL AREA COVERED - 21,636 SQ.
FT.

CONTROLLER

POINT OF CONNECTION
MAKE IRRIGATION POINT OF CONNECTION INTO
NEW SITE MATER METER. VERIFY EXACT
LOCATION IN THE FIELD AND ADJIST AS
NECESSARY. INSTALL BALL VALVE AT POC
POR IRRIGATION SYSTEM ISOLATION. INSTALL
BACKFLOW PREVENTER IMMEDIATELY
DOWNSTREAM OF BALL VALVE FER ALL LOCAL
CODES. FINAL BACKFLOW PREVENTER
LOCATION TO SE APPROVED IN THE FIELD BY
THE OWNER. INSTALL MASTER VALVE
DOWNSTREAM OF BACKFLOW DEVICE AND WIRE
TO CONTROLLER FER MANUFACTURER'S
DIRECTIONS. MAXIMUM DEMAND IS 45 SPM.
STATIC PRESSURE AT METER IS 65 PSI.
INFORMATIN RECEIVED FROM STELLA AT
RIVERSIDE FUELIC UTILITIES AT 826-5285 ON
JULY 5,2007. CONTRACTOR SHALL VERIFY
PRESSURE PRIOR TO START OF INSTALLATION.
IF A PRESSURE RELATED ISSUE IS IDENTIFIED,
NOTIFY LANDSCAPE ARCHITECT IMMEDIATELY.

CONTROLLER
PINAL CONTROLLER LOCATION TO BE
APPROVED IN THE PIELD BY THE
OWNER. THE OWNER IS TO PROVIDE
120V AC POWER TO THE PINAL
CONTROLLER LOCATION. THE
IRRIGATION CONTRACTOR SHALL MAKE
ALL FINAL CONNECTIONS PER LOCAL
CODES. MOUNT, GROUND, AND WIRE ALL
THE CONTROL EQUIPMENT PER THE
MANUFACTURER'S DIRECTIONS, THESE
PLANS, AND PER ALL LOCAL CODES.

MAINLINE AND VALVES SHOWN OUTSIDE


MAINLINE AND VALVES SHOWN OUTSIDE OF PLANTED AREAS FOR CLARITY ONLY. INSTALL ALL IRRIGATION EQUIPMENT IN ADJACENT PLANTED AREAS EXCEPT WHERE SLEEVING IS SHOWN ON THE PLANS. ALL PIPES AND WIRES THAT MUST RIN UNDER HARDSCAPE TO BE SLEEVED IN SCH 40 PVC SLEEVES ACCORDING TO THE SLEEVING CHART.

DOWNTOWN MALL
LANDSCAPE PLANS

12/03/07

IRRIGATION PLAN
M-457
L2.6

SHEET 53 OF 100

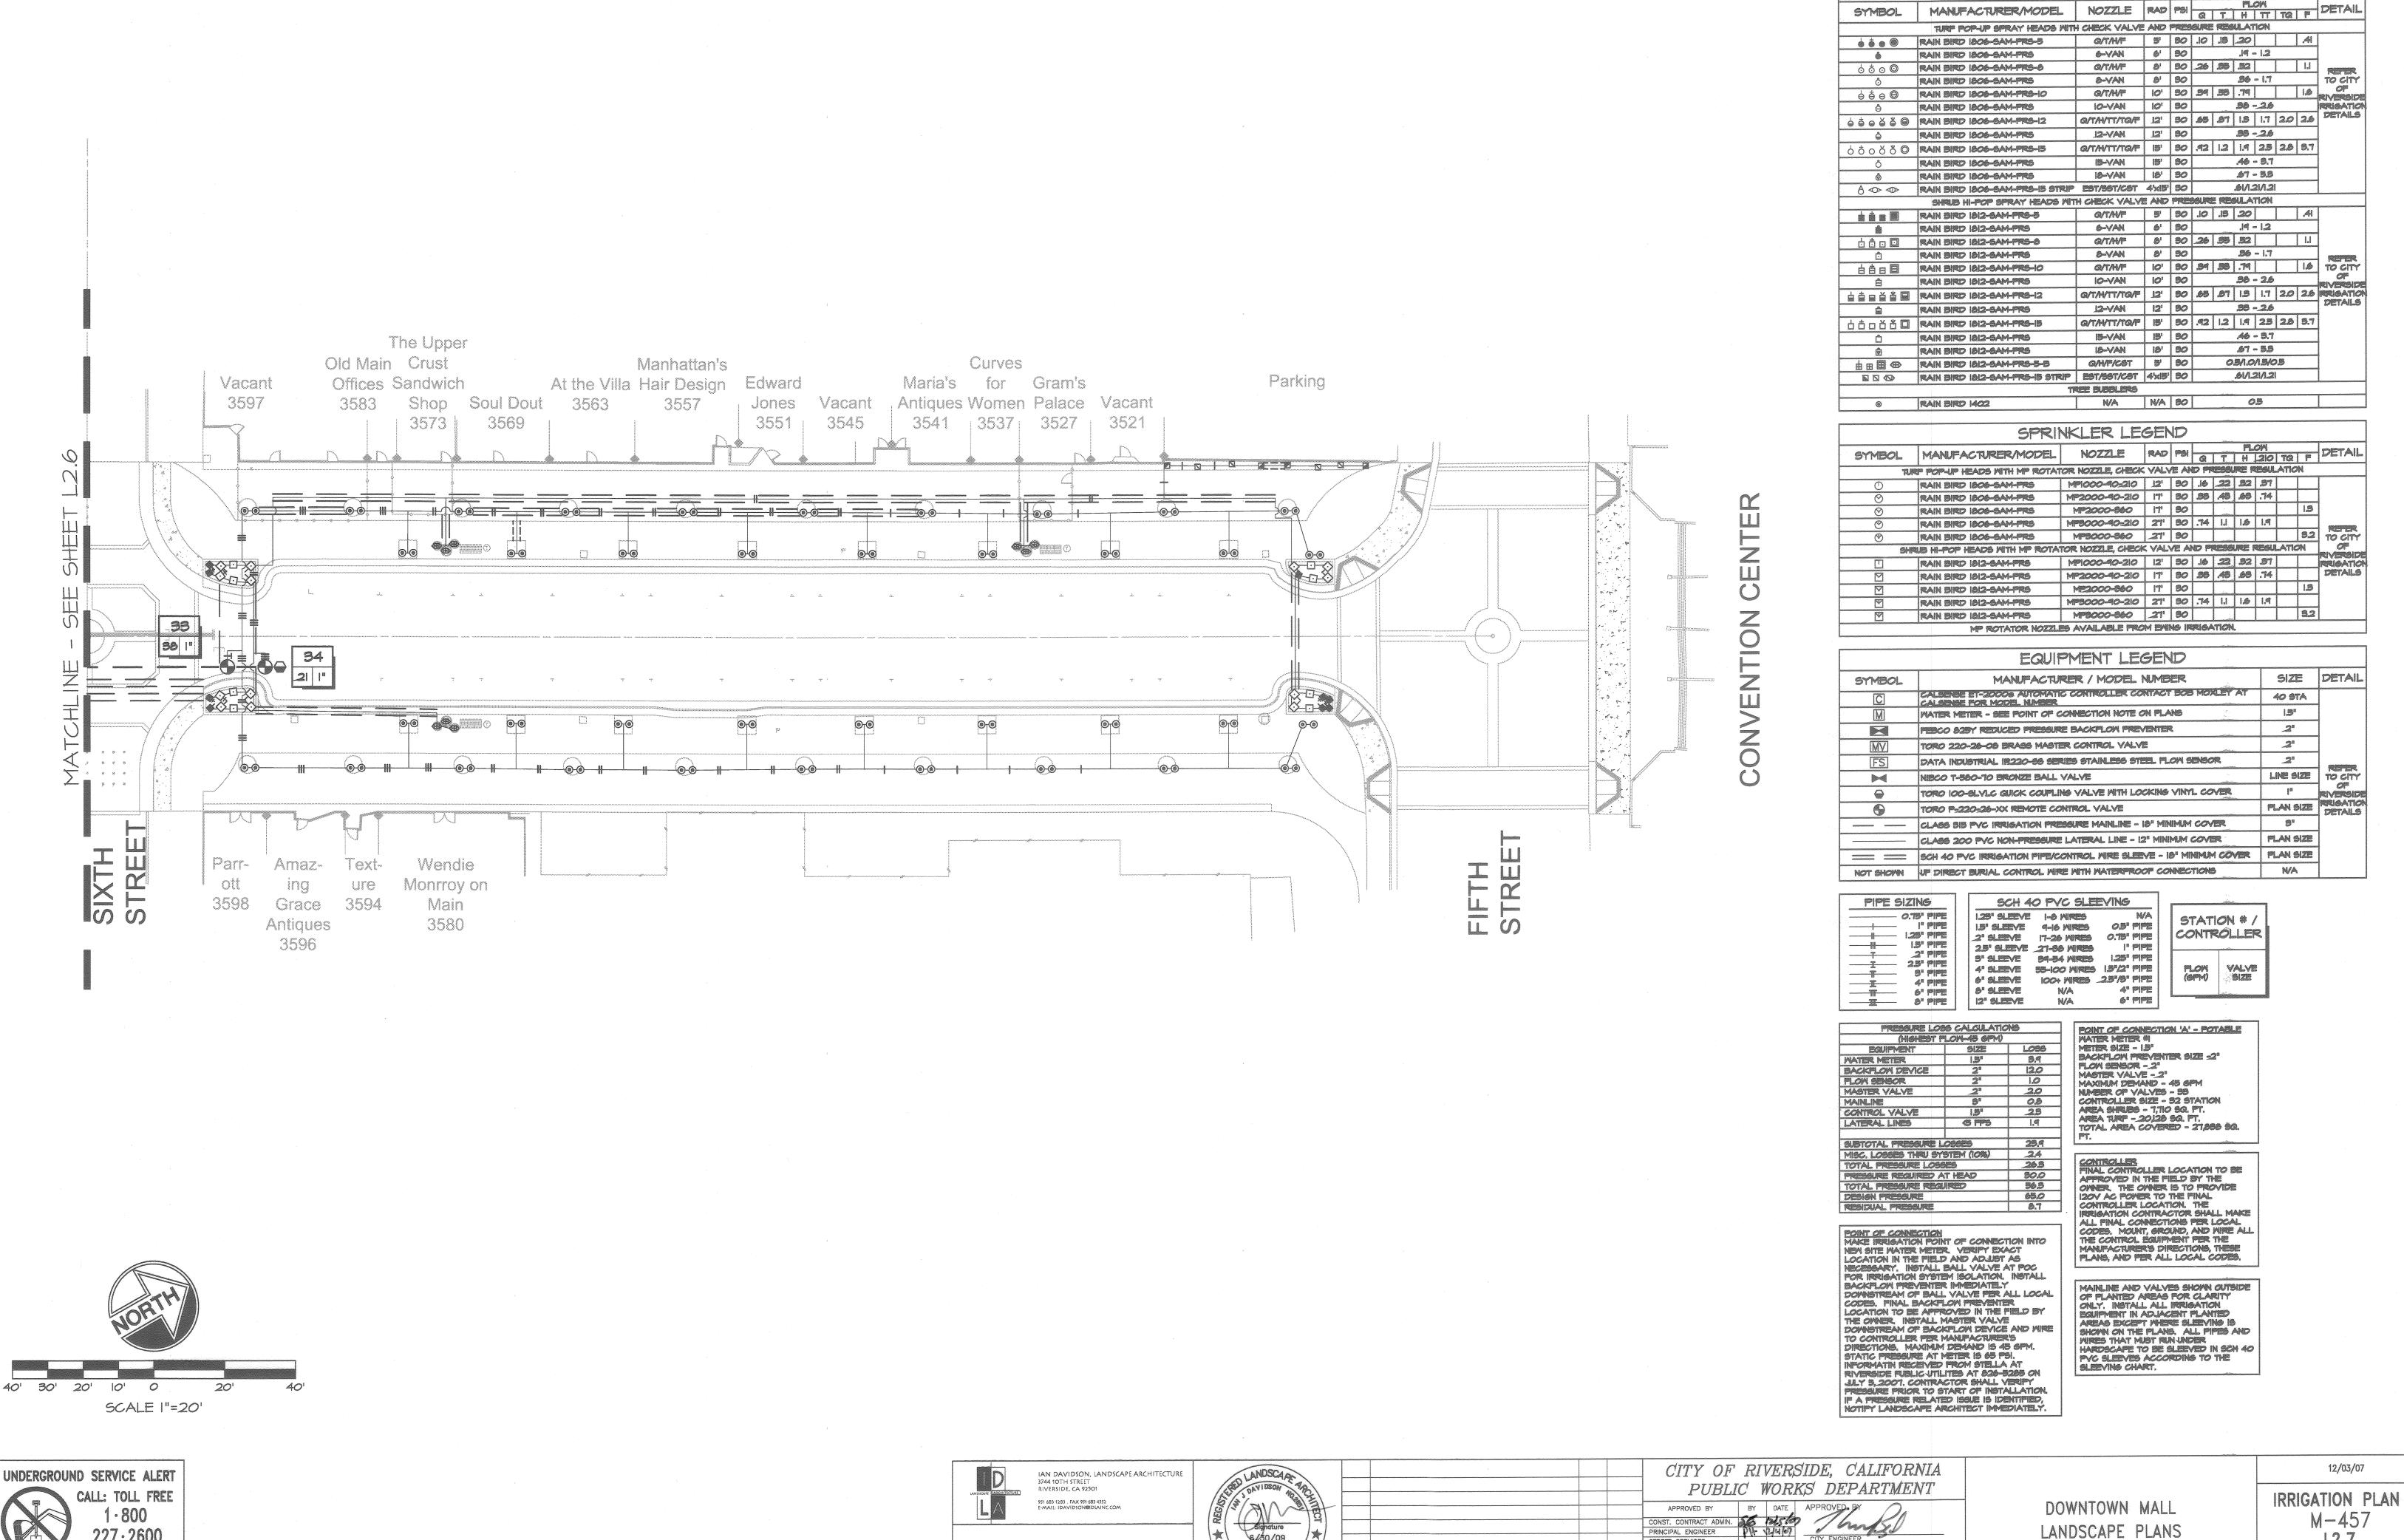

STATE OF CALFO.

TWO WORKING DAYS BEFORE YOU DIG

SHEET 54 OF 100

M-457

SPRINKLER LEGEND

CITY ENGINEER

DATE 19/5/07


STREET SERVICES


PARKS DEPARTMENT

DESIGNED BY ______ DRAWN BY ______ MA__ CHECKED BY ______ UD





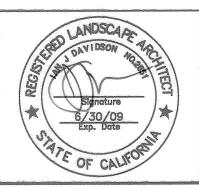


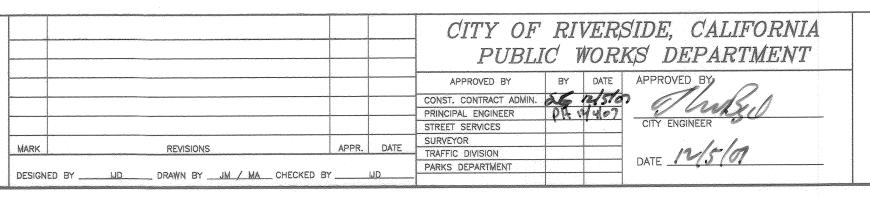





REDUCED PRESSURE BACKFLOW DEVICE

Date

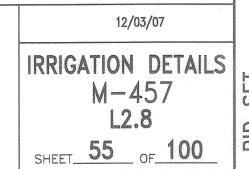



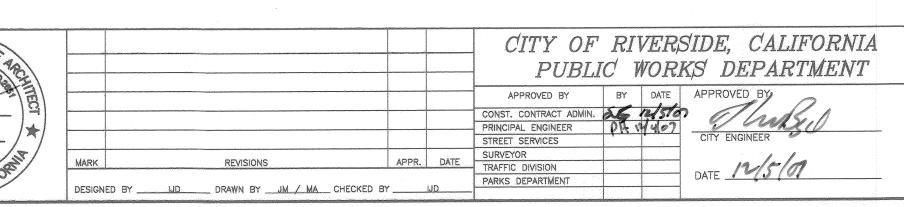

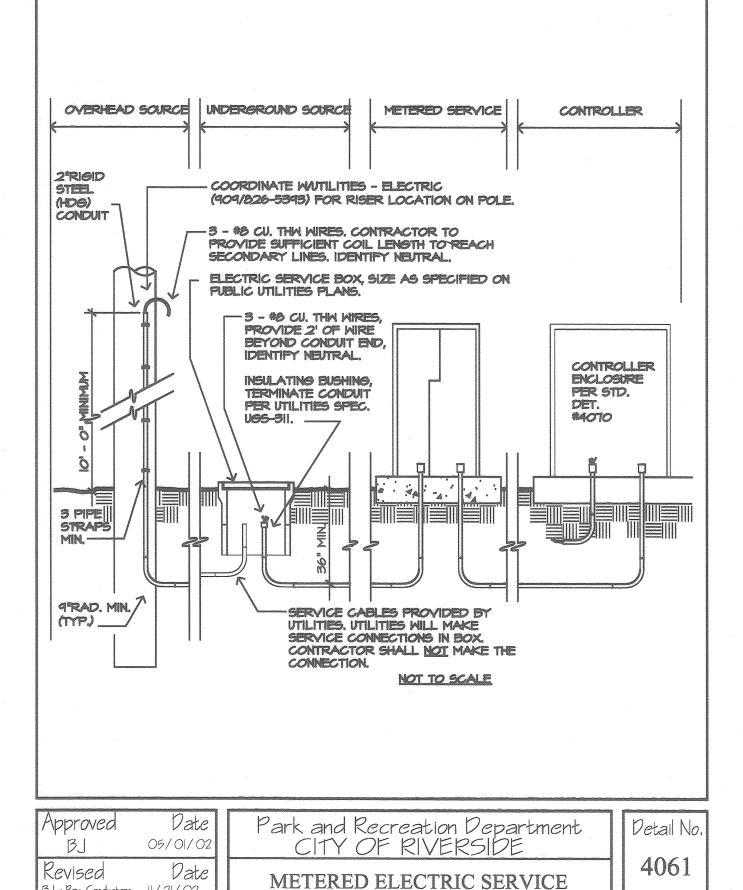

- ISOLATION VALVE

PER SPECS

4" MAX.

Park and Recreation Department

ISOLATION VALVE IN BOX

CITY OF RIVERSIDE

SCH 40 PVC SLEEVE WHERE

Detail No.

UNDER PAVEMENT

NOT TO SCALE

PVC UNION -

P.V.C. MALE

ADAPTER -

VALVE BOX PER

SPECS.

SPECIFIED -

WHERE PIPE GRADE MUST CHANGE

Date

Date

08/28/03

IN LESS THAN 10' HORIZONTAL

DISTANCE, USE 45 DEGREE ELL


MULCH AS

FITTINGS

Approved

Revised

BJ-Rev. Conductors 11/21/02

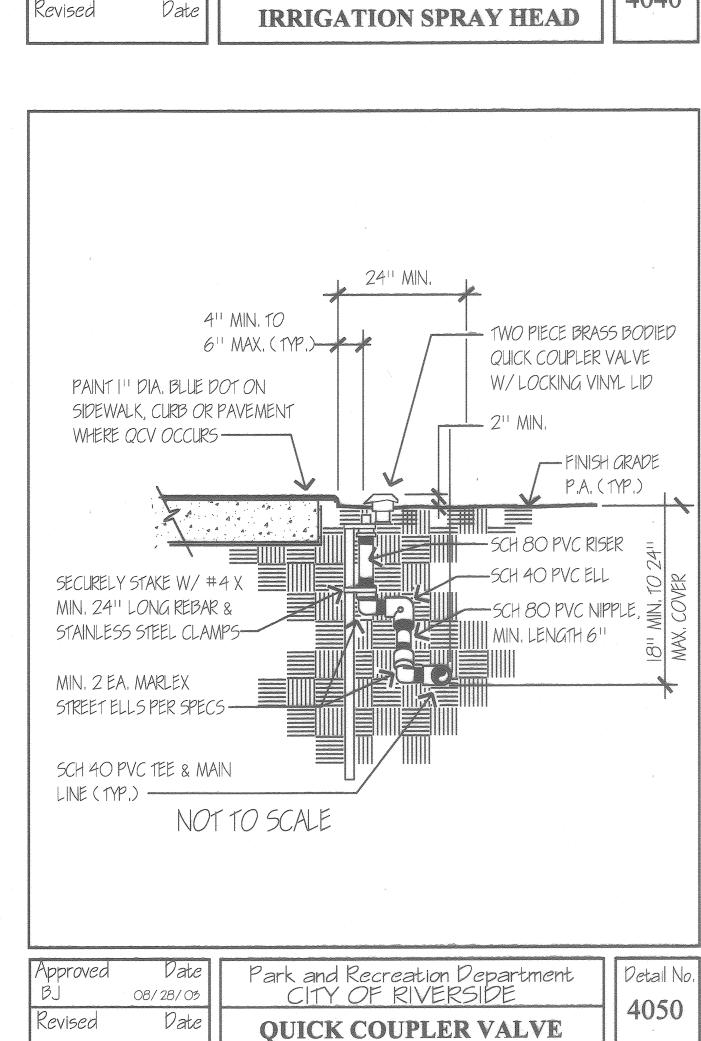

Park and Recreation Department

CITY OF RIVERSIDE

2" MIN. TO

SIDEWALK, CLIRB OR

PAVEMENT WHERE

OCCURS -

TRENCH

BACKFILL (TYP.)

MIN. 2 EA. MARLEX

SCH 40 PVC TEE &

NOT TO SCALE

Date

08/28/03

Approved

LATERAL LINE (TYP.)——

STREET ELLS PER

4" MAX. (TYP.)


-2" MIN. - FINISH GRADE


(MP.)


-SCH 80 PVC NIPPLE

Detail No

MIN, LENGTH 6"

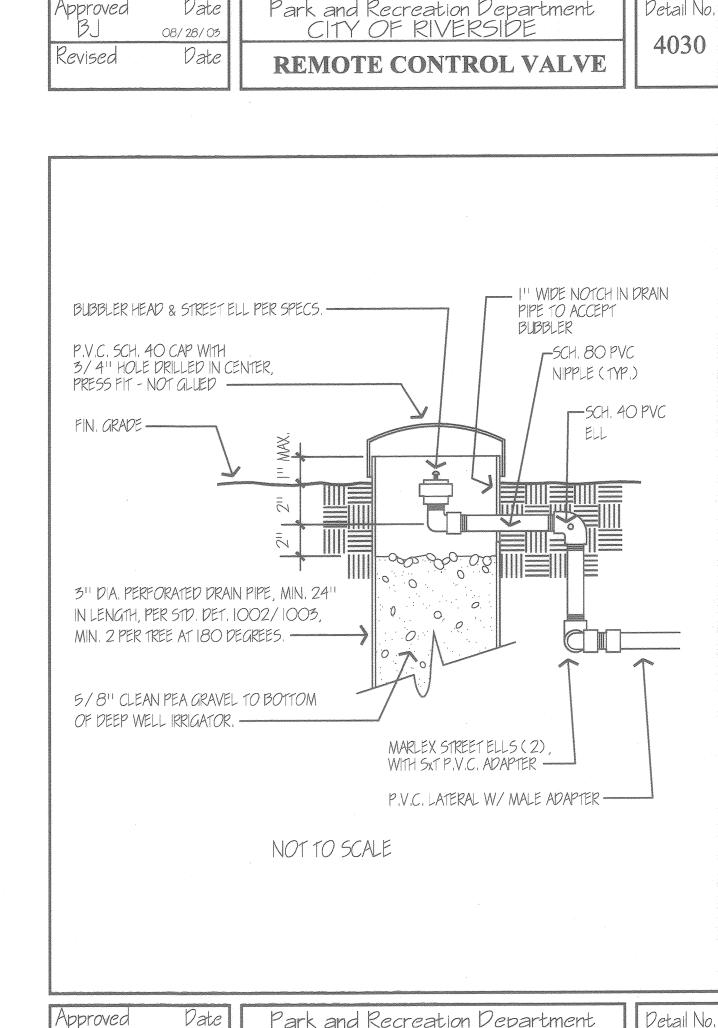


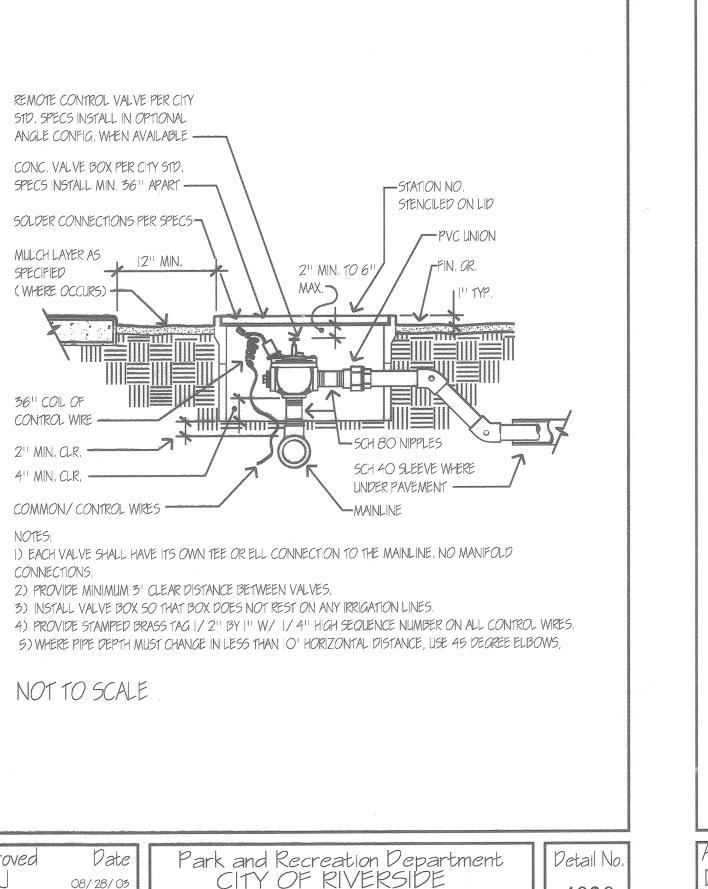

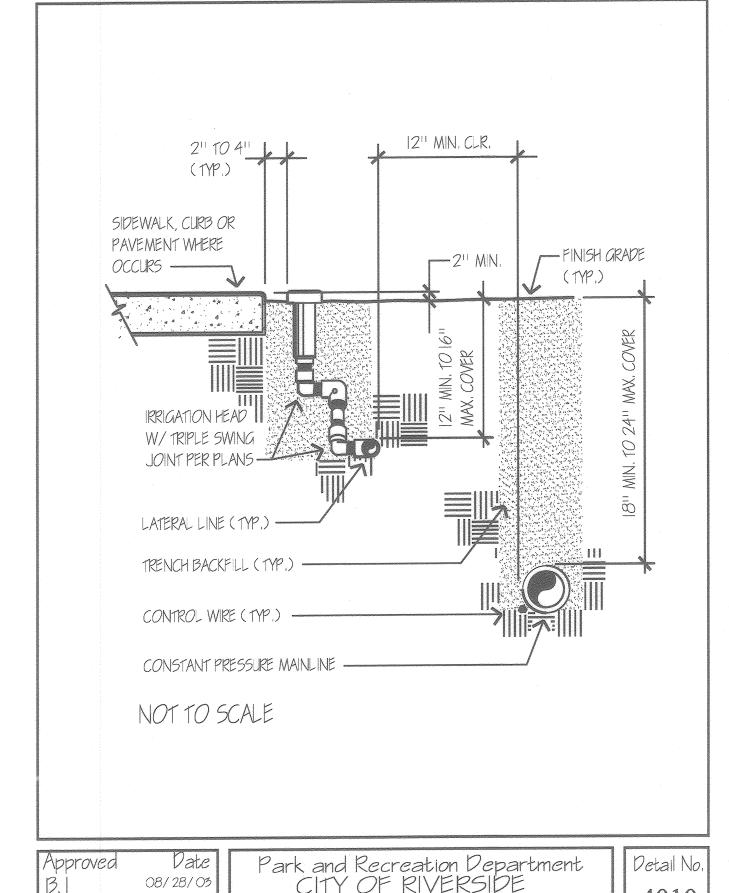



Date

Revised

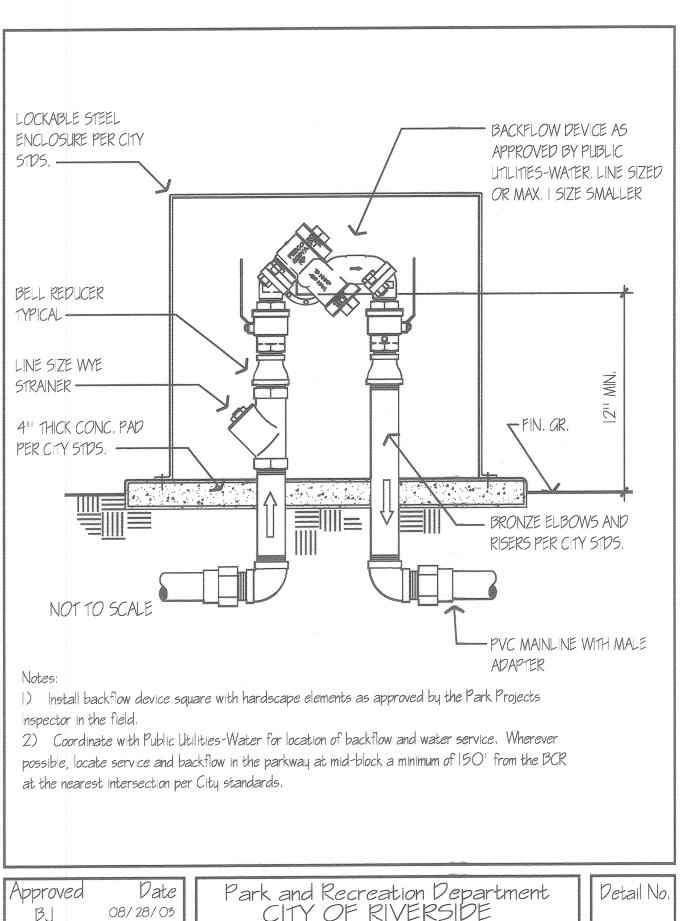



TRENCH AND LINE PLACEMENT

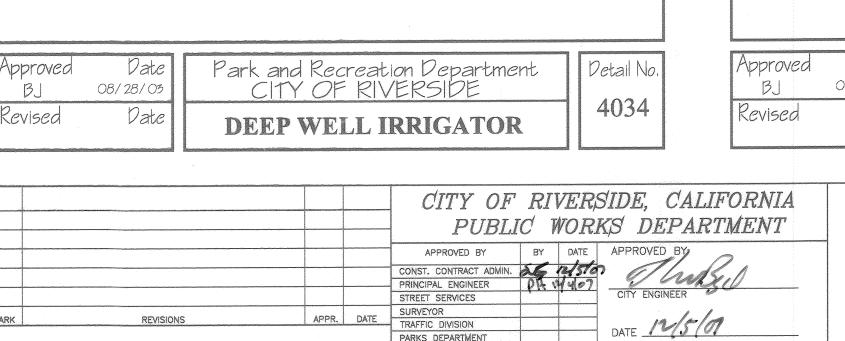


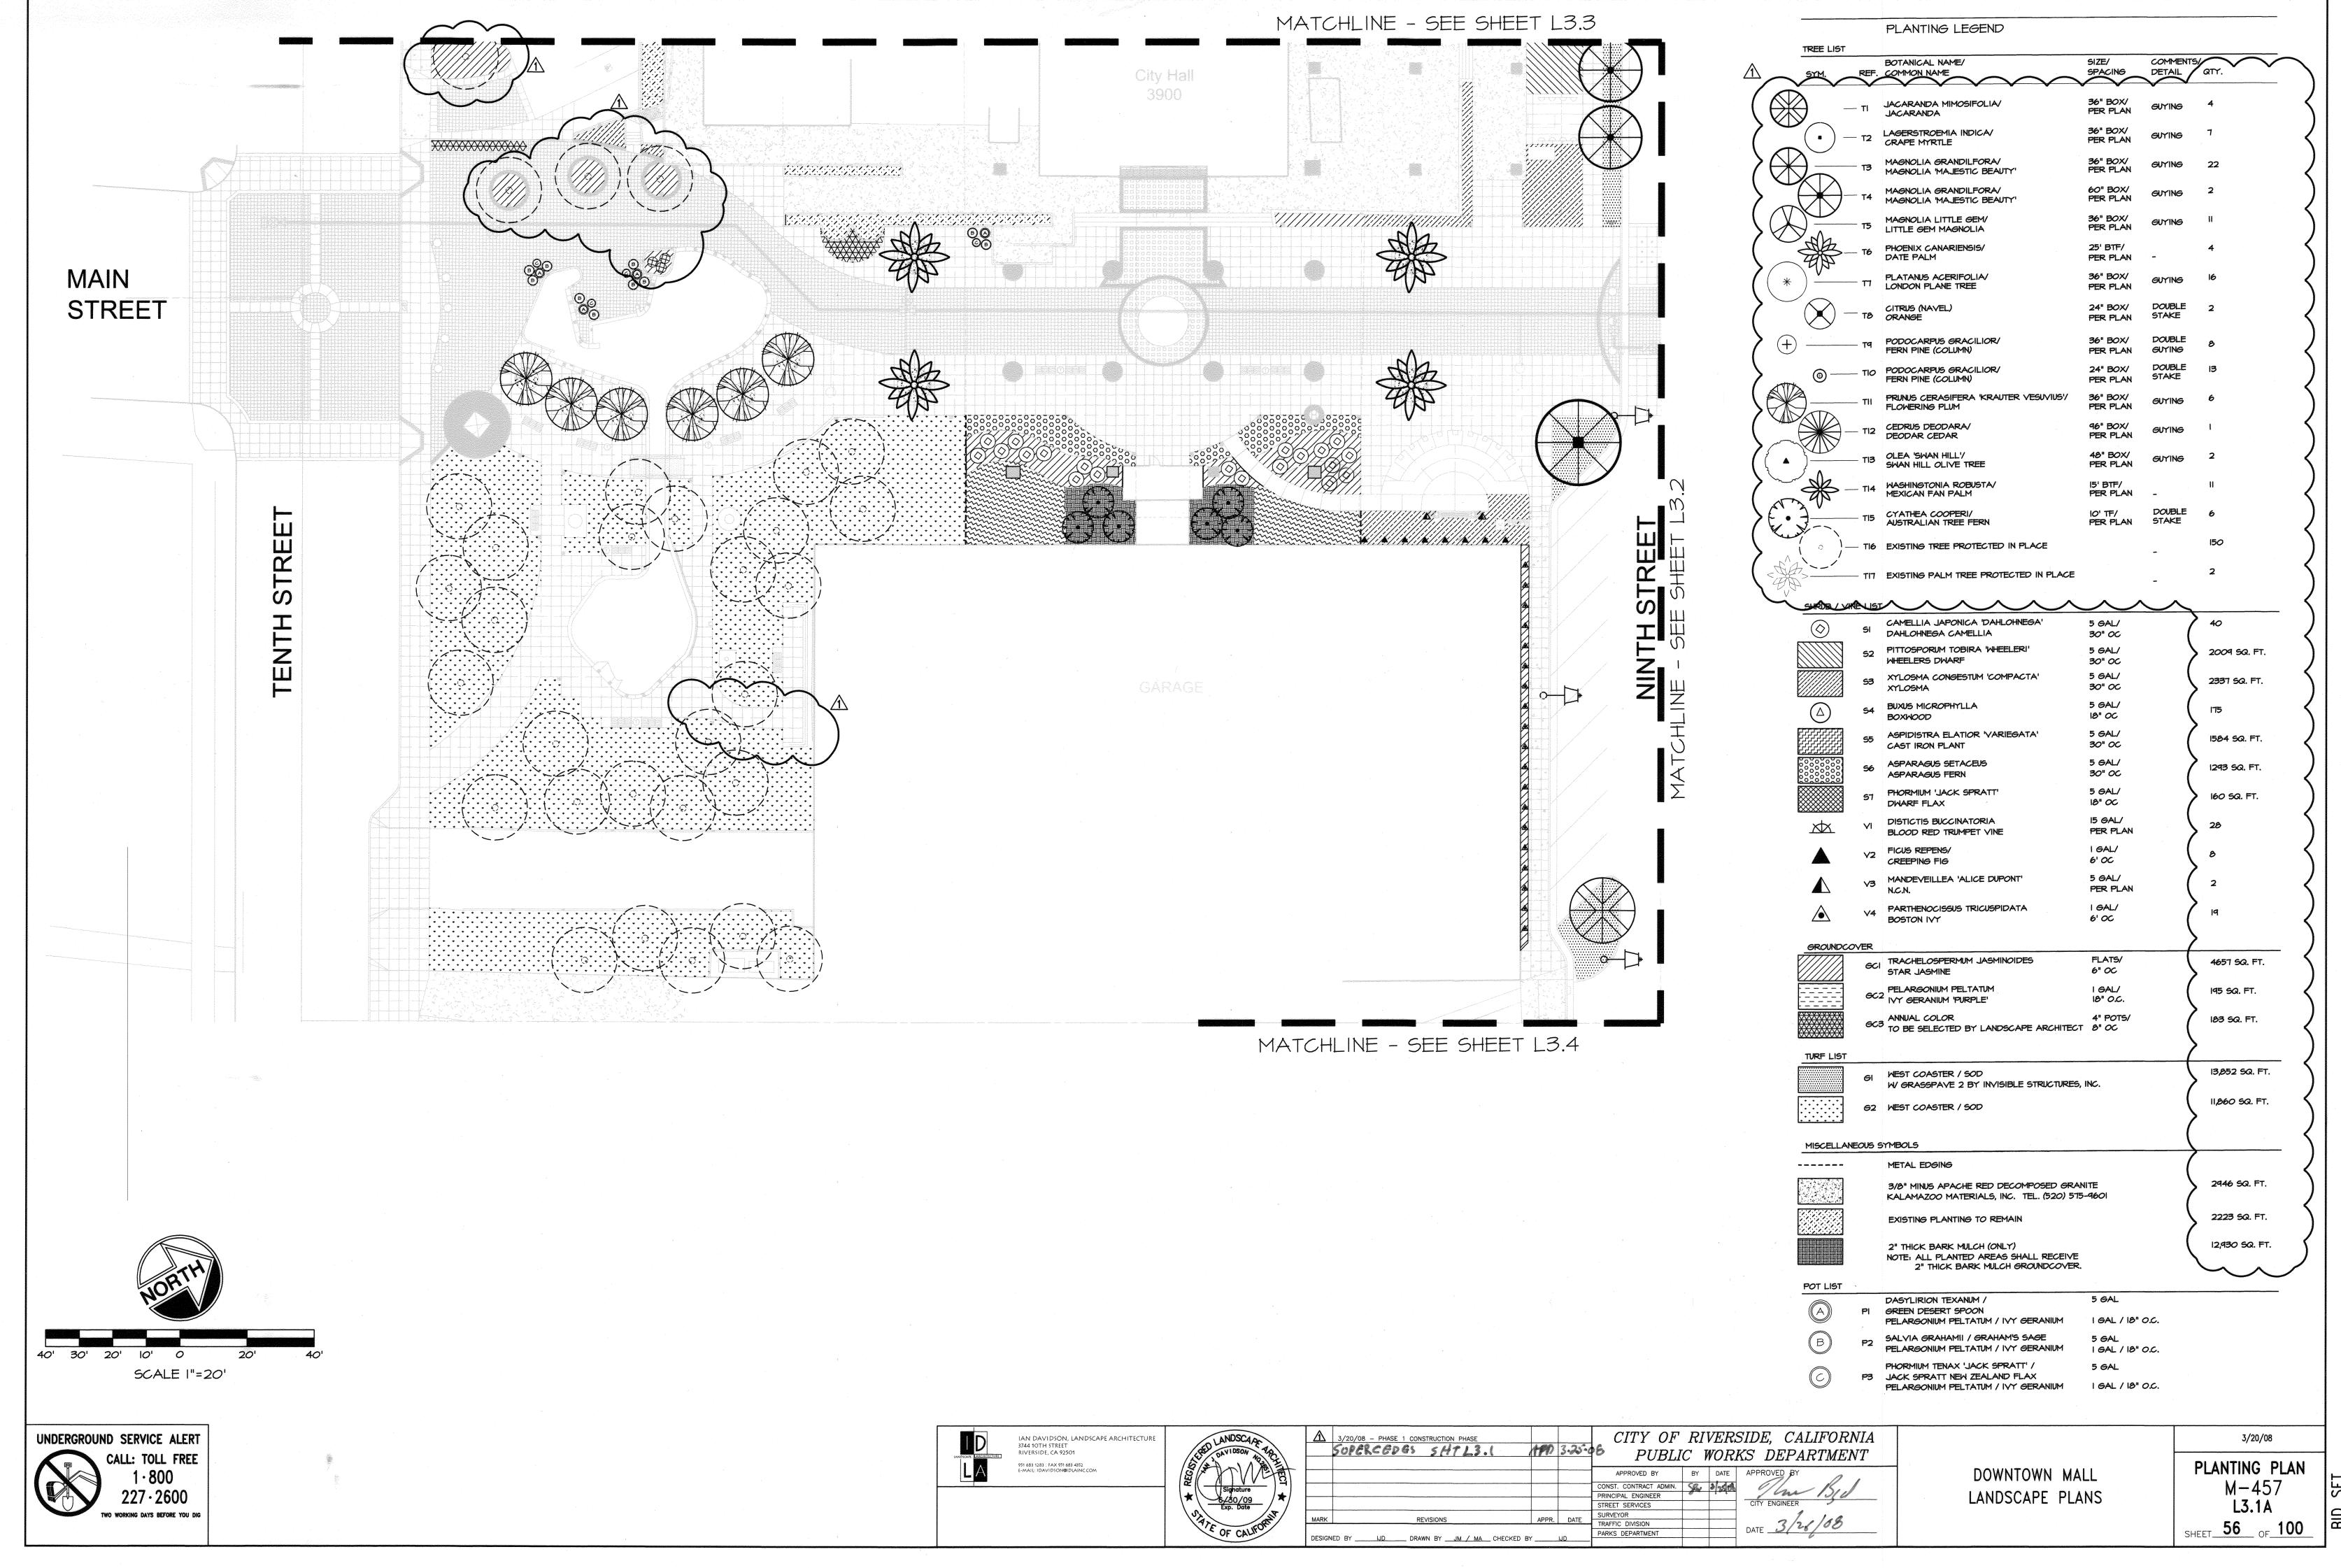


SET SET

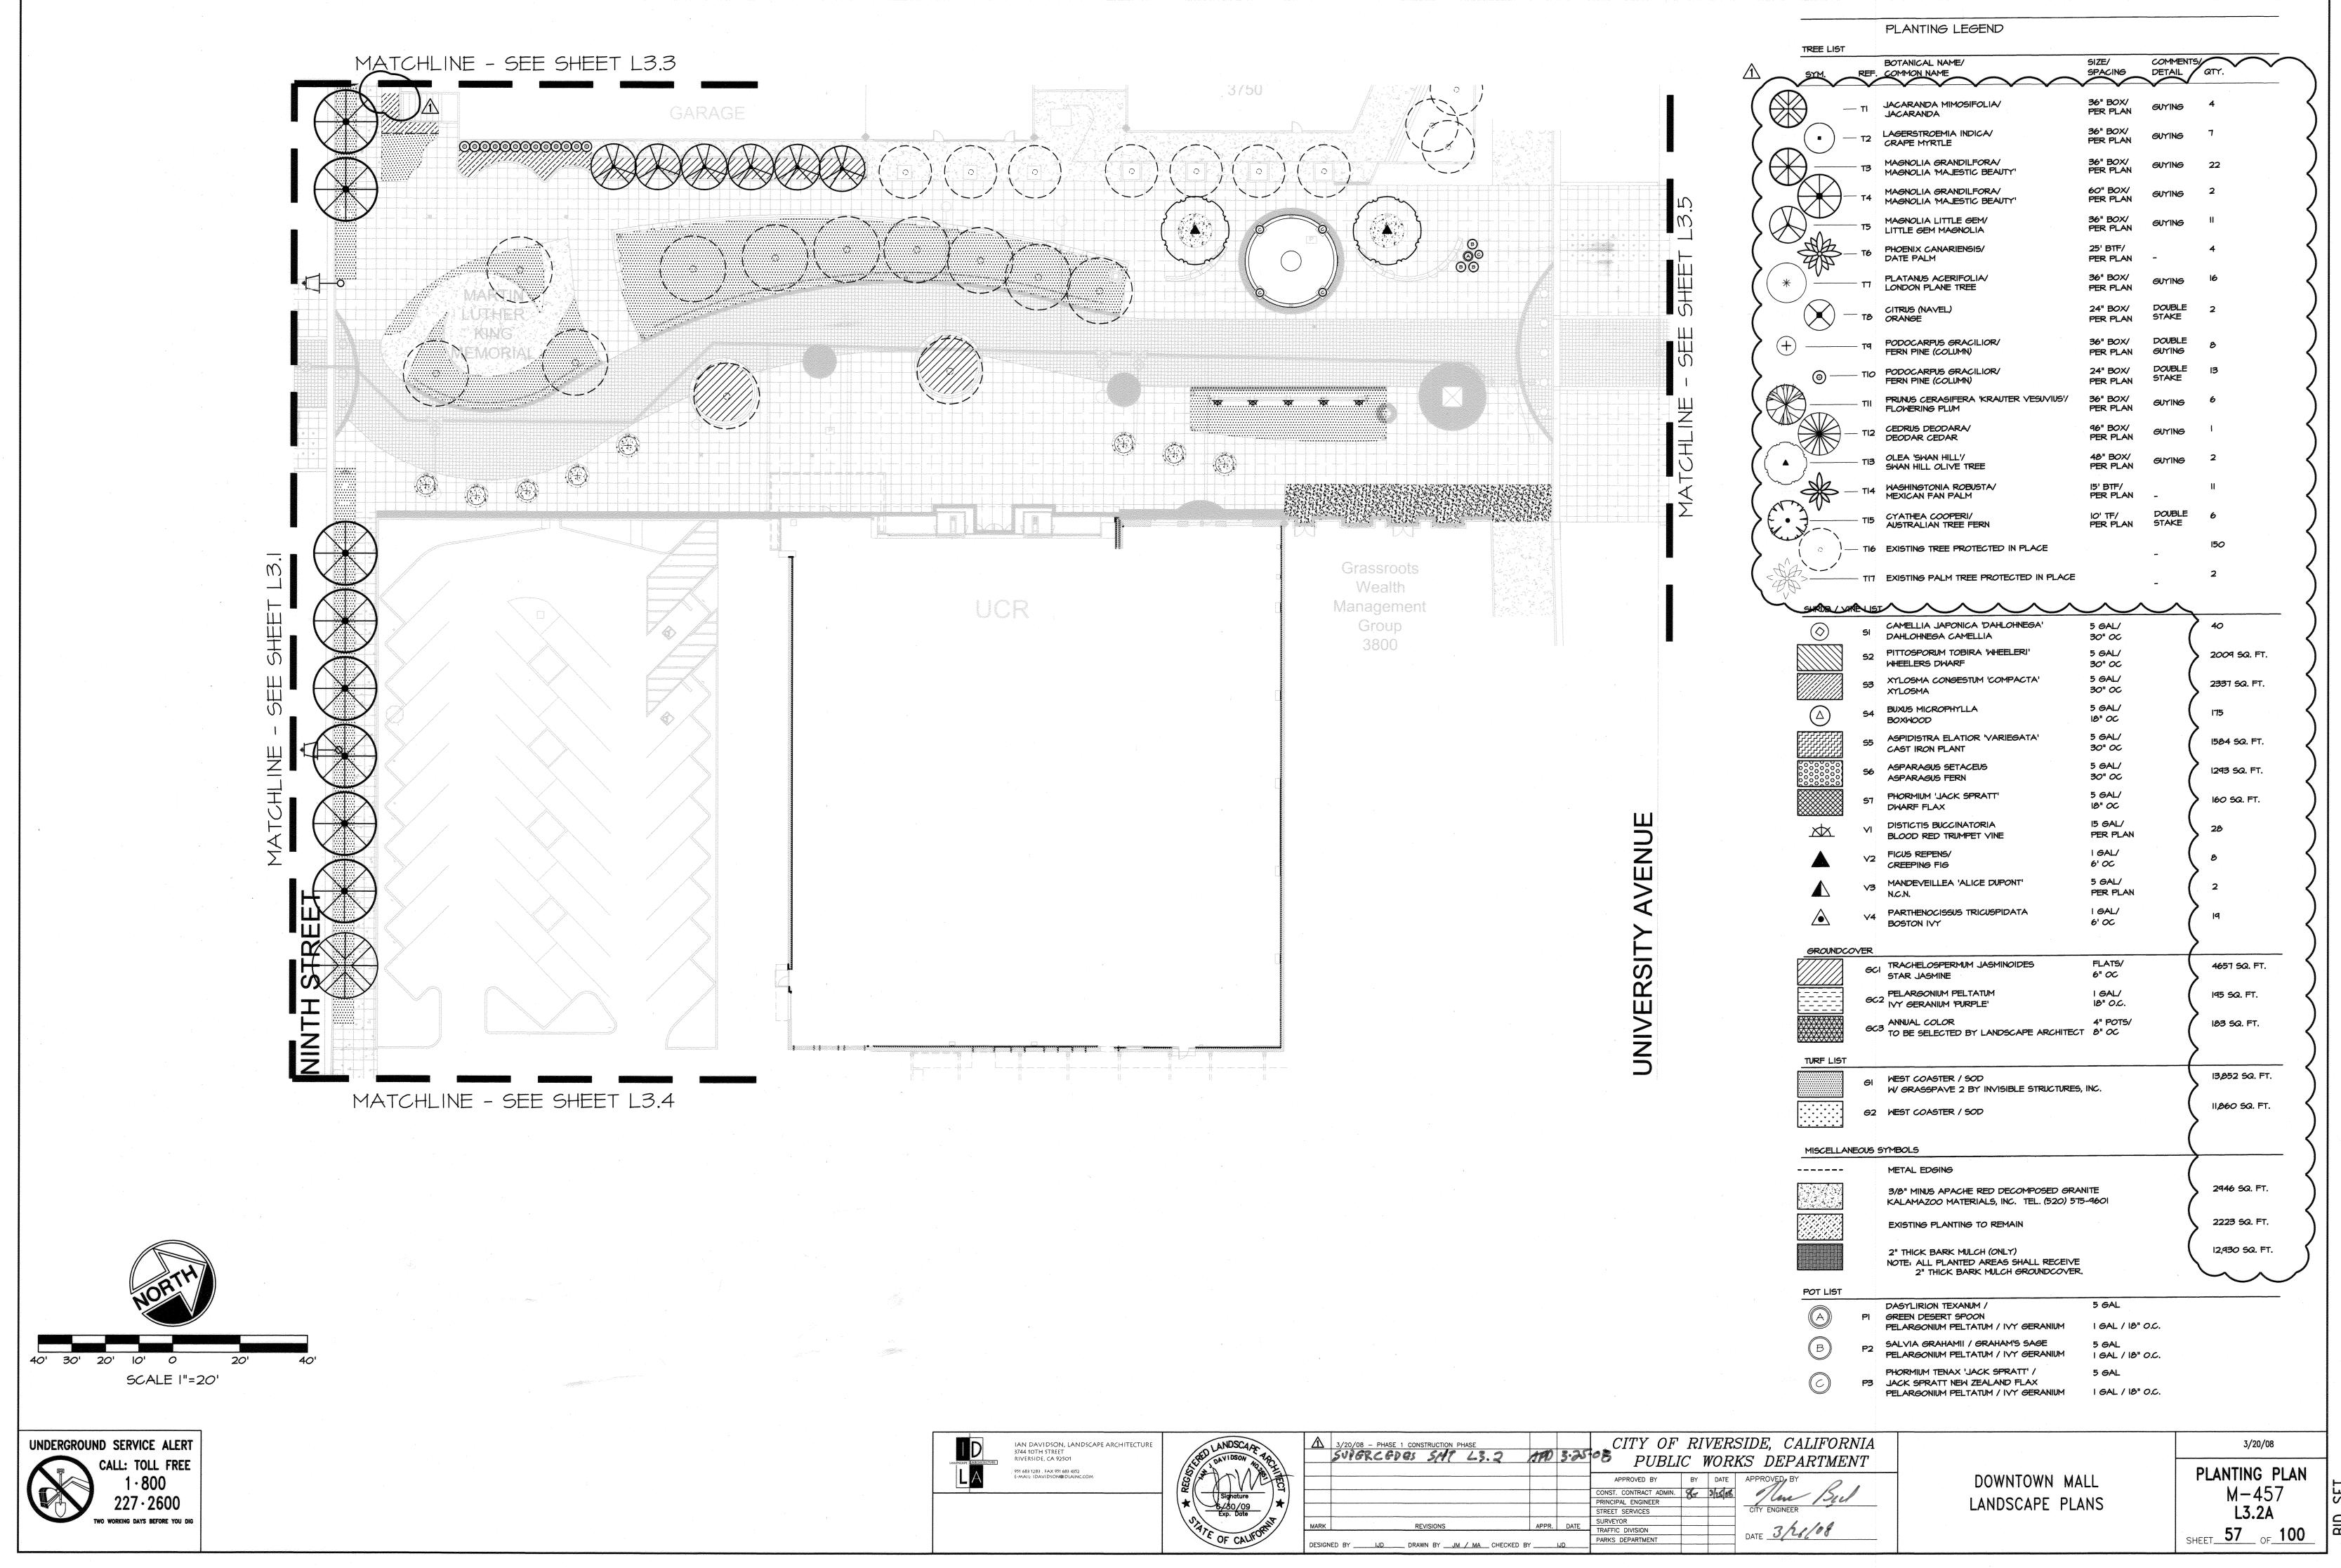

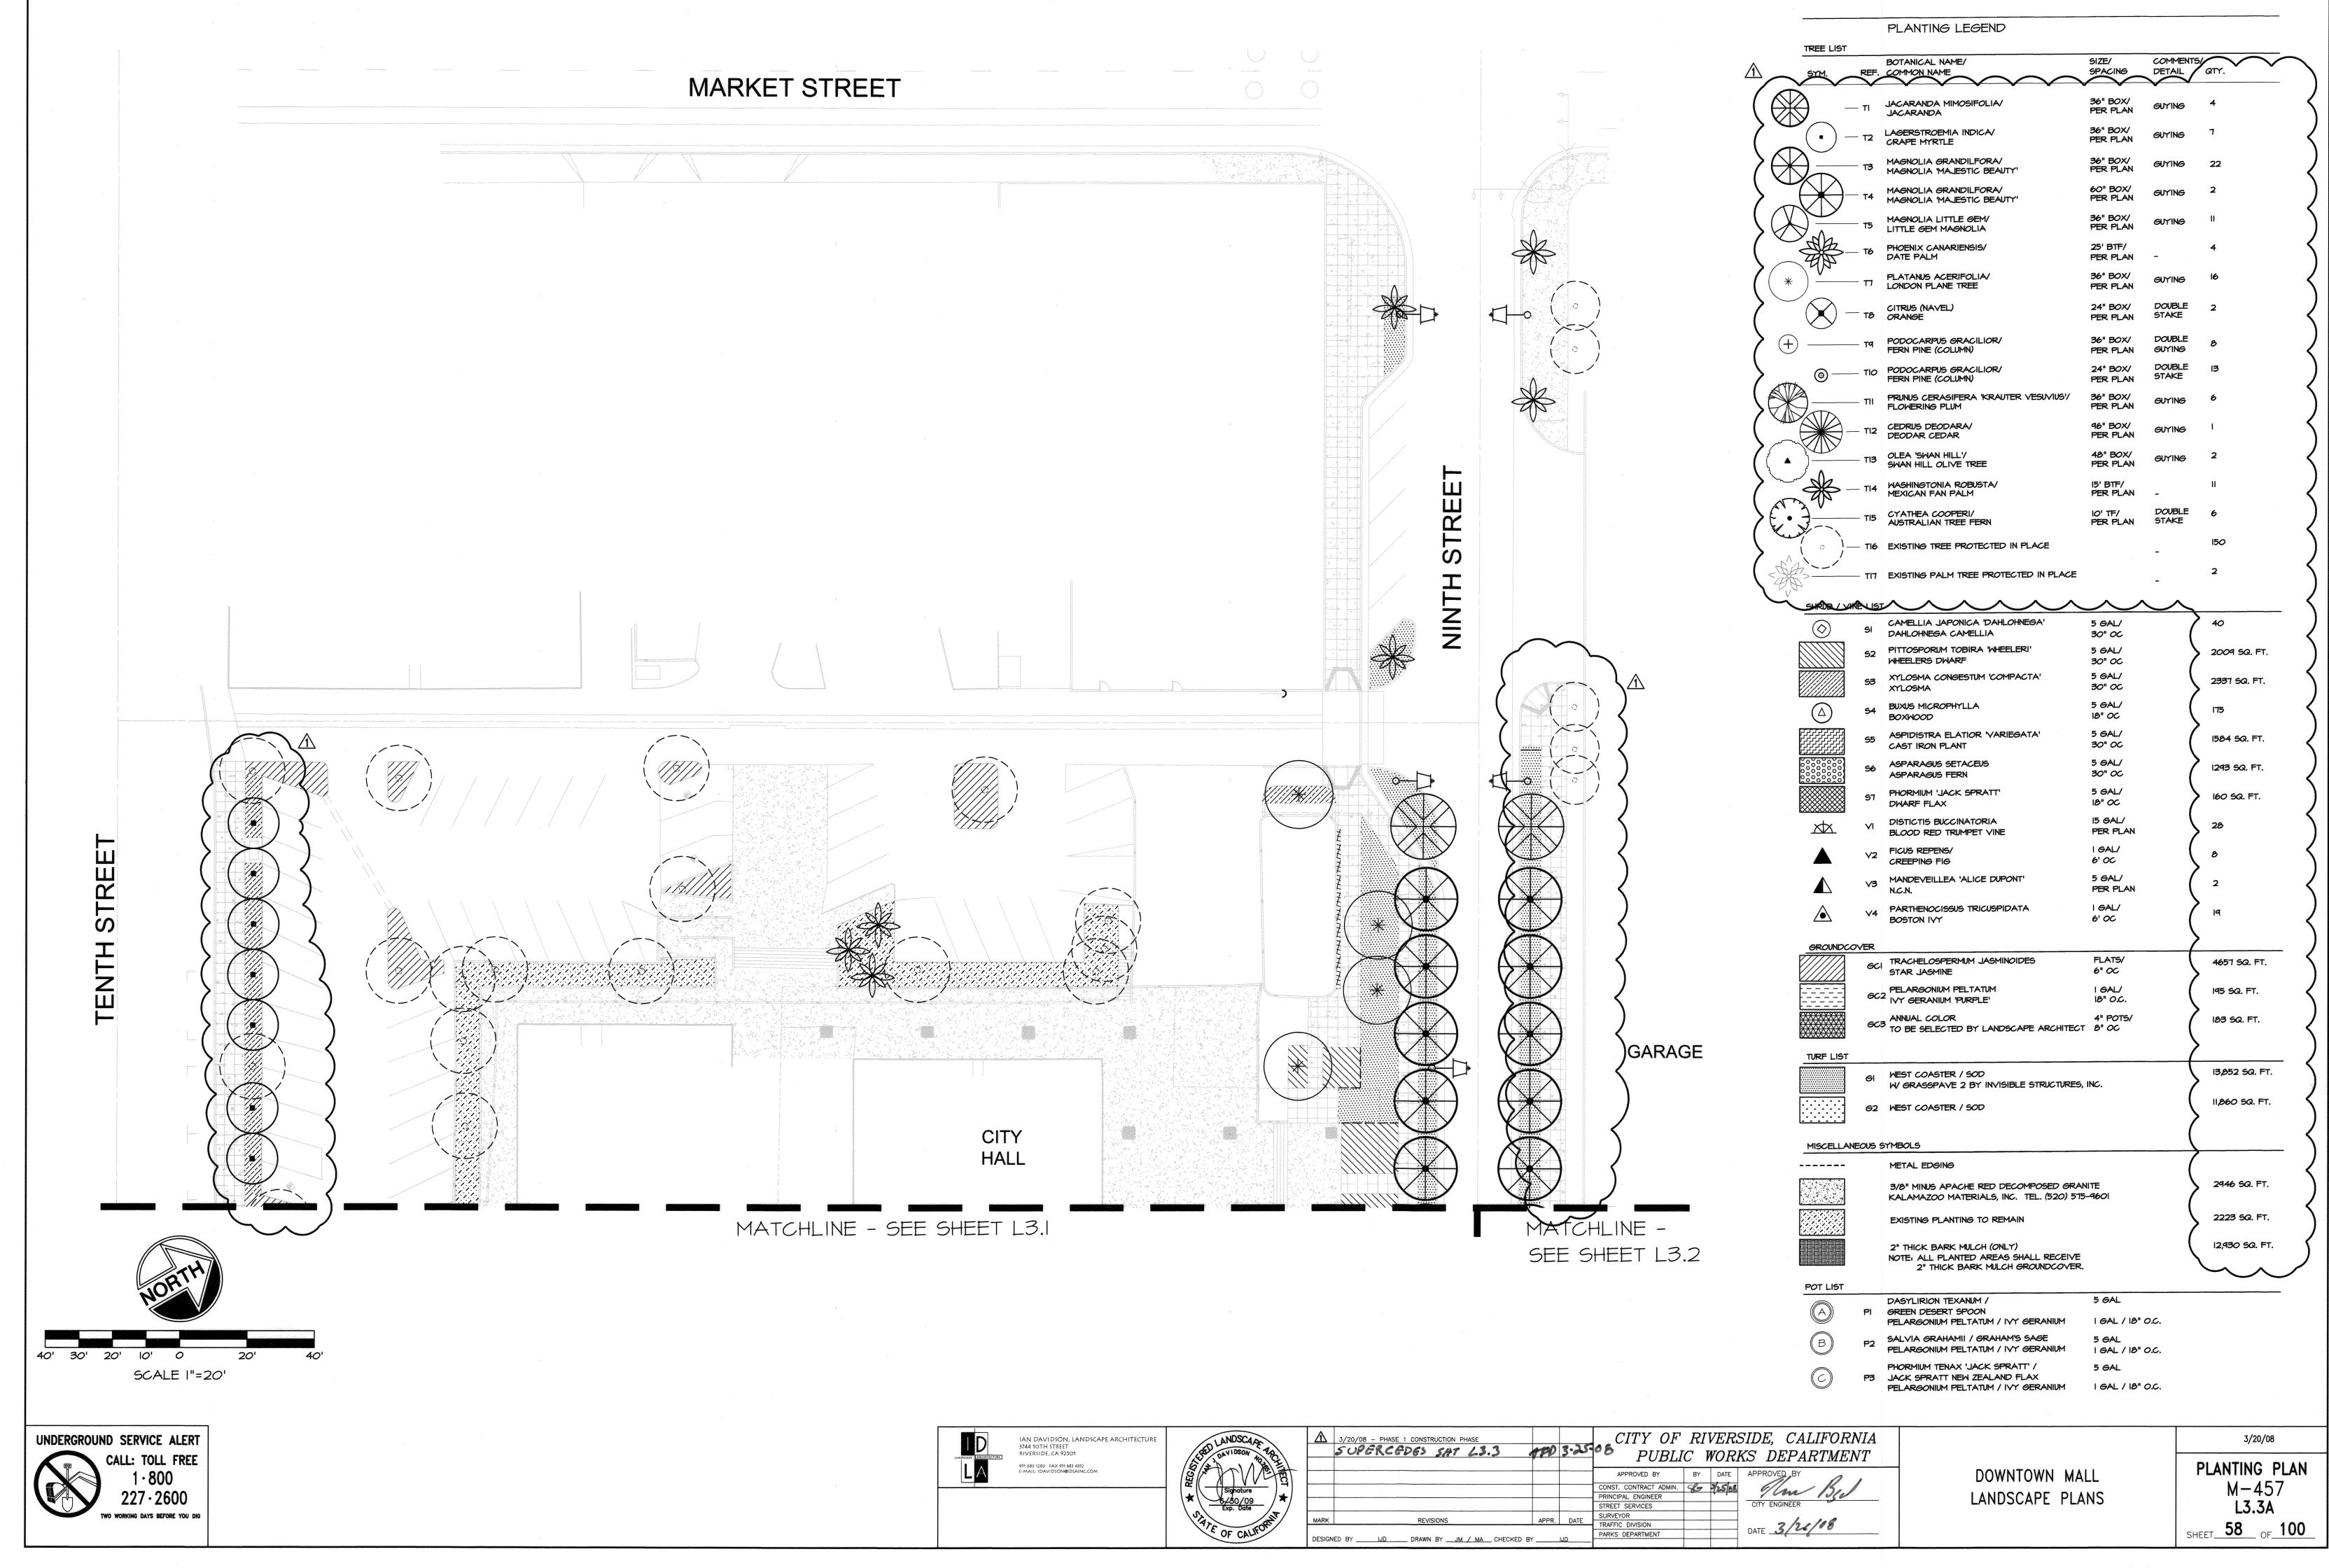

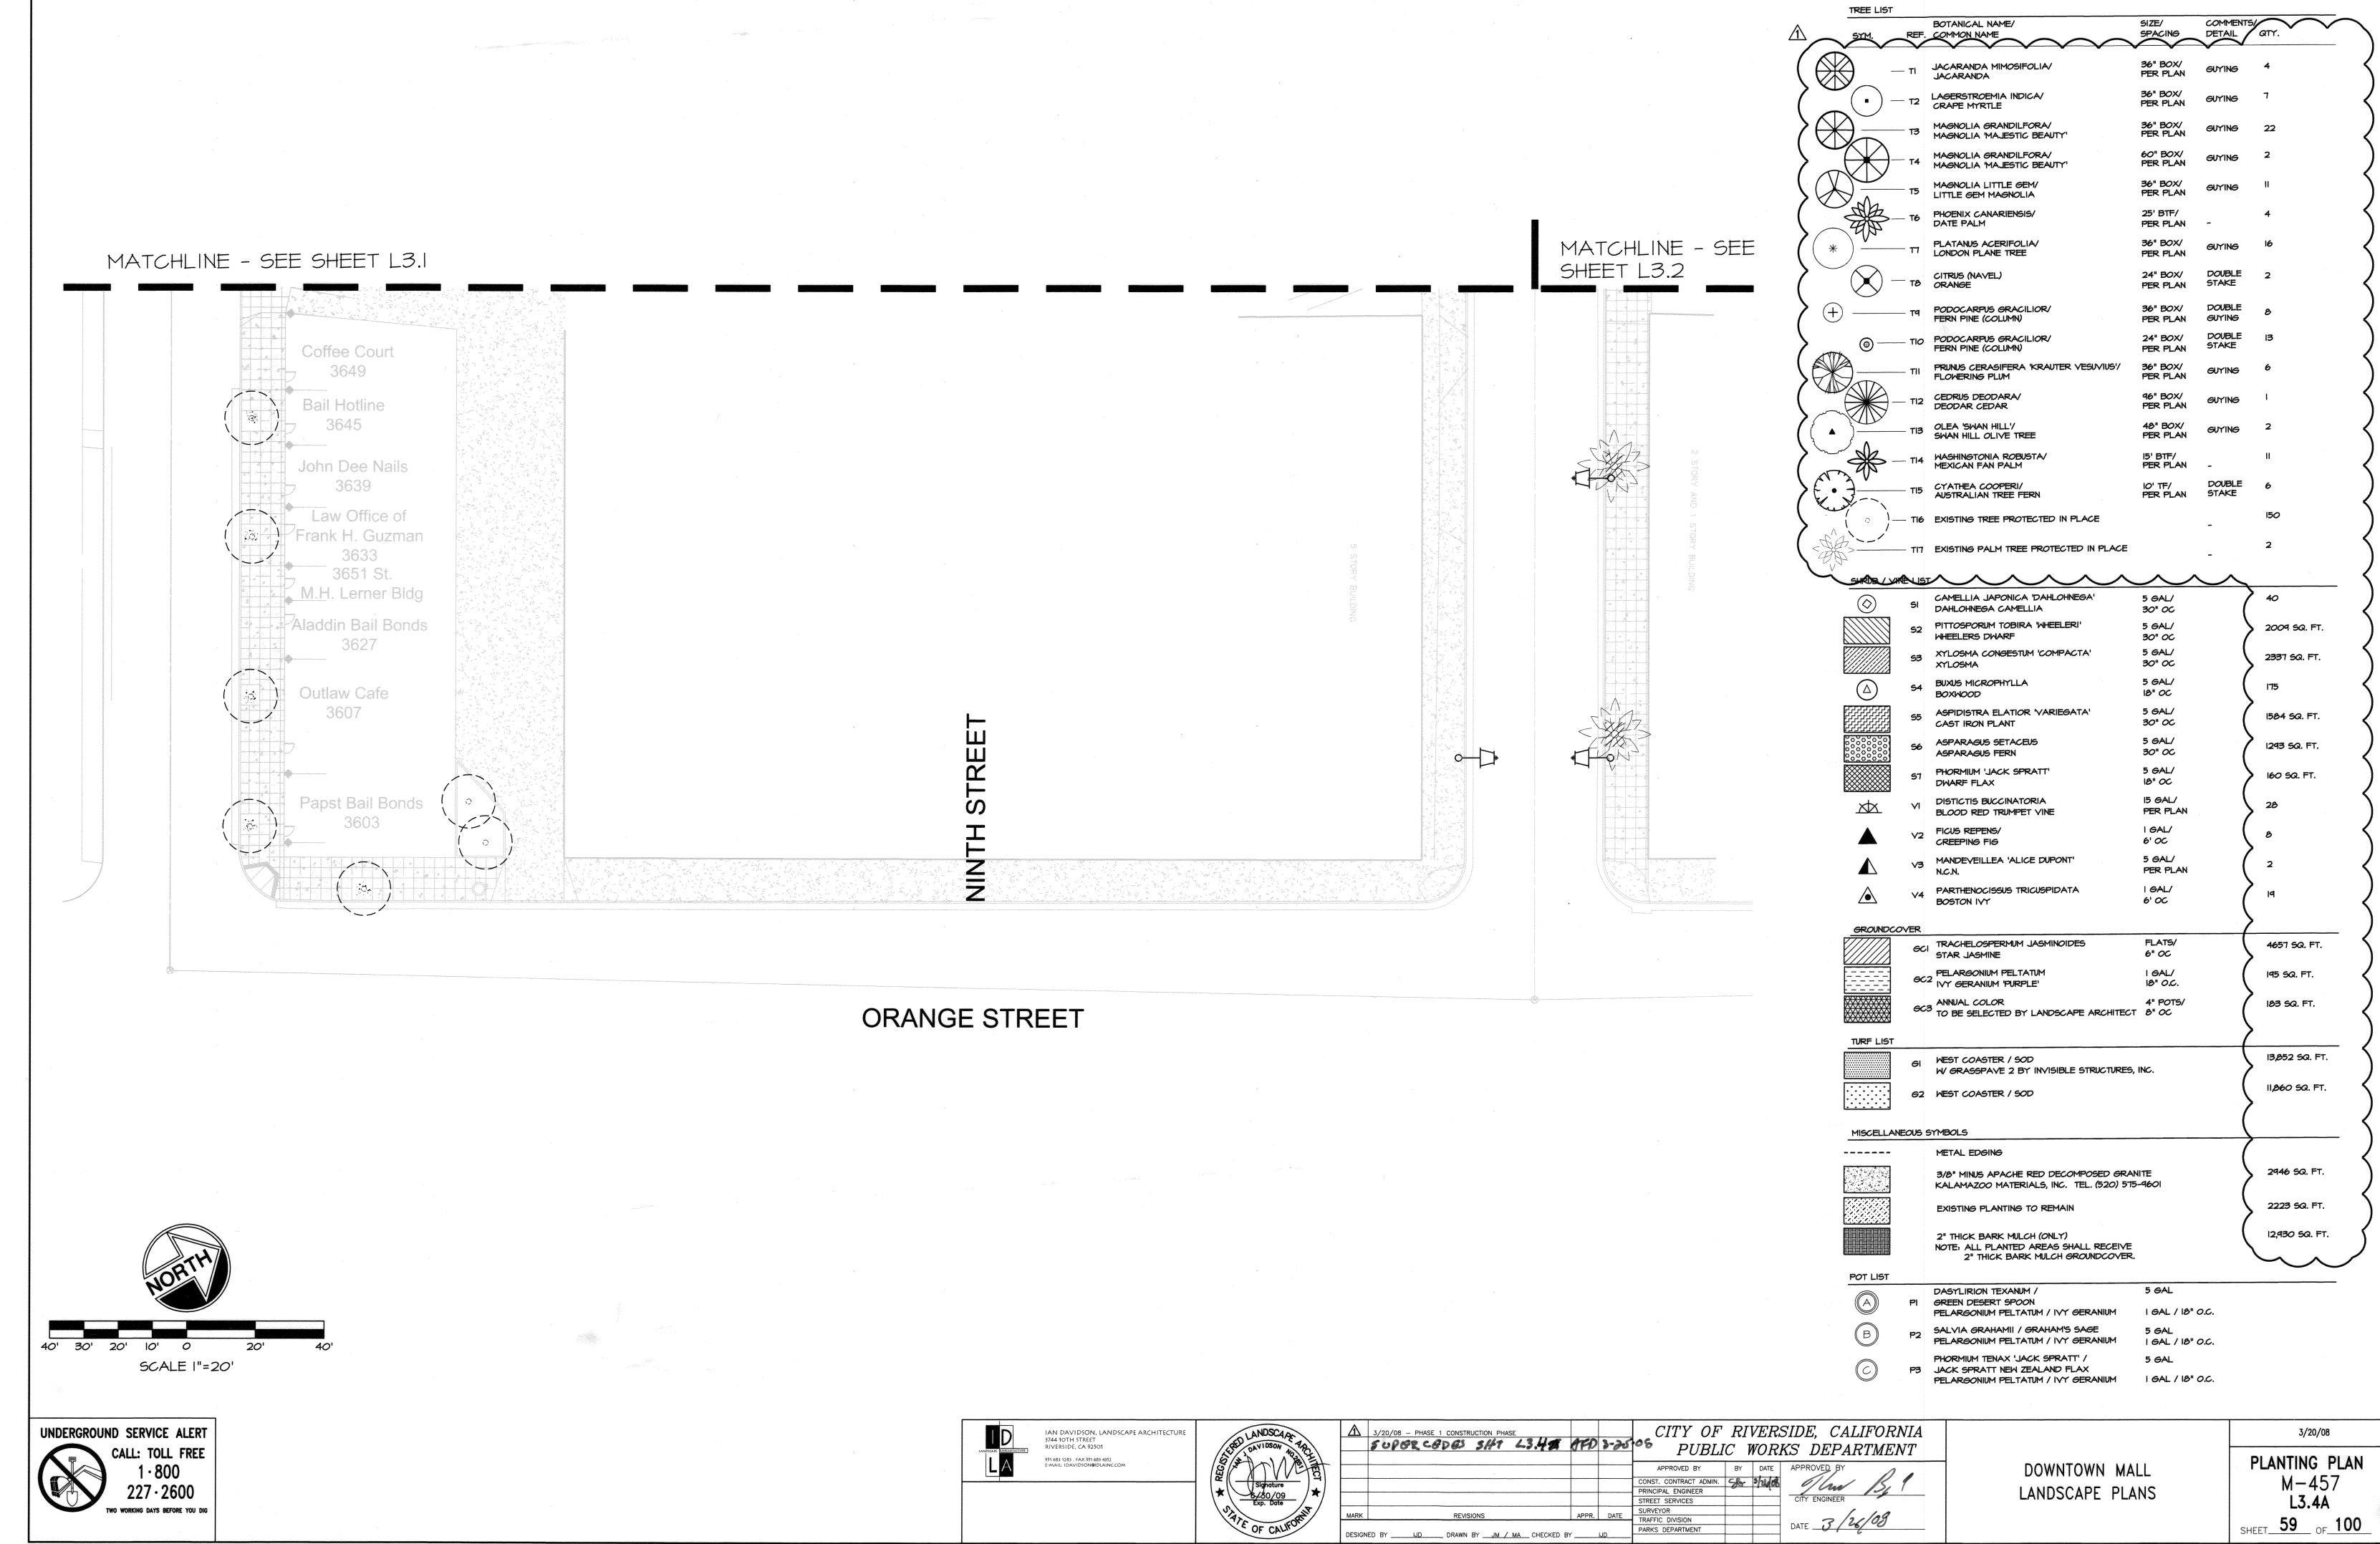

PLANTING LEGEND

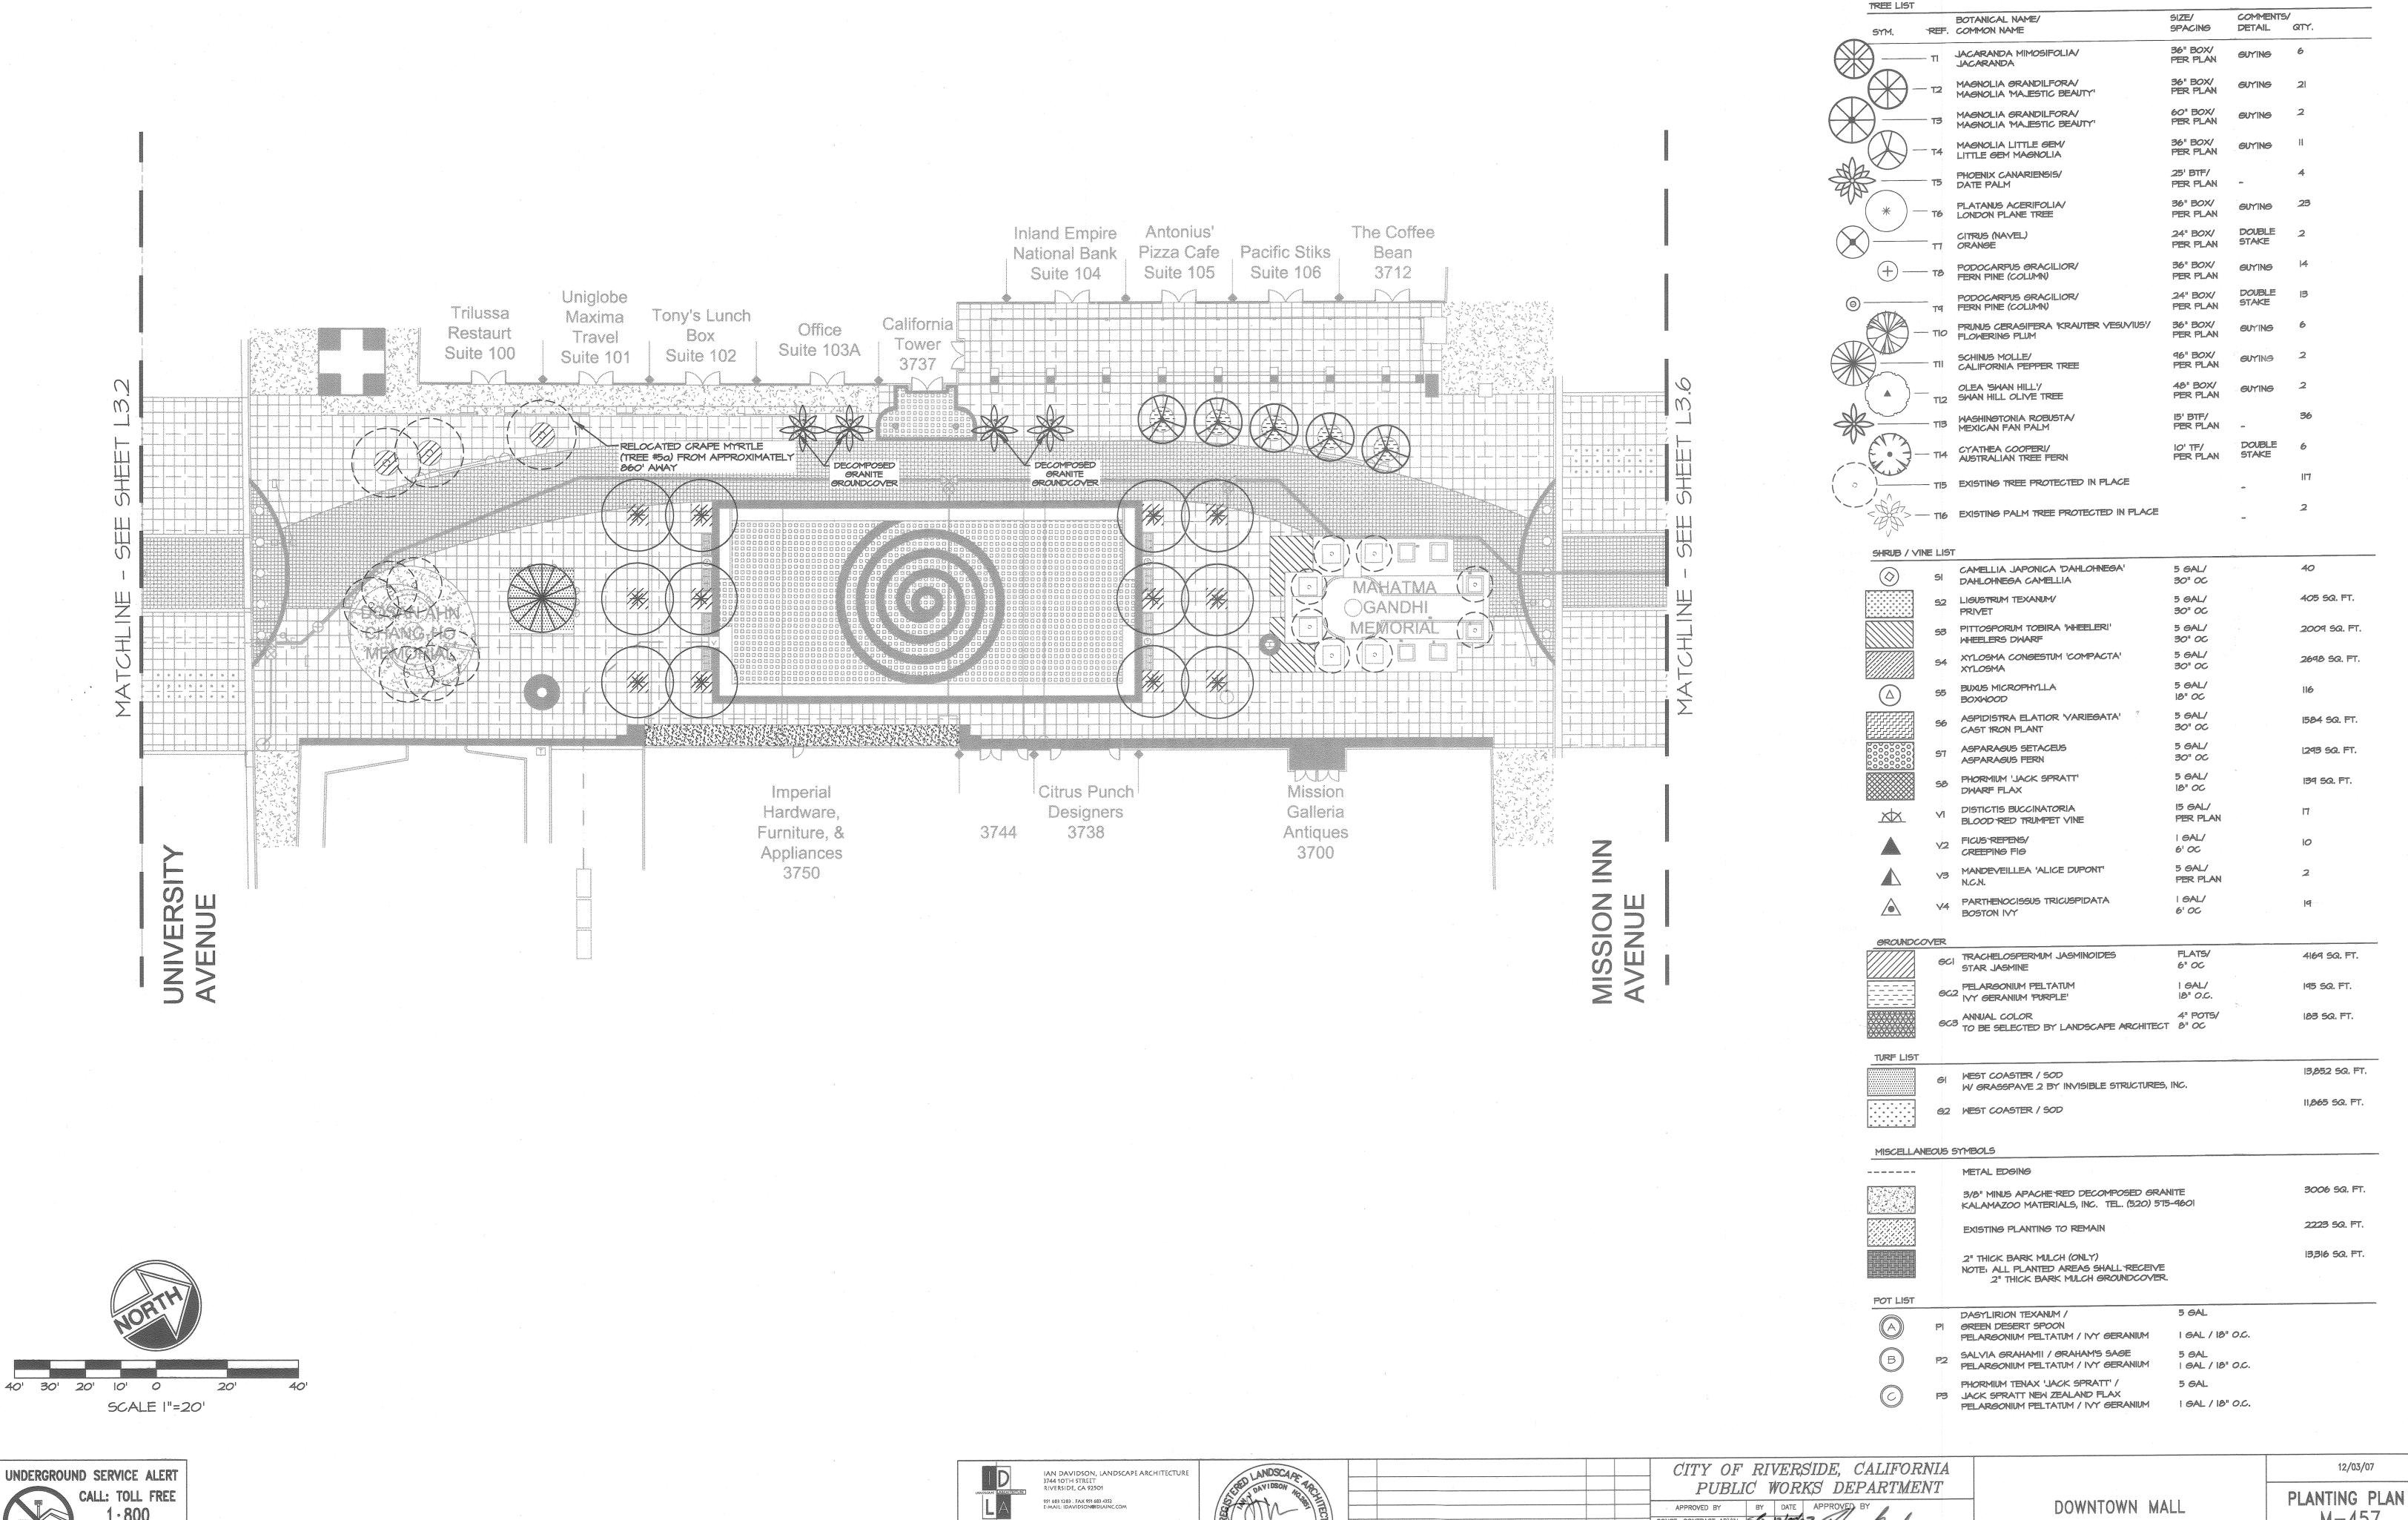

DESIGNED BY _____ JD __ DRAWN BY ____ JM / MA __ CHECKED BY _____ JD

WO WORKING DAYS BEFORE YOU DIG


BID SET


L3.5 0 _{of} 100

M-457

LANDSCAPE PLANS

PLANTING LEGEND

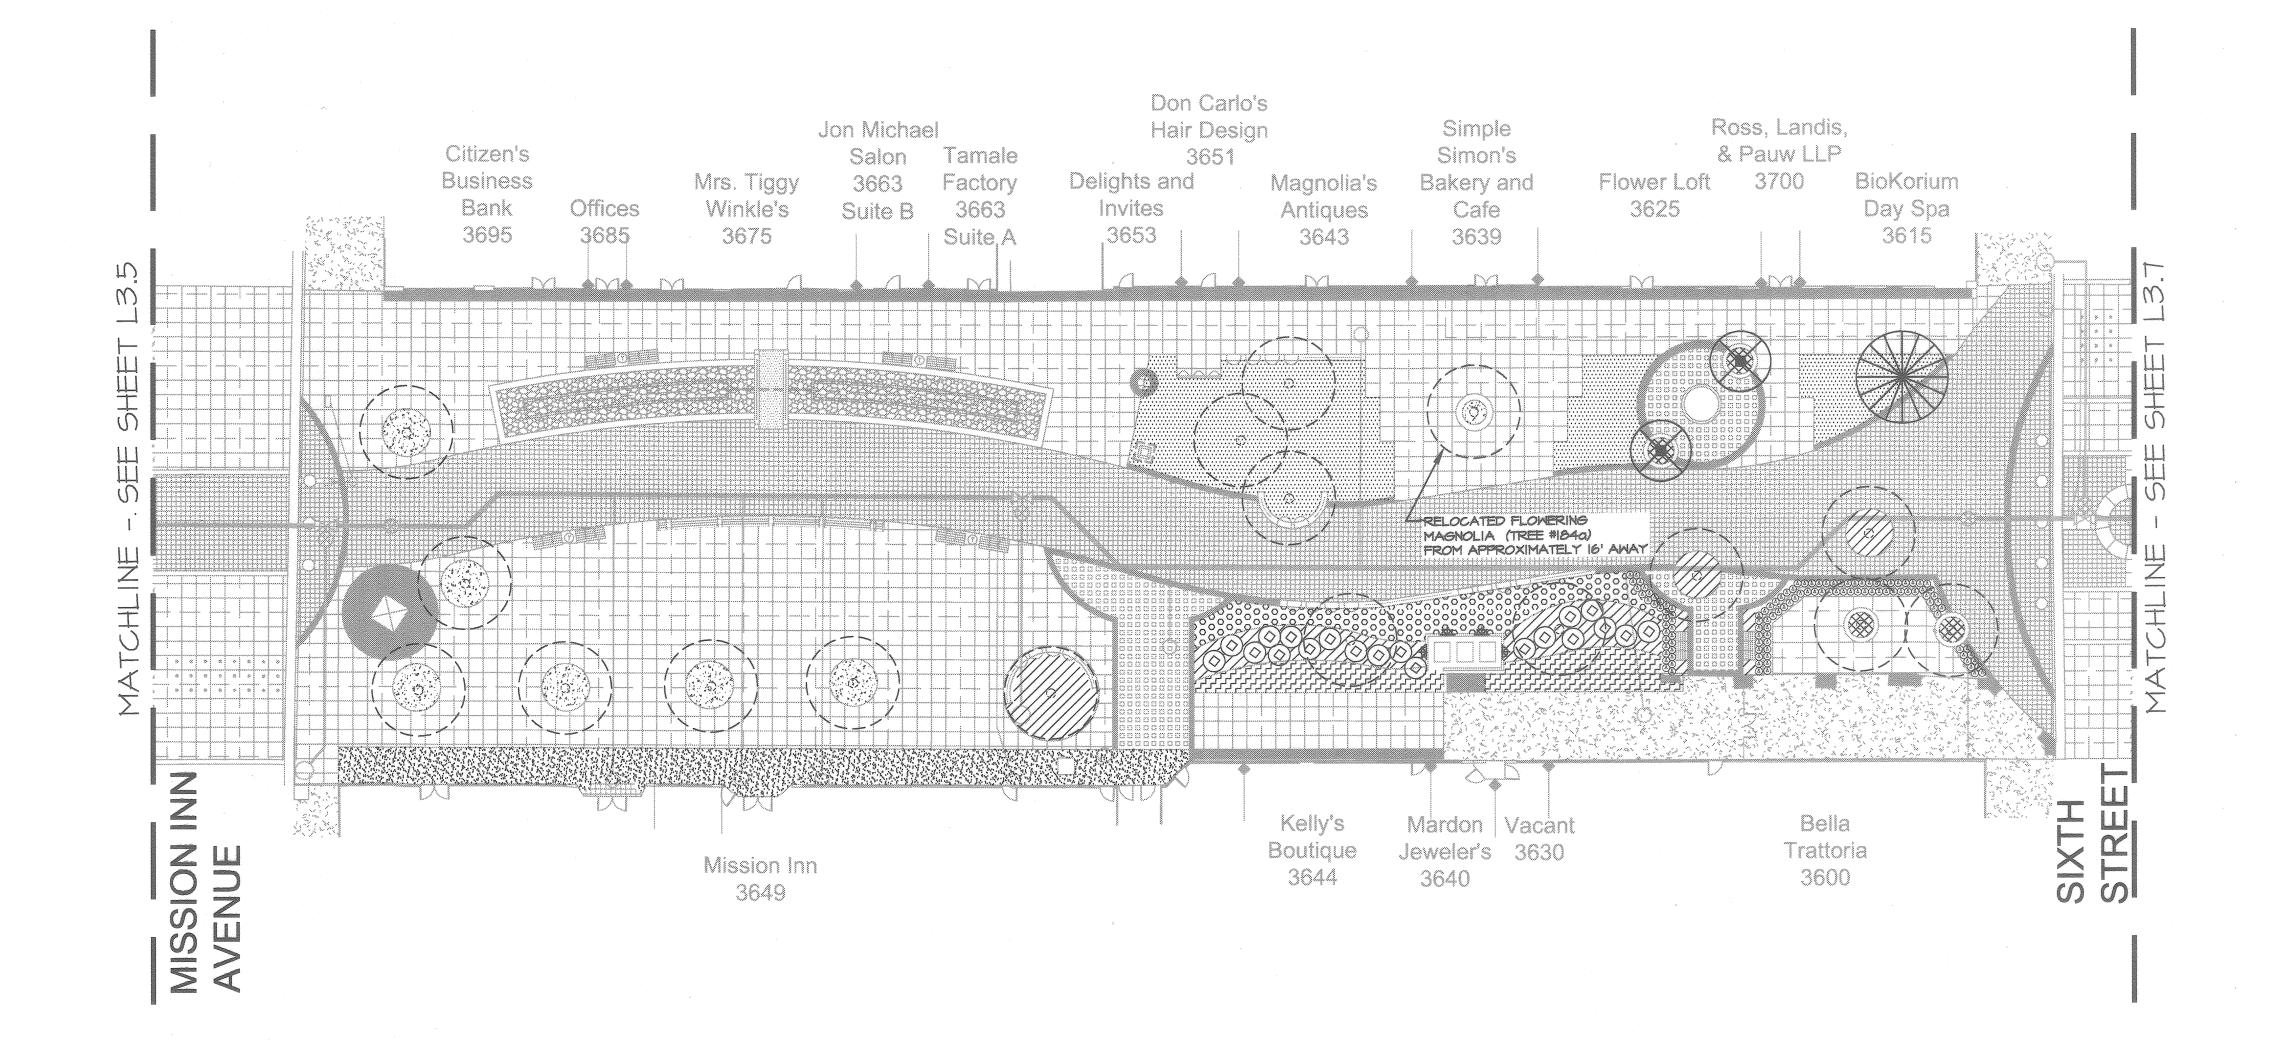

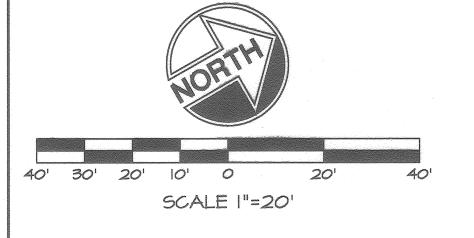

UNDERGROUND SERVICE ALERT CALL: TOLL FREE 227 · 2600

IAN DAVIDSON, LANDSCAPE ARCHITECTURE 3744 10TH STREET RIVERSIDE, CA 92501 951 683 1283 . FAX 951 683 4352 E-MAIL: IDAVIDSON@IDLAINC.COM



DESIGNED BY ______ DR

			CITY OF PUBLI	RI C 1	VERS VORI	SIDE, CALIFORNIA KS DEPARTMENT
			APPROVED BY	BY	DATE	APPROVED
			CONST. CONTRACT ADMIN.	85	12/11/2	1/m/5/
			PRINCIPAL ENGINEER STREET SERVICES	- KIL	10/4/0/	CITY ENGINEER
REVISIONS	APPR.	DATE	SURVEYOR TRAFFIC DIVISION			intela
RAWN BY JM / MA CHECKED BY _	IJ)	PARKS DEPARTMENT			DATE

DOWNTOWN MALL LANDSCAPE PLANS

PELARGONIUM PELTATUM / IVY GERANIUM I GAL / 18" O.C.

PLANTING LEGEND

JACARANDA MIMOSIFOLIA

MAGNOLIA GRANDILFORA/ MAGNOLIA 'MALESTIC BEAUTY'

MAGNOLIA GRANDILFORA/

MAGNOLIA LITTLE GEM/

LITTLE GEM MAGNOLIA

PHOENIX CANARIENSIS/

PLATANUS ACERIFOLIA

PODOCARPUS GRACILIOR/

PRUNUS CERASIFERA KRAUTER VESUVIUS!

MAGNOLIA 'MAJESTIC BEAUTY'

BOTANICAL NAME/

REF. COMMON NAME

JACARANDA

DATE PALM

TT ORANGE

+ T8 PODOCARPUS GRACILIOR/ FERN PINE (COLUMN)

TO LONDON PLANE TREE

CITRUS (NAVEL)

TO FERN PINE (COLUMN)

SCHINUS MOLLE/

TII CALIFORNIA PEPPER TREE

OLEA 'SWAN HILL'

CYATHEA COOPERI/

WASHINGTONIA ROBUSTA/

TIS EXISTING TREE PROTECTED IN PLACE

CAMELLIA JAPONICA 'DAHLOHNEGA'

XYLOSMA CONGESTUM 'COMPACTA'

ASPIDISTRA ELATIOR 'VARIEGATA'

TIE EXISTING PALM TREE PROTECTED IN PLACE

93 PITTOSPORUM TOBIRA WHEELERI'

SI DAHLOHNEGA CAMELLIA

WHEELERS DWARF

BUXUS MICROPHYLLA

CAST IRON PLANT

ASPARAGUS FERN

DWARF FLAX

FICUS REPENS/

BOSTON IVY

STAR JASMINE

GC2 INY GERANIUM PURPLE

ASPARAGUS SETACEUS

PHORMIUM 'JACK SPRATT'

DISTICTIS BUCCINATORIA BLOOD RED TRUMPET VINE

MANDEVEILLEA 'ALICE DUPONT'

PARTHENOCISSUS TRICUSPIDATA

GCI TRACHELOSPERMUM JASMINOIDES

GC3 TO BE SELECTED BY LANDSCAPE ARCHITECT 8" OC

W GRASSPAVE 2 BY INVISIBLE STRUCTURES, INC.

3/8" MINUS APACHE RED DECOMPOSED GRANITE KALAMAZOO MATERIALS, INC. TEL. (520) 575-9601

NOTE: ALL PLANTED AREAS SHALL RECEIVE 2" THICK BARK MULCH GROUNDCOVER.

PELARGONIUM PELTATUM / IVY GERANIUM

SALVIA GRAHAMII / GRAHAM'S SAGE PELARGONIUM PELTATUM / IVY GERANIUM

PHORMIUM TENAX 'JACK SPRATT' /

P3 JACK SPRATT NEW ZEALAND FLAX

EXISTING PLANTING TO REMAIN

2" THICK BARK MULCH (ONLY)

DASYLIRION TEXANUM /

PI GREEN DESERT SPOON

PELARGONIUM PELTATUM

WEST COASTER / SOD

62 WEST COASTER / SOD

METAL EDGING

S2 LIGUSTRUM TEXANUM/

PRIVET

XYLOSMA

BOXWOOD

TI2 SWAN HILL OLIVE TREE

TIO FLOWERING PLUM

TIS MEXICAN FAN PALM

TI4 AUSTRALIAN TREE FERN

SHRUB / VINE LIST

GROUNDCOVER

TURF LIST

SIGN NAMES ADDRESS OFFICE STORE STORE

POT LIST

MISCELLANEOUS SYMBOLS

COMMENTS/

DETAIL QTY.

euying 6

euying 2

GUYING

DOUBLE

STAKE

GUYING

STAKE

DOUBLE 13

GUYING 2

40

116

2

405 SQ. FT.

2009 SQ. FT.

2698 SQ. FT.

1584 SQ. FT.

1293 SQ. FT.

139 SQ. FT.

4169 SQ. FT.

195 SQ. FT.

183 SQ. FT.

13,852 SQ. FT.

11,865 SQ. FT.

3006 SQ. FT.

2223 SQ. FT.

13,316 SQ. FT.

STAKE

SPACING

36" BOX/

36" BOX/ PER PLAN

PER PLAN

36" BOX/ PER PLAN

25' BTF/

PER PLAN

PER PLAN

24" BOX/

36" BOX/

PER PLAN

24" BOX/

PER PLAN

36" BOX/

PER PLAN

PER PLAN

48" BOX/

PER PLAN

PER PLAN

5 GAL/

30" OC

5 GAL/ 30" OC

5 GAL/

30" OC

5 GAL/

30" OC

5 GAL/

18" 00

5 GAL/

30" OC

5 GAL/

30" OC

18" OC

PER PLAN

I GAL/

6' OC

5 GAL/

GAL/

FLATS/

6" OC

I GAL/

5 GAL

5 GAL

1 GAL / 18" O.C.

1 GAL / 18" O.C.

18" O.C. 4" POTS/

6' OC

PER PLAN

PER PLAN


PER PLAN

TREE LIST


SYM.


12/03/07 PLANTING PLAN M - 457L3.6 SHEET 61 OF 100

M-457

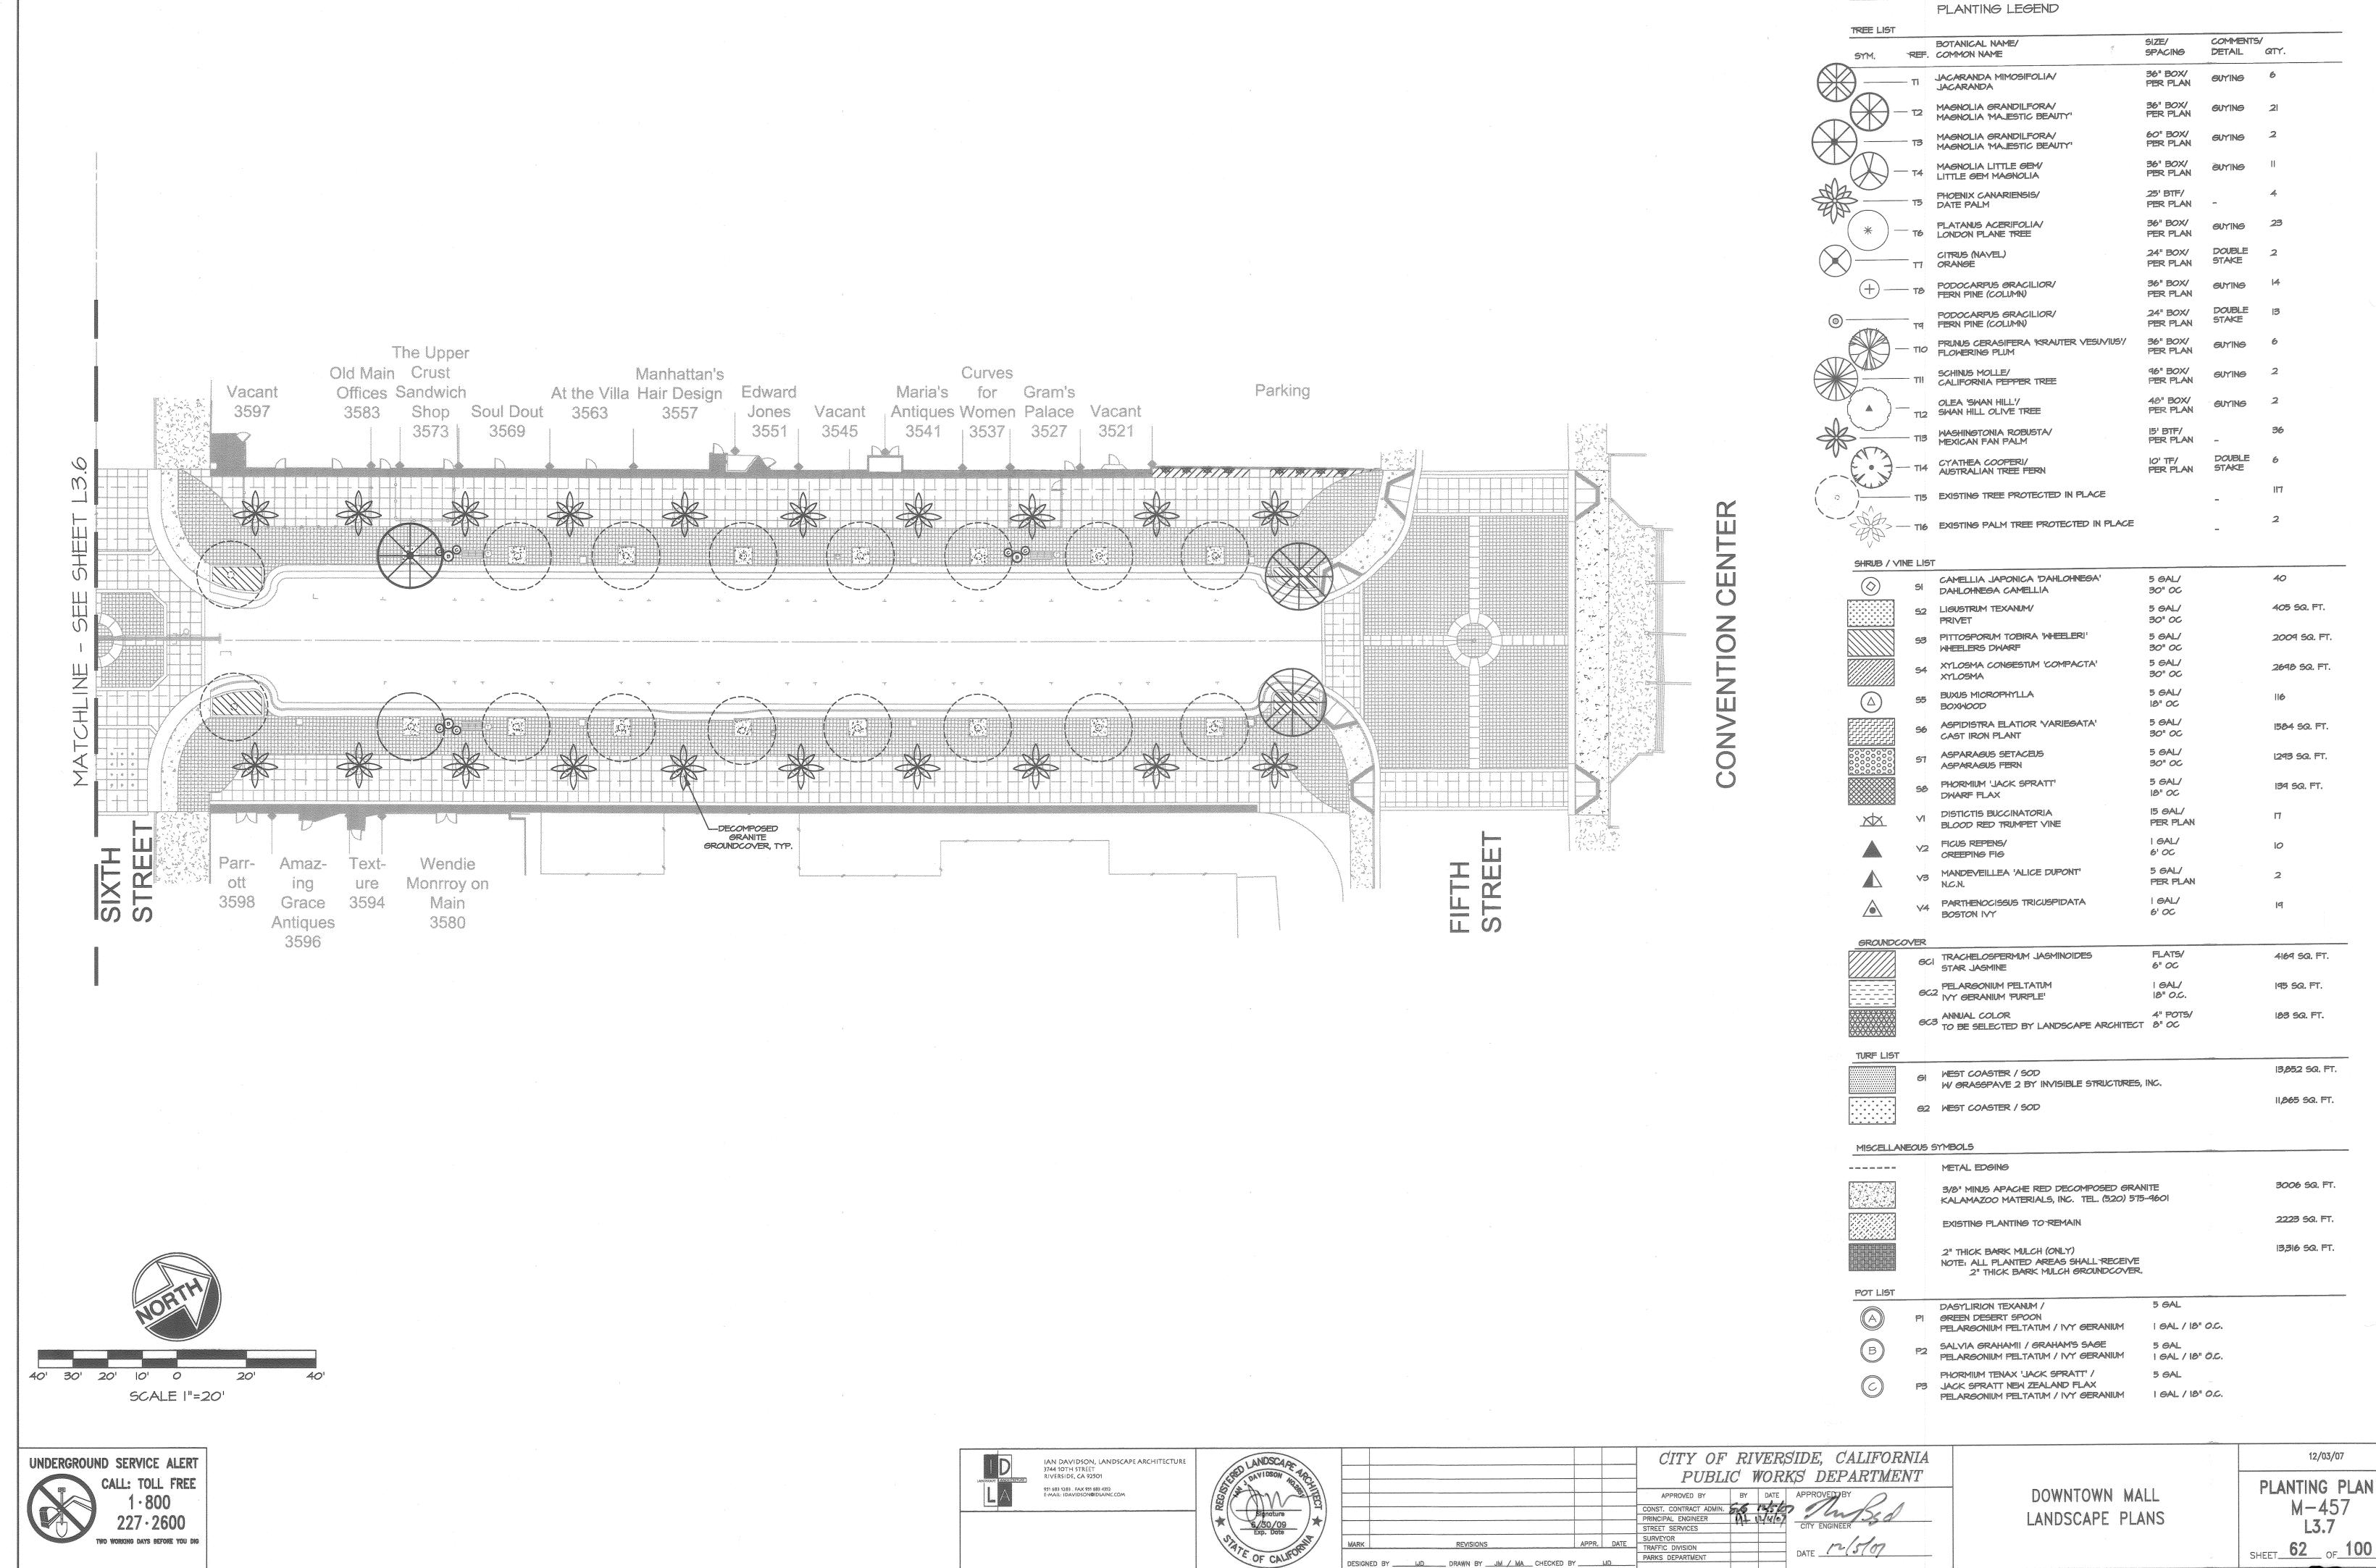

M-457

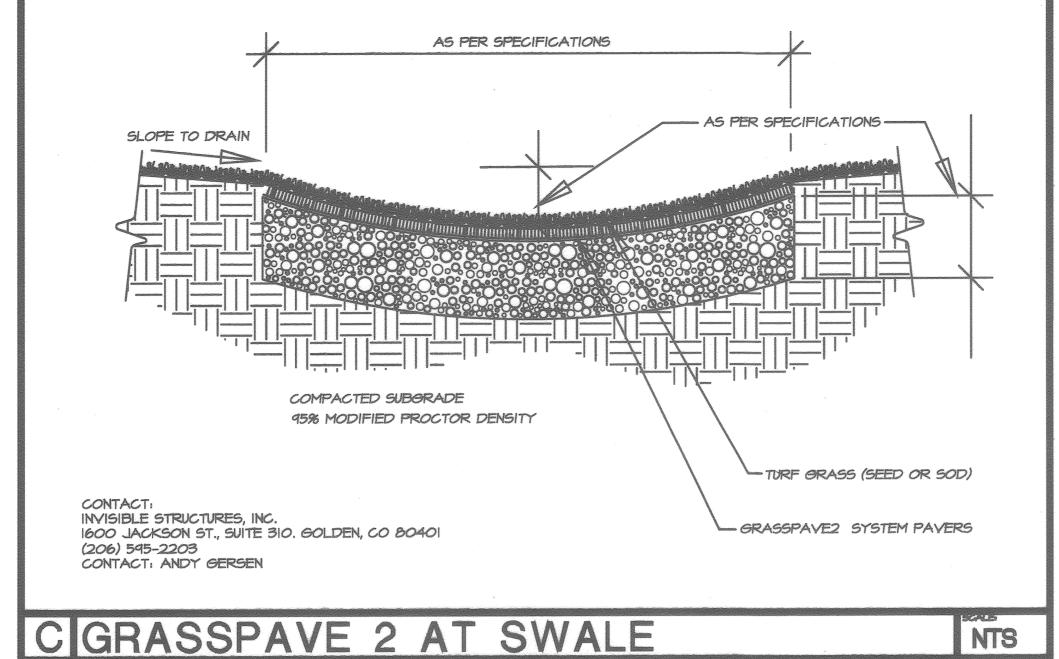

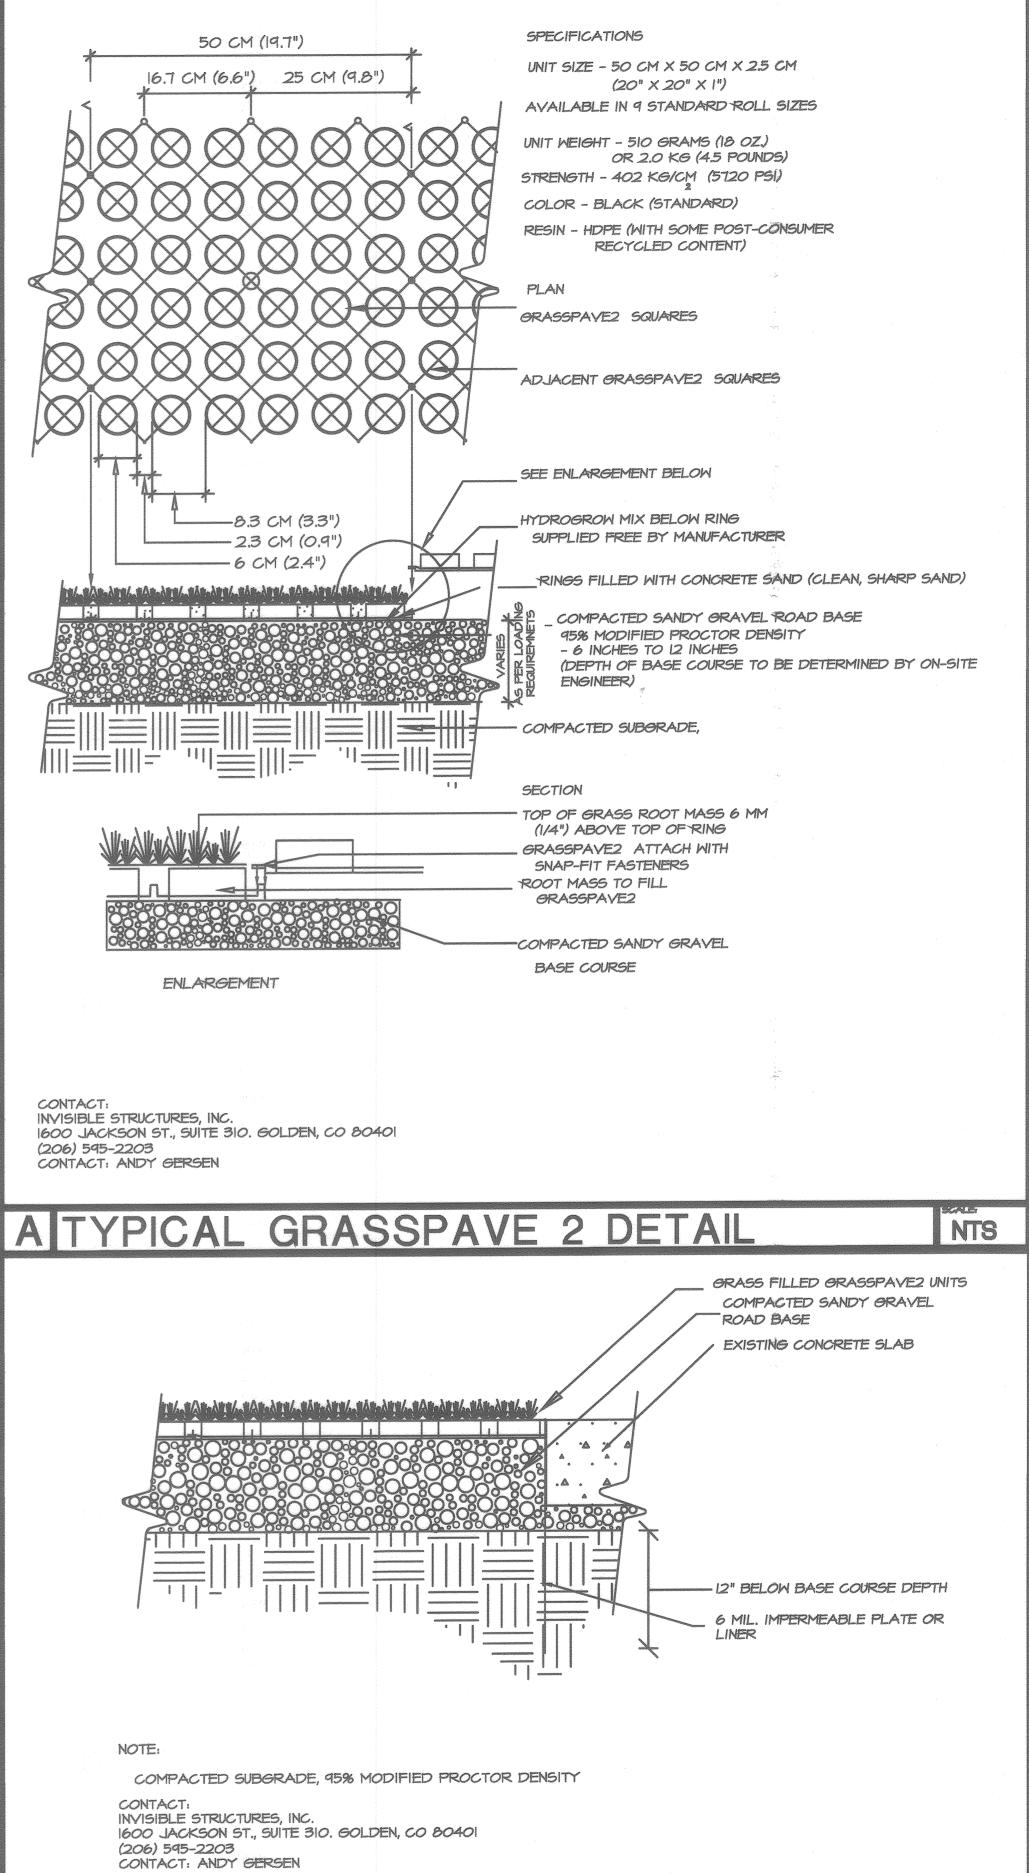

UNDERGROUND SERVICE ALERT

CALL: TOLL FREE


1 · 800

227 · 2600

TWO WORKING DAYS BEFORE YOU DIG

IAN DAVIDSON, LANDSCAPE ARCHITECTURE
3744 10TH STREET
RIVERSIDE, CA 92501

951 683 1283 . FAX 951 683 4352
E-MAIL: IDAVIDSON@IDLAINC.COM

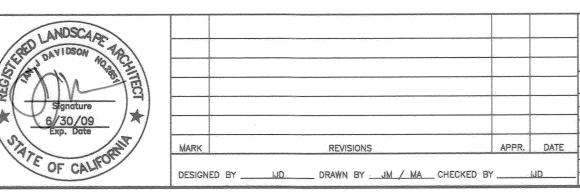

BGRASSPAVE 2 AT

CITY OF RIVERSIDE, CALIFORNIA

PUBLIC WORKS DEPARTMENT

APPROVED BY

BY DATE APPROVED BY

CONST. CONTRACT ADMIN.
PRINCIPAL ENGINEER
STREET SERVICES
SURVEYOR
TRAFFIC DIVISION
PARKS DEPARTMENT

DATE

DOWNTOWN MALL
LANDSCAPE PLANS


CONC. EDGE


12/03/07


PLANTING DETAILS
M-457
L3.8


SHEET 63 OF 100


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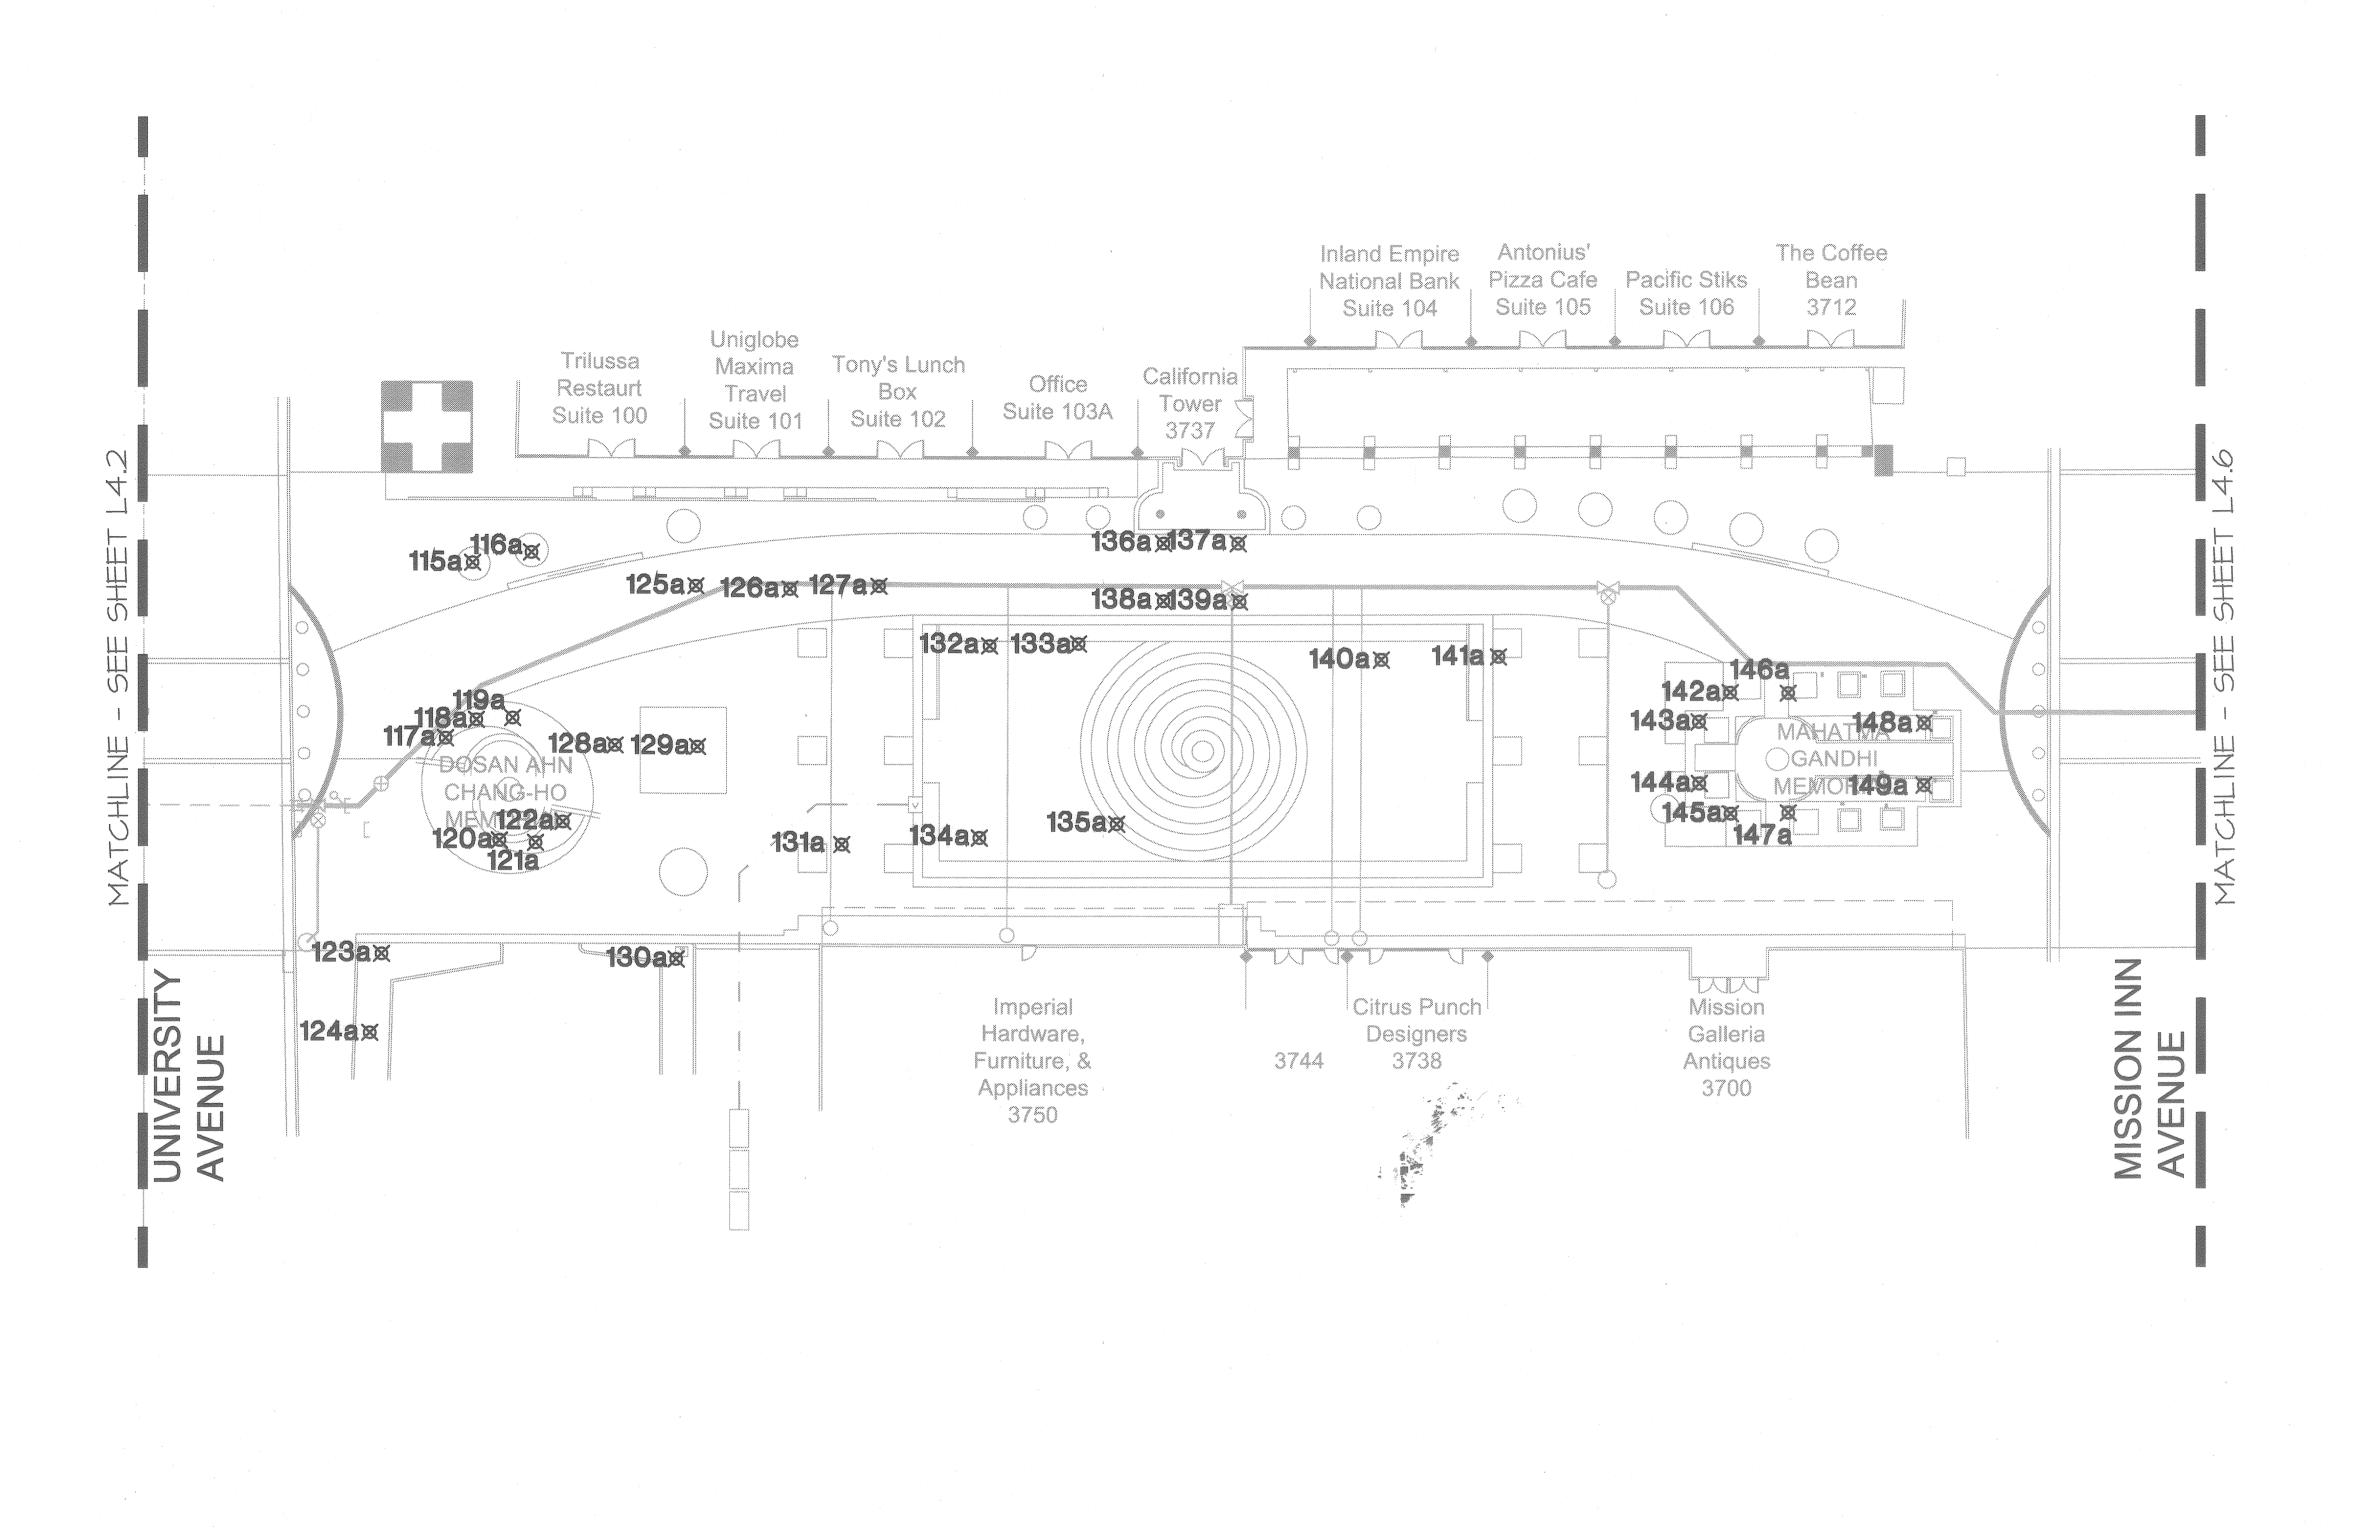


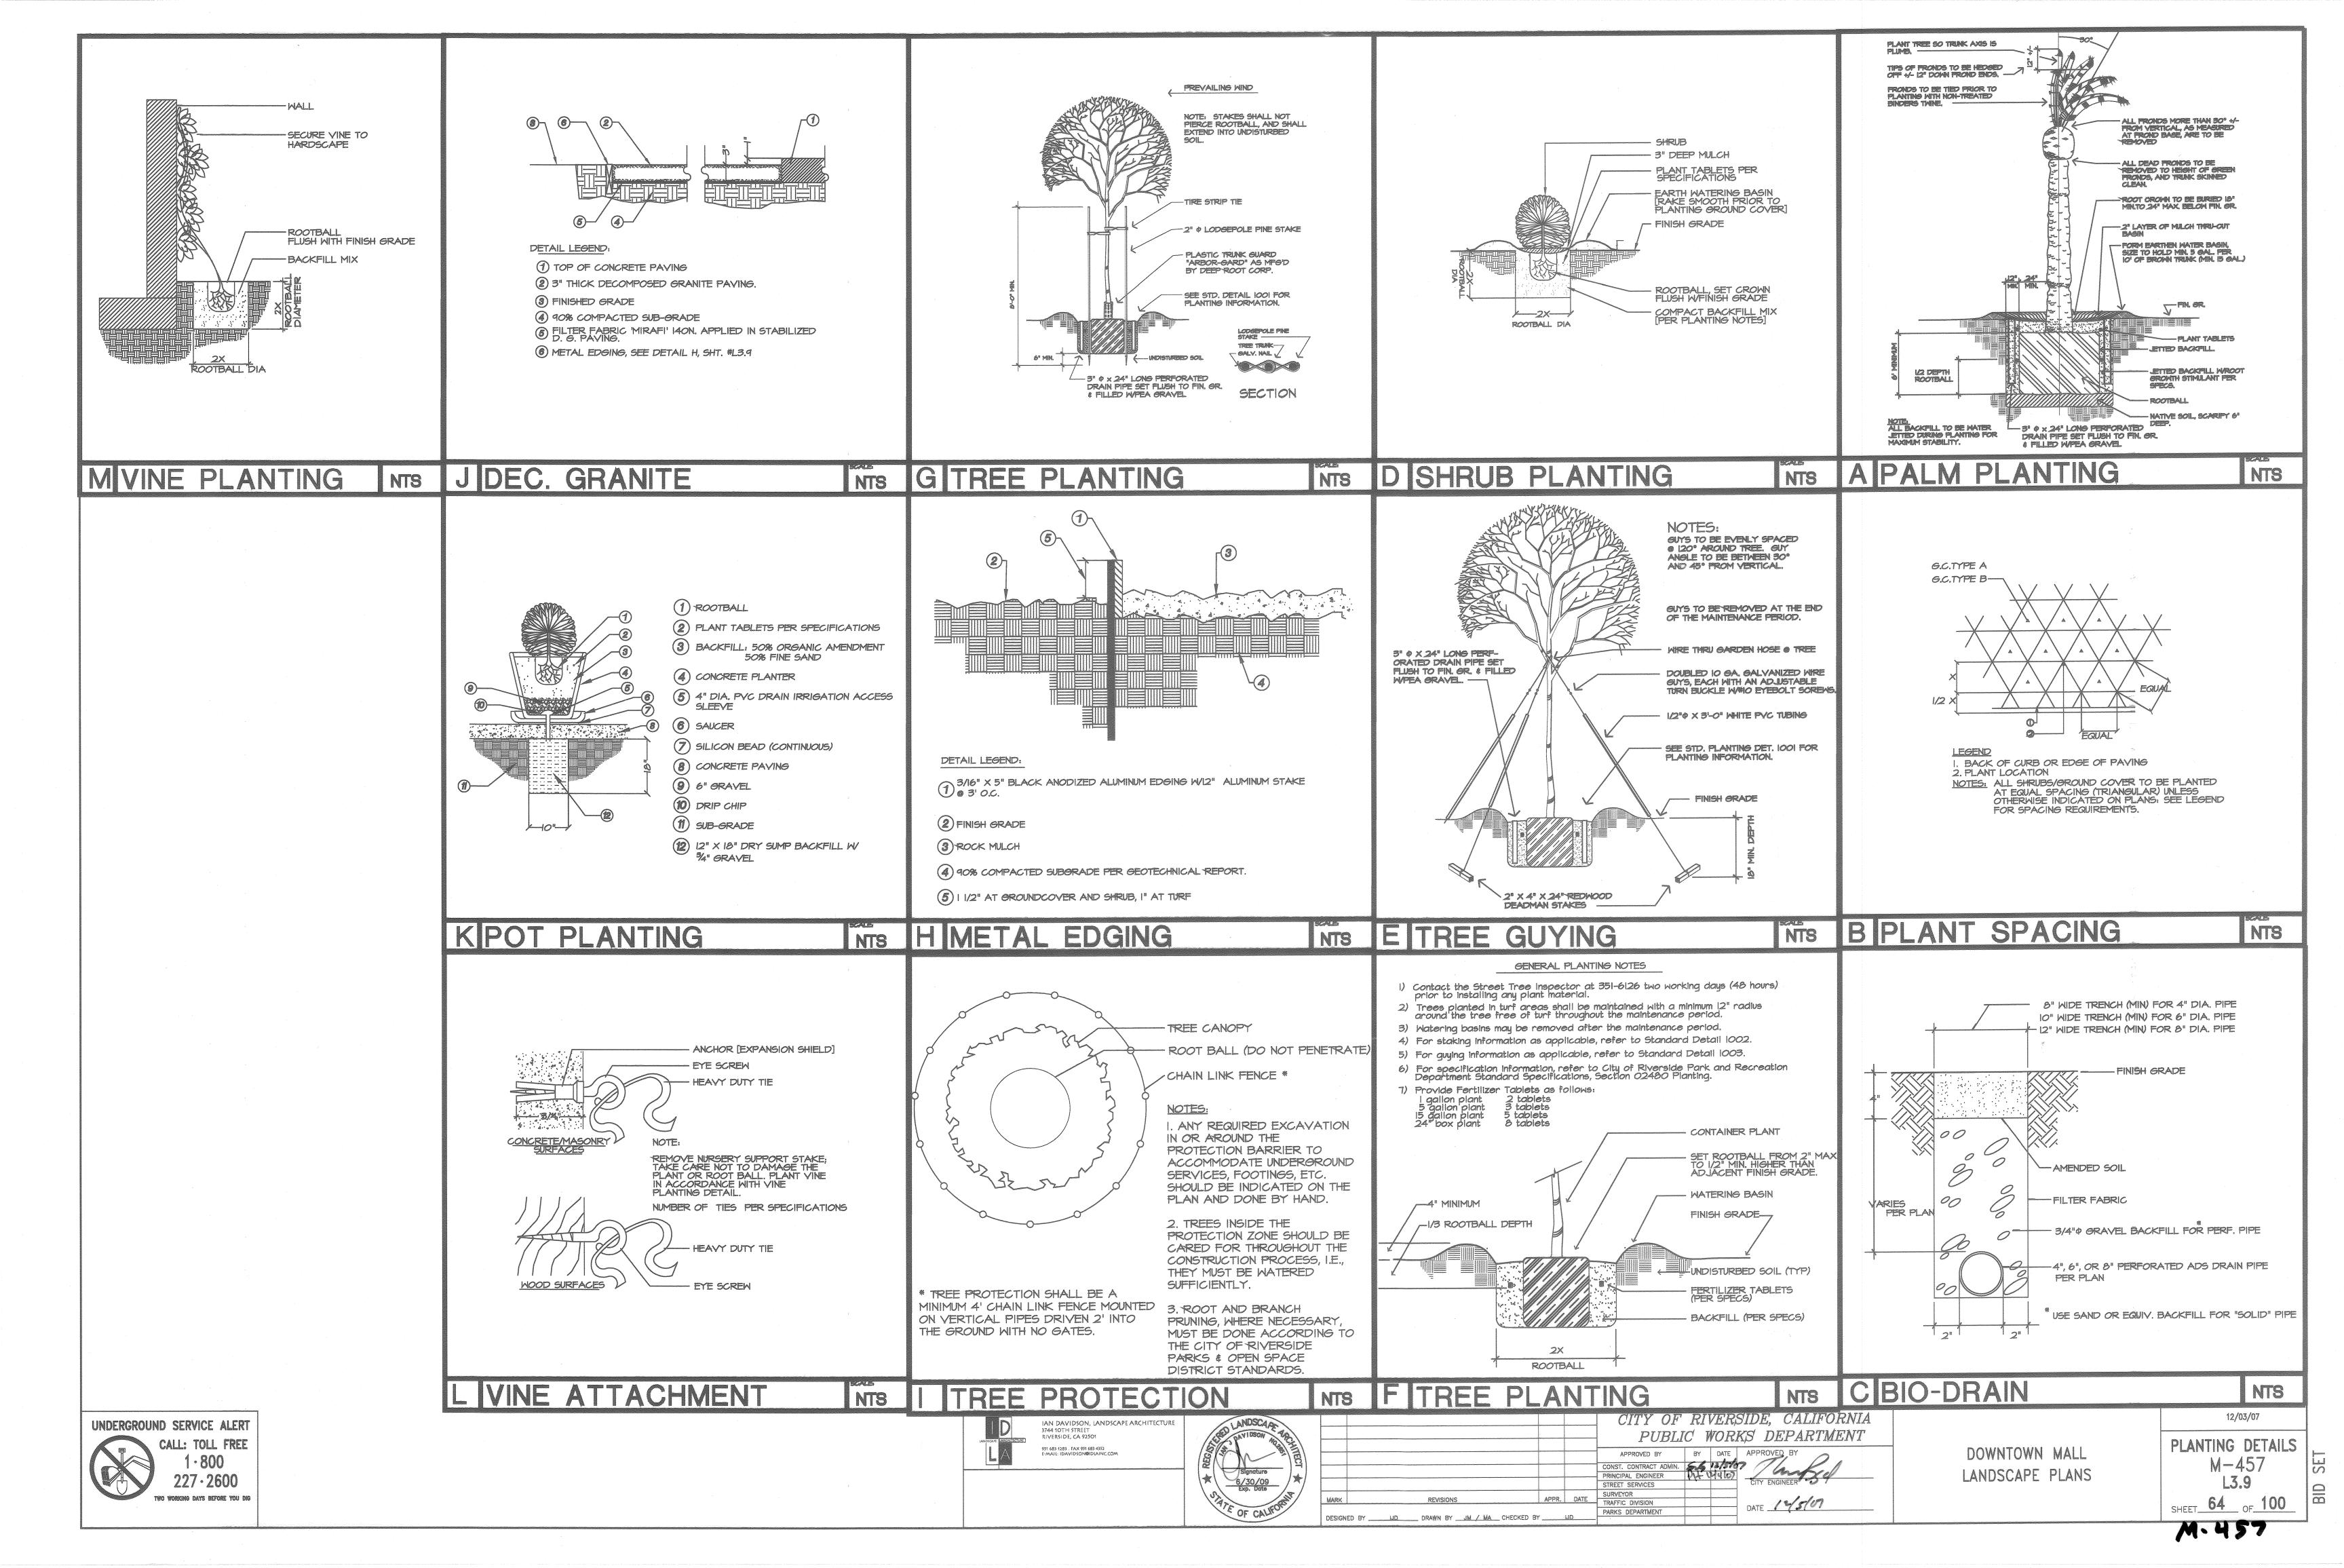

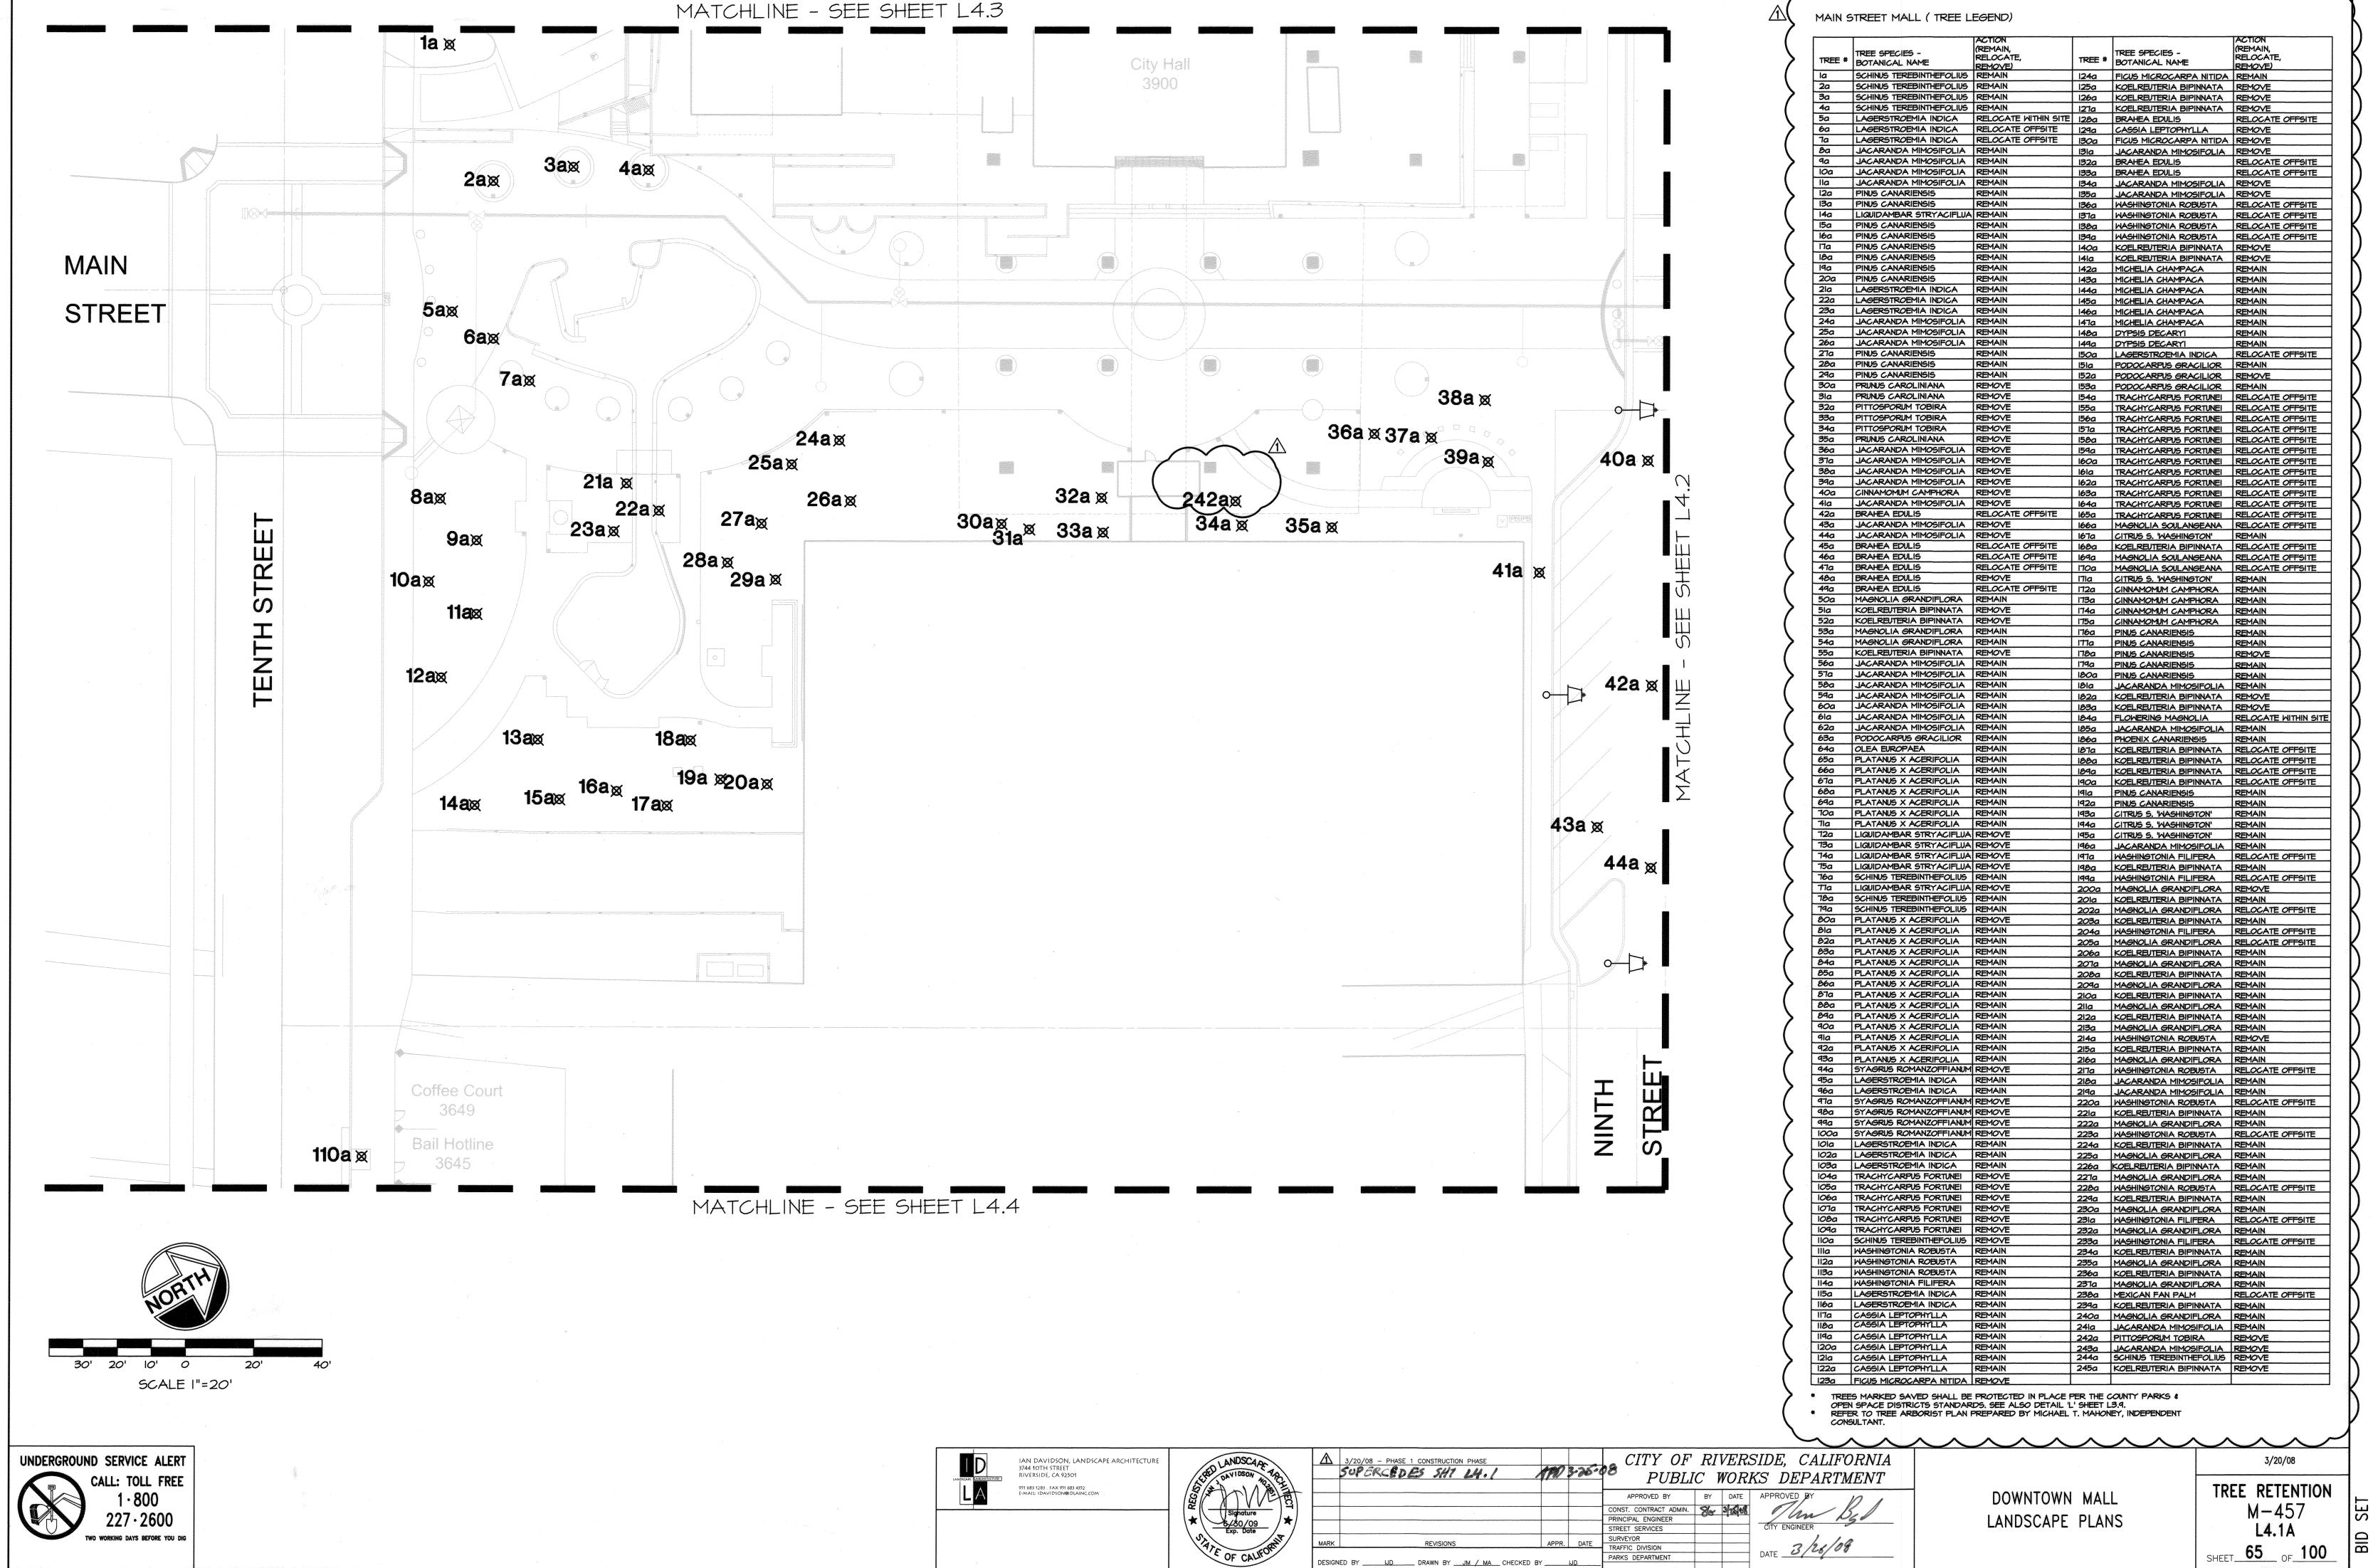

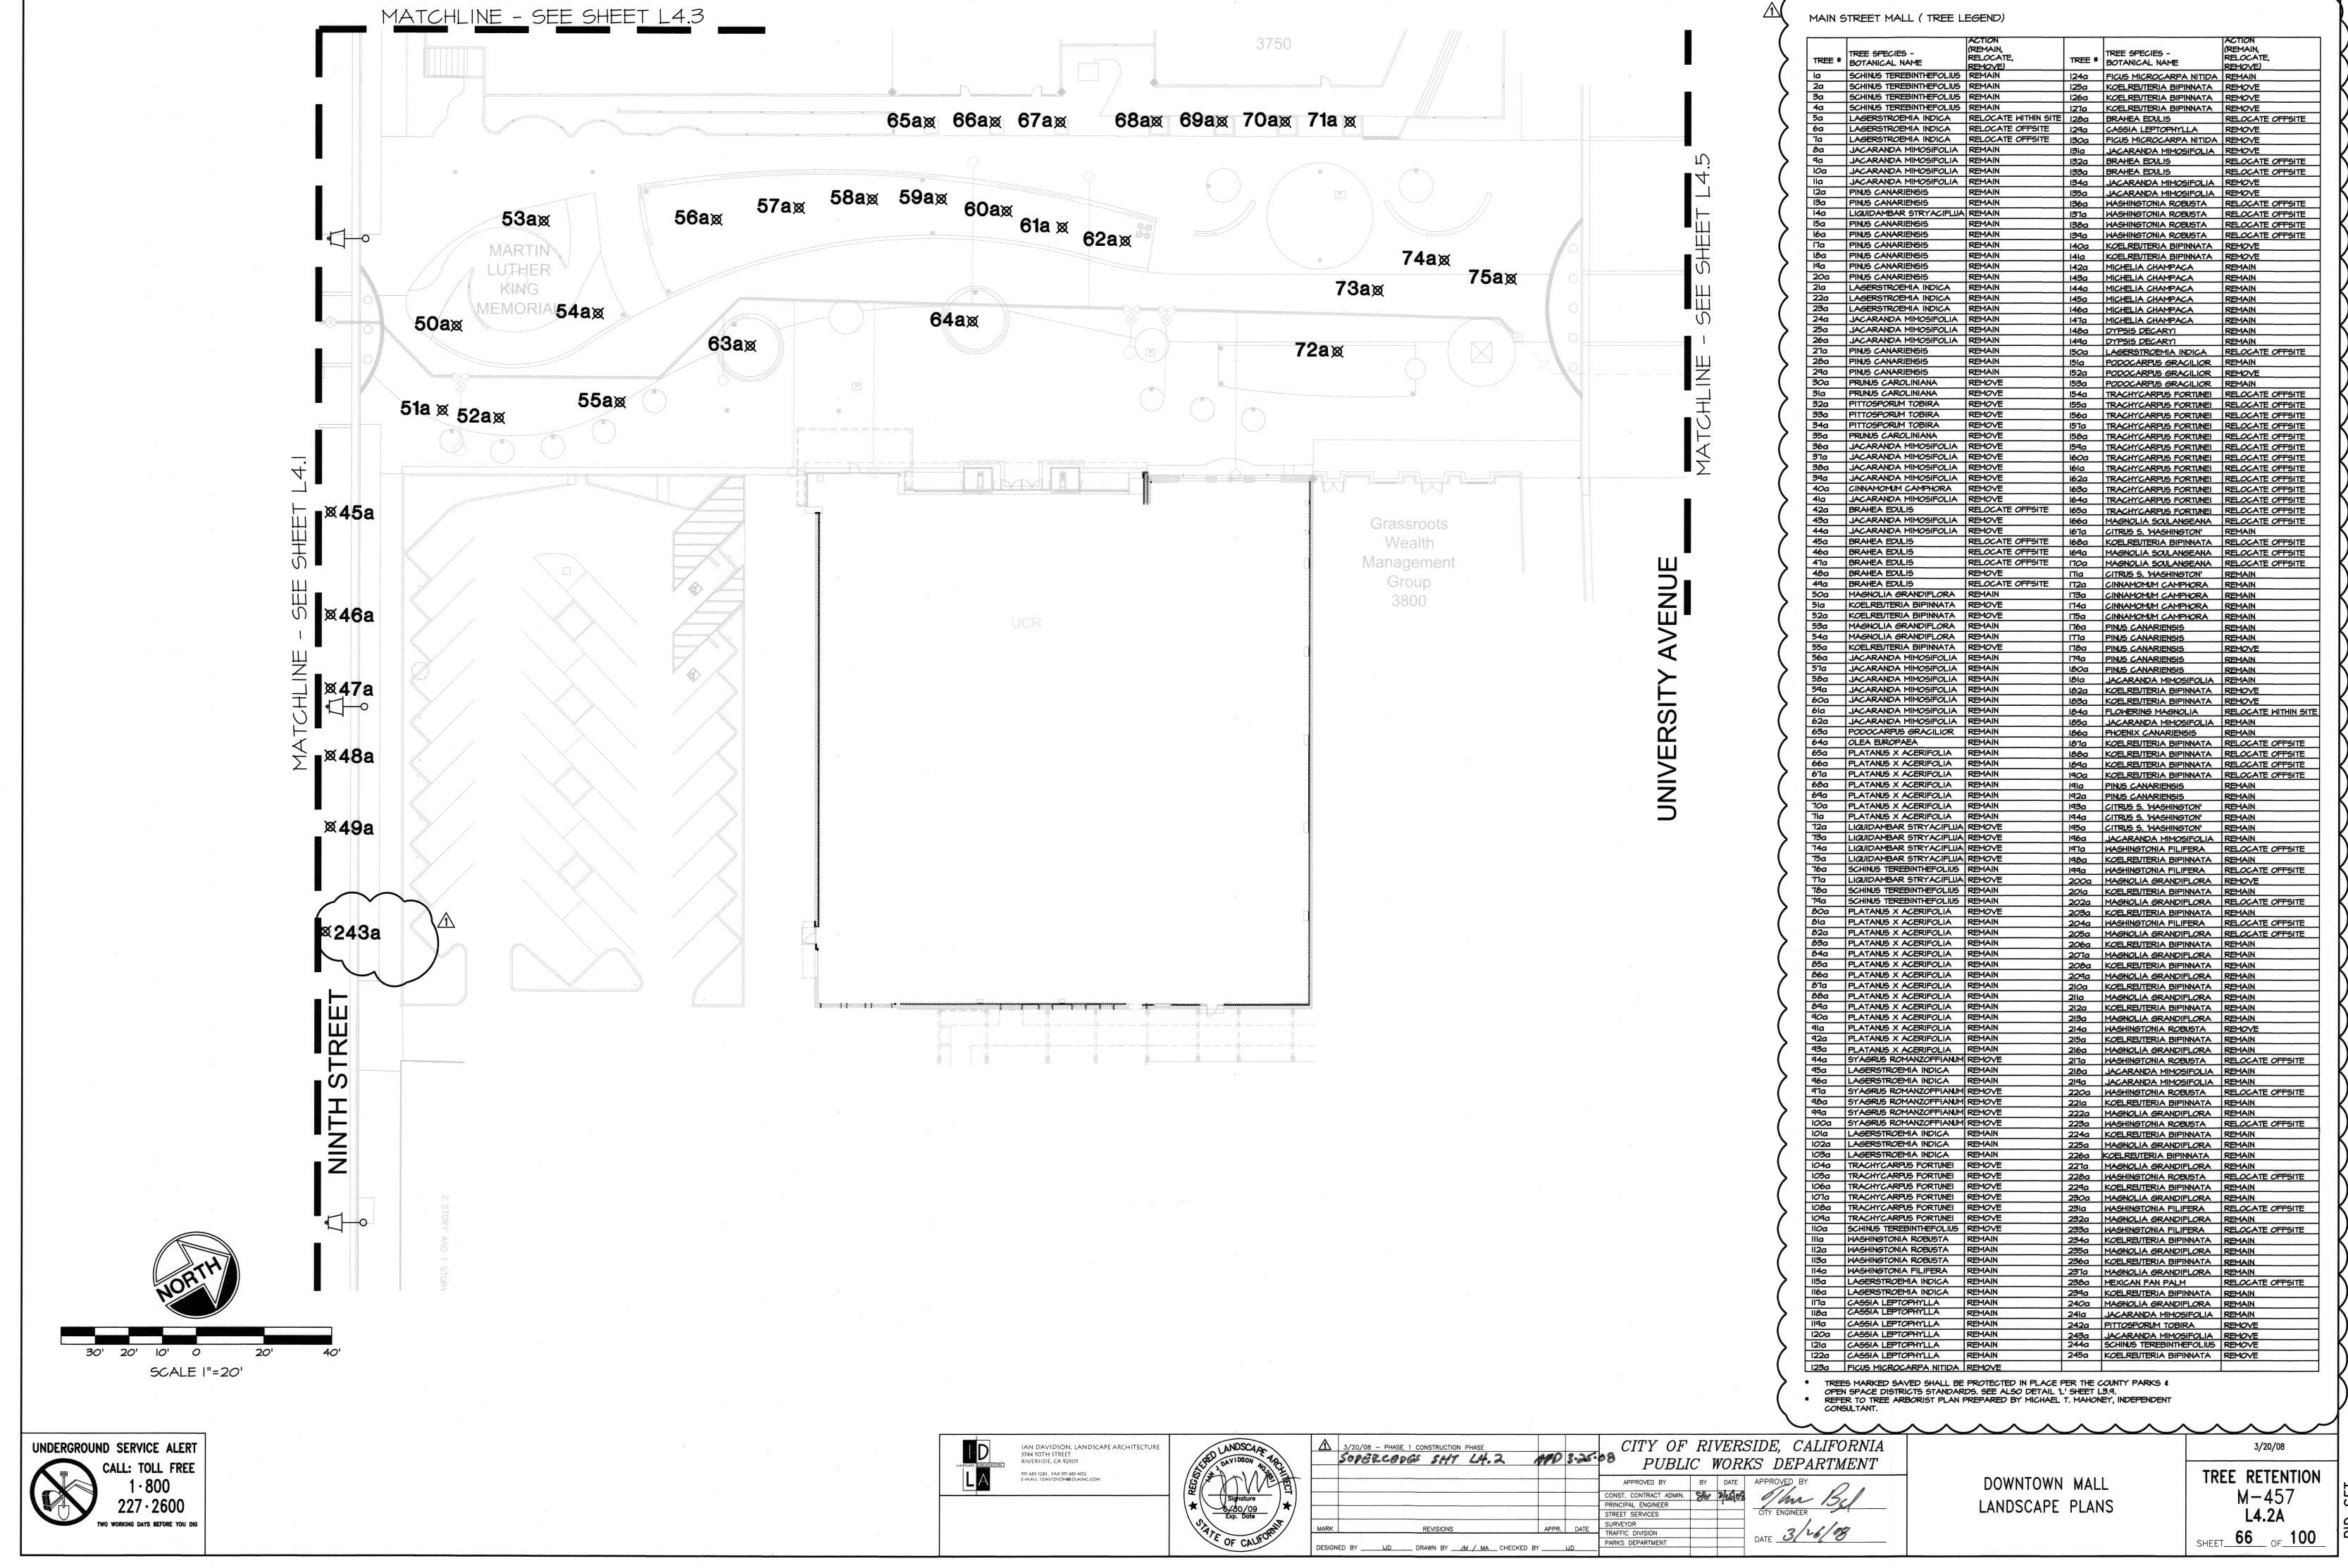

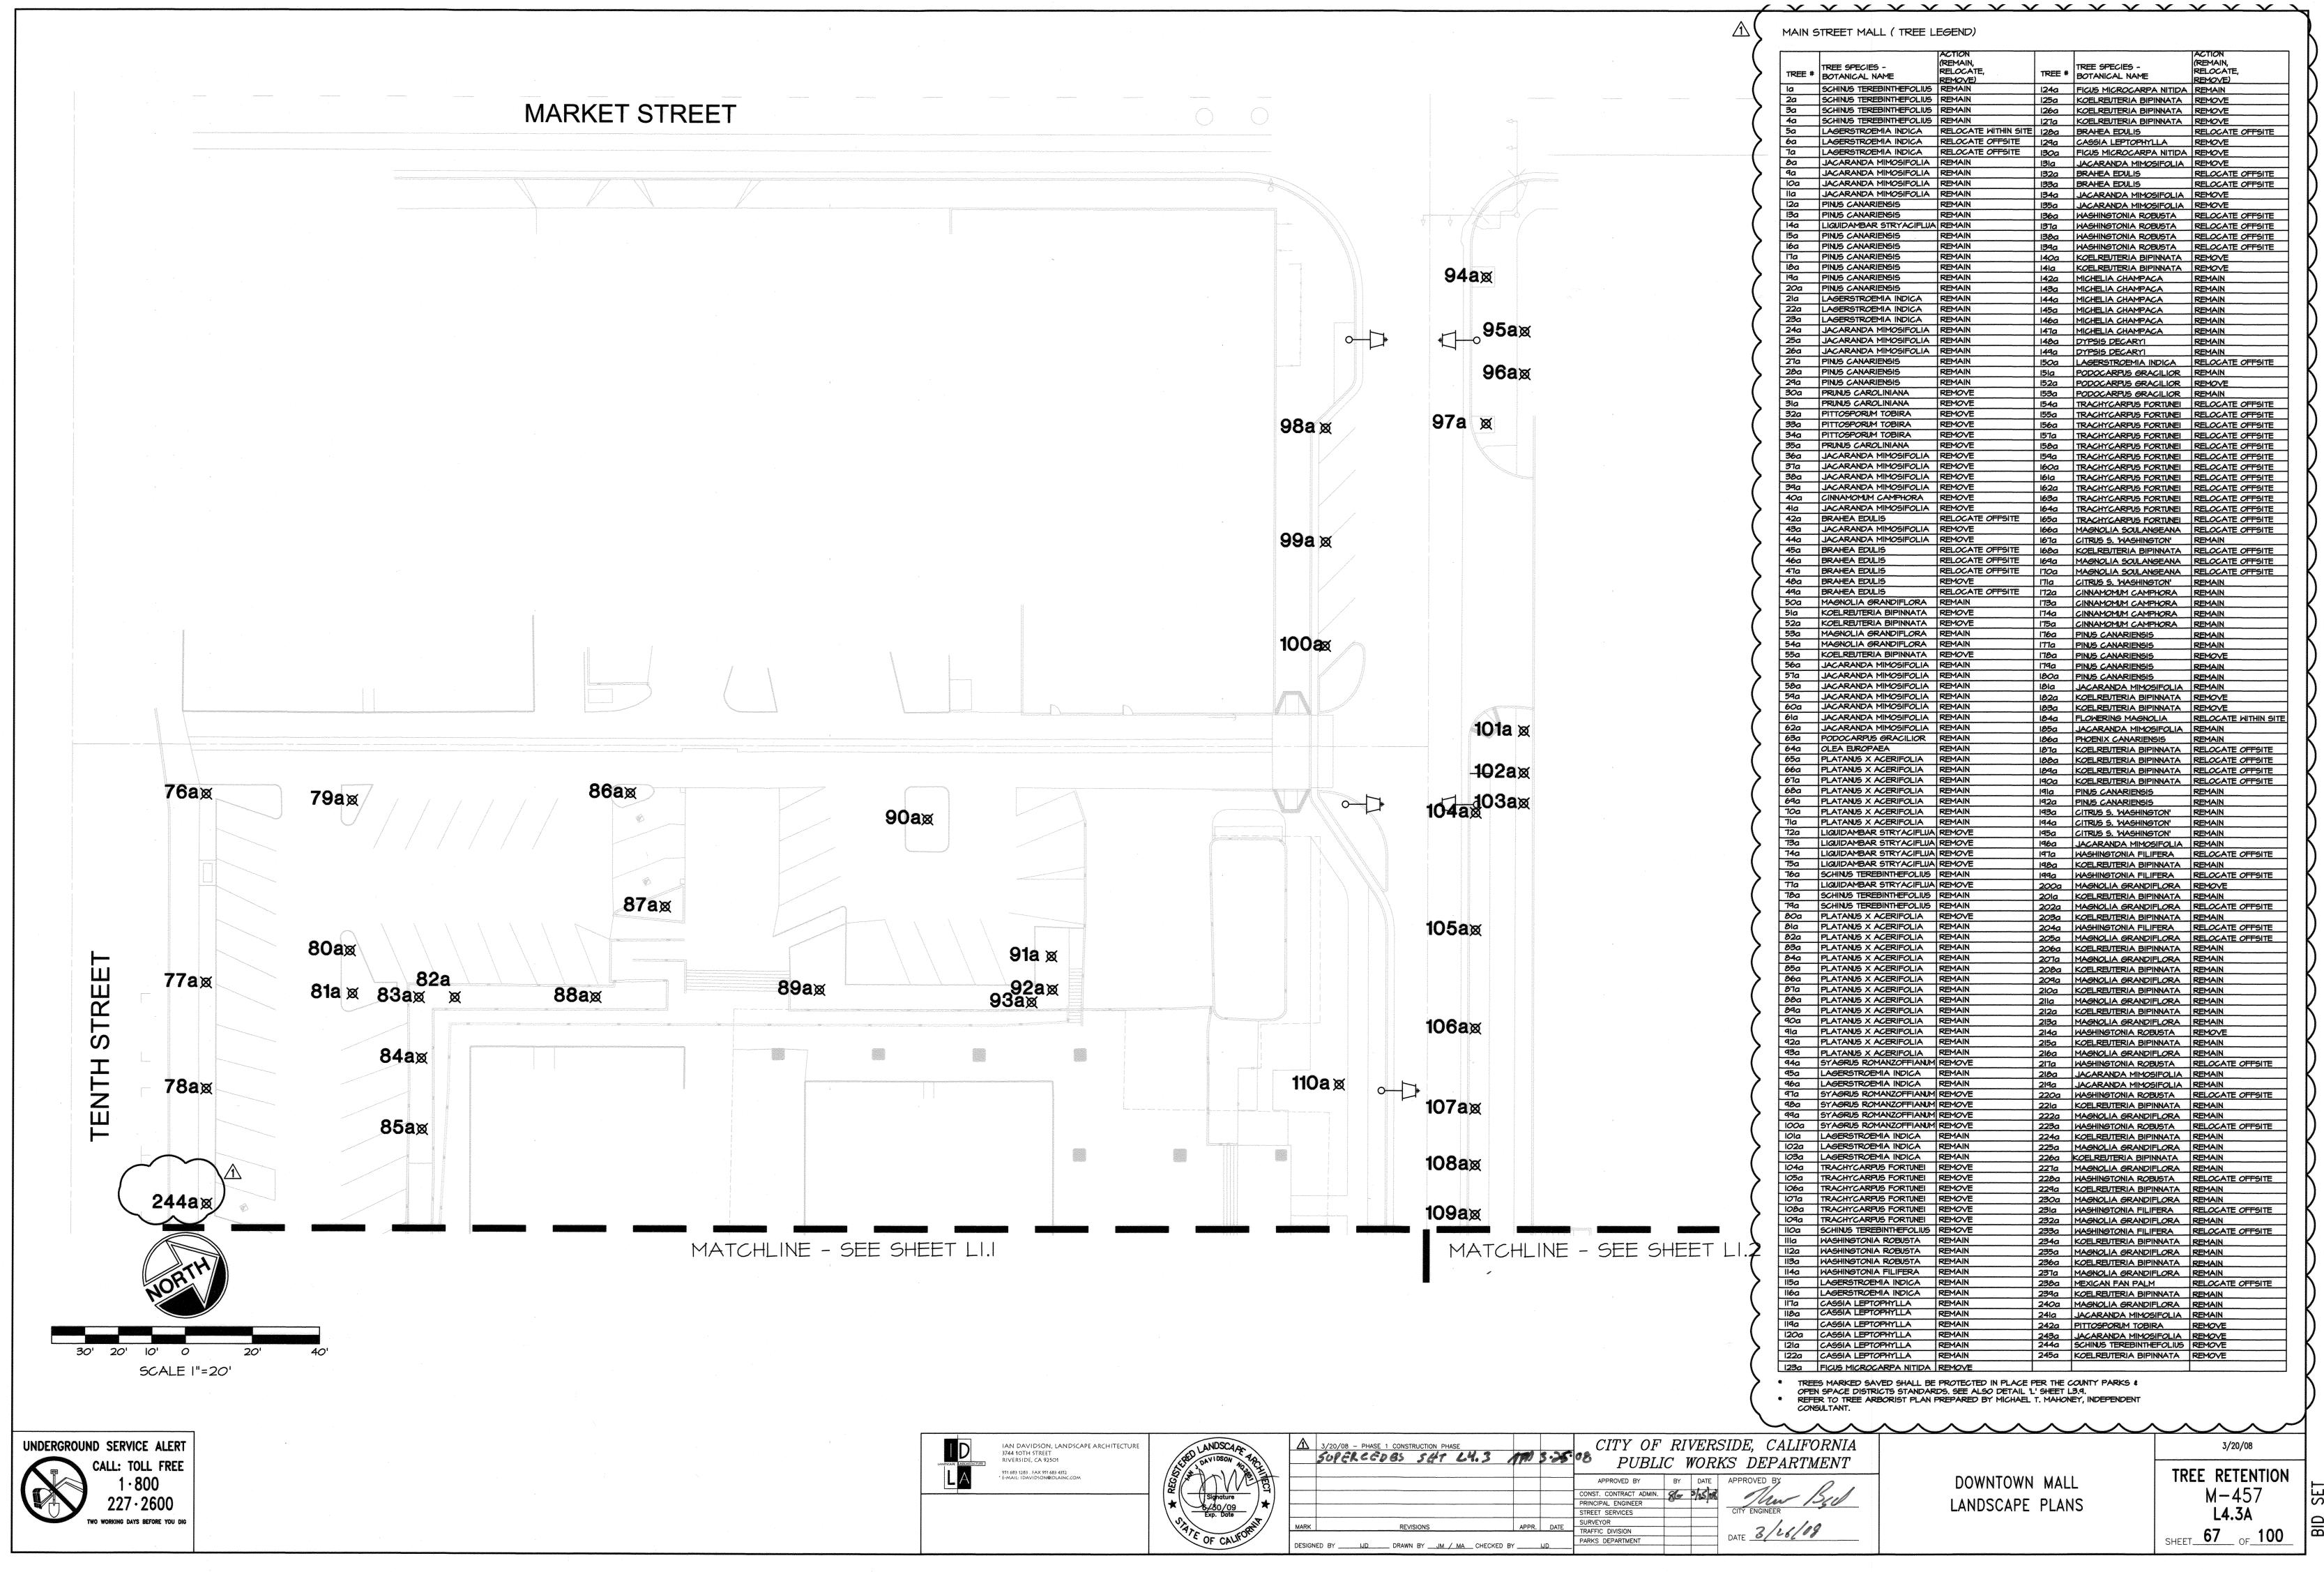

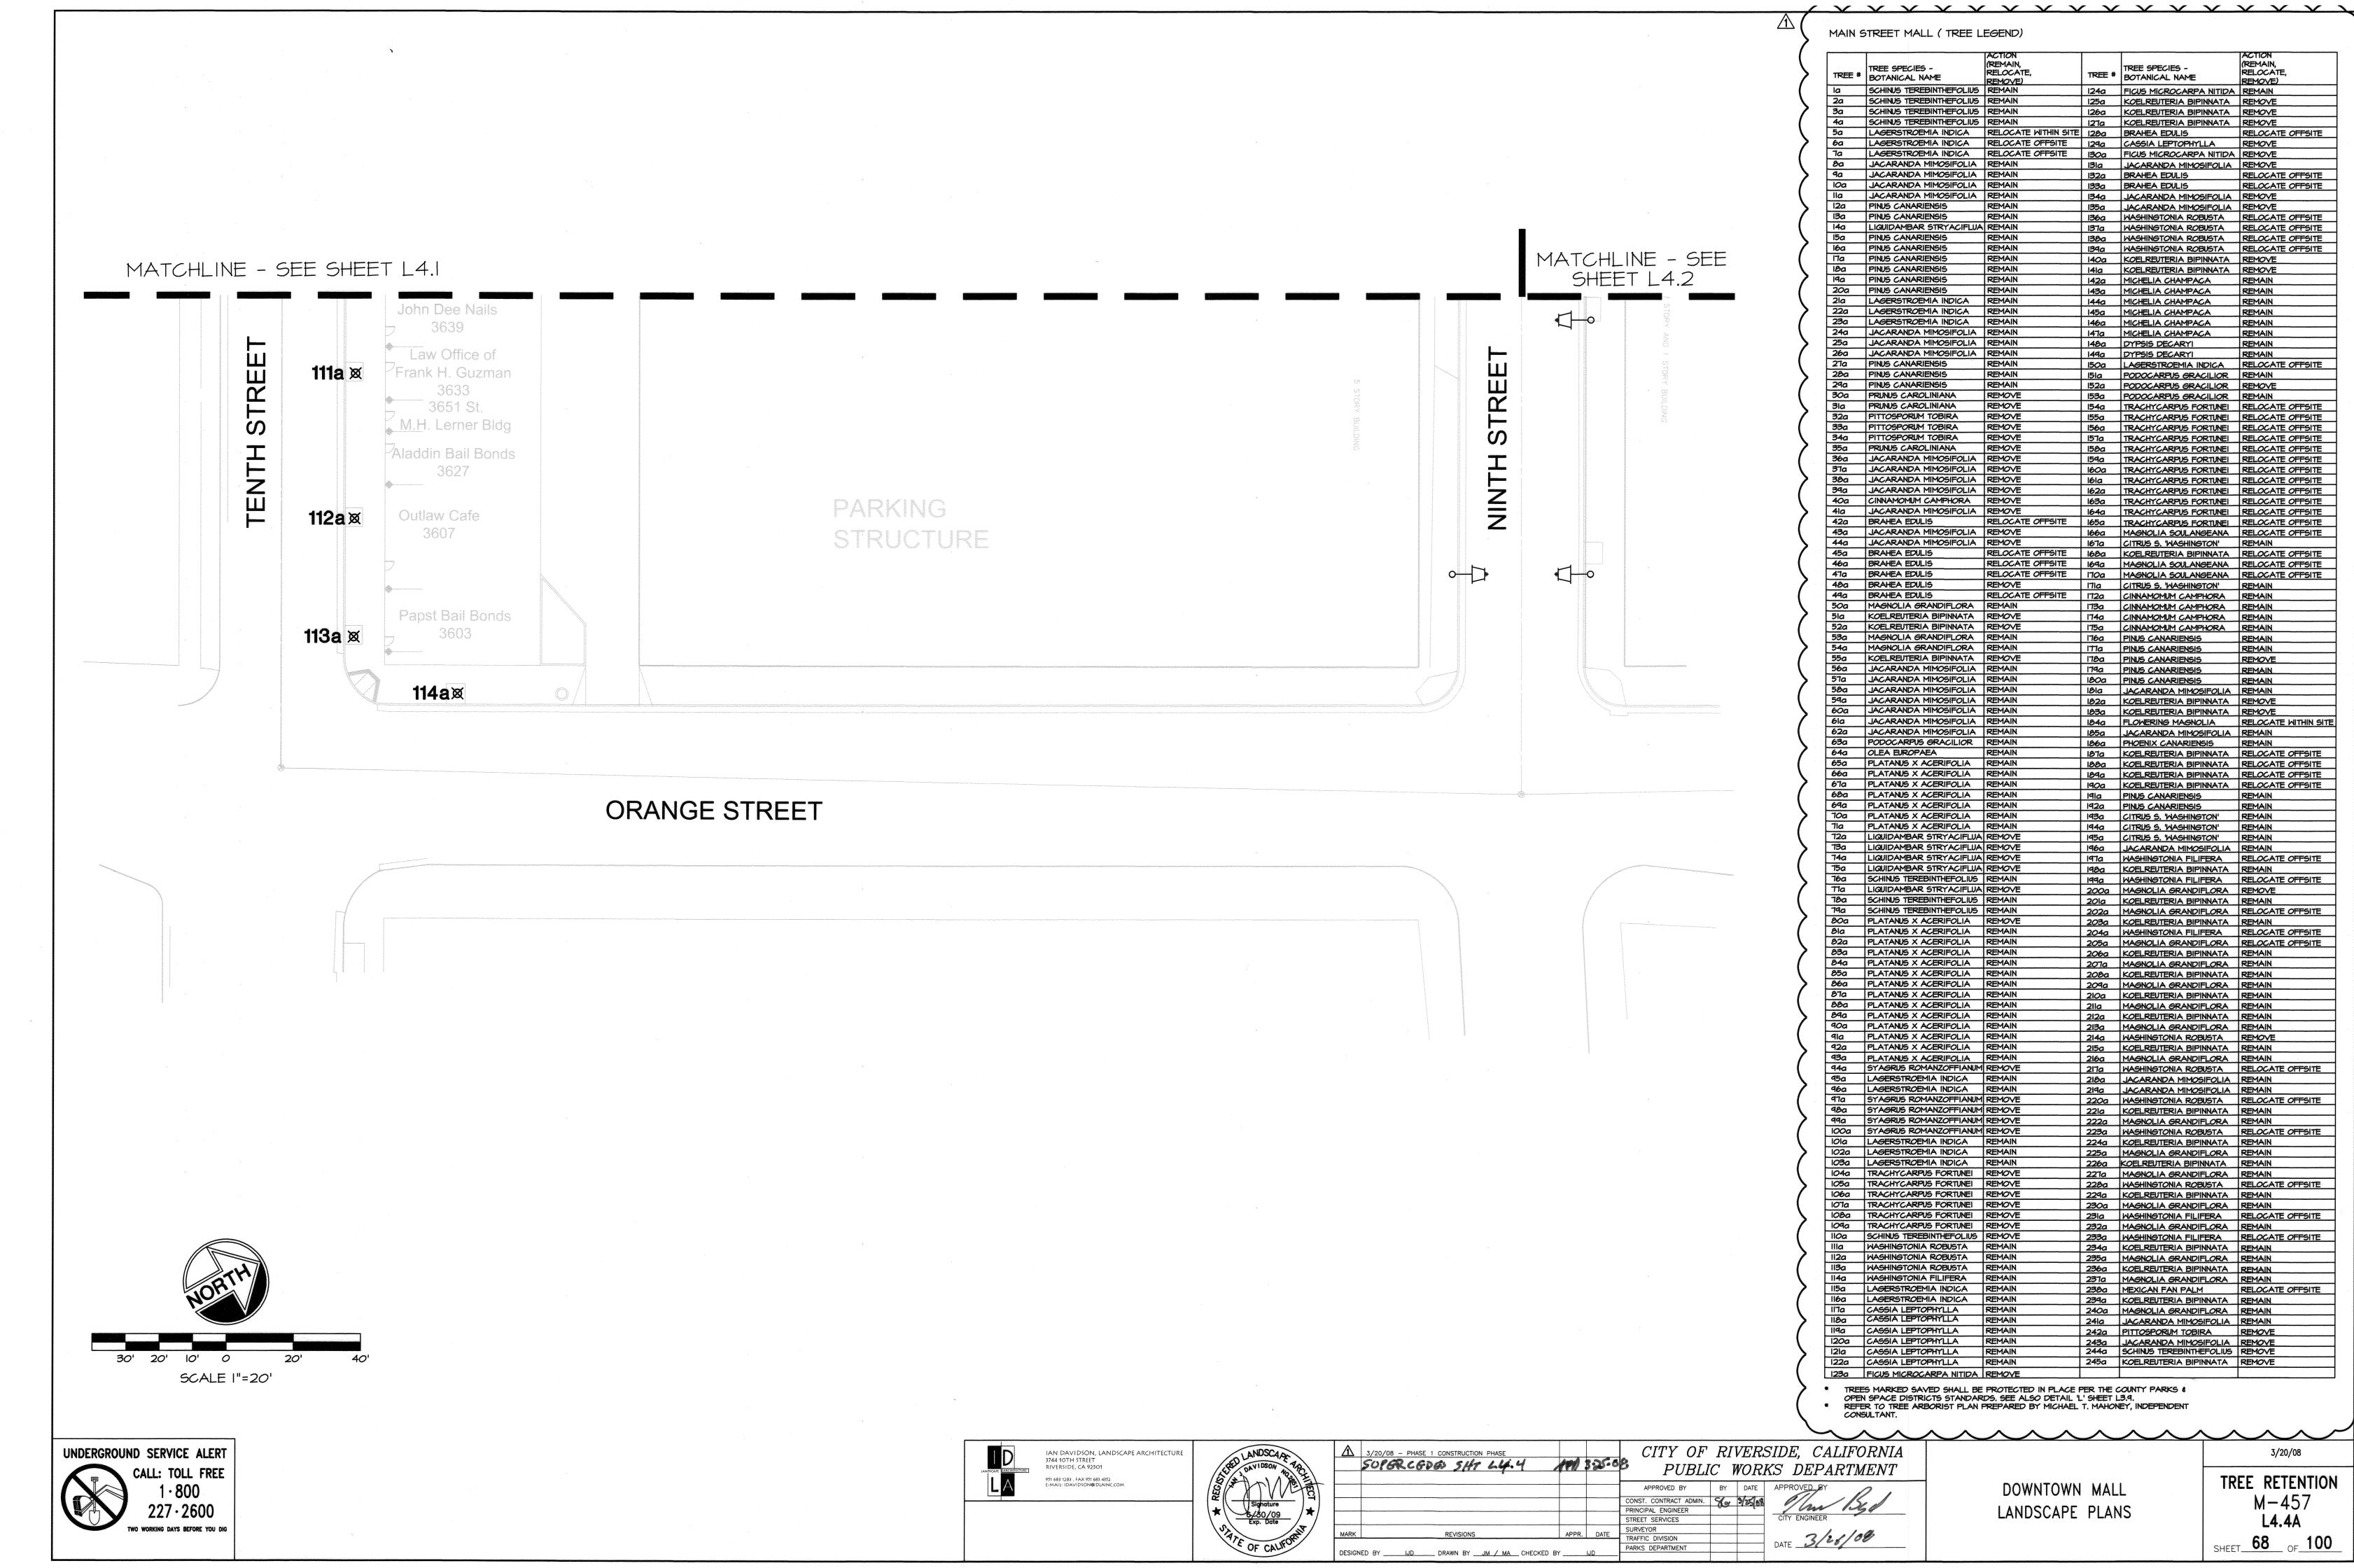

30' 20' 10' 0 20' 40' SCALE I"=20'

UNDERGROUND SERVICE ALERT

CALL: TOLL FREE

1 · 800

227 · 2600

TWO WORKING DAYS BEFORE YOU DIG

IAN DAVIDSON, LANDSCAPE ARCHITECTURE
3744 10TH STREET
RIVERSIDE, CA 92501
951 683 1283 . FAX 951 683 4352
E-MAIL: IDAVIDSON®IDIAINC.COM



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CITY OF RIVERSIDE, CALIFORNIA
PUBLIC WORKS DEPARTMENT

APPROVED BY
NST. CONTRACT ADMIN.
NCIPAL ENGINEER
REET SERVICES
REET SERVICES
REVEYOR

MAIN STREET MALL (TREE LEGEND)

SCHINUS TEREBINTHEFOLIUS REMOVE

SCHINUS TEREBINTHEFOLIUS REMOVE

SCHINUS TEREBINTHEFOLIUS REMOVE

SCHINUS TEREBINTHEFOLIUS REMOVE

JACARANDA MIMOSIFOLIA REMAIN

JACARANDA MIMOSIFOLIA REMAIN

JACARANDA MIMOSIFOLIA REMAIN

JACARANDA MIMOSIFOLIA REMAIN

LIQUIDAMBAR STRYACIFLUA REMAIN

AGERSTROEMIA INDICA REMAIN

JACARANDA MIMOSIFOLIA REMAIN
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CINNAMOMUM CAMPHORA REMOVE

JACARANDA MIMOSIFOLIA REMOVE

JACARANDA MIMOSIFOLIA REMOVE

KOELREUTERIA BIPINNATA REMOVE

MAGNOLIA GRANDIFLORA REMAIN

MAGNOLIA GRANDIFLORA REMAIN

KOELREJTERIA BIPINNATA REMOVE

JACARANDA MIMOSIFOLIA REMAIN

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PODOCARPUS GRACILIOR REMAIN

PLATANUS X ACERIFOLIA PREMAIN

IQUIDAMBAR STRYACIFLUA REMOVE

LIQUIDAMBAR STRYACIFLUA REMOVE

LIQUIDAMBAR STRYACIFLUA REMOVE

LIQUIDAMBAR STRYACIFLUA REMOVE

SCHINUS TEREBINTHEFOLIUS REMOVE

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LIQUIDAMBAR STRYACIFLUA REMOVE

PLATANUS X ACERIFOLIA REMOVE

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TRACHYCARPUS FORTUNEI REMOVE
LAGERSTROEMIA INDICA REMOVE

LAGERSTROEMIA INDICA REMOVE

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TRACHYCARPUS FORTUNEI REMOVE

TRACHYCARPUS FORTUNEI | REMOVE

TRACHYCARPUS FORTUNEI REMOVE

WASHINGTONIA ROBUSTA REMAIN

WASHINGTONIA ROBUSTA REMAIN

WASHINGTONIA ROBUSTA REMAIN
WASHINGTONIA ROBUSTA REMAIN

WASHINGTONIA FILIFERA REMAIN

CASSIA LEPTOPHYLLA REMAIN

CASSIA LEPTOPHYLLA REMAIN

LAGERSTROEMIA INDICA RELOCATE OFFSITE

TREES MARKED SAVED SHALL BE PROTECTED IN PLACE PER THE COUNTY PARKS & OPEN SPACE DISTRICTS STANDARDS. SEE ALSO DETAIL "L' SHEET L3.9.

* REFER TO TREE ARBORIST PLAN PREPARED BY MICHAEL T. MAHONEY, INDEPENDENT

REMOVE

REMOVE

PLATANUS X ACERIFOLIA REMAIN

70a PLATANUS X ACERIFOLIA REMAIN

75a LIQUIDAMBAR STRYACIFLUA REMOVE

810 PLATANUS X ACERIFOLIA REMAIN

83a PLATANUS X ACERIFOLIA REMAIN

87a PLATANUS X ACERIFOLIA REMAIN

92a PLATANUS X ACERIFOLIA REMAIN

LAGERSTROEMIA INDICA

103a TRACHYCARPUS FORTUNEI REMOVE

107a TRACHYCARPUS FORTUNEI REMOVE

108a TRACHYCARPUS FORTUNEI REMOVE 109a SCHINUS TEREBINTHEFOLIUS REMOVE

CASSIA LEPTOPHYLLA

CASSIA LEPTOPHYLLA

CONSULTANT.

BRAHEA EDULIS

BRAHEA EDULIS

98a BRAHEA EDULIS

JACARANDA MIMOSIFOLIA REMOVE

PINUS CANARIENSIS

PINUS CANARIENSIS

PINUS CANARIENSIS
PINUS CANARIENSIS

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PRUNUS CAROLINIANA

PRUNUS CAROLINIANA

PITTOSPORUM TOBIRA

PITTOSPORUM TOBIRA

PITTOSPORUM TOBIRA

PRUNUS CAROLINIANA

BRAHEA EDULIS

BRAHEA EDULIS

BRAHEA EDULIS

BRAHEA EDULIS

BRAHEA EDULIS

BRAHEA EDULIS

OLEA EUROPAEA

MAGNOLIA GRANDIFLORA

KOELREUTERIA BIPINNATA

LAGERSTROEMIA INDICA

AGERSTROEMIA INDICA

TREE SPECIES -

TREE # BOTANICAL NAME

RELOCATE,

REMOVE)

REMAIN

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REMAIN

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RELOCATE OFFSITE

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RELOCATE OFFSITE

RELOCATE OFFSITE

REMAIN

RELOCATE OFFSITE

RELOCATE OFFSITE 154a

AGERSTROEMIA INDICA RELOCATE OFFSITE 1280 BRAHEA EDULIS

DOWNTOWN MALL
LANDSCAPE PLANS

AGERSTROEMIA INDICA RELOCATE OFFSITE 2370 MAGNOLIA GRANDIFLORA REMAIN

12/03/07

TREE RETENTION
M-457
L4.5

SHEET 69 OF 1

REMAIN,

REMOVE)

REMOVE

REMAIN

REMAIN

REMAIN

REMAIN

RELOCATE

RELOCATE OFFSITE

RELOCATE OFFSITE

RELOCATE OFFSITE

REE SPECIES -

122a CASSIA LEPTOPHYLLA

129a CASSIA LEPTOPHYLLA

BRAHEA EDULIS

BRAHEA EDULIS

123a FICUS MICROGARPA NITIDA REMOVE

124a FICUS MICROCARPA NITIDA REMOVE

1300 FICUS MICROCARPA NITIDA REMOVE

134a JACARANDA MIMOSIFOLIA REMOVE

135a JACARANDA MIMOSIFOLIA REMOVE

140a KOELREUTERIA BIPINNATA REMOVE

1410 KOELREUTERIA BIPINNATA REMOVE

MICHELIA CHAMPACA

MICHELIA CHAMPACA

MICHELIA CHAMPACA

DYPSIS DECARY

DYPSIS DECARY

144a MICHELIA CHAMPACA

145a MICHELIA CHAMPACA

1460 MICHELIA CHAMPACA

RELOCATE OFFSITE 167a CITRUS S. WASHINGTON' REMOVE

1490

153a

KOELREUTERIA BIPINNATA REMOVE

JACARANDA MIMOSIFOLIA REMOVE

136a CALIFORNIA FAN PALM RELOCATE OFFSITE
137a CALIFORNIA FAN PALM RELOCATE OFFSITE

1380 CALIFORNIA FAN PALM RELOCATE OFFSITE
1390 CALIFORNIA FAN PALM RELOCATE OFFSITE

1500 LAGERSTROEMIA INDICA RELOCATE OFFSITE

TRACHYCARPUS FORTUNEI RELOCATE OFFSITE

TRACHYCARPUS FORTUNEI | RELOCATE OFFSITE

TRACHYCARPUS FORTUNEI | RELOCATE OFFSITE

TRACHYCARPUS FORTUNE! RELOCATE OFFSITE

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TRACHYCARPUS FORTUNEI | RELOCATE OFFSITE

MAGNOLIA SOULANGEANA | RELOCATE OFFSITE

MAGNOLIA SOULANGEANA RELOCATE OFFSITE

FLOWERING MAGNOLIA RELOCATE WITHIN SITE

KOELREJTERIA BIPINNATA RELOCATE OFFSITE

KOELREJTERIA BIPINNATA RELOCATE OFFSITE

WASHINGTONIA FILIFERA RELOCATE OFFSITE

WASHINGTONIA FILIFERA RELOCATE OFFSITE

REMAIN

REMAIN

REMAIN

RELOCATE OFFSITE

1600 TRACHYCARPUS FORTUNEI RELOCATE OFFSITE

166a MAGNOLIA SOULANGEANA RELOCATE OFFSITE

1680 KOELREUTERIA BIPINNATA RELOCATE OFFSITE

CINNAMOMUM CAMPHORA REMAIN

CINNAMOMUM CAMPHORA REMAIN

INNAMOMUM CAMPHORA REMAIN

JACARANDA MIMOSIFOLIA REMAIN

JACARANDA MIMOSIFOLIA REMAIN

1890 KOELREUTERIA BIPINNATA RELOCATE OFFSITE

1900 KOELREUTERIA BIPINNATA RELOCATE OFFSITE

KOELREUTERIA BIPINNATA REMOVE

2020 MAGNOLIA GRANDIFLORA RELOCATE OFFSITE

204a WASHINGTONIA FILIFERA RELOCATE OFFSITE

MAGNOLIA GRANDIFLORA REMAIN

KOELREUTERIA BIPINNATA REMOVE

MAGNOLIA GRANDIFLORA REMAIN

KOELREUTERIA BIPINNATA REMOVE

MAGNOLIA GRANDIFLORA REMAIN

WASHINGTONIA ROBUSTA REMOVE

2170 WASHINGTONIA-ROBUSTA RELOCATE OFFSITE

223a WASHINGTONIA ROBUSTA RELOCATE OFFSITE

2260 KOELREUTERIA BIPINNATA RELOCATE OFFSITE

2280 WASHINGTONIA ROBUSTA RELOCATE OFFSITE

233a WASHINGTONIA FILIFERA RELOCATE OFFSITE

2380 MEXICAN FAN PALM RELOCATE OFFSITE

WASHINGTONIA FILIFERA RELOCATE OFFSITE

WASHINGTONIA ROBUSTA RELOCATE OFFSITE

1820 KOELREUTERIA BIPINNATA REMOVE

183a KOELREUTERIA BIPINNATA REMOVE

PHOENIX CANARIENSIS

PINUS CANARIENSIS

CITRUS S. 'WASHINGTON'

1940 CITRUS S. 'WASHINGTON' REMAIN

1950 CITRUS S. WASHINGTON' REMAIN

1960 JACARANDA MIMOSIFOLIA REMAIN

2000 MAGNOLIA GRANDIFLORA REMAIN

2010 KOELREUTERIA BIPINNATA REMOVE

2030 KOELREJTERIA BIPINNATA REMOVE

2060 KOELREUTERIA BIPINNATA REMOVE

2010 MAGNOLIA GRANDIFLORA REMAIN

2110 MAGNOLIA GRANDIFLORA REMAIN

212a KOELREIJTERIA BIPINNATA REMOVE

216a MAGNOLIA GRANDIFLORA REMAIN

218a JACARANDA MIMOSIFOLIA REMAIN

2190 JACARANDA MIMOSIFOLIA REMAIN

2210 KOELREUTERIA BIPINNATA REMOVE

224a KOELREUTERIA BIPINNATA REMOVE

227a MAGNOLIA GRANDIFLORA REMAIN

2290 KOELREUTERIA BIPINNATA REMOVE

230a MAGNOLIA GRANDIFLORA REMAIN

2320 MAGNOLIA GRANDIFLORA REMAIN

234a KOELREUTERIA BIPINNATA REMOVE 235a MAGNOLIA GRANDIFLORA REMAIN

239a KOELREUTERIA BIPINNATA REMOVE 240a MAGNOLIA GRANDIFLORA REMAIN

2410 JACARANDA MIMOSIFOLIA REMAIN

236a KOELREUTERIA BIPINNATA REMOVE

MAGNOLIA GRANDIFLORA REMAIN

2220 MAGNOLIA GRANDIFLORA REMAIN

193a

CITRUS S. 'WASHINGTON'

PINUS CANARIENSIS

PINUS CANARIENSIS

PINUS CANARIENSIS

PINUS CANARIENSIS

PINUS CANARIENSIS

CINNAMOMUM CAMPHORA


PODOCARPUS GRACILIOR REMOVE


PODOCARPUS GRACILIOR REMOVE

PODOCARPUS GRACILIOR REMOVE

TREE # BOTANICAL NAME

AGERSTROEMIA INDICA RELOCATE WITHIN SITE 1260 KOELREUTERIA BIPINNATA REMOVE
AGERSTROEMIA INDICA RELOCATE OFFSITE 1270 KOELREUTERIA BIPINNATA REMOVE

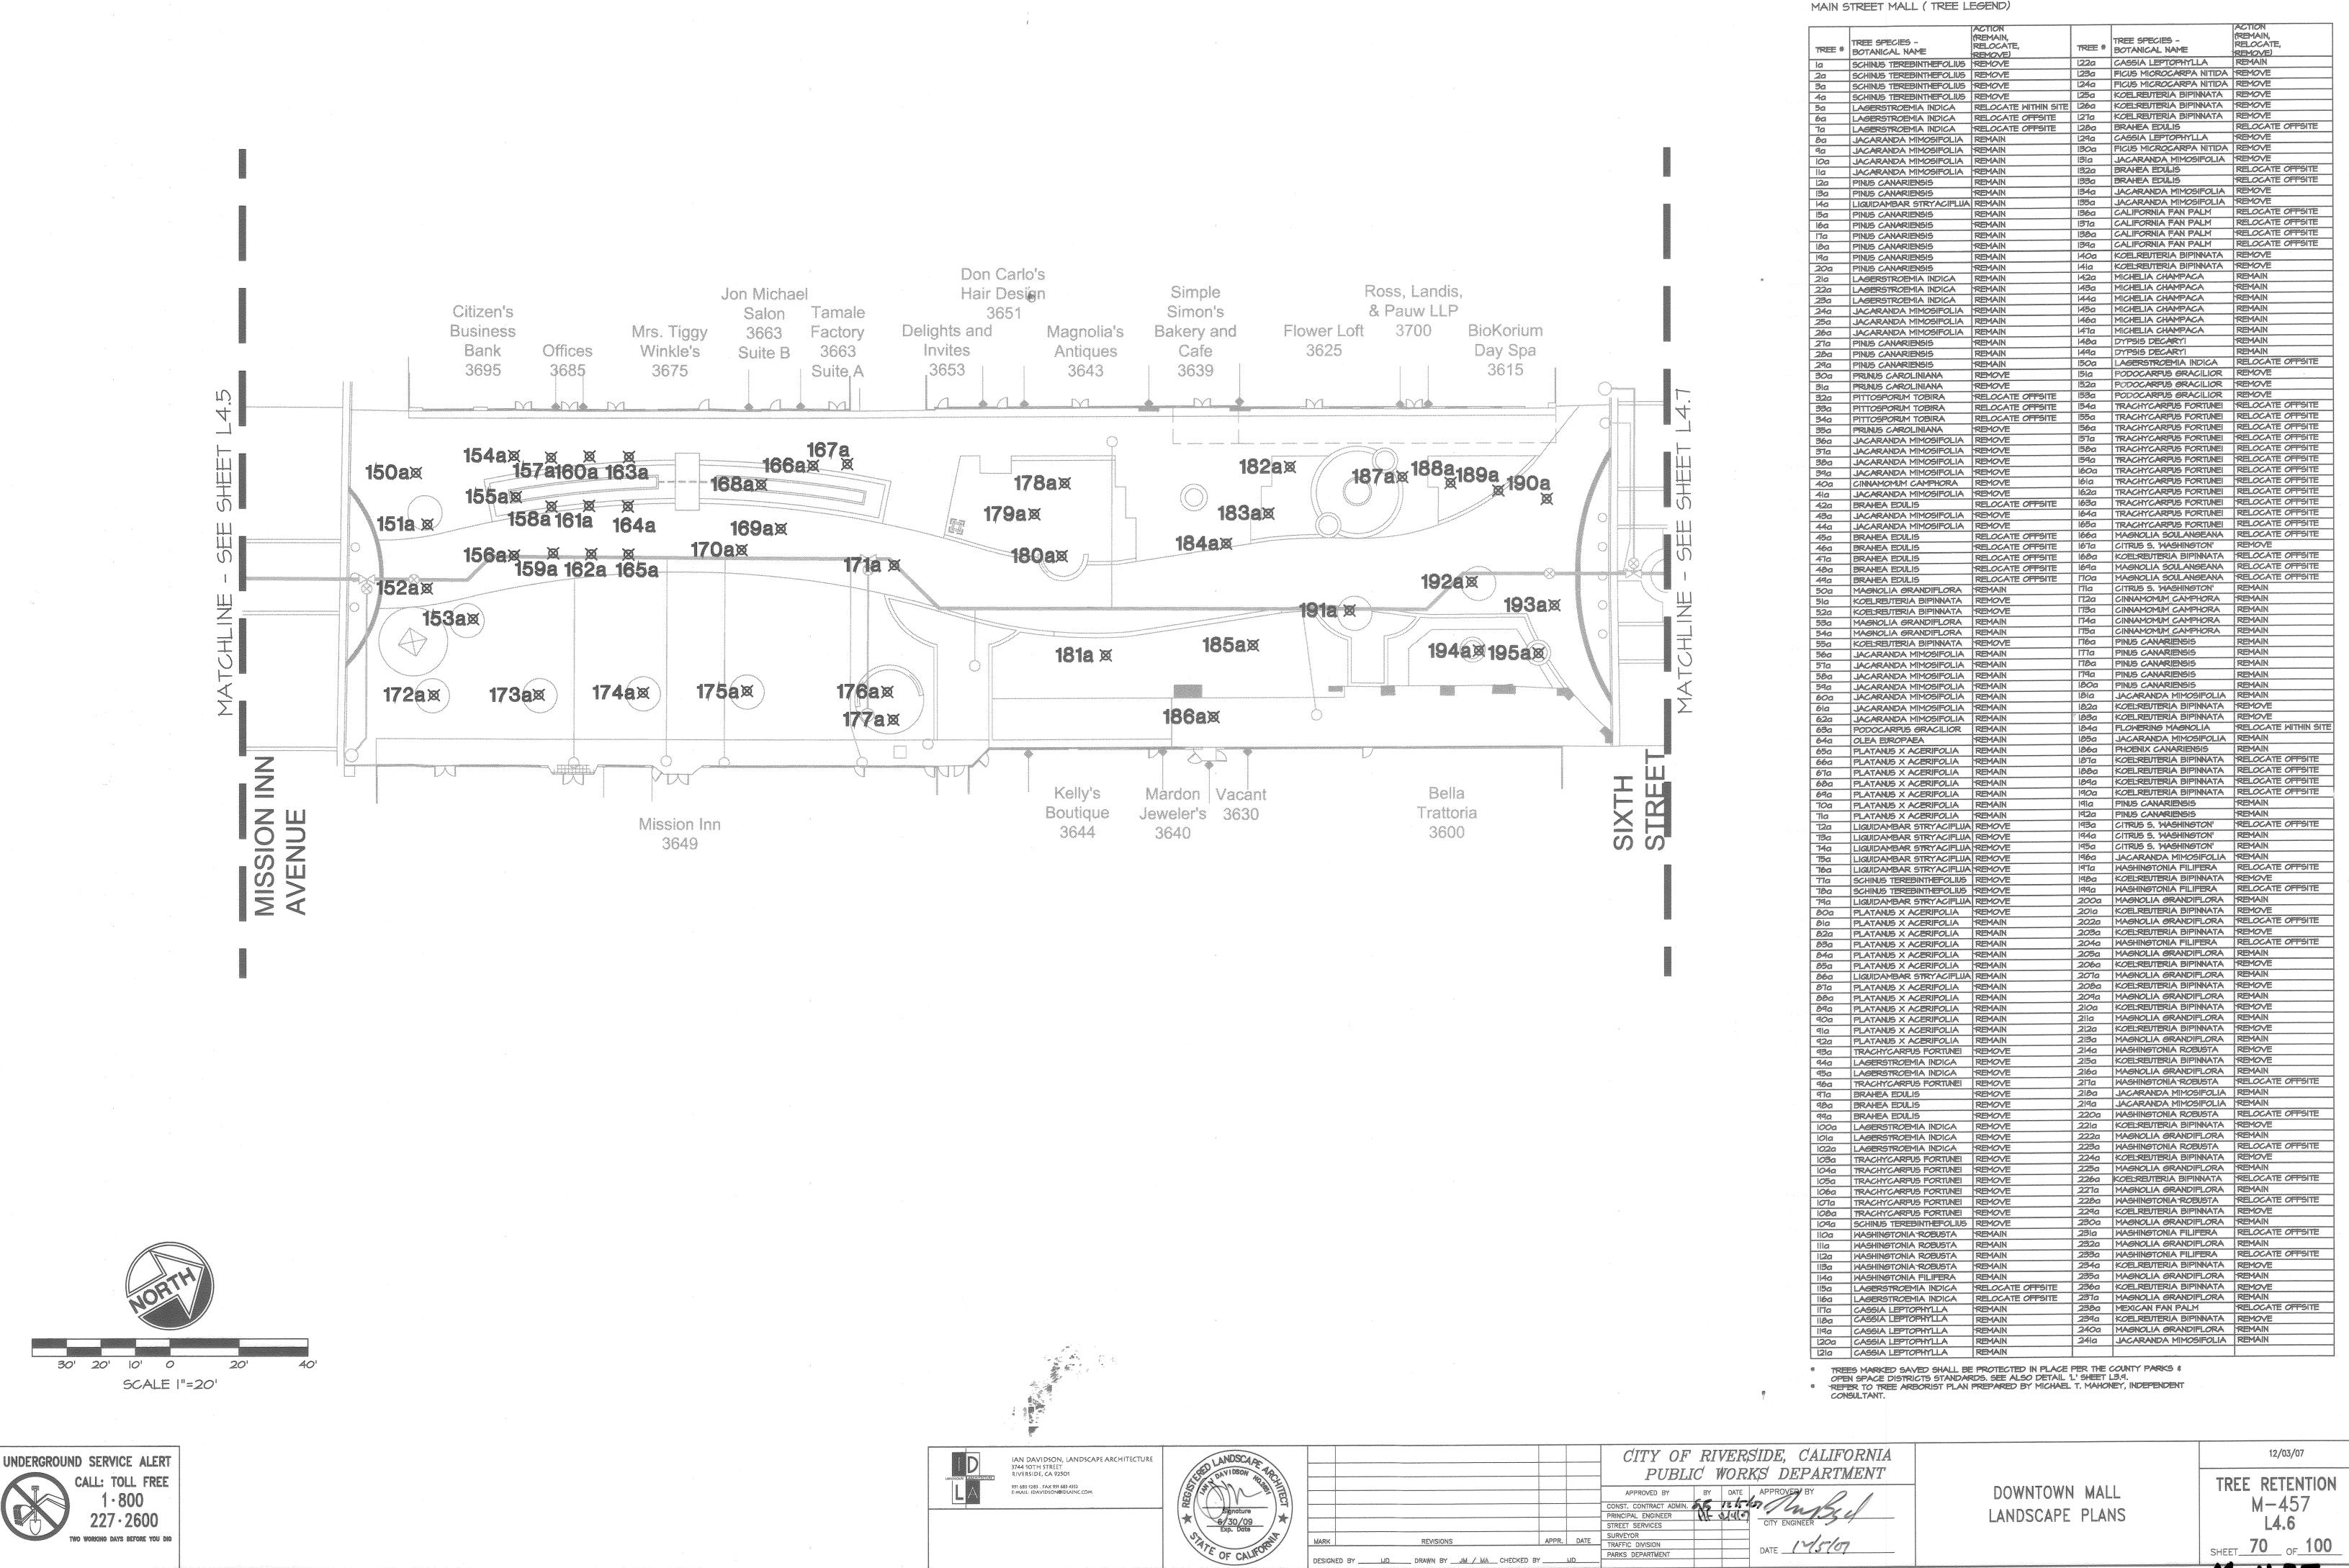

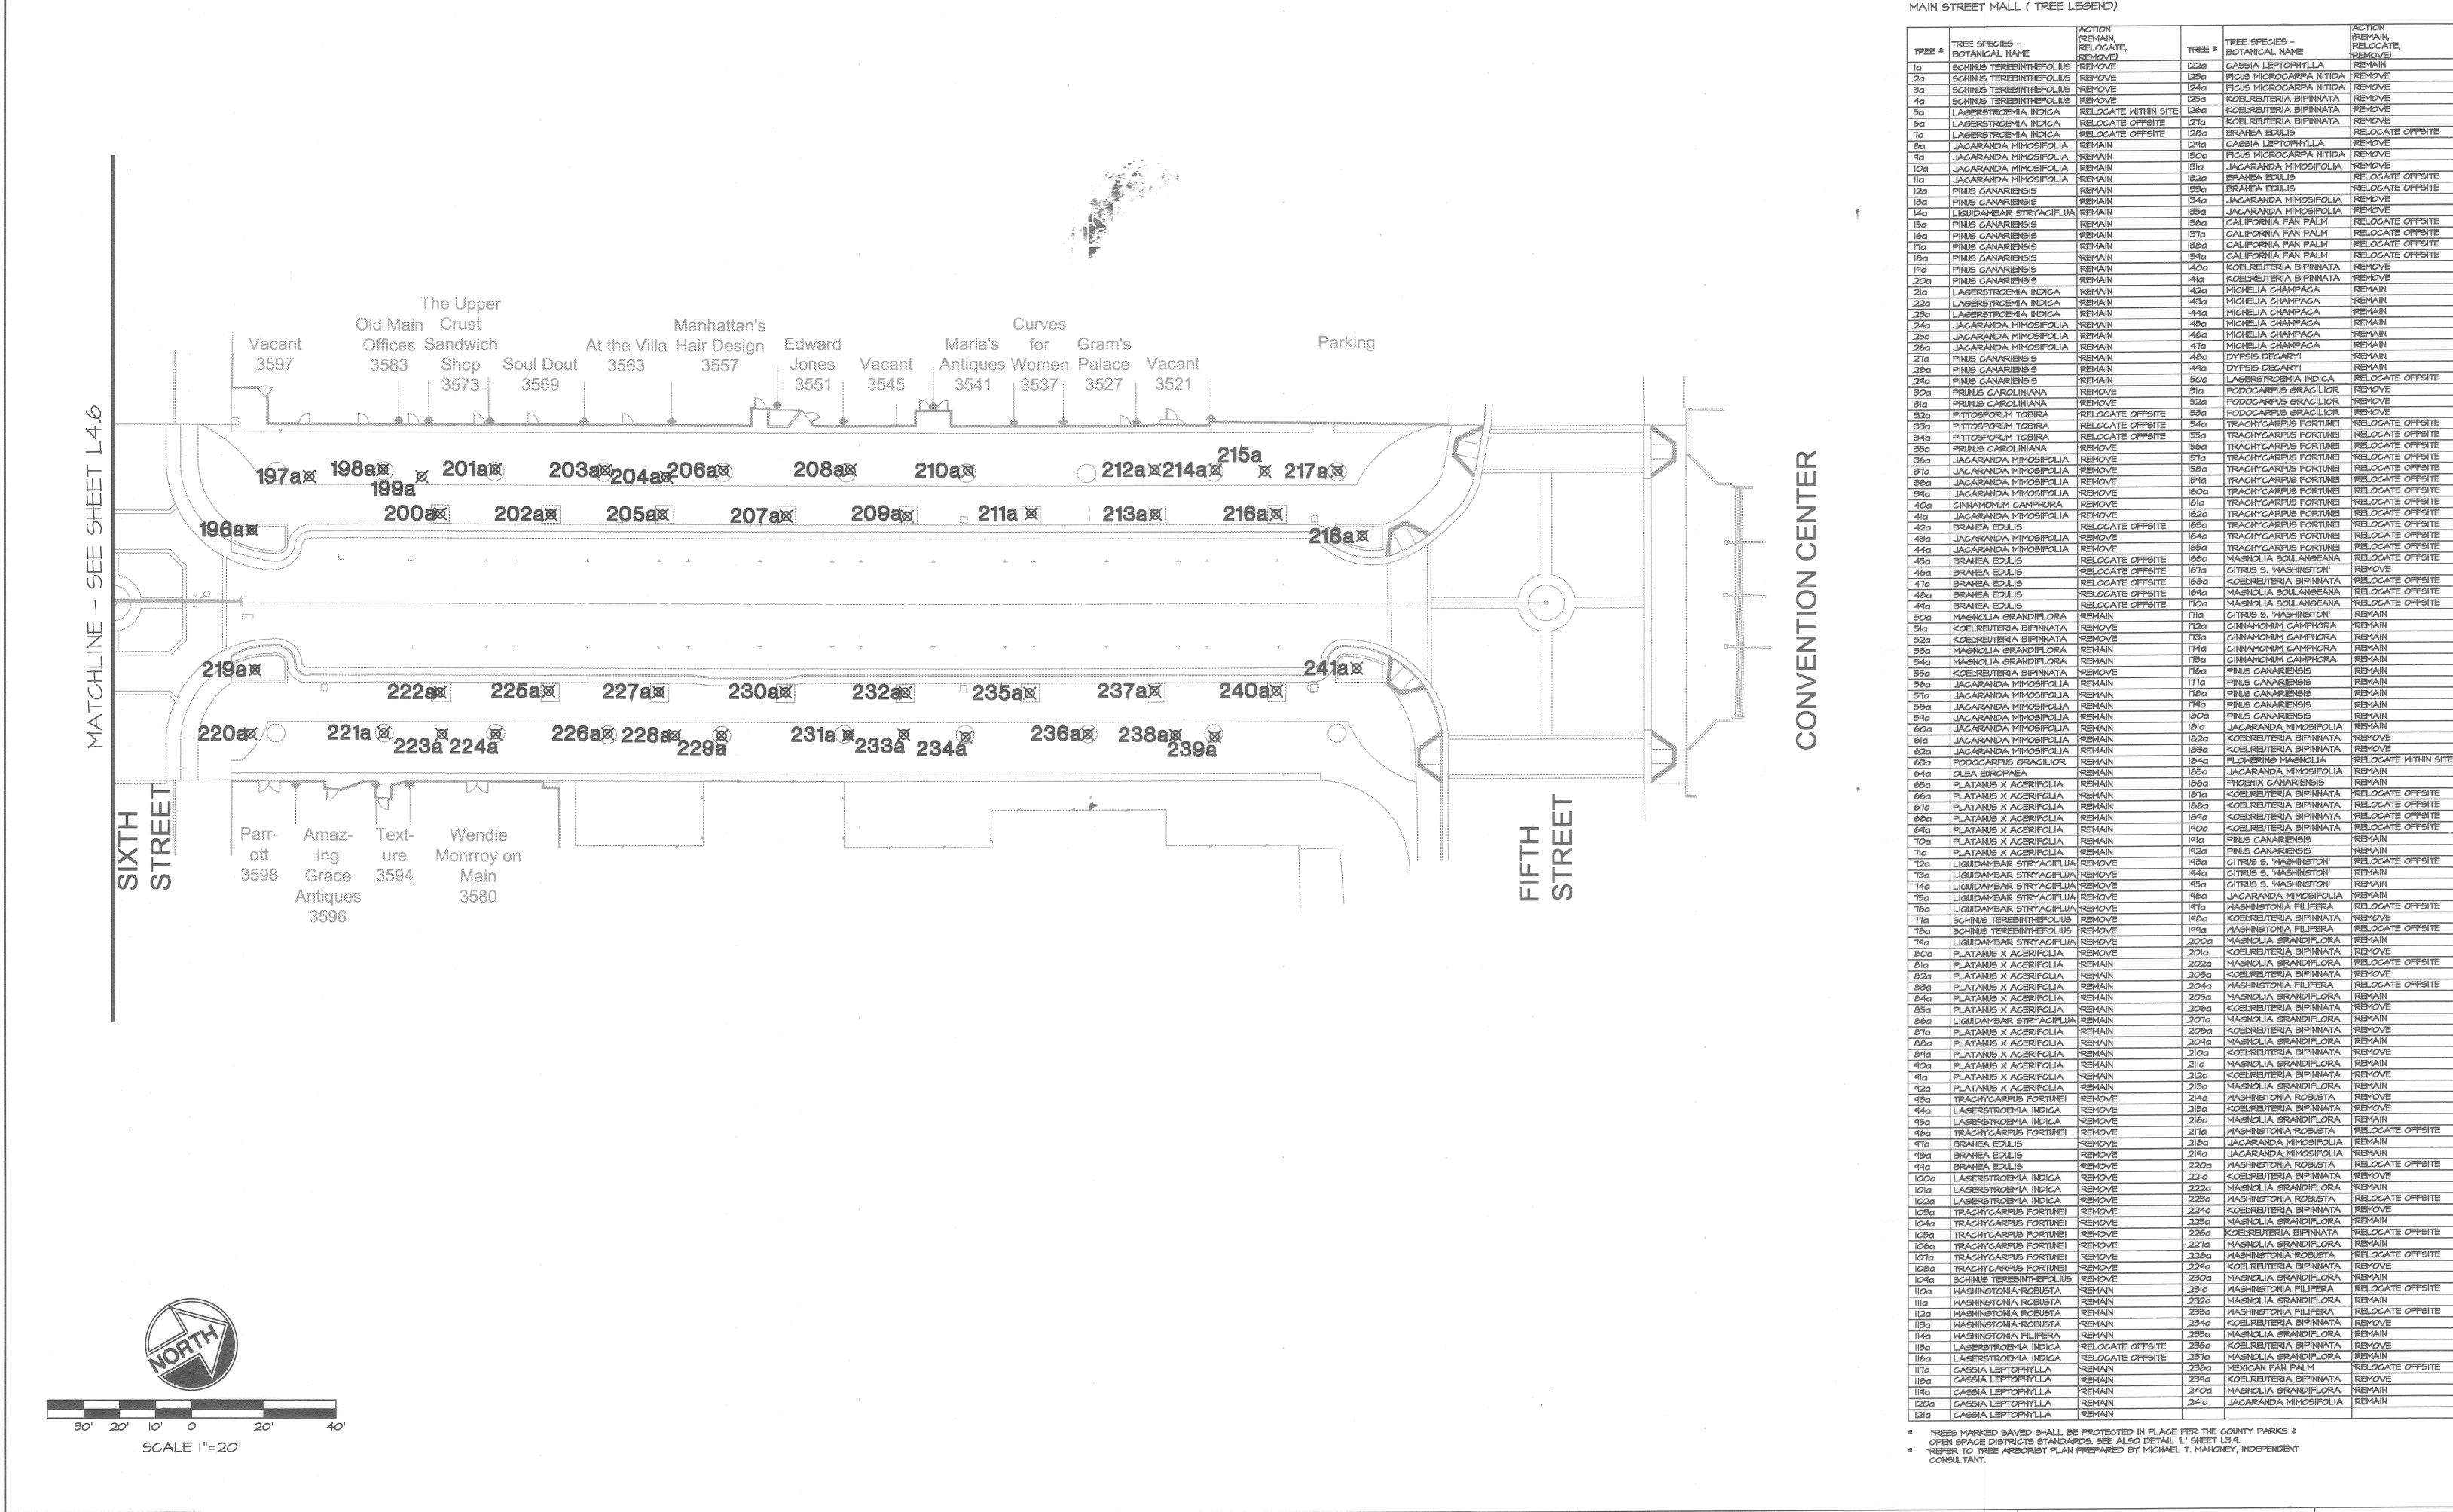

IAN DAVIDSON, LANDSCAPE ARCHITECTURE

STE OF CALIFO

RIVERSIDE, CA 92501

951 683 1283 . FAX 951 683 4352 E-MAIL: IDAVIDSON@IDLAINC.COM

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TREE RETENTION

CITY OF RIVERSIDE, CALIFORNIA

APPROVED BY

BY DATE APPROVED BY

CONST. CONTRACT ADMIN.

PRINCIPAL ENGINEER

CITY ENGINEER

PARKS DEPARTMENT

DESIGNED BY ______ DRAWN BY __JM / MA _ CHECKED BY _____ UD_

PUBLIC WORKS DEPARTMENT

DATE 19/5/01

DOWNTOWN MALL LANDSCAPE PLANS

12/03/07

REMAIN,

RELOCATE,

REMOVE)

RELOCATE OFFSITE

RELOCATE OFFSITE

RELOCATE OFFSITE

REMAIN

REMAIN

REMAIN

YPE	MANUFACTURER CATALOG#	LAMP QTY. & TYPE	FIXTURE WATTAGE	VOLTS	REMARKS
A	ELA #L8120/CR22A/CR43B/P3025D OR APPROVED EQUAL BY DYNAMIC LIGHTING *=COLOR AS SELECTED BY ARCHITECT	(2) IOO WATT METAL HAILDE TMIN (I80°)	244	208 MULTI- TAP BALLAT	TWIN POLE MOUNTED CUTOFF LIGHT FIXTURE COMPLETE WITH TEMPERED GLASS, TAMPERED RESISTANT LATCH, QUICK DISCONNECT, TYPE III DISTRIBUTION, CROSSARM, BANNER ARM, 4" FLUTED ROUND STRAIGHT POLAND SPEAKER BRACKETS. SEE DETAIL 4, SHEET EO.4.
В	ELA #L8120/CR43B/P3025D OR APPROVED EQUAL BY DYNAMIC LIGHTING *=COLOR AS SELECTED BY ARCHITECT	(2) 100 MATT METAL HAILDE TMIN (180°)	244	208 MULTI- TAP BALLAT	TWIN POLE MOUNTED CUTOFF LIGHT FIXTURE COMPLETE WITH TEMPERED GLASS, TAMPERED RESISTANT LATCH, QUICK DISCONNECT, TYPE III DISTRIBUTION, CROSSARM AND 4" FLUTED ROUND STRAIGHT POLE. SEE DETAIL 4, SHEET EO.4.
<b>c</b>	ELA #L8120 OR APPROVED EQUAL BY DYNAMIC LIGHTING *=COLOR AS SELECTED BY ARCHITECT	(I) IOO WATT METAL HAILDE	122	208 MULTI- TAP BALLAT	ARBOR MOUNTED CUTOFF LIGHT FIXTURE COMPLETE WITH TEMPERED GLA TAMPERED RESISTANT LATCH, QUICK DISCONNECT, TYPE III DISTRIBUTION WALL BRACKET.
D	BEGA #8422MH OR APPROVED EQUAL BY KIM LIGHTING	(I) IOO WATT METAL HAILDE	122	120	SQUARE SHIELDED BOLLARD COMPLETE WITH 3/16" THICK ALUMINUM POST ONE PIECE DIE CAST ALUMINUM CAP SECURED WITH FOUR (4) SOCKET HE STAINLESS STEEL SCREWS, HEAVY PRESSED OPTICAL GLASS SPREAD LE INTERNAL ANODIZED ALUMINUM REFLECTOR AND FULLY GASKETED WITH A HIGH TEMPERATURE SILICONE RUBBER CHANNEL.
E	KIM LIGHTING #LTV768MF/5LEDI20/NB/TR60 NO KNOMN EQUAL	5 WATT LED	5	120	6" DIAMETER INGRADE WIDE FLOOD LED LIGHT FIXTURE COMPLETE WITH CAST BRASS HOUSING, 3/16" THICK SLIGHTLY CROWNED CLEAR TEMPERES SODA LIME GLASS LENS, DIE-CAST BRASS LENS RING, BLACKENED STAIL STEEL HEX-SOCKET CAP SCREWS, 340° HORIZONTAL ROTATION AND 15° VERTICAL OPTICAL ADJUSTMENT, MOLDED SILICONE GASKETED THROUGH ANTI-SIPHON PLUGS AND 0°F STARTING TEMPERATURE CONSTANT CURREFLECTRONIC DRIVER.
F	KIM LIGHTING #LTV768WF/I5LEDI20/NB/TR60 NO KNOWN EQUAL	IS MATT LED	15	120	6" DIAMETER INGRADE WIDE FLOOD LED LIGHT FIXTURE COMPLETE WITH CAST BRASS HOUSING, 3/16" THICK SLIGHTLY CROWNED CLEAR TEMPERE SODA LIME GLASS LENS, DIE-CAST BRASS LENS RING, BLACKENED STAIL STEEL HEX-SOCKET CAP SCREWS, 340° HORIZONTAL ROTATION AND 15° VERTICAL OPTICAL ADJUSTMENT, MOLDED SILICONE GASKETED THROUGH ANTI-SIPHON PLUGS AND 0°F STARTING TEMPERATURE CONSTANT CURRE ELECTRONIC DRIVER.
6	KIM LIGHTING #LTV7INF/I8LEDI2O/NB/TR50 NO KNOWN EQUAL	IS WATT LED	18	120	9" DIAMETER INGRADE NARROW FLOOD LED LIGHT FIXTURE COMPLETE ME S/16" MIN. WALL HIGH TEMPERATURE COMPRESSION MOLDED FIBERGLASS COMPOSITE HOUSING, 3/16" THICK SLIGHTLY CROWNED CLEAR TEMPERED SODA LIME GLASS LENS, DIE-CAST BRASS LENS RING BLACKENED STAINLESS STEEL HEX-SOCKET CAP SCREWS, 340° HORIZON ROTATION AND 15° VERTICAL OPTICAL ADJUSTMENT, MOLDED SILICONE GASKETED THROUGHOUT, ANTI-SIPHON PLUGS AND 0°F STARTING TEMPERATURE CONSTANT CURRENT ELECTRONIC DRIVER.
H	BETA-CALCO #NSC6O-RS9771-3 LED-MH-SS NO KNOMN EQUAL	(3) 1.2 WATT LED	3.6	120	5 1/2" DIAMETER INGRADE LED LIGHT FIXTURE COMPLETE WITH DIE- CAS ALUMINUM BODY, BRUSHED STAINLESS STEEL FACE PLATE, I2mm THICK TEMPERED GLASS LENS, TAMPERPROOF SCREWS AND INTEGRAL DRIVER LENS SHALL BE ETCHED IN THE INSIDE TO PROVIDE A WIDEN BEAM SPE, SOFTEN THE LIGHT AND HIDE THE LED ARRAY.
	KIM LIGHTING #EL807/I5LEDI20/BL NO KNOWN EQUAL	IS MATT LED	15	120	RECESSED MOUNTED LED STEP LIGHT FIXTURE COMPLETE WITH DIE-CAST COPPER ALUMINUM HOUSING, TEMPERED PRISMATIC GLASS LENS, STAINLE STEEL HEX-SOCKET CAP SCREWS, 2.5 MIL NOMINAL THICKNESS THERMOS POLYESTER POWDER COAT PAINT, SILICONE GASKET AND 0°F STARTING TEMPERATURE CONSTANT CURRENT ELECTRONIC DRIVER.
	KIM LIGHTING  #ISA/SET4/I75MH*/BL-P/HS (FIXTURE)  #PSA**-4 88/SA/BL-P (POLE) OR APPROVED EQUAL BY GARDCO  * = VOLTAGE SHALL BE FIELD VERIFIED  ** = POLE HEIGHT TO BE FIELD VERIFIED	(I) ITS WATT METAL HAILDE SINGLE	205	VERIFY VOLTAGE IN FIELD	POLE MOUNTED FULL CUTOFF AREA LIGHT FIXTURE COMPLETE WITH DIE-CLOW COPPER ALUMINUM HOUSING, SPECULAR ALZAK SEGMENTED FIELD ROTATABLE REFLECTOR, 3/16" THICK CLEAR TEMPERED FLAT GLASS LE STAINLESS STEEL HARDWARE, 2.5 MIL NOMINAL THICKNESS THERMOSET POLYESTER POWDER COAT PAINT, SILICONE GASKETING, PREWIRED ELECTRICAL MODULE WITH QUICK DISCONNECT PLUGS, TYPE IV DISTRIBUTHOUSE SIDE SHIELD AND 4" SQUARE ALUMINUM POLE. SEE DETAIL 8, SHEEO.4.
$\leq\rangle$	KIM LIGHTING  #ISA/SET4/175MH*/BL-P (FIXTURE)  #PSA**-4188/SA/BL-P (POLE)  OR APPROVED EQUAL BY  GARDCO  * = VOLTAGE SHALL BE FIELD VERIFIED  ** = POLE HEIGHT TO BE FIELD VERIFIED	(1) 175 WATT METAL HAILDE SINGLE	205	VERIFY VOLTAGE IN FIELD	POLE MOUNTED FULL CUTOFF AREA LIGHT FIXTURE COMPLETE WITH DIE-CLOW COPPER ALUMINUM HOUSING, SPECULAR ALZAK SEGMENTED FIELD ROTATABLE REFLECTOR, 3/16" THICK CLEAR TEMPERED FLAT GLASS LESTAINLESS STEEL HARDWARE, 2.5 MIL NOMINAL THICKNESS THERMOSET POLYESTER POWDER COAT PAINT, SILICONE GASKETING, PREWIRED ELECTRICAL MODULE WITH QUICK DISCONNECT PLUGS, TYPE IV DISTRIBUTAND 4" SQUARE ALUMINUM POLE. SEE DETAIL 8, SHEET EO.4.
	KIM LIGHTING  #29B/SET4/I75MH*/BL-P (FIXTURE)  #PSA**-4I88/SB/BL-P (POLE)  OR APPROVED EQUAL BY  GARDCO  * = VOLTAGE SHALL BE FIELD VERIFIED  ** = POLE HEIGHT TO BE FIELD VERIFIED	(2) 175 WATT METAL HAILDE TWIN (180°)	410	VERIFY VOLTAGE IN FIELD	TWIN POLE MOUNTED FULL CUTOFF AREA LIGHT FIXTURE COMPLETE WITH DIE-CAST LOW COPPER ALUMINUM HOUSING, SPECULAR ALZAK SEGMENTE FIELD ROTATABLE REFLECTOR, 3/16" THICK CLEAR TEMPERED FLAT GLALENS, STAINLESS STEEL HARDWARE, 2.5 MIL NOMINAL THICKNESS THERMOROLYESTER POWDER COAT PAINT, SILICONE GASKETING, PREWIRED ELECTRICAL MODULE WITH QUICK DISCONNECT PLUGS, TYPE IV DISTRIBUT AND 4" SQUARE ALUMINUM POLE. SEE DETAIL 8, SHEET EO.4.
M	ARCHITECTURAL AREA LIGHTING  *OSR-70T6EB/LAMP 70/SLN/SAH/BLK/ MPS-45 (FIXTURE)  *PR4/4RI6-125/BLK (POLE)  OR APPROVED EQUAL BY  KIM LIGHTING	(I) 70 WATT T6 CERAMIC METAL HAILDE	95	120	POLE MOUNTED H.I.D. FLOOD LIGHT FIXTURE COMPLETE WITH DIE-CAST ALUMINUM HOUSING, SPUN ALUMINUM PARABOLIC REFLECTOR, CLEAR TEMPERED GLASS LENS, LINEAR SPREAD LENS, FULL HOOD SHIELD, STAIN STEEL HARDWARE, THERMOSET POLYESTER POWDER COAT PAINT, SILICO GASKETING, ELECTRONIC BALLAST MOUNTED ON A PREWIRED PLATE WITH QUICK DISCONNECT PLUG AND 4" ROUND ALUMINUM POLE. SEE DETAIL 4, SHEET EO.4 FOR CONCRETE BASE REQUIREMENTS.
N	KIM LIGHTING #EL732NF/6LEDI2O/BL/PL73/AGS73BL/EPI7 NO KNOWN EQUAL	6 WATT LED	6	120	POWER POST MOUNTED LED LANDSCAPCE LIGHT FIXTURE COMPLETE WITH DIE-CAST ALUMINUM BODY AND SMIVEL, CLEAR TEMPERED SODA LIME G LENS, PRISMATIC LENS INSERT, ADJUSTABLE GLARE SHEILD, I7 1/2" BLAC RESISTANT PVC POWERPOST, 2.5 MIL NOMINAL THICKNESS THERMOSET POLYESTER POWDER COAT PAINT, SILICONE GASKET AND 0°F STARTING TEMPERATURE ELECTRONIC DRIVER.
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NOTE: ALL LIGHT FIXTURES THAT ARE LABELED WITH "NO KNOWN EQUAL" CAN ONLY BE SUBSTITUTED BY SUBMITTING A SAMPLE FOR A TABLE TOP COMPARISON BETWEEN THE ABOVE SPECIFIED LIGHT FIXTURE AND THE LIGHT FIXTURE TO BE SUBMITTED AS AN EQUAL, FOR COMPARISON BY THE OWNER, ARCHITECT AND ELECTRICAL ENGINEER. IF A SAMPLE IS NOT SUBMITTED FOR COMPARISON NO SUBSTITUTIONS WILL BE ACCEPTED AND THE SPECIFIED FIXTURE SHALL BE PROVIDED, NO EXCEPTIONS TAKEN.

#### GENERAL NOTES

- PROVIDE ALL MATERIALS AND LABOR AS REQUIRED TO ACHIEVE A COMPLETE AND OPERATIONAL
- COORDINATE AND OBTAIN APPROVALS FROM ALL RESPECTIVE GOVERNMENTAL AGENCIES AND UTILITY COMPANIES AS REQUIRED FOR A COMPLETE AND FUNCTIONAL INSTALLATION.
- INSTALL RACEWAY SYSTEMS AS FOLLOWS:
- a. USE RIGID GALVANIZED STEEL IN ALL AREAS EXPOSED TO WEATHER OR PHYSICAL DAMAGE. b. USE FLEXIBLE METALLIC CONDUIT FOR SHORT CONNECTION TO LIGHTING FIXTURE (6' MAX.), CONNECTION TO EQUIPMENT REQUIRING VIBRATION ISOLATION AND HORIZONTAL RUNS IN WOOD STUD WALLS. USE SEAL-TITE IN AREAS EXPOSED TO WEATHER.
- c. USE ELECTRICAL METALLIC TUBING (EMT) WITH COMPRESSION TYPE FITTINGS FOR BUILDING INTERIOR WORK.
- d. USE P.V.C. CONDUIT UNDERGROUND WITH CODE SIZED GROUND. CONDUIT RISERS AND STUBS ABOVE GRADE SHALL BE I.M.C. WITH HALF-LAPPED TAPE COVERING OR P.V.C.
- 4. ALL NEW WIRING SHALL BE 600 VOLT RATED COPPER TYPE "THHN/THWN" U.O.N..
- 5. ALL FIXTURE, DEVICE, ETC... LOCATIONS SHALL BE VERIFIED WITH ARCH. DRAWINGS AS WELL AS EQUIPMENT SUPPLIER REQUIREMENTS PRIOR TO ANY ROUGH-IN WORK.
- 6. ALL LIGHTING FIXTURES SHALL BE MOUNTED AND SUPPORTED IN ACCORDANCE WITH OSHA STANDARDS AND ALL LOCAL, STATE, AND NATIONAL ELECTRICAL CODES.
- THE NUMERAL(S) SHOWN AT TOP LIGHT FIXTURE IDENTIFICATION SYMBOL WHICH INDICATES NUMBER OF LIGHT FIXTURES REQUIRED SHALL NOT BE USED BY THE CONTRACTOR FOR HIS QUANTITY TAKE-OFF AT BIDDING OR FOR DETERMINATION OF HOW MANY FIXTURES WILL BE INSTALLED. THE CONTRACTOR SHALL INSTALL A LIGHT FIXTURE WHEREVER A FIXTURE OUTLET IS SHOWN ON
- THESE DRAWINGS ARE DIAGRAMMATIC AND REPRESENT THE INTENT OF EQUIPMENT, DEVICES, ETC. TO BE CONNECTED AND THE CIRCUITS TO WHICH THEY ARE TO BE CONNECTED TO. THE CONTRACTOR SHALL INSTALL ALL CONDUIT, J-BOXES, ETC. AS REQUIRED FOR A COMPLETE AND FULLY OPERATIONAL SYSTEM.
- 9. ALL EXTERIOR EQUIPMENT SHALL BE WEATHERPROOF.
- 10. ELECTRICAL CONTRACTOR SHALL PERFORM ALL WORK IN STRICT ACCORDANCE WITH ALL LOCAL, STATE, AND NATIONAL GOVERNING CODES.
- 11. ALL EQUIPMENT SHALL BE NEW AND BEAR A "UL" LABEL U.O.N..
- ELECTRICAL CONTRACTOR SHALL SECURE AND PAY FOR ALL NECESSARY BUILDING PERMITS.
- 13. COMPLETE ELECTRICAL INSTALLATION SHALL BE GUARANTEED IN WRITING FOR A PERIOD OF (1)
- 14. SEE SINGLE LINE DIAGRAM FOR CONDUIT AND CONDUCTOR SIZES, PANELS, TRANSFORMERS, MOTOR CONTROL CENTERS, MECHANICAL EQUIPMENT, ETC. HOMERUNS TO PANELS MAY NOT BE SHOWN ON PLANS BUT ARE PART OF THIS CONTRACT.
- ELECTRICAL CONTRACTOR SHALL VISIT SITE PRIOR TO BID DATE, TO VERIFY ALL EXISTING CONDITIONS TO BE ENCOUNTERED IN THE INSTALLATION OF ALL NEW EQUIPMENT, FIXTURES, DEVICES. FEEDERS. ETC.. EXACT INSTALLATION METHOD AND REQUIREMENTS SHALL BE VERIFIED AND DETERMINED PRIOR TO BID DATE. CONTRACTORS SHALL IMMEDIATELY NOTIFY THIS ENGINEER OF ANY REQUIRED MODIFICATIONS WHICH ARE NOT SHOWN ON THESE DRAWINGS. SUBMITTAL OF BID INDICATES CONTRACTOR IS AWARE OF ALL JOB SITE CONDITIONS AND WORK TO BE PERFORMED.
- 16. IT SHALL BE THIS CONTRACTOR'S RESPONSIBILITY TO DO ALL CORING, CUTTING, PATCHING AND REFINISHING OF WALLS AND SURFACES WHEREVER IT IS NECESSARY FOR HIM TO PENETRATE FOR HIS WORK. ALL OPENINGS MADE SHALL BE SEALED TO MEET THE RATED INTEGRITY OF THE PARTICULAR WALL, FLOOR OR CEILING.
- 17. ALL FINAL CONNECTIONS TO OWNER-FURNISHED EQUIPMENT SHALL BE MADE BY THE CONTRACTORS.
- 18. ALL ELECTRICAL EQUIPMENT CHARACTERISTICS, LOCATIONS, AND CONNECTION REQUIREMENTS SHALL BE VERIFIED PRIOR TO ANY ROUGH-IN WORK.
- ELECTRICAL CONTRACTOR SHALL SUBMIT SHOP DRAWINGS FOR ALL ELECTRICAL EQUIPMENT AND ELECTRICAL MATERIALS TO BE USED ON THE PROJECT. ALL ITEMS SHALL BE APPROVED BY THE ENGINEER PRIOR TO ANY COMMENCEMENT OF PLACING ORDERS OR PERFORMING ANY ROUGH-IN
- THESE DRAWINGS AND SPECIFICATIONS ARE TO BE CONSIDERED AS CONTRACT DOCUMENTS REQUIRED FOR AGENCIES REVIEW, APPROVAL AND FOR BIDDING PURPOSES ONLY. THE CONTRACTOR SHALL SUBMIT SCALED CONSTRUCTION DRAWINGS SHOWING EQUIPMENT LOCATIONS, CONDUIT ROUTING AND POINT TO POINT CONNECTIONS AS A PART OF THE SHOP DRAWING SUBMITTALS.
- COMPLETE ELECTRICAL SYSTEM SHALL BE GROUNDED IN ACCORDANCE WITH THE PRESENTLY ADOPTED EDITION OF THE C.E.C. ART. 250. ALL POWER AND LIGHTING BRANCH CIRCUITS SHALL BE INSTALLED WITH A #12 GREEN GROUND WIRE U.O.N.
- 22. PROVIDE ENGRAVED PLASTIC NAMEPLATES FOR ALL MAJOR ELECTRICAL EQUIPMENT.
- 23. PROVIDE THE OWNER AND THIS ENGINEER WITH ONE SET OF ELECTRICAL "AS-BUILTS" AT THE
- 24. ALL DISCONNECT SWITCHES SHALL BE HEAVY DUTY TYPE AND PROVIDED WITH REJECTION TYPE
- 25. EVERY CONDUCTOR OF EACH SYSTEM SHALL BE PERMANENTLY TAGGED AS INDICATED IN THE SPECIFICATIONS.
- 26. ALL EXPOSED CONDUITS, IN VIEW OF THE PUBLIC, SHALL BE APPLIES WITH TWO (2) COATS OF PAINT TO MATCH FINISH OF SURFACE TO WHICH IT IS ATTACHED/SUPPORTED TO.
- 27. ALL CONDUIT ONLY (C.O.) SHALL BE PROVIDED WITH A 3/16" PULL ROPE, TAGGED AND IDENTIFIED
- AT BOTH ENDS WITH THE LOCATION OF TERMINATION. WHERE A CONFLICT OCCURS BETWEEN THE PLANS AND THE ELECTRICAL SPECIFICATIONS ISSUED AS
- A PART OF THESE DOCUMENTS, THE MORE STRINGENT REQUIREMENT SHALL PREVAIL.
- THE SEISMIC ANCHORAGE OF ELECTRICAL EQUIPMENT SHALL CONFORM TO C.C.R. TITLE 24, 2001 CBC SECTION 1632A AND TABLE 16A-O. ANCHORAGE DETAILS NOT SHOWN ON THE APPROVED PLANS ARE SUBJECT TO FIELD APPROVAL BY THE ARCHITECT AND/OR STRUCTURAL ENGINEER OF RECORD AND FIELD INSPECTOR.
- 30. ALL UNDERGROUND UTILITIES AND/OR STRUCTURES THAT ARE SHOWN ON THE PLANS HAVE BEEN REPORTED BY THE OWNER AND/OR OTHERS AND THOSE THAT WERE SHOWN ON THE RECORD DRAWINGS EXAMINED ARE INDICATED WITH THEIR APPROXIMATE LOCATION AND EXTENT. THE CONTRACTOR, BY ACCEPTING THESE PLANS OR PROCEEDING WITH IMPROVEMENTS PURSUANT THERETO AGREES TO ASSUME LIABILITY AND TO HOLD THE ENGINEER HARMLESS FOR ANY DAMAGES RESULTING FROM THE EXISTENCE OF UNDERGROUND UTILITIES AND/OR STRUCTURES NOT REPORTED TO THE ENGINEER, NOT INDICATED ON THE RECORDS DRAWINGS EXAMINED AND LOCATED AT VARIANCE WITH THAT REPORTED AND/OR SHOWN ON THE RECORDS DRAWINGS EXAMINED. THE CONTRACTOR IS REQUIRED TO TAKE DUE PRECAUTIONARY MEASURES TO PROTECT THE UTILITIES AND/OR STRUCTURES FOUND AT THE SITE. IT SHALL BE THE CONTRACTORS RESPONSIBILITY TO NOTIFY THE OWNER, ARCHITECT AND ENGINEER OF THE UTILITIES AND/OR STRUCTURES CONCERNED BEFORE STARTING WORK.
- THE CONTRACTOR SHALL PROVIDE ENGRAVED WALL PLATES FOR ALL OUTLETS AND SWITCHES INDICATING THE PANEL DESIGNATION AND CIRCUIT NUMBER.
- ALL ELECTRICAL DEVICES, FIXTURES, CONDUIT, WIRING, EQUIPMENT, ETC. SHOWN ON THESE PLANS ARE NEW UNLESS OTHERWISE INDICATED.

#### ELECTRICAL SYMBOLS LIST

- CONDUIT CONCEALED WITHIN BUILDING WALLS OR CEILING SPACE. TICK MARKS INDICATE QUANTITY OF #12 THHN/THWN CONDUCTORS - U.O.N., CONDUIT SHOWN WITH NO TICK MARKS INDICATE 2 #12 THHN/THWN CONDUCTORS - U.O.N.. NUMERALS ADJACENT TO TICK MARKS ON CONDUIT RUNS INDICATE SIZE OF CONDUCTORS IN LIEU OF #12. CONDUIT SHALL BE 3/4" MINIMUM - U.O.N..
- ---#--- CONDUIT ROUTED BELOW FINISHED GRADE AND / OR CONCRETE SLAB. TICK MARKS INDICATE QUANTITY OF #12 THHN/THWN CONDUCTORS - U.O.N.. CONDUITS SHOWN WITH NO TICK MARKS INDICATE 2 #12 THHN/THWN CONDUCTORS - U.O.N.. NUMERALS ADJACENT TO TICK MARKS ON CONDUIT RUNS INDICATE SIZE OF CONDUCTORS IN LIEU OF #12. CONDUIT SHALL BE 3/4" MINIMUM - U.O.N.. INCLUDE CODE SIZED COPPER BOND CONDUCTOR (NOT SHOWN ON PLAN) IN ALL NON-METALLIC CONDUIT RUNS.
- HOMERUN TO DESTINATION AS INDICATED. REFER TO CONDUIT SYMBOL ABOVE.
- -E EXISTING CONDUIT AND CONDUCTORS TO REMAIN.
- -R- EXISTING CONDUIT AND CONDUCTORS TO BE REMOVED.
- LIGHTING FIXTURE IDENTIFICATION SYMBOL. LETTER INDICATES TYPE OF FIXTURE. NUMERAL AT TOP OF HEXAGON INDICATES NUMBER OF FIXTURES REQUIRED, NUMBER AT BOTTOM OF HEXAGON INDICATES MOUNTING HEIGHT FROM FLOOR TO BOTTOM OF FIXTURE. OMMISSION OF MOUNTING HEIGHT INDICATES CEILING MOUNTING. +20'-0"
- WEATHERPROOF SPECIAL EVENT RECEPTACLE MOUNTED AT +18" A.F.F. U.O.N.. 50 AMP, 125/250 VOLTS, 3 POLE, 4 WIRE GROUNDING. VERIFY NEMA CONFIGURATION WITH THE CITY OF RIVERSIDE PRIOR TO PLACING ORDER.
- WEATHERPROOF STANDARD 20A, 120V-10 GROUNDING TYPE "GROUND FAULT INTERRUPTER" (G.F.I.) RECEPTACLE MOUNTED AT +18" A.F.F. - U.O.N.
- JUNCTION BOX. SIZED BY THIS CONTRACTOR PER ACTUAL NUMBER OF CONDUITS AND/OR CONDUCTORS PASSING THRU. WP - DENOTES WEATHERPROOF.
- WALL MOUNTED EXTERIOR SPEAKER. WP DENOTES WEATHERPROOF.
- BOLLARD TYPE LIGHTING FIXTURE. PROVIDE CONCRETE FOOTING PER MFGRS. REQUIREMENTS.
- INGRADE LIGHTING FIXTURE.
- STEP LIGHT FIXTURE.
- PARKING LOT LIGHTING FIXTURE.
- O-O AREA LIGHTING FIXTURE.
- POLE MOUNTED FLOOD LIGHT FIXTURE.
- FLOOD LIGHT FIXTURE.
- LANDSCAPE FLOOD LIGHT FIXTURE.
- STREET LIGHTING FIXTURE.
- WALL MOUNTED LIGHTING FIXTURE.
- ⑤-●-⑤ POLE MOUNTED EXTERIOR SPEAKER.
- STERIOR SPEAKER

#### **DEMOLITION NOTES**

- 1. THE EXISTING CONDITIONS SHOWN ARE FROM AVAILABLE RECORD DRAWINGS AND SHOWN FOR REFERENCE ONLY. CONTRACTOR SHALL VERIFY ACTUAL EXISTING CONDITIONS AT SITE PRIOR TO SUBMITTING BID. ALL DEMOLITION, ALTERATION, EXTENSION, RELOCATION, REHABILITATION WORK SHALL BE INCLUDED IN CONTRACT. NO ADDITIONAL ALLOWANCE OR CHANGE ORDERS WILL BE
- NOTIFY THE ENGINEER IMMEDIATELY WHEREVER EXISTING EQUIPMENT IS ENCOUNTERED WHICH MUST BE RELOCATED DUE TO THE NEW CONSTRUCTION, OR NOT INDICATED ON "AS-BUILT" DRAWINGS OR WAS BURIED UNDERGROUND OR EMBEDDED IN STRUCTURE WALLS.
- 3. CAREFULLY PROTECT ALL WALLS, TRIM, FLOORS, EQUIPMENT, UTILITY LINES AND MATERIALS. WHEN WORKING ON FINISHED SURFACES, LIMIT DAMAGE TO THE SMALLER AREA IF POSSIBLE AND RESTORE TO THE ORIGINAL CONDITION ALL SURFACES WHICH ARE DAMAGED BECAUSE OF THE INSTALLATION
- EQUIPMENT, MATERIALS AND SUPPLIES TEMPORARILY REMOVED FOR PROTECTION SHALL BE REPLACED IN ORIGINAL LOCATIONS. ANY MATERIALS DAMAGED SHALL BE REPLACED WITH NEW MATERIALS OF LIKE KIND AND QUALITY.
- 5. DEMOLITION WORK SHALL BE DONE IN A MANNER WHICH WILL NOT CAUSE UNNECESSARY INCONVENIENCE OR DANGER TO USERS OF THE PREMISES AND ADJACENT SITE, AND NOT INTERFERE WITH ITS OPERATION. ANY DEMOLITION WORK TO BE PERFORMED MUST BE PLANNED IN ADVANCE.
- 6. RESEAL ALL PENETRATIONS OR OPENINGS THROUGH WALLS, CEILING, FLOORS, ETC., TO MAINTAIN THE RATING OF STRUCTURE.
- 7. ALL REMOVED MATERIALS AND EQUIPMENT WHICH IS SALVAGED MATERIAL SHALL REMAIN IN THE PROPERTY OF THE OWNER. DELIVER SUCH SALVAGED MATERIALS AND EQUIPMENT ON THE PREMISES AS DIRECTED BY OWNER AND NEATLY PILE OR STORE THEM AND PROTECT FROM DAMAGE. DISPOSE OF ALL HAZARDOUS MATERIAL PER GUIDELINE OF THE STATE OF CALIFORNIA, DEPARTMENT OF HEALTH SERVICES AND OTHER AGENCIES HAVING JURISDICTION.

#### REFERENCES & ABBREVIATIONS


(E-1)	DETAIL REFERENCE	MCB	MAIN CIRCUIT BREAKER
1	KEYNOTE REFERENCE	FLA	FULL LOAD AMPS
AFF	ABOVE FINISH FLOOR	С	CONDUIT
UON	UNLESS OTHERWISE NOTED	٧	VOLTS
CO	CONDUIT ONLY W/PULL ROPE	Α	AMPS
WP	WEATHER PROOF	GFI	GROUND FAULT INTERRUPTER
CU	COPPER	GND	GROUND
MLO	MAIN LUGS ONLY	VL	VERIFY LOCATION
(E)	EXISTING TO REMAIN	AC	ABOVE COUNTER
(R)	EXISTING TO BE REMOVED	NL	NIGHT LIGHT
(RR)	EXISTING TO BE RELOCATED	ЕМ	EMERGENCY
(EN)	EXISTING IN NEW LOCATION	oc	ON CENTER


DOWNTOWN MALL

LANDSCAPE PLANS

12-23-2007 ELECTRICAL PLAN

UNDERGROUND SERVICE ALERT CALL: TOLL FREE

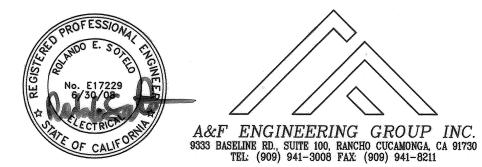

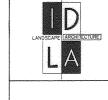

an Davidson, Landscape Architecture RIVERSIDE, CA 92501



ANDSC4PA

A RE-NUMBERED SHEET HAD 12-4-07 CITY OF RIVERSIDE, CALIFORNIA PUBLIC WORKS DEPARTMENT APPROVED BY _ DRAWN BY _____ MWK ___ CHECKED BY ____ RES

BY DATE APPROVED BY CONST. CONTRACT ADMIN.

PRINCIPAL ENGINEER

STREET SERVICES

CITY ENGINEER CITY ENGINEER STREET SERVICES DATE / JUL PARKS DEPARTMENT

MAIN BREAKER: 400A.

BUS SIZE

COPPER: 400A.

SCA: 22 KAIC

MOUNT: SURFACE

ENTRY: BOTTOM

720

4424 3304

5200

5200

5200

5200

40824 39704 340 331

ACTUAL AMPS

1342

(N) PANEL "MPA"			MA			400A				22 KAI	
VOLTAGE 208/120V-4-WIRE					IS SIZE					PEDES	
LOCATION: ELEC. ROOM			<del>,</del>			400A	<del> </del>	<del>ب بند</del>		вотто	<del></del>
DESCRIPTION	- <del></del>	BKR		LTS	REC	MSC	MTR	A-VA	B-VA	C-VA	AMPS
PATHWAY LIGHTS (10TH-9TH)	1_	20	2	7				854		7	
W/CKT. 1	3	<u> </u>	上		ļ				854		
AREA POLE LTS (10TH-9TH)	5	20	2	7	<u> </u>				,	854	
W/CKT, 5	7		_					854		-	
ACC./BOLLARDS (10TH-9TH)	9	20	1	31					1053		
ACC./BOLLARDS (10TH-9TH)	11	20	1	17						1275	
KIOSK (10TH STREET)	13	20	1			1		1200			
PLANTER REC'S (10TH-9TH)	15	20	1		4				720		
PLANTER REC'S (10TH-9TH)	17	20	1		4					720	
PLANTER REC'S (10TH-9TH)	19	20	1		4			720			
PLANTER REC'S (10TH-9TH)	21	20	1		4				720		
PUBLIC COURT POWER	23	20	1		4					720	
LIGHTING CONTROL CIRCUIT	25	20	1			5		600		1	
SPARE	27	20	1								
SPARE	29	20	1								
SPARE	31	20	1						]	1	
SPARE	33	20	1							]	
SPARE		20	1		<del> </del>						
IRRIGATION CONTROLLER	37	20	1			1		600	1	L	
SP. EVENT REC'S (10TH-9TH)	39	70	2		1	'		000	5200	1	
W/CKT. 39	41					<b>-</b>			0200	5200	<b>-</b>
11/0/(1. 00	+		L	CI ID.	TOTAL	VOLT/	A MADC:	4828	8547	8769	-
(E) CLOCK TOWER	2	20	1	306	TOTAL	V OL III	AIVIFO.	1000	0047	0/00	
SP. EVENT REC'S (10TH-9TH)	4	70	2	<b> </b>	1			1000	5200	1	
W/CKT. 4	6	10	2	<u> </u>					3200	5200	ļ
SP. EVENT REC'S (10TH-9TH)	8	70	2	ļ	4			5200	1	5200	
W/CKT. 8	10	170	<del>  _</del> _		1			5200	5000	1	
		70		<u> </u>	4				5200	5000	
SP. EVENT REC'S (10TH-9TH) W/CKT. 12	12	70	2	-	1			5000	1	5200	ļ
	14	70		ļ				5200	5000	1	
SP. EVENT REC'S (10TH-9TH)	16	70	2		1				5200	5000	
W/CKT, 16	18								1	5200	
SP. EVENT REC'S (10TH-9TH)	20	70	2		1			5200		1	
W/CKT, 20	22								5200		
SP. EVENT REC'S (10TH-9TH)		70	2		1				1	5200	
W/CKT. 24	26							5200		,	
SP. EVENT REC'S (10TH-9TH)	28	70	2		1				5200		
W/CKT, 28	30		_							5200	
SP. EVENT REC'S (10TH-9TH)	32	70	2		1			5200			
W/CKT. 32	34		_						5200		
SP. EVENT REC'S (10TH-9TH)	36	70	2		- 1					5200	
W/CKT. 36	38							5200			
SP. EVENT REC'S (10TH-9TH)	40	70	2		1				5200		
W/CKT. 40	42		_							5200	
			, , , , , , ,	SUB	TOTAL	VOLT/	AMPS:	32200	36400	36400	
CONNECTED: 127144	VA				TOTAL	VOLT/	AMPS:	37028	44947	45169	1
25% OF MTR:	VA							309	375	376	1
	VA							<u> </u>	-	<del></del>	4

						400A	· ·		had 111.V1.	ROHO	
	CKT	BKR	Р	LTS	REC	MSC	MTR	A-VA	B-VA	C-VA	AMF
PATHWAY LIGHTS (9TH-UNIV)	1	20	2	11				1159			
	3								1159		
4	5	20	2	7						854	
W/CKT. 5	7	mests sir an						854			
•	9	20	1	21					1104		
· · · · · · · · · · · · · · · · · · ·	11	20	1			1				1200	
	13	20	1			1		1500			
PLANTER REC'S (9TH-UNIV)	15	20	1		4				720		
	17	20	1		5					900	
PLANTER REC'S (9TH-UNIV)	19	20	1		4			720			
	21	20	1		4				720		
	23	20	1		5					900	
	25	20	1		5			900			
	27	20	1		6				1080		
BENCH REC'S (9TH-UNIV)	29	20	1		4					720	
	31	20	1			5		600			
in the first of th	33	20	1								
SPARE	35	20	1								
SPARE	37	20	1								
SPARE	39	20	1								
SPARE	41	20	1								
				SUB :	TOTAL	VOLT/	AMPS:	5733	4783	4574	
SPARE	2	20	1								
SPARE	4	20	1								
SPARE	6	20	1								
SPARE	8	20	1								
	10	20	1								
SP. EVENT REC'S (9TH-UNIV)	12	70	2		1					5200	
4	14							5200			
	16	70	2		1				5200		
W/CKT. 16	18									5200	
SP. EVENT REC'S (9TH-UNIV)	20	70	2		1			5200			
	22								5200		
SP. EVENT REC'S (9TH-UNIV)	24	70	2		1					5200	
	26							5200			
SP. EVENT REC'S (9TH-UNIV)	28	70	2		1				5200		
W/CKT. 28	30									5200	
SP. EVENT REC'S (9TH-UNIV)	32	70	2		1			5200			
W/CKT. 32	34								5200		
SP. EVENT REC'S (9TH-UNIV)	36	70	2		1					5200	
W/CKT. 36	38							5200			
SP. EVENT REC'S (9TH-UNIV)	40	70	2		1				5200		
W/CKT. 40	42									5200	
				SUB :	TOTAL	VOLT/	AMPS:	26000	26000	31200	
CONNECTED: 98290	VA			-	TOTAL	VOLT/	AMPS:	31733	30783	35774	
25% OF MTR:	VA				OTAL A				257	298	1
25% OF LCL: 1582.5	VΔ								<del>en er en en</del>	<del></del>	•

MAIN BREAKER: 400A.

**BUS SIZE** 

COPPER: 400A.

PLANTER REC'S (9TH-UNIV)	15	20	1		4			720		PLANTER REC'S (UNIV-MISS)   15   20   1   4	720
PLANTER REC'S (9TH-UNIV)	17	20	1		5				900	PLANTER REC'S (UNIV-MISS) 17 20 1 3	
PLANTER REC'S (9TH-UNIV)	19	20	1		4		720	]		PLANTER REC'S (UNIV-MISS) 19 20 1 3 540	_
PLANTER REC'S (9TH-UNIV)	21	20	1		4			720		PLANTER REC'S (UNIV-MISS) 21 20 1 3	540
PLANTER REC'S (9TH-UNIV)	23	20	1		5				900	PLANTER REC'S (UNIV-MISS) 23 20 1 4	
PLANTER REC'S (9TH-UNIV)	25	20	1		5		900			PLANTER REC'S (UNIV-MISS) 25 20 1 3 540	-
BENCH REC'S (9TH-UNIV)	27	20	1		6			1080		BENCH REC'S (UNIV-MISS) 27 20 1 4	720
BENCH REC'S (9TH-UNIV)	29	20	1		4		1		720	LIGHTING CONTROL CIRCUIT 29 20 1 5	
LIGHTING CONTROL CIRCUIT	31	20	1		<del>,</del>	5	600			SPARE 31 20 1	-
SPARE	33	20	1		<del></del>					SPARE 33 20 1	
SPARE	35	20	1		***************************************					SPARE 35 20 1	
SPARE	37	20	1							SPARE 37 20 1	
SPARE	39	20	1							SPARE 39 20 1	
SPARE	41	20	1				7			SPARE 41 20 1	
		***************************************	نجينينين -	SUB T	DTAL	VOLT/AMPS	5: 5733	4783	4574	SUB TOTAL VOLT/AMPS: 3866	4424 3
SPARE	2	20	1							SPARE 2 20 1	
SPARE	4	20	1							SP. EVENT REC'S (UNIV-MISS 4 70 2 1	5200
SPARE	6	20	1					1		W/CKT. 4   6	!
SPARE	8	20	1							SP. EVENT REC'S (UNIV-MISS 8 70 2 1 5200	
SPARE	10	20	1							W/CKT. 8 10 !	5200
SP. EVENT REC'S (9TH-UNIV)	12	70	2		1				5200	SP. EVENT REC'S (UNIV-MISS 12 70 2 1	1
W/CKT. 12	14						5200			W/CKT. 12 14 5200	
SP. EVENT REC'S (9TH-UNIV)	16	70	2		1			5200		SP. EVENT REC'S (UNIV-MISS 16 70 2 1 1	5200
W/CKT. 16	18							·	5200	W/CKT. 16   18	
SP. EVENT REC'S (9TH-UNIV)	20	70	2		1		5200	]		SP. EVENT REC'S (UNIV-MISS 20 70 2 1 5200	
W/CKT. 20	22							5200			5200
SP. EVENT REC'S (9TH-UNIV)	24	70	2		1			<u> </u>	5200	SP. EVENT REC'S (UNIV-MISS 24 70 2 1	1
N/CKT. 24	26						5200	]		W/CKT. 24 26 5200	
SP. EVENT REC'S (9TH-UNIV)	28	70	2		1			5200		SP. EVENT REC'S (UNIV-MISS 28 70 2 1	5200
W/CKT. 28	30						100	<b>L</b>	5200	W/CKT. 28 30	5
SP. EVENT REC'S (9TH-UNIV)	32	70	2		1		5200	]		SP. EVENT REC'S (UNIV-MISS 32 70 2 1 5200	
N/CKT. 32	34							5200	1	W/CKT. 32 34 !	5200
SP. EVENT REC'S (9TH-UNIV)	36	70	2		1		1		5200	SP. EVENT REC'S (UNIV-MISS 36 70 2 1	į
W/CKT. 36	38						5200	]		W/CKT. 36 38 5200	-
SP. EVENT REC'S (9TH-UNIV)	40	70	2		1			5200		SP. EVENT REC'S (UNIV-MISS 40 70 2 1 1	5200
N/CKT. 40	42						1		5200	W/CKT. 40 42	5
		<u> </u>	سبينة		DTAL	VOLT/AMPS	26000	26000	<del></del>		36400 3
CONNECTED: 98290	VA					VOLT/AMPS				l la companya di la c	10824 3
25% OF MTR:	VA					MPS/PHASE		257	298		340
25% OF LCL: 1582.5							<u> </u>	<u> </u>		25% OF LCL: 1668.5 VA	
CALCULATED: 99873		=	27	7.22	AMPS	2	272.83	ACTUAL	. AMPS		CTUAL AN

(N) PANEL "MPC"

VOLTAGE: 208/120V-4-WIRE

W/CKT. 1 3 --- -- AREA POLE LTS (UNIV-MISS) 5 20 2 2

W/CKT. 5 7 --- --- ACC./BOLLARDS (UNIV-MISS) 9 20 1 80 EXISTING STATUE LIGHTING 11 20 1 EXISTING STATUE LIGHTING 13 20 1 PLANTER REC'S (UNIV-MISS) 15 20 1 4

LOCATION: ELEC. ROOM

SCA: 22 KAIC

MOUNT: PEDESTAL

ENTRY: BOTTOM

(N) PANEL "MPD"			MA	IN BRE	EAKER:	400A	i.		SCA:	22 KAI	C
VOLTAGE: 208/120V-4-WIRE				BU	IS SIZE					SURFA	
LOCATION: ELEC. ROOM					PPER:	400A	١,		ENTRY:	вотто	M
DESCRIPTION		BKR		LTS	REC	MSC	MTR	A-VA	B-VA	C-VA	AMPS
PATHWAY LIGHTS (MISS-6TH)	1	20	2	12				1281			
W/CKT. 1	3								1281		
ACC./BOLLARDS (MISS-6TH)	5	20	1	20						1036	
KIOSK (MISS)	7	20	1			1		1200			
LIGHTING CONTROL CIRCUIT	9	20	1			5			600		
PLANTER REC'S (MISS-6TH)	11	20	1		4			1		720	
PLANTER REC'S (MISS-6TH)	13	20	1		3			540			
PLANTER REC'S (MISS-6TH)	15	20	1		4				720		
PLANTER REC'S (MISS-6TH)	17	20	1		4					720	
PLANTER REC'S (MISS-6TH)	19	20	1		3		-	540	]	1	
PLANTER REC'S (MISS-6TH)	21	20	1		4				720	]	
BENCH REC'S (MISS-6TH)	23	20	1	<u> </u>	5	1	<b> </b>			900	
SPARE	25	20	1	<del>                                     </del>					1	L	
SPARE	27	20	1	<b>†</b>	<b>†</b>	<b>†</b>					
SPARE	29	20	1			$\vdash$					1
SPARE	31	20	1		$\vdash$	$\vdash$	f		1	L	
SPARE		20	1		<b>-</b>		<del> </del>			]	
SP. EVENT REC'S (MISS-6TH)	35	70	2		1		-		L	5200	1
W/CKT. 35	37			-	<u> </u>	<del> </del>		5200	]	0230	
FOUNTAIN (MISS-6TH)	39	40	2	<del> </del>		1		0200	2912	1	<b>-</b>
W/CKT. 39	41			-	<del> </del>	<del>  '</del> -			2012	2912	<del>                                     </del>
VV/OIX1. 33	71	L	L	SI IB	TOTAL	VOLT	L AMPS:	8761	6233	11488	<b>-</b>
SPARE	2	20	1	300	TOTAL	T CET	AWI O.	0701	0200	11400	
SP. EVENT REC'S (MISS-6TH)	4		2		1				5200	1	
W/CKT. 4	6	70	_		<del>  '</del> -				3200	5200	
	8	70	2		1			5200	1	3200	<b>-</b>
W/CKT. 8	10	10	_		<del>  '</del> -	-	<b>-</b>	3200	5200	1	
SP. EVENT REC'S (MISS-6TH)		70	2	<b></b>	1				3200	5200	ļ
W/CKT. 12	14	70	_	<b></b>	<del>                                     </del>			5200	1	1 3200	-
SP. EVENT REC'S (MISS-6TH)	tania and	70	2		1	-		3200	5200	1	
terior in contrata de la contrata d		70	4						3200	5000	
W/CKT. 16 SP. EVENT REC'S (MISS-6TH)	18	70	_		-			5000	1	5200	
	20	70	2		1			5200	E000	1	
W/CKT. 20	22	70	=		<b> </b>				5200	5000	ļ
		70	2	ļ	1			5000	1	5200	
W/CKT. 24	26		_					5200	5000	1	
		70	2		1				5200		
W/CKT. 28	30								1	5200	
SP. EVENT REC'S (MISS-6TH)		70	2		1			5200		1	
W/CKT. 32	34								5200		
SP. EVENT REC'S (MISS-6TH)		70	2		1				1	5200	
W/CKT. 36	38							5200		1	
SP. EVENT REC'S (MISS-6TH)		70	2		1				5200		
W/CKT. 40	42									5200	
								31200	36400	36400	1
CONNECTED: 130482	VA			•	TOTAL	VOLT/	AMPS:	39961	42633	47888	]
25% OF MTR:	VA			To	OTAL A	MPS/F	HASE:	333	355	399	ŀ
25% OF LCL: 1199.5	VA										-
CALCULATED: 131682	VA	=	36	5.51	AMPS		36	32.18	ACTUAL	AMPS	

(N) PANEL "MPE"			M	(IN BRI	EAKER:	400A	١.		SCA:	22 KAI	2
VOLTAGE: 208/120V-4-WIRE				BU	JS SIZE					SURFA	
LOCATION: ELEC. ROOM				CC	PPER:	400A	١.	***************************************	ENTRY:	вотто	M
DESCRIPTION	CKT	BKR	Р	LTS	REC	MSC	MTR	A-VA	B-VA	C-VA	AMPS
ACC./BOLLARDS (6TH-5TH)	1	20	1	14				1244		-	
ACC./BOLLARDS (6TH-5TH)	3	20	1	14					1244		
PLANTER REC'S (6TH-5TH)	5	20	1		5				-	900	
PLANTER REC'S (6TH-5TH)	7	20	1		5			900		_	
PLANTER REC'S (6TH-5TH)	9	20	1		5				900		
PLANTER REC'S (6TH-5TH)	11	20	1		5					900	
PLANTER REC'S (6TH-5TH)	13	20	1		5			900			
PLANTER REC'S (6TH-5TH)	15	20	1		5				900		
PLANTER REC'S (6TH-5TH)	17	20	1		5					900	
PLANTER REC'S (6TH-5TH)	19	20	1		5			900			
IGHTING CONTROL CIRCUIT	21	20	1			5			600		
SPARE	23	20	1								
SPARE	25	20	1			<b>T</b>				•	
SPARE	27	20	1	T	1	<b>T</b>	<b>†</b>				
SPARE	29	20	1	<del>                                     </del>							
SPARE	31	20	1			t			]	L	
SPARE	33	20	1		<b>†</b>	†				1	
SPARE	35	20	1	<del>                                     </del>	<del>                                     </del>	<u> </u>	<del> </del>				<b></b>
SPARE	37	20	1	-	<del> </del>	<b>-</b>	<del> </del>		]		
SP. EVENT REC'S (MISS-6TH)	39	70	2	1-	1	I	$\vdash$		5200	1	
W/CKT. 39	41		_	<del> </del>	<del>                                     </del>	<del> </del>			0200	5200	-
7,7,51(1). 60		L	L	SUB	TOTAL	VOLT/	A MPS:	3944	8844	7900	
SPARE	2	20	1	300	TOTAL	T	Aivir G.	0011	0011	7300	-
SP. EVENT REC'S (MISS-6TH)	4	70	2	-	1	<del> </del>	<u> </u>		5200	1	
N/CKT. 4	6	70	_	├	┼	╁	<b>-</b>		3200	5200	
		70	2	<del> </del>	1	<del> </del>		5200	1	5200	
SP. EVENT REC'S (MISS-6TH)	8	70	2			<del> </del>	ļ	5200	5000	1	
N/CKT. 8	10	70	_		1	<del> </del>			5200	5000	<b></b>
SP. EVENT REC'S (6TH-5TH)	12	70	2	<b> </b>	1	<u> </u>	ļ	5000	1	5200	ļ
W/CKT. 12	14		_		<u> </u>	ļ		5200	5000	1	
SP. EVENT REC'S (6TH-5TH)	16	70	2		1	<u> </u>			5200		ļ
N/CKT. 16	18				ļ	ļ			1	5200	ļ
SP. EVENT REC'S (6TH-5TH)		70	2		1			5200		1	
N/CKT. 20	22		_						5200		
SP. EVENT REC'S (6TH-5TH)	24	70	2		1	ļ			1	5200	
N/CKT. 24	26							5200			
SP. EVENT REC'S (6TH-5TH)	28	70	2		1	<u> </u>			5200		
N/CKT. 28	30									5200	
SP. EVENT REC'S (6TH-5TH)	32	70	2		1			5200		_	
N/CKT. 32	34								5200		
SP. EVENT REC'S (6TH-5TH)	36	70	2		1					5200	
W/CKT. 36	38							5200			
SP. EVENT REC'S (6TH-5TH)	40	70	2		1				5200		
N/CKT. 40	42									5200	
	Kanininana	أسيسسينا	بندست	SUB	TOTAL	VOLT/	AMPS:	31200	36400	36400	
CONNECTED: 124688	VA					VOLT/			45244	44300	1
25% OF MTR:	VΑ					AMPS/F			377	369	
25% OF LCL: 622				•				<u> </u>	l	I	1
CALCULATED: 125310		_	2/	17 02	A NAMES		2	16.10	ACTUAL	A BADO	

# "MPA" THRU "MPE" PANEL SCHEDULES

* - THE CONTRACTOR SHALL RECONNECT ALL EXISTING CIRCUITS THAT ARE TO REMAIN

THE LOADS ON THE NEW PANEL DIRECTORY.

FROM THE REMOVED METER PEDESTAL TO THE NEW METER PEDESTAL AND INDICATE







(N) PANEL "MPB"

VOLTAGE 208/120V-4-WIRE

LOCATION: ELEC. ROOM

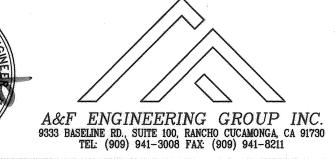

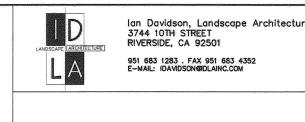



S THE PROPERTY OF THE PROPERTY	LANDSCAR DAVIDSON A	K NACHITE
RE _	Signature	_  잌
<b> </b>	6/30/09 Exp. Date	-   *
STATE	OF CALIF	ORMIN

4	RE-NUMBERED	SHEET AFD	12.4.0	CITY OF	RIV	/ER	SIDE, CALIFORNIA
	/						KS DEPARTMENT
			1	APPROVED BY	BY	DATE	APPROVED BY
				CONST. CONTRACT ADMIN. PRINCIPAL ENGINEER	77	1375° Wules	or glange
				STREET SERVICES		, , , ,	CITY ENGINEER
MARK	REVISIONS	APPF	R. DATE	SURVEYOR TRAFFIC DIVISION			mlela
DESIGN	IED BY MWK DRAWN BY N	MWK CHECKED BY	RES	PARKS DEPARTMENT			DATE / CJ(O)

DOWNTOWN MALL LANDSCAPE PLANS

12-3-2007 ELECTRICAL PLAN

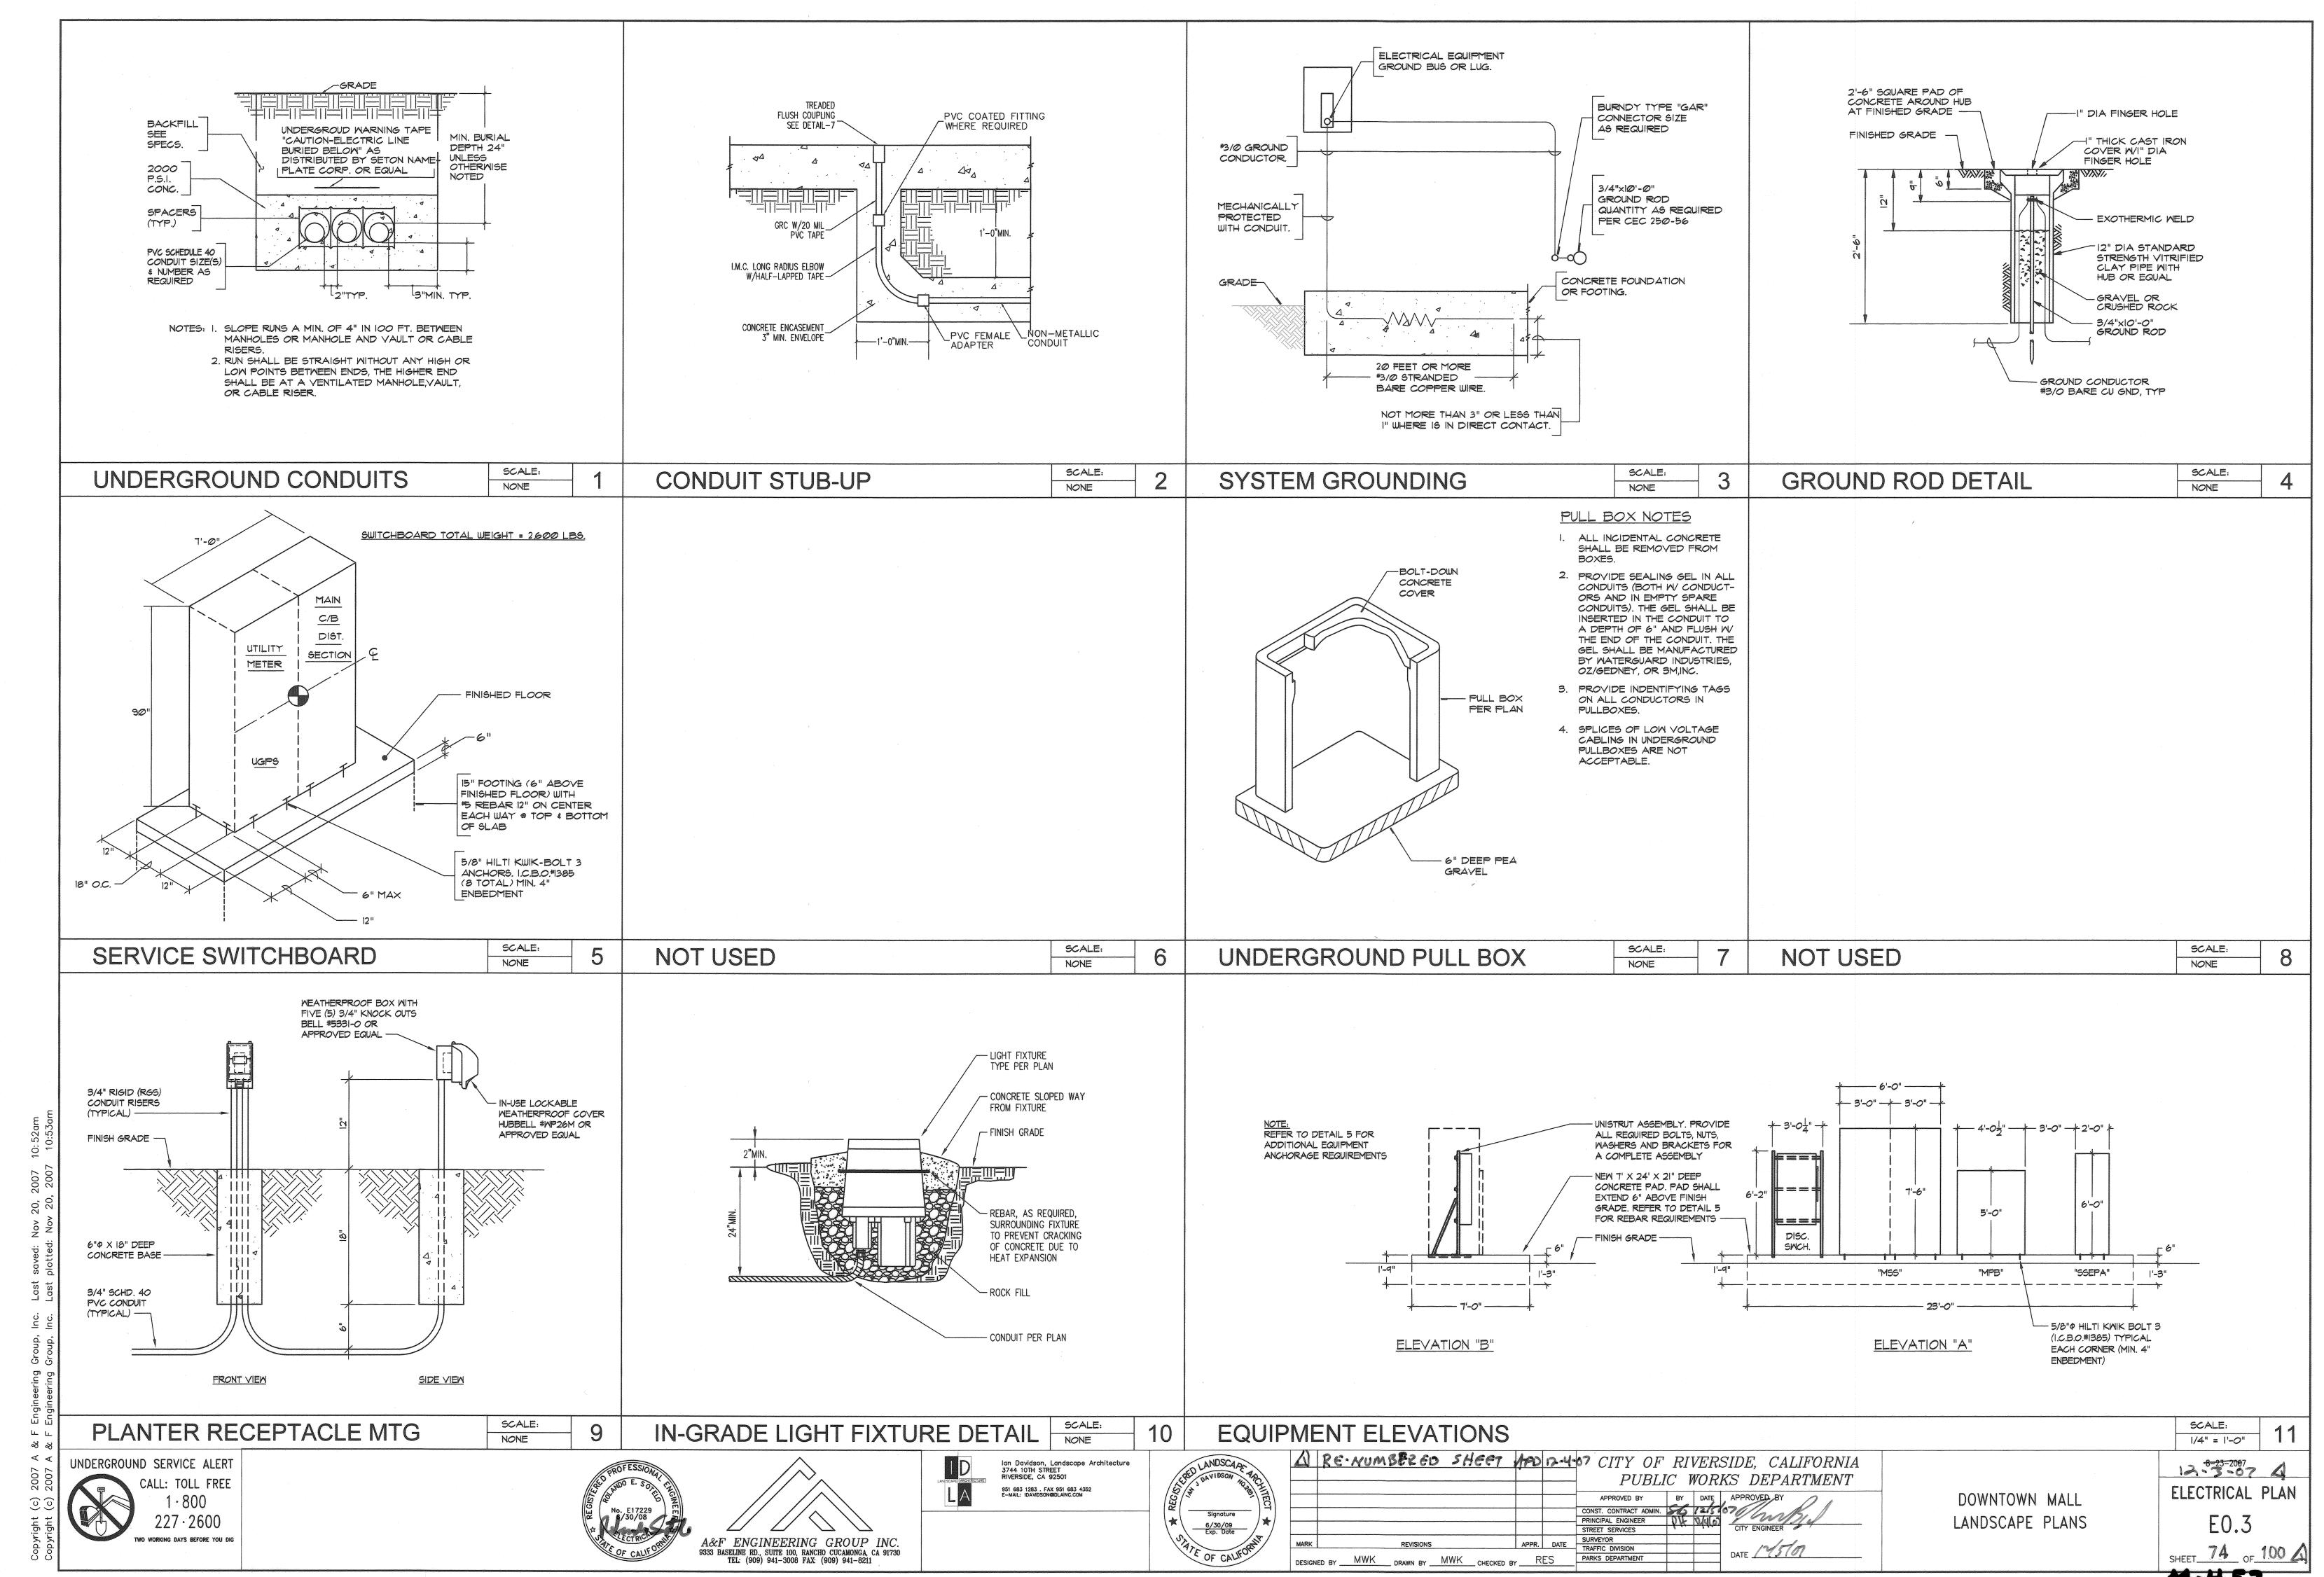

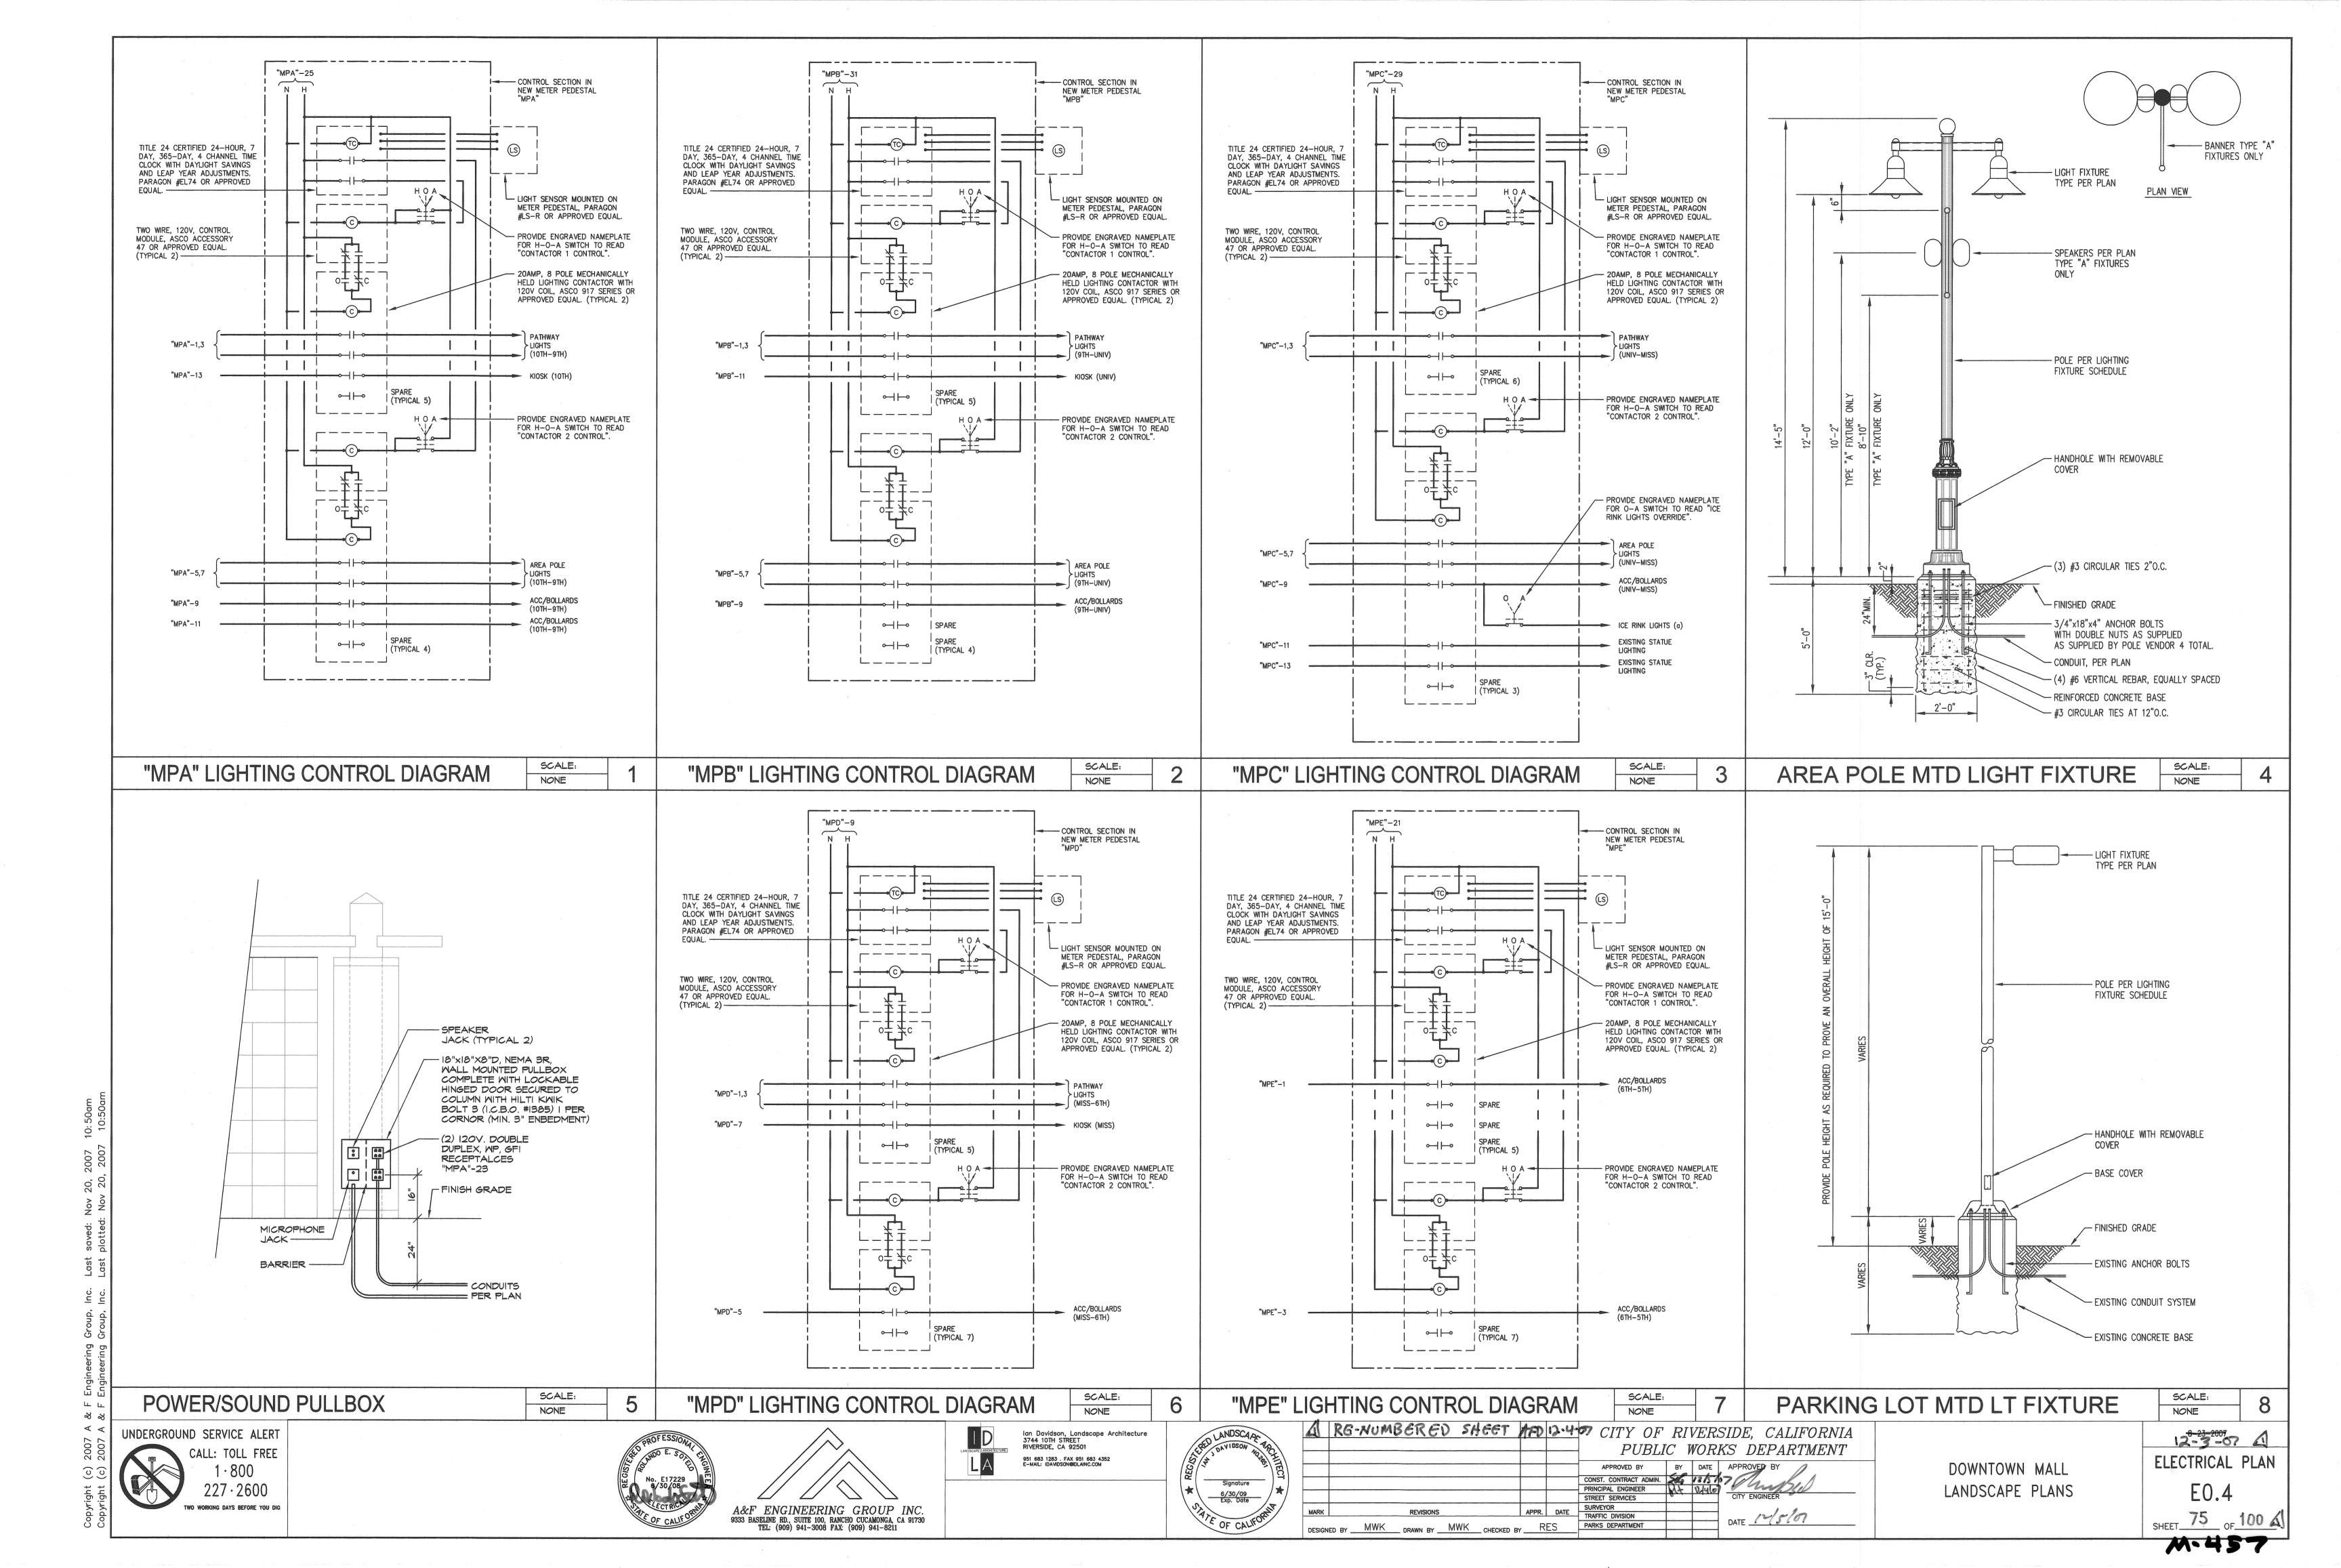


CERTIFICATE			7,	Part 1 of 2)	
PROJECT NAME				DA	ΤΕ
Downtow	n Mall		Marketon - 200 annua - 200 annua - 200 annua		7/6/2007
PROJECT ADDRESS Riversio	40			lг	
PRINCIPAL DESIGNER - LIGH			TELEPHONE	T	Building Permit#
Rolando			909-941	1-3008 Г	<del></del>
OCUMENTATION AUTHOR	·		TELEPHONE		Checked by/Date
	ineering Group, Inc.		(909) 94	1 2000	Enforcement Agency L
SENERAL INFORMATIC					
ATE OF PLANS	OUTDOOR LIGHTIN	G ZONE LZ1 LZ2	X LZ3	LZ4	
UNCTION TYPE	OUTDOOR LIGHTING	OUTDOOR SIGNS	3	☐ INDOOR SIG	NS
PHASE OF CONSTRUCTION	☐ NEW CONSTRUCTION	ADDITION	<del></del>	X ALTERATION	٧
STATEMENT OF COMP	LIANCE				
California Code of Regulation This certificate applies only	to building lighting requirem	ients.			ts 1 and 6 of the
DOCUMENTATION AUTHOR	er hereby certifies that the d	SIGNATURE	ite and complete	9.	DATE /
Luis F	Flores	SIGNATURE C	S. 35 /		man
construction documents is calculations submitted with	consistent with the other co this permit application. The	proposed building has	orksheets, with t s been designed	he specifications	and with any oth
construction documents is a calculations submitted with contained in Sections 110,  Please Check One: (These I hereby affirm that I are document as the person electrical engineer, I affirm that I am eligib 6737.3 to sign this document.)  I affirm that I am eligib because it pertains to a Sections 5537, 5538 a	consistent with the other co this permit application. The 119, 130 through 132, and e sections of the Business and eligible under the provision responsible for its prepar or I am a licensed architect. He under the provisions of Deument as the person responder the exemption to E a structure or type of work on 6737.1.  NER - NAME	mpliance forms and we proposed building has 146, and 149 of Title 24 and Professions Code ons of Division 3 of the ation; and that I am lice with the properties of the Busine insible for its preparation.	orksheets, with the speed designed of the speed designed of the speed in the State of the speed in the speed	the specifications, to meet the light to meet the light II in the Nonreside Professions Code ate of California at the Code by Sector a licensed controls Code to sign	and with any othing requirements ential Manual.) to sign this s a civil engineer ion 5537.2 or actor performing this document
construction documents is a calculations submitted with contained in Sections 110,  Please Check One: (These Interest of the Contained in Sections 110,  I hereby affirm that I am document as the person electrical engineer, or electrical engineer,	consistent with the other co this permit application. The 119, 130 through 132, and e sections of the Business and eligible under the provision responsible for its prepar or I am a licensed architect. He under the provisions of Dament as the person responsible to the under the provisions of Dament as the person responsible under the exemption to Date a structure or type of work on 6737.1.  NER - NAME  E. Sotelo  E FORMS & WORKSHEE mpliance. Required on plans for all the project consists solely of if the project consists of independent of the project consists of our control of the project consists of the control of the project consists of the project consists of the control of the control of the project consists	mpliance forms and we proposed building has 146, and 149 of Title 24 and Professions Code ons of Division 3 of the ation; and that I am lie division 3 of the Busine insible for its preparation.  Division 3 of the Busine described as exempt professional security of the Busine described as exempt professional s	orksheets, with the been designed, Part 6.  are printed in full Business and Profession; and that I arm as an arm as a manner of the I arm as a man	the specifications, to meet the light professions Code ate of California a constant constant professions Code to sign less and Professions Code to sign le	and with any othing requirements ential Manual.) to sign this is a civil engineer actor performing this document ons Code
construction documents is a calculations submitted with contained in Sections 110,  Please Check One: (These I hereby affirm that I an document as the person electrical engineer, I affirm that I am eligib 6737.3 to sign this doc this work.  I affirm that I am eligib 6737.3 to sign this doc this work.  I affirm that I am eligib because it pertains to a Sections 5537, 5538 a PRINCIPAL LIGHTING DESIG Rolando  LIGHTING COMPLIANCI  ZOLTG-1-C: Certificate of Cor Either LTG-1-C 1. Use LTG-1. 2. Use LTG-1. 3. Use OLTG-4. Use OLTG-4. Use OLTG-4. Use OLTG-4. Use OLTG-4.	consistent with the other co this permit application. The 119, 130 through 132, and a sections of the Business and eligible under the provision responsible for its prepar or I am a licensed architect. It was a fixed the person responsible for its prepar or I am a licensed architect. It was the person responsible to the under the provisions of Eument as the person responsible under the exemption to E a structure or type of work on 6737.1.  NER - NAME  E. Sotelo  E FORMS & WORKSHEE mpliance. Required on plans for all or OLTG-1-C may be used for C if the project consists of independent of the project consists of independent of the project consists of out MPLIANCE SUMMARY. Applications and the project consists of out MPLIANCE SUMMARY.	mpliance forms and we proposed building has 146, and 149 of Title 24 and Professions Code ons of Division 3 of the ation; and that I am lice division 3 of the Busine insible for its preparation. Division 3 of the Busine insible for its preparation. Division 3 of the Busine insible for its preparation. Division 3 of the Busine insible for its preparation. Division 3 of the Busine insible for its preparation. Division 3 of the Busine insible for its preparation. Division 3 of the Busine insible for its preparation. Division 3 of the Busine insible insibl	orksheets, with the been designed, Part 6.  are printed in full Business and Pensed in the States and Profession; and that I am assume to Business and Profession; and that I am assume to Business and Profession; and that I am assume to Business and Profession; and that I am assume to Business and Profession; and that I am assume to Business and Profession; and that I am assume to Business and Profession; and that I am assume to Business and Profession; and that I am assume to Business and Profession; and that I am assume to Business and Profession; and the I am assume to Business and Profession; and that I am assume to Business and Profession; and that I am assume to Business and Profession; and that I am assume to Business and Profession; and that I am assume to Business and Profession; and that I am assume to Business and Profession; and that I am assume to Business and Profession; and that I am assume to Business and Profession; and that I am assume to Business and Profession; and that I am assume to Business and Profession; and that I am assume to Business and Profession; and that I am assume to Business and Profession; and that I am assume to Business and Profession; and that I am assume to Business and Profession; and that I am assume to Business and Profession; and Business and Profession; and Business and Profession; and Business a	the specifications, to meet the light professions. Code to see the a licensed control ons Code to sign less and Professional Professiona	and with any othing requirements ential Manual.) to sign this is a civil engineer actor performing this document ons Code
construction documents is a calculations submitted with contained in Sections 110,  Please Check One: (These Interest of the I	consistent with the other co this permit application. The 119, 130 through 132, and e sections of the Business and eligible under the provision responsible for its prepar or I am a licensed architect. He under the provisions of Dament as the person responsible to the under the provisions of Dament as the person responsible under the exemption to Date a structure or type of work on 6737.1.  NER - NAME  E. Sotelo  E FORMS & WORKSHEE mpliance. Required on plans for all the project consists solely of if the project consists of independent of the project consists of our control of the project consists of the control of the project consists of the project consists of the control of the control of the project consists	mpliance forms and we proposed building has 146, and 149 of Title 24 and Professions Code ons of Division 3 of the ation; and that I am lice the second of the Busine in the second of t	orksheets, with the speed designed of the speed designed of the speed in the States and Profession; and that I am assume to Business and Profession; and that I am assume to Business and Profession; and that I am assume to Business and Professions and Pro	the specifications, to meet the light professions. Code at a licensed control ons Code to sign less and Professions and Profession to the incorporated in so the other outdoor lighting allowances (Excepticulations.	and with any othing requirements ential Manual.) to sign this is a civil engineer so to sign this of a civil engineer actor performing this document ons Code  LIC. #  Chedules on the plans g.  ing. it Signs).

ROJECT NAME Downto	wn Mall		DATE 7	/6/2007
ghting Schedules or	Plans Show that	Outdoor Lighting Meets Allowed	Lighting Power	
X Lighting power allow Not Applicable	ance for general site ille	umination on OLTG-2-C Part 1 of 4		
Lighting power allow  X Not Applicable	ance for local ordinanc	es or for security multipliers on OLTG-2-C	Part 2 of 4	
X Lighting power allow Not Applicable	ances for specific appli	cations, other than vehicle service statio	ns with canopies on OLTG-2-C Pa	art 3 of 4
Lighting power allow  Not Applicable	ances for vehicle servic	ce station canopies on OLTG-2-C part 4 of	4	
X Sign lighting complia Not Applicable	nce on OLTG-4-C			
andatory Measures o	on Plans Show that	t Outdoor Liahtina Meets Outdoo	or Liahtina Controls And I	Equipment
X Installed lighting pow Not Applicable	ver has been determined	d in accordance with Section 130(c)1		
	illed luminaires with lan in sensor per Section 13	nps rated over 100 Watts either have a lai 12(a)	mp efficacy of at least 60 lumins p	oer Watt or are
	man rated areator than 1	75 Watts in hardscape area, including park	ing late building entrances, cone	nice and all
		ments of Section 132(b)	ing iots, building entrances, cano	pies, and an
Not Applicable				
X All permanently insta Not Applicable	illed outdoor lighting m	eets the control requirements of Section 1	132(c)1	
Building facades, park  X Not Applicable	king lots, garages, canop	iles, and outdoor sales areas meet the Mult	ti-Level Lighting Requirements of	Section 132(c)
ANDATORY AUTON	ATIC CONTROLS			
CONTROL LOCATION (Room #)	CONTROL IDENTIFICATION	CONTROL TYPE (Auto Time Switch, Dimming, etc.)	AREA CONTROLLED	NOTE TO FIELD
				_
11				
		14		
				$\dashv \vdash \vdash$


Project Name Downto	wn Ma	11								Da		6/2	007	7
LIGHTING POWER AL				ER	AL SITE ILLUMINATION	1-17								
	Allo B	tted W	atts D	E	Luminaire F	G	Lamp:	s/Ball	asts	к	Ins	talle M	d Wa	
A  Lighting Application Category (Table 147-A)		Alloted LPD  Wift. sq. or  Wi/LF		Code	Description	Cutoff Designation		Lamps per Luminaire	Watts per Lamp	Ballast per Luminaire	Watts per Luminaire	-	Number of Luminaires	o Installed Watts (L x N)
Pedestrian Hardscape	116,775	0.17		Α	Twin 100w Metal Halide Mag (2)		M100	2	100	1.0	244.0	х	32	7,80
				В	Twin 100w Metal Halide Mag (2)		M100	2	100	1.0	244,0	х	17	4,14
				С	100w Metal Halide		M100	1	100	1.0	110.0	х	10	1,10
				D	100w Metal Halide Mag		M100	1	100	1.0	122.0	Х	54	6,58
				Е	(1) 5w LED		LED	3	1	1.0	5.0	х	39	19
				Н	(1) 3w LED		LED	3	1	1.0	3,6	х	27	9
				ı	(1) 15w LED		LED	9	1	1.0	15,0		50	75
Automotive Hardscape	24,395	0.15	3,659	J	175w Metal Halide Mag		M175	1	175	1.0	205.0	х	3	61
				К	175w Metal Halide Mag		M175	1	175	1.0	205.0	х	8	1,64
				L	Twin 175w Metal Halide Mag		M175	2	175		410.0			41
	1				(2)			Ī	<u></u>					
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<del></del>	+							H		$\vdash$		Н	$\vdash$	
						<u> </u>	<u> </u>			Ш		Ш	Щ	
Total /	Allotted \	Vatts	23,511						Tota	l Insi	alled V	Vatt	s	23,3

roject Name Do	wntov	vn M	all								Dá	ite	7/6	5/2007	7
<u>IGHTING POWER</u>				SPE	CIFIC APPLICATIONS (T	able 1				hicle					ies
	1	tted W		_	Luminaire			nps/B	allasts		De		n Wa		
A	В	С	D >	E	<u> </u>	G	Н	НН	با	K		M	N	0	P
Lighting Application Category (Table 147-B)	Area (sq. ft.) or Length (LF)	Alloted LPD W/ft. sq. or W/LF	Allotted Watts (B x C)	Code	Description	Cutoff Designation	Lamp Type	Lamps per Luminaire	Watts per Lamp	Ballast per Luminaire	Watts per Luminaire	If CEC Default	Number of Luminaires	Installed Watts (L × N)	Allowed Watts (Min of D or O)
uilding Facade	320	0.35	112	F	(1) 15w LED		LED	9	1	1.0	15,0		5	75	
	777	0.00		<u> </u>		1		H			10,0	^`	۳	· · · ·	
	<del> </del>			-		+	<u> </u>			$\vdash$		_	$\vdash$		
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Downto	own Mall					DATE 7/	6/2007
ardscape - Method	(1)						
Hardscape for aut	omotive vehicul	ar use, inclu	ding parking	lots, drivewa	ays and site i	oads.	
Δ	В	С	D	Е	F	G	H
Lighting Application	Actual Paved Area + 5 perimeter of adjacent unpaved land, Includes planters and land. Includes planters and landscaped areas less than 10' wide that are		Areas (SF) to Su Overlapping areas	ibtract from within			
Lighting Application (Table 147-B)	enclosed by hardscape on at least 3 sides.	(If Applicable)	luminaire	Areas	other structures	(C + D + E + F)	Illuminated Are (B - G)
Automotive Hardscape	24,395	0	0	0	0	0	24,395
Hardscape for ped	lestian use, incl	С	D	Е	F	G	Н
	Actual Paved Area + 5' ounpaved land on either side of path of travel. Shall include all contiguous paved area before including adjacen	C  Area between poles or luminaires that are > 6 times the mounting height	D Areas (SF) to Su Overlapping areas	Γ	F	Sub total of areas to subtract	
A  Lighting Application	Actual Paved Area + 5' unpaved land on either side of path of travel. Shall include all contiguous paved area	C  Area between poles or luminaires that are > 6 times the mounting height distance	D Areas (SF) to Su Overlapping areas of another application or	E btract from within Building	F the Illuminated A Areas obstructed by signs or	Sub total of areas to subtract	
Lighting Application (Table 147-B)	Actual Paved Area + 5' unpaved land on either side of path of travel. Shall include all contiguous paved area before including adjacen grounds.	r Area between poles or luminaires that are > 6 times the mounting height distance (If Applicable)	D Areas (SF) to Su  Overlapping areas of another application or luminaire	E btract from within Building Areas	F  Areas obstructed by signs or other structures	Sub total of areas to subtract (C + D + E + F)	Illuminated Area (B - G)
A  Lighting Application (Table 147-B)	Actual Paved Area + 5' unpaved land on either side of path of travel. Shall include all contiguous paved area before including adjacen grounds.	r Area between poles or luminaires that are > 6 times the mounting height distance (If Applicable)	D Areas (SF) to Su  Overlapping areas of another application or luminaire	E btract from within Building Areas	F  Areas obstructed by signs or other structures	Sub total of areas to subtract (C + D + E + F)	Illuminated Are (B - G)

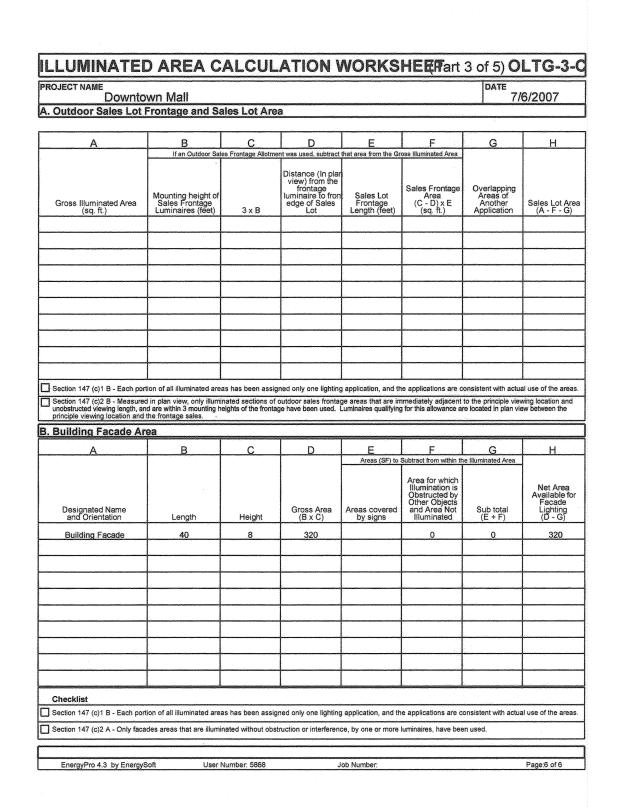


UNDERGROUND SERVICE ALERT CALL: TOLL FREE

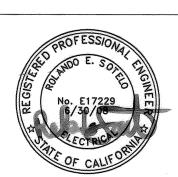

EnergyPro 4.3 by EnergySoft User Number: 5868 Job Number:



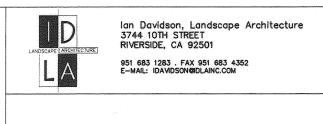




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DOWNTOWN MALL LANDSCAPE PLANS

12-03-2007 ELECTRICAL PLAN SHEET 76 OF 99

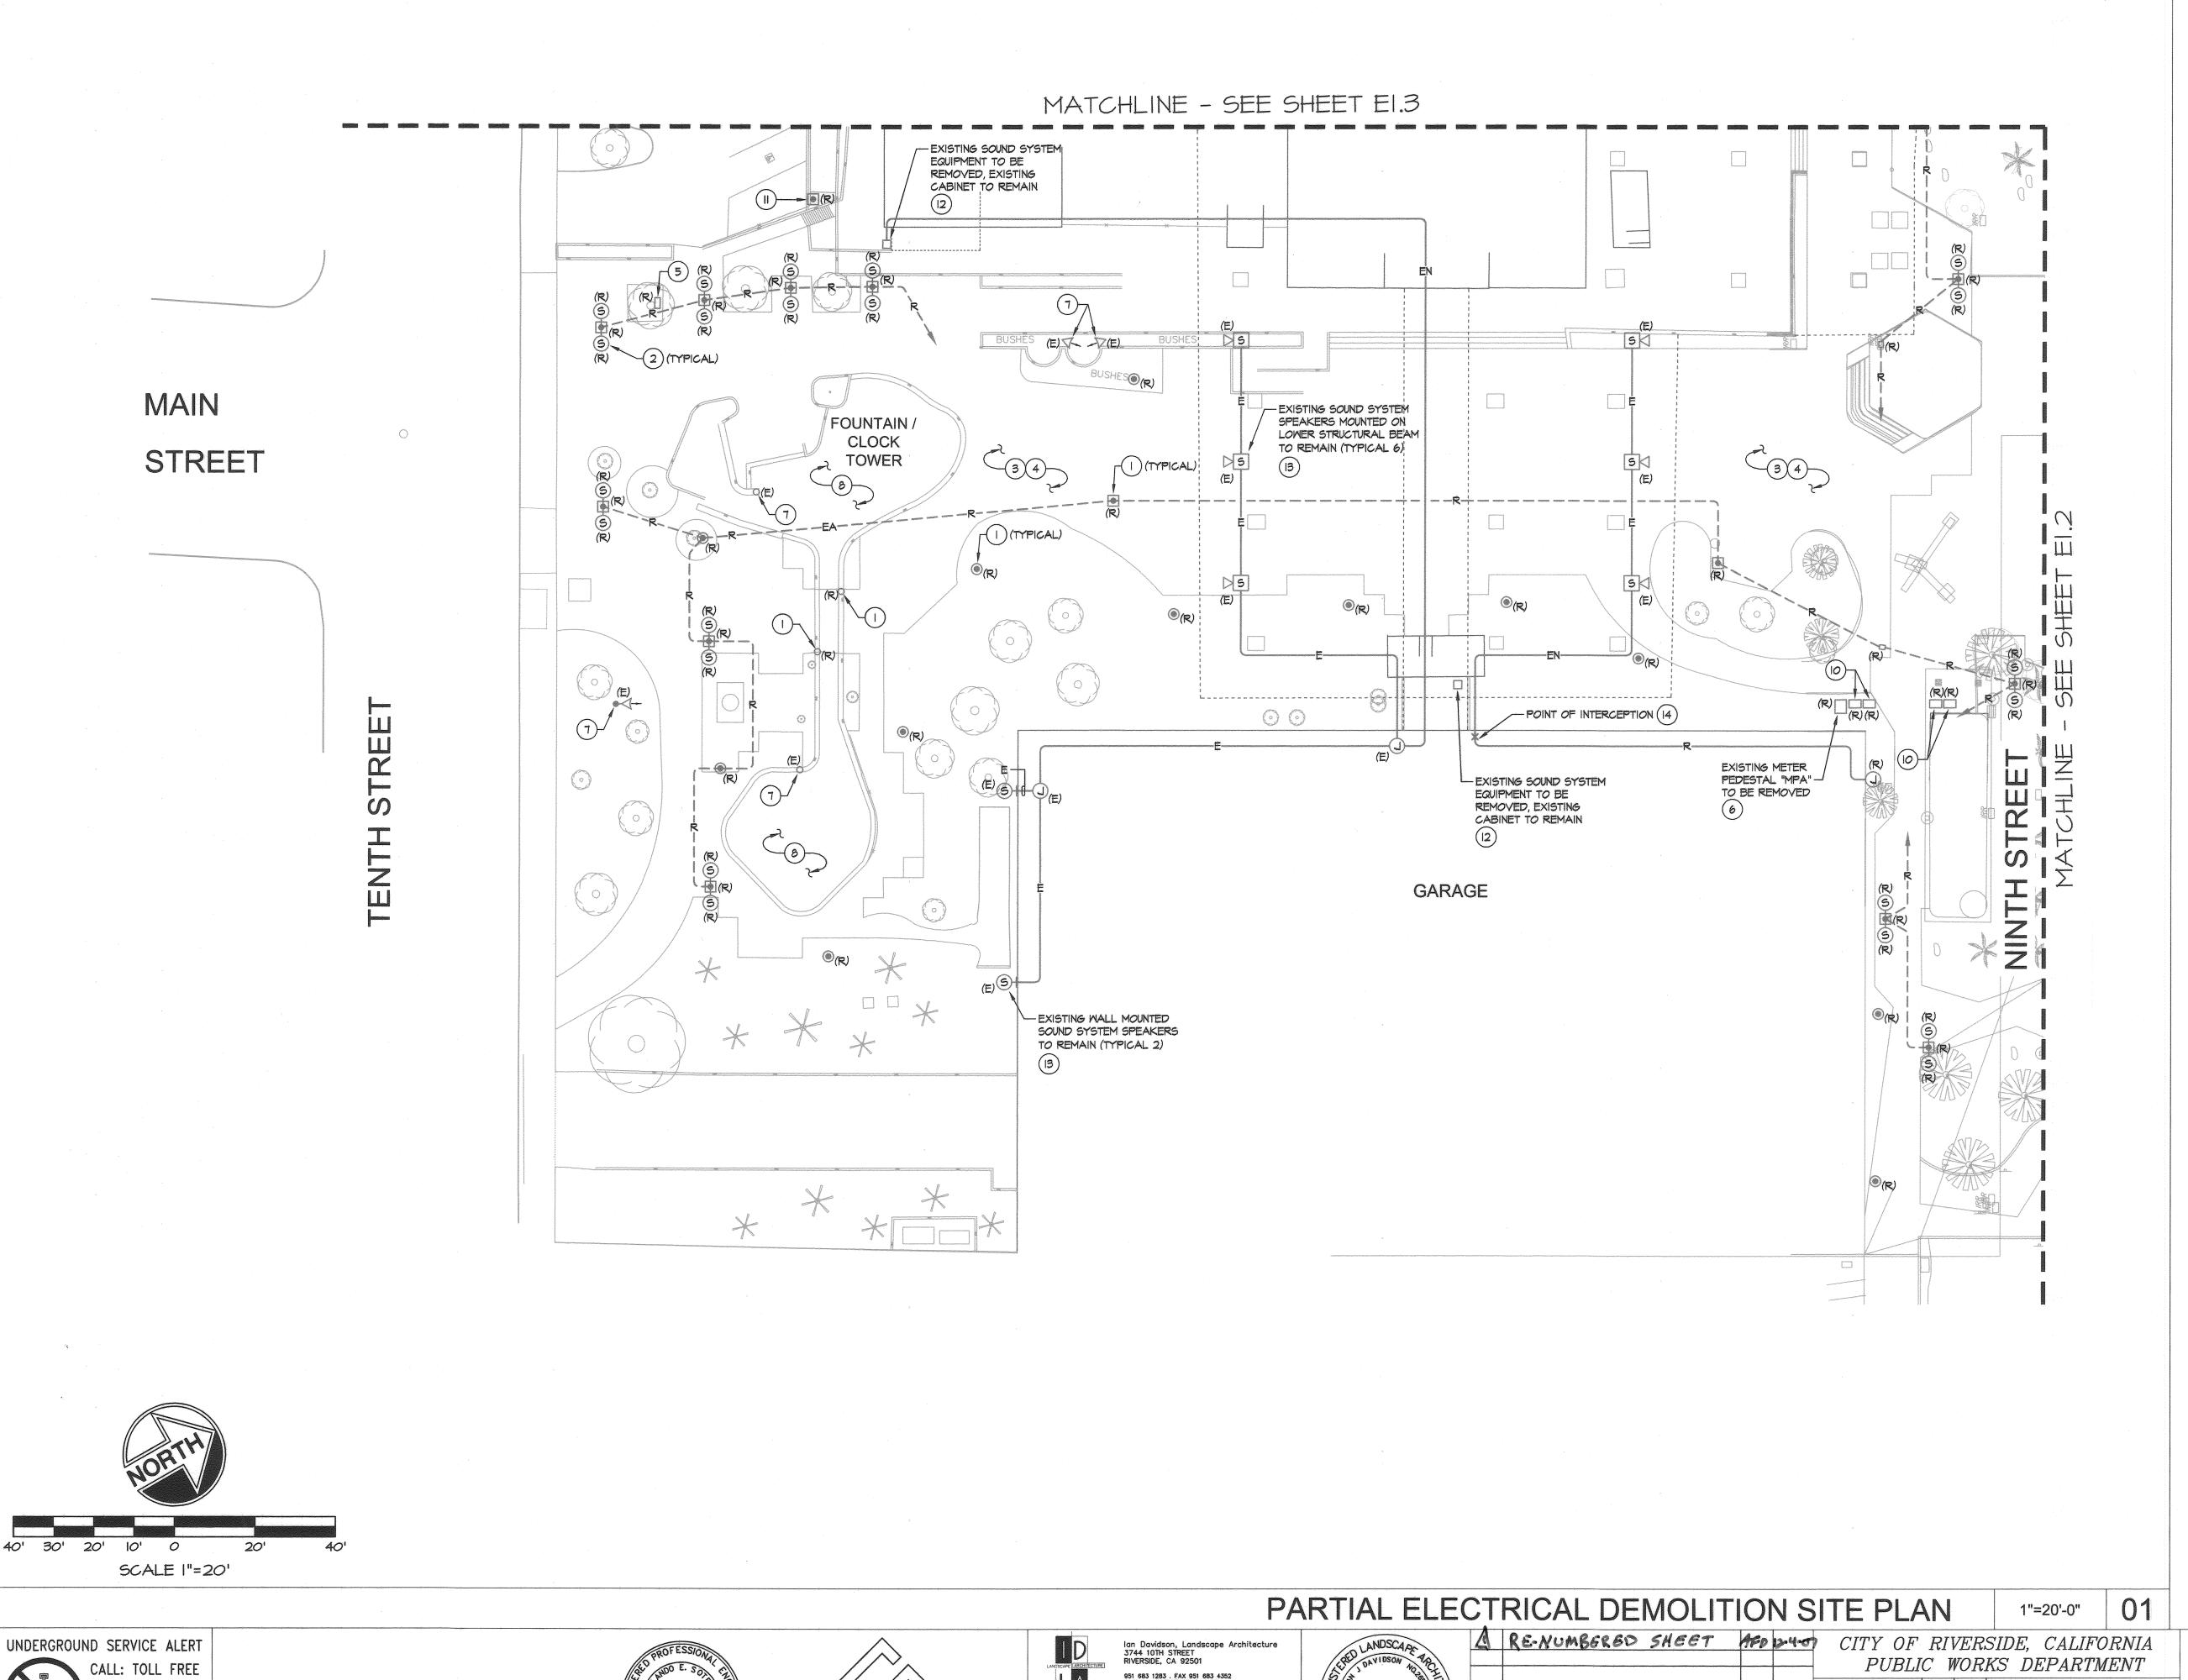

- ( I ) THE CONTRACTOR SHALL COMPLETELY DISCONNECT AND REMOVE THE EXISTING LIGHT FIXTURE, INCLUDING ALL ASSOCIATED PULL BOXES, CONDUIT AND CONDUCTORS. WHERE ITS NOT FEASIBLE AND/OR IMPOSSIBLE TO REMOVE THE EXISTING UNDERGROUND CONDUIT SYSTEM, THE CONDUIT SHALL BE ABANDONED IN PLACE AND INDICATED ON THE AS-BUILT DRAWINGS. WHERE THE EXISTING REMOVED LIGHT FIXTURE IS FEEDING AN EXISTING LIGHT FIXTURE THAT IS TO REMAIN, THE CONTRACTOR SHALL ROUTE NEW CONDUIT AND CONDUCTORS AS REQUIRED TO PROVIDE THE POWER NECESSARY TO MAINTAIN THE EXISTING LIGHT FIXTURE IN OPERATION. ALL INFORMATION SHALL BE INDICATED ON THE AS-BUILT
- (2) THE CONTRACTOR SHALL COMPLETELY DISCONNECT AND REMOVE THE EXISTING SOUND SYSTEM SPEAKERS, INCLUDING ALL ASSOCIATED PULL BOXES, CONDUIT AND CONDUCTORS. WHERE ITS NOT FEASIBLE AND/OR IMPOSSIBLE TO REMOVE THE EXISTING UNDERGROUND CONDUIT SYSTEM, THE CONDUIT SHALL BE ABANDONED IN PLACE AND INDICATED ON THE AS-BUILT DRAWINGS.
- (3) THE CONTRACTOR SHALL COMPLETELY DISCONNECT AND REMOVE ALL EXISTING MEATHERPROOF RECEPTACLES, TIME CLOCKS AND LIGHT FIXTURES MOUNTED IN THE PLANTER AREAS/TREES, INCLUDING ALL ASSOCIATED PULL BOXES, CONDUIT AND CONDUCTORS. WHERE ITS NOT FEASIBLE AND/OR IMPOSSIBLE TO REMOVE THE EXISTING UNDERGROUND CONDUIT SYSTEM, THE CONDUIT SHALL BE ABANDONED IN PLACE AND INDICATED ON THE AS-BUILT DRAWINGS. WHERE THE EXISTING REMOVED EQUIPMENT/DEVICES ARE FEEDING ANY EXISTING EQUIPMENT/DEVICES THAT ARE TO REMAIN, THE CONTRACTOR SHALL ROUTE NEW CONDUIT AND CONDUCTORS AS REQUIRED TO PROVIDE THE POWER NECESSARY TO MAINTAIN THE EXISTING EQUIPMENT/DEVICES IN OPERATION. ALL INFORMATION SHALL BE INDICATED ON THE AS-BUILT DRAWING.
- (4) THE CONTRACTOR SHALL NOTE THAT THE EXISTING CONDUIT ROUTINGS AND PULL BOX LOCATIONS INDICATED ON THIS PLAN WERE TAKEN FROM THE EXISTING AS-BUILT DRAWINGS AND THAT NOT ALL OF THE EXISTING CONDUITS AND PULL BOXES ARE SHOWN ON THIS PLAN. HE SHALL BE RESPONSIBLE FOR FIELD VERIFYING THE EXACT ROUTING AND QUANTITIES OF ALL CONDUIT SYSTEMS AND PULL BOXES ASSOCIATED WITH ALL OF THE EQUIPMENT/DEVICES BEING REMOVED AND REMOVE ALL CONDUITS AND PULL BOXES. WHERE ITS NOT FEASIBLE AND/OR IMPOSSIBLE TO REMOVE THE EXISTING UNDERGROUND CONDUIT SYSTEM, THE CONDUIT SHALL BE ABANDONED IN PLACE AND INDICATED ON THE AS-BUILT
- (5) THE CONTRACTOR SHALL COMPLETELY DISCONNECT AND REMOVE THE EXISTING BREAKER/RECEPTACLE BOX, INCLUDING ALL PULL BOXES, CONDUIT AND CONDUCTORS. WHERE ITS NOT FEASIBLE AND/OR IMPOSSIBLE TO REMOVE THE EXISTING UNDERGROUND CONDUIT SYSTEM, THE CONDUIT SHALL BE ABANDONED IN PLACE AND INDICATED ON THE AS-BUILT DRAWINGS. WHERE THE EXISTING REMOVED BREAKER/RECEPTACLE BOX IS FEEDING ANY EXISTING EQUIPMENT/DEVICES THAT ARE TO REMAIN THE CONTRACTOR SHALL ROUTE NEW CONDUIT AND CONDUCTORS AS REQUIRED TO PROVIDE THE POWER NECESSARY TO MAINTAIN THE EXISTING EQUIPMENT/DEVICES IN OPERATION. ALL INFORMATION SHALL BE INDICATED ON THE AS-BUILT DRAWING.
- (6) THE CONTRACTOR SHALL BE COMPLETELY DISCONNECT AND REMOVE THE EXISTING METER PEDESTAL "MPA", INCLUDING ALL SERVICE FEEDERS AND BRANCH CIRCUIT CONDUITS AND CONDUCTORS. PRIOR TO REMOVAL OF EQUIPMENT, THE CONTRACTOR SHALL TRACE OUT ALL EXISTING CIRCUITS BEING FED FROM THE EXISTING METER PEDESTAL "MPA" AND INDICATE WHAT EQUIPMENT/DEVICES THE EXISTING CIRCUITS ARE CURRENTLY FEEDING. ALL EXISTING CIRCUITS THAT ARE NOT FEEDING EXISTING EQUIPMENT THAT IS BEING REMOVED AND ARE TO REMAIN IN OPERATION SHALL BE INTERCEPTED AND EXTENDED TO THE NEW METER PEDESTAL "MPA". ALL INFORMATION SHALL BE INDICATED ON THE AS-BUILT DRAWING.
- THE CONTRACTOR SHALL BE RESPONSIBLE FOR MAINTAINING AND PROTECTING THE EXISTING LIGHT FIXTURE IN PLACE, INCLUDING THE EXISTING CONDUIT AND CONDUCTORS CURRENTLY FEEDING THE LIGHT FIXTURE. THE CONTRACTOR SHALL TRACE OUT THE EXISTING CIRCUIT FEEDING THE LIGHT FIXTURE AND INDICATE IT ON THE AS-BUILT DRAWING. WHERE THE EXISTING LIGHT FIXTURE IS BEING FED FROM AN EXISTING LIGHT FIXTURE BEING REMOVED, THE CONTRACTOR SHALL ROUTE NEW CONDUIT AND CONDUCTORS AS REQUIRED TO PROVIDE THE REQUIRED POWER NECESSARY TO THE EXISTING LIGHT FIXTURE. ALL INFORMATION SHALL BE INDICATED ON THE AS-BUILT DRAWING.
- (8) THE CONTRACTOR SHALL BE RESPONSIBLE FOR MAINTAINING THE EXISTING POWER TO THE EXISTING FOUNTAIN/CLOCK TOWER REMAINING IN PLACE. THE CONTRACTOR SHALL TRACE OUT THE EXISTING CONDUIT/CIRCUIT ROUTING CURRENTLY FEEDING THE EXISTING FOUNTAIN/CLOCK TOWER AND INDICATE IT ON THE AS-BUILT DRAMING. WHERE THE EXISTING FOUNTAIN/CLOCK TOWER CIRCUIT IS BEING FED TROUGH THE EXISTING CONDUIT SYSTEM THAT IS BEING REMOVED, THE CONTRACTOR SHALL ROUTE NEW CONDUIT AND CONDUCTORS AS REQUIRED TO PROVIDE THE REQUIRED POWER NECESSARY TO THE EXISTING FOUNTAIN/CLOCK TOWER. ALL INFORMATION SHALL BE INDICATED ON THE AS-BUILT DRAWING.
- (9) NOT USED.
- 10 THE CONTRACTOR SHALL COMPLETELY DISCONNECT AND REMOVE THE EXISTING UNDERGROUND PULL BOXES. HE SHALL MAKE ALL REQUIRED ADJUSTMENTS NECESSARY TO THE EXISTING CONDUITS AND CONDUCTORS THAT TERMINATE INTO THE EXISTING PULL BOXES IN ORDER TO EXTEND ALL OF THE EXISTING CIRCUITS THAT ARE TO REMAIN IN OPERATION TO THE NEW METER PEDESTAL "MPA" AND/OR NEW METER PEDESTAL "MPB". IF REQUIRED THE CONTRACTOR SHALL RELOCATE THE EXISTING PULL BOXES AND RE-USE THEM AS NECESSARY TO INTERCEPT ALL OF THE EXISTING CONDUITS. ALL INFORMATION SHALL BE INDICATED ON THE AS-BUILT DRAWING.
- II) THE CONTRACTOR SHALL COMPLETELY DISCONNECT AND REMOVE THE EXISTING LIGHT FIXTURE ONLY. HE SHALL RE-USE THE EXISTING LIGHT FIXTURE BASE, CONDUIT AND CONDUCTORS AS INDICATED ON THE RENOVATION SITE PLAN.
- 12 THE CONTRACTOR SHALL COMPLETELY DISCONNECT AND REMOVED THE EXISTING SOUND SYSTEM EQUIPMENT ONLY. HE SHALL BE RESPONSIBLE FOR MAINTAINING AND PROTECTING THE EXISTING CABINET IN PLACE, INCLUDING THE EXISTING POWER CURRENTLY FEEDING THE EQUIPMENT. THE CONTRACTOR SHALL TRACE OUT THE EXISTING CIRCUIT FEEDING THE SOUND SYSTEM EQUIPMENT AND INDICATE IT ON THE AS-BUILT DRAWING. WHERE THE EXISTING SOUND SYSTEM EQUIPMENT CIRCUIT IS BEING FED TROUGH THE EXISTING CONDUIT SYSTEM THAT IS BEING REMOVED, THE CONTRACTOR SHALL ROUTE NEW CONDUIT AND CONDUCTORS AS REQUIRED TO PROVIDE THE REQUIRED POWER NECESSARY TO THE EXISTING SOUND SYSTEM EQUIPMENT. ALL INFORMATION SHALL BE INDICATED ON THE AS-BUILT DRAWING.
- (I3) THE CONTRACTOR SHALL BE RESPONSIBLE FOR MAINTAINING AND PROTECTING THE EXISTING SOUND SYSTEM SPEAKERS IN PLACE, INCLUDING INCLUDING ALL ASSOCIATED PULL BOXES, CONDUIT AND CONDUCTORS. EXACT ROUTING OF CONDUIT AND CABLING SHALL BE FIELD VERIFIED AND INDICATED ON THE AS-BUILT DRAWINGS.
- 14) THE CONTRACTOR SHALL FIELD VERIFY EXACT POINT OF INTERCEPTION IN THE FIELD AND INDICATE EXACT LOCATION ON THE AS-BUILT DRAWINGS.
- (15) REFER TO THE RENOVATION SITE PLAN FOR ADDITIONAL INFORMATION AND
- (16) REFER TO GENERAL NOTES, SHEET EO.I, FOR ADDITIONAL REQUIREMENTS.

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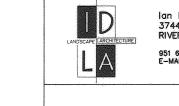
ELECTRICAL PLAN DOWNTOWN MALL

E1. SHEET 77 OF 100

M-457

UNDERGROUND SERVICE ALERT

A&F ENGINEERING GROUP INC 9333 BASELINE RD., SUITE 100, RANCHO CUCAMONGA, CA 91730











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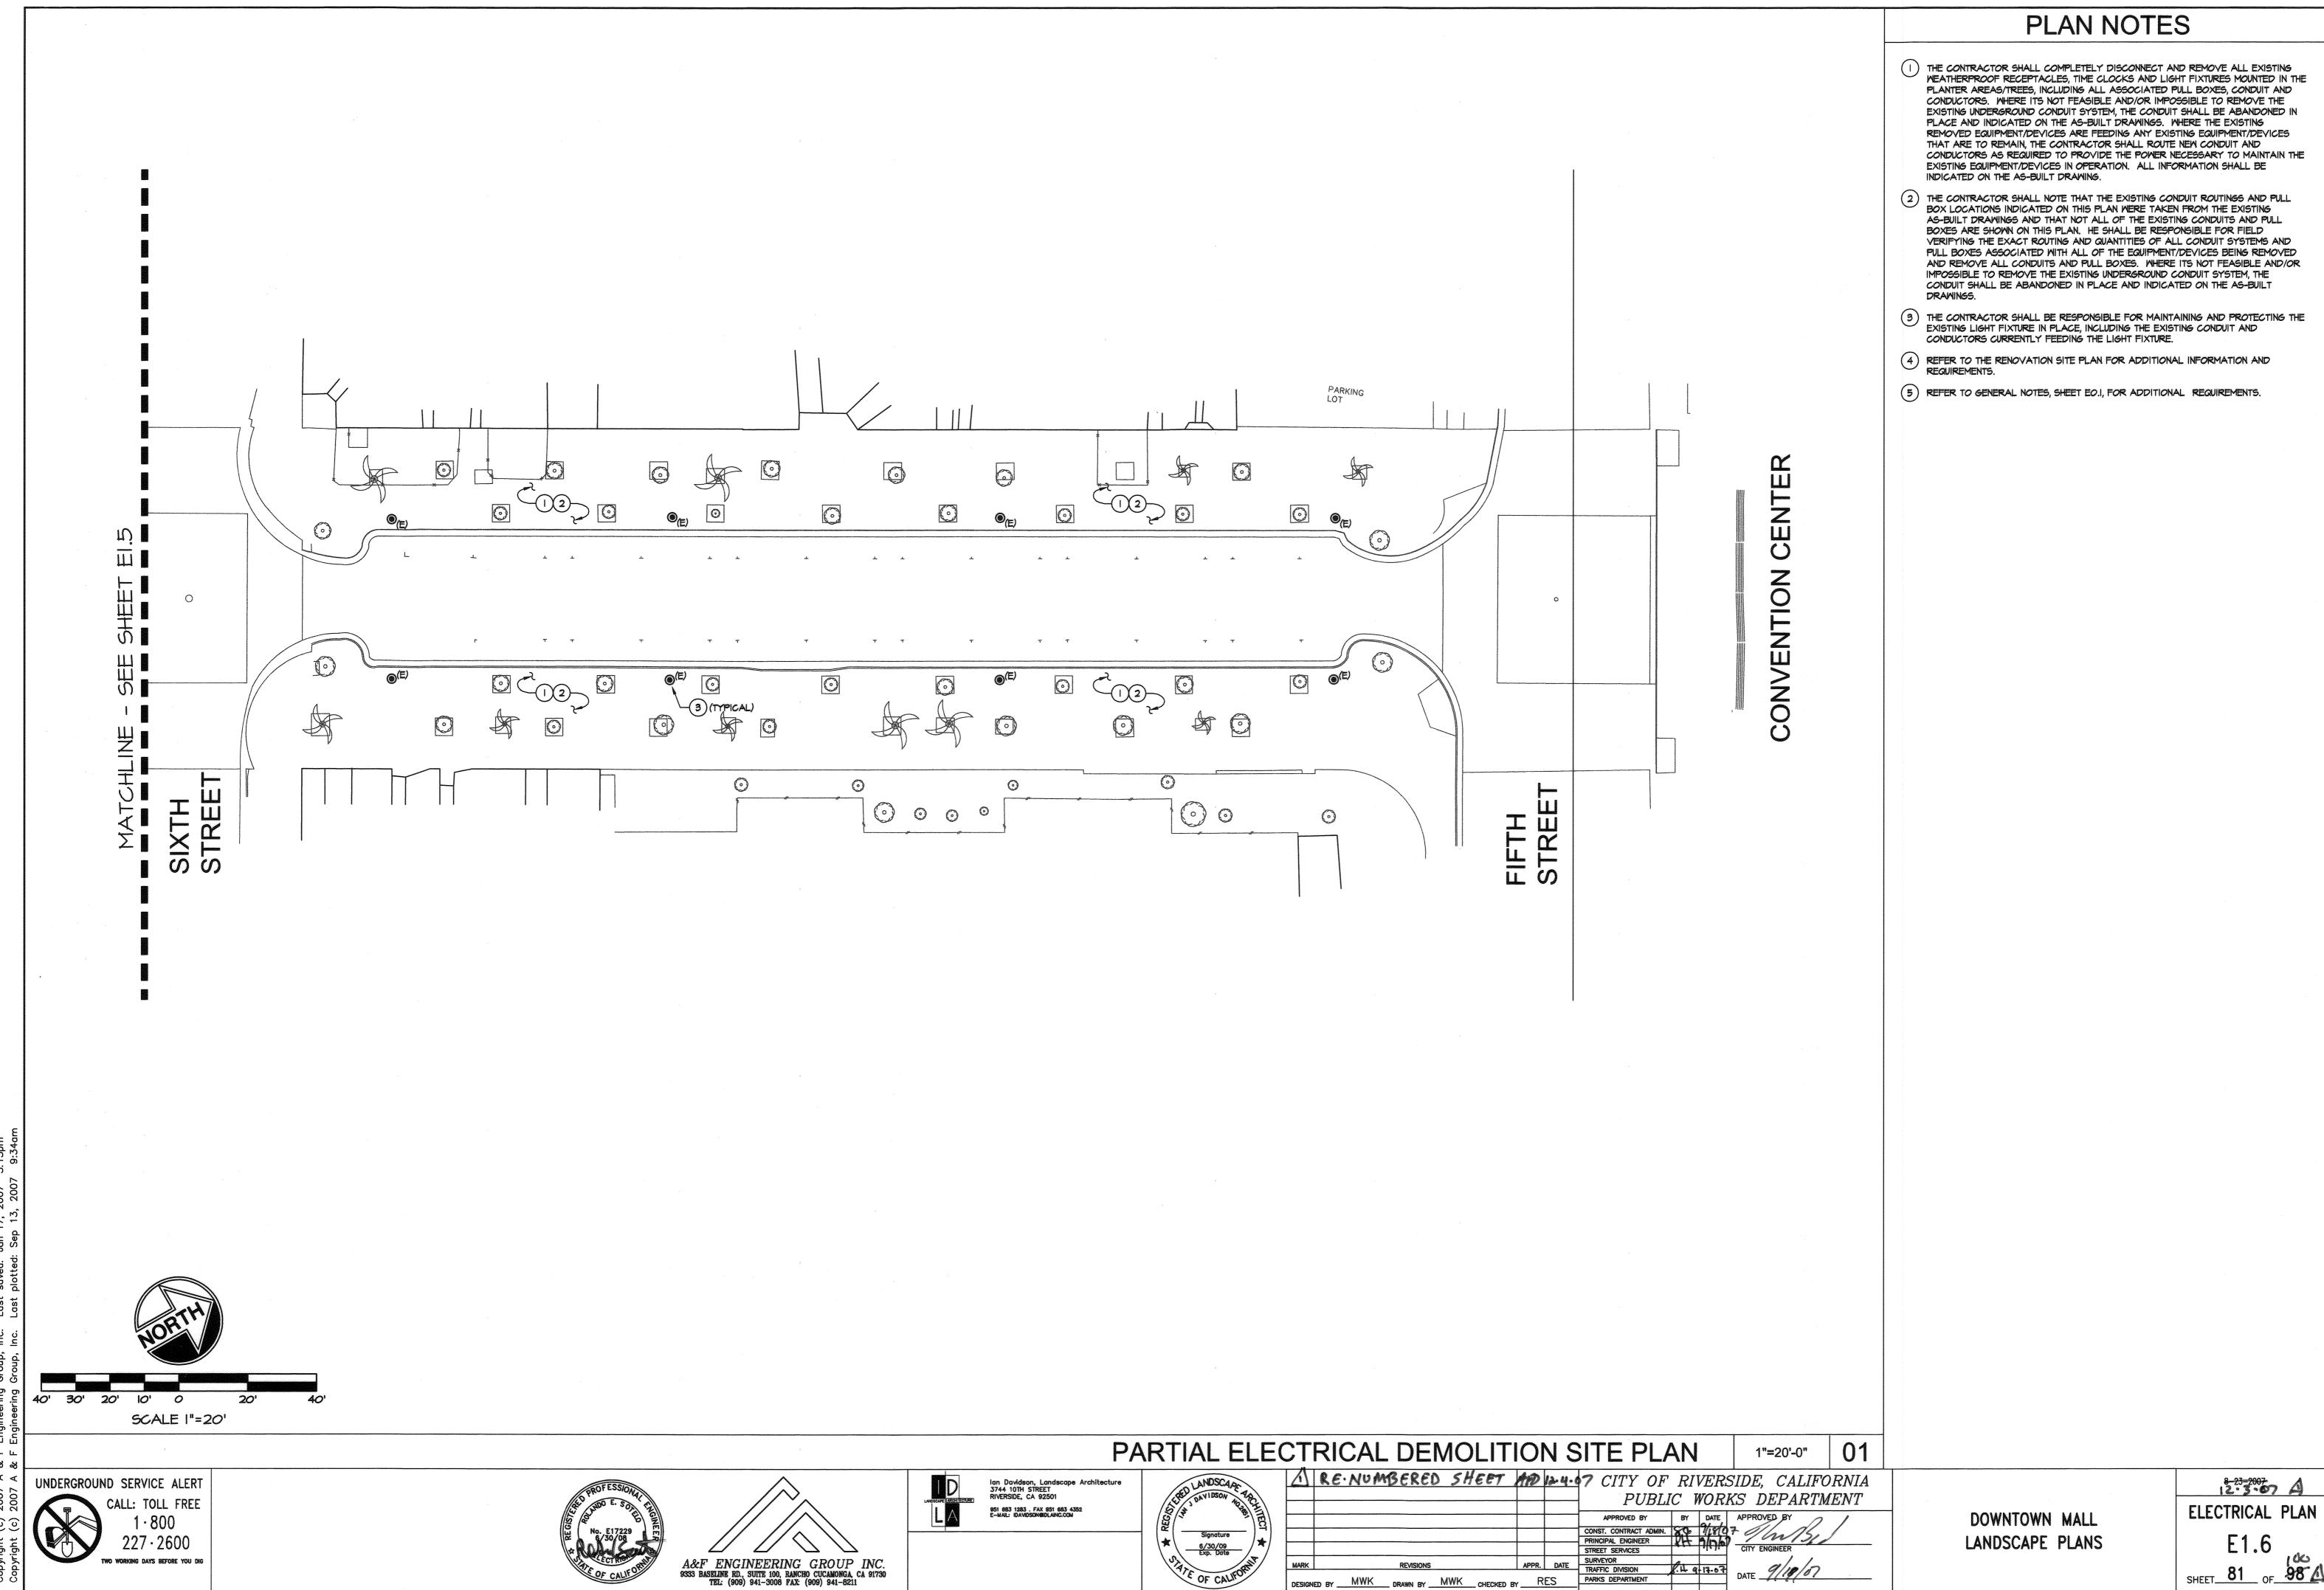
LANDSCAPE PLANS




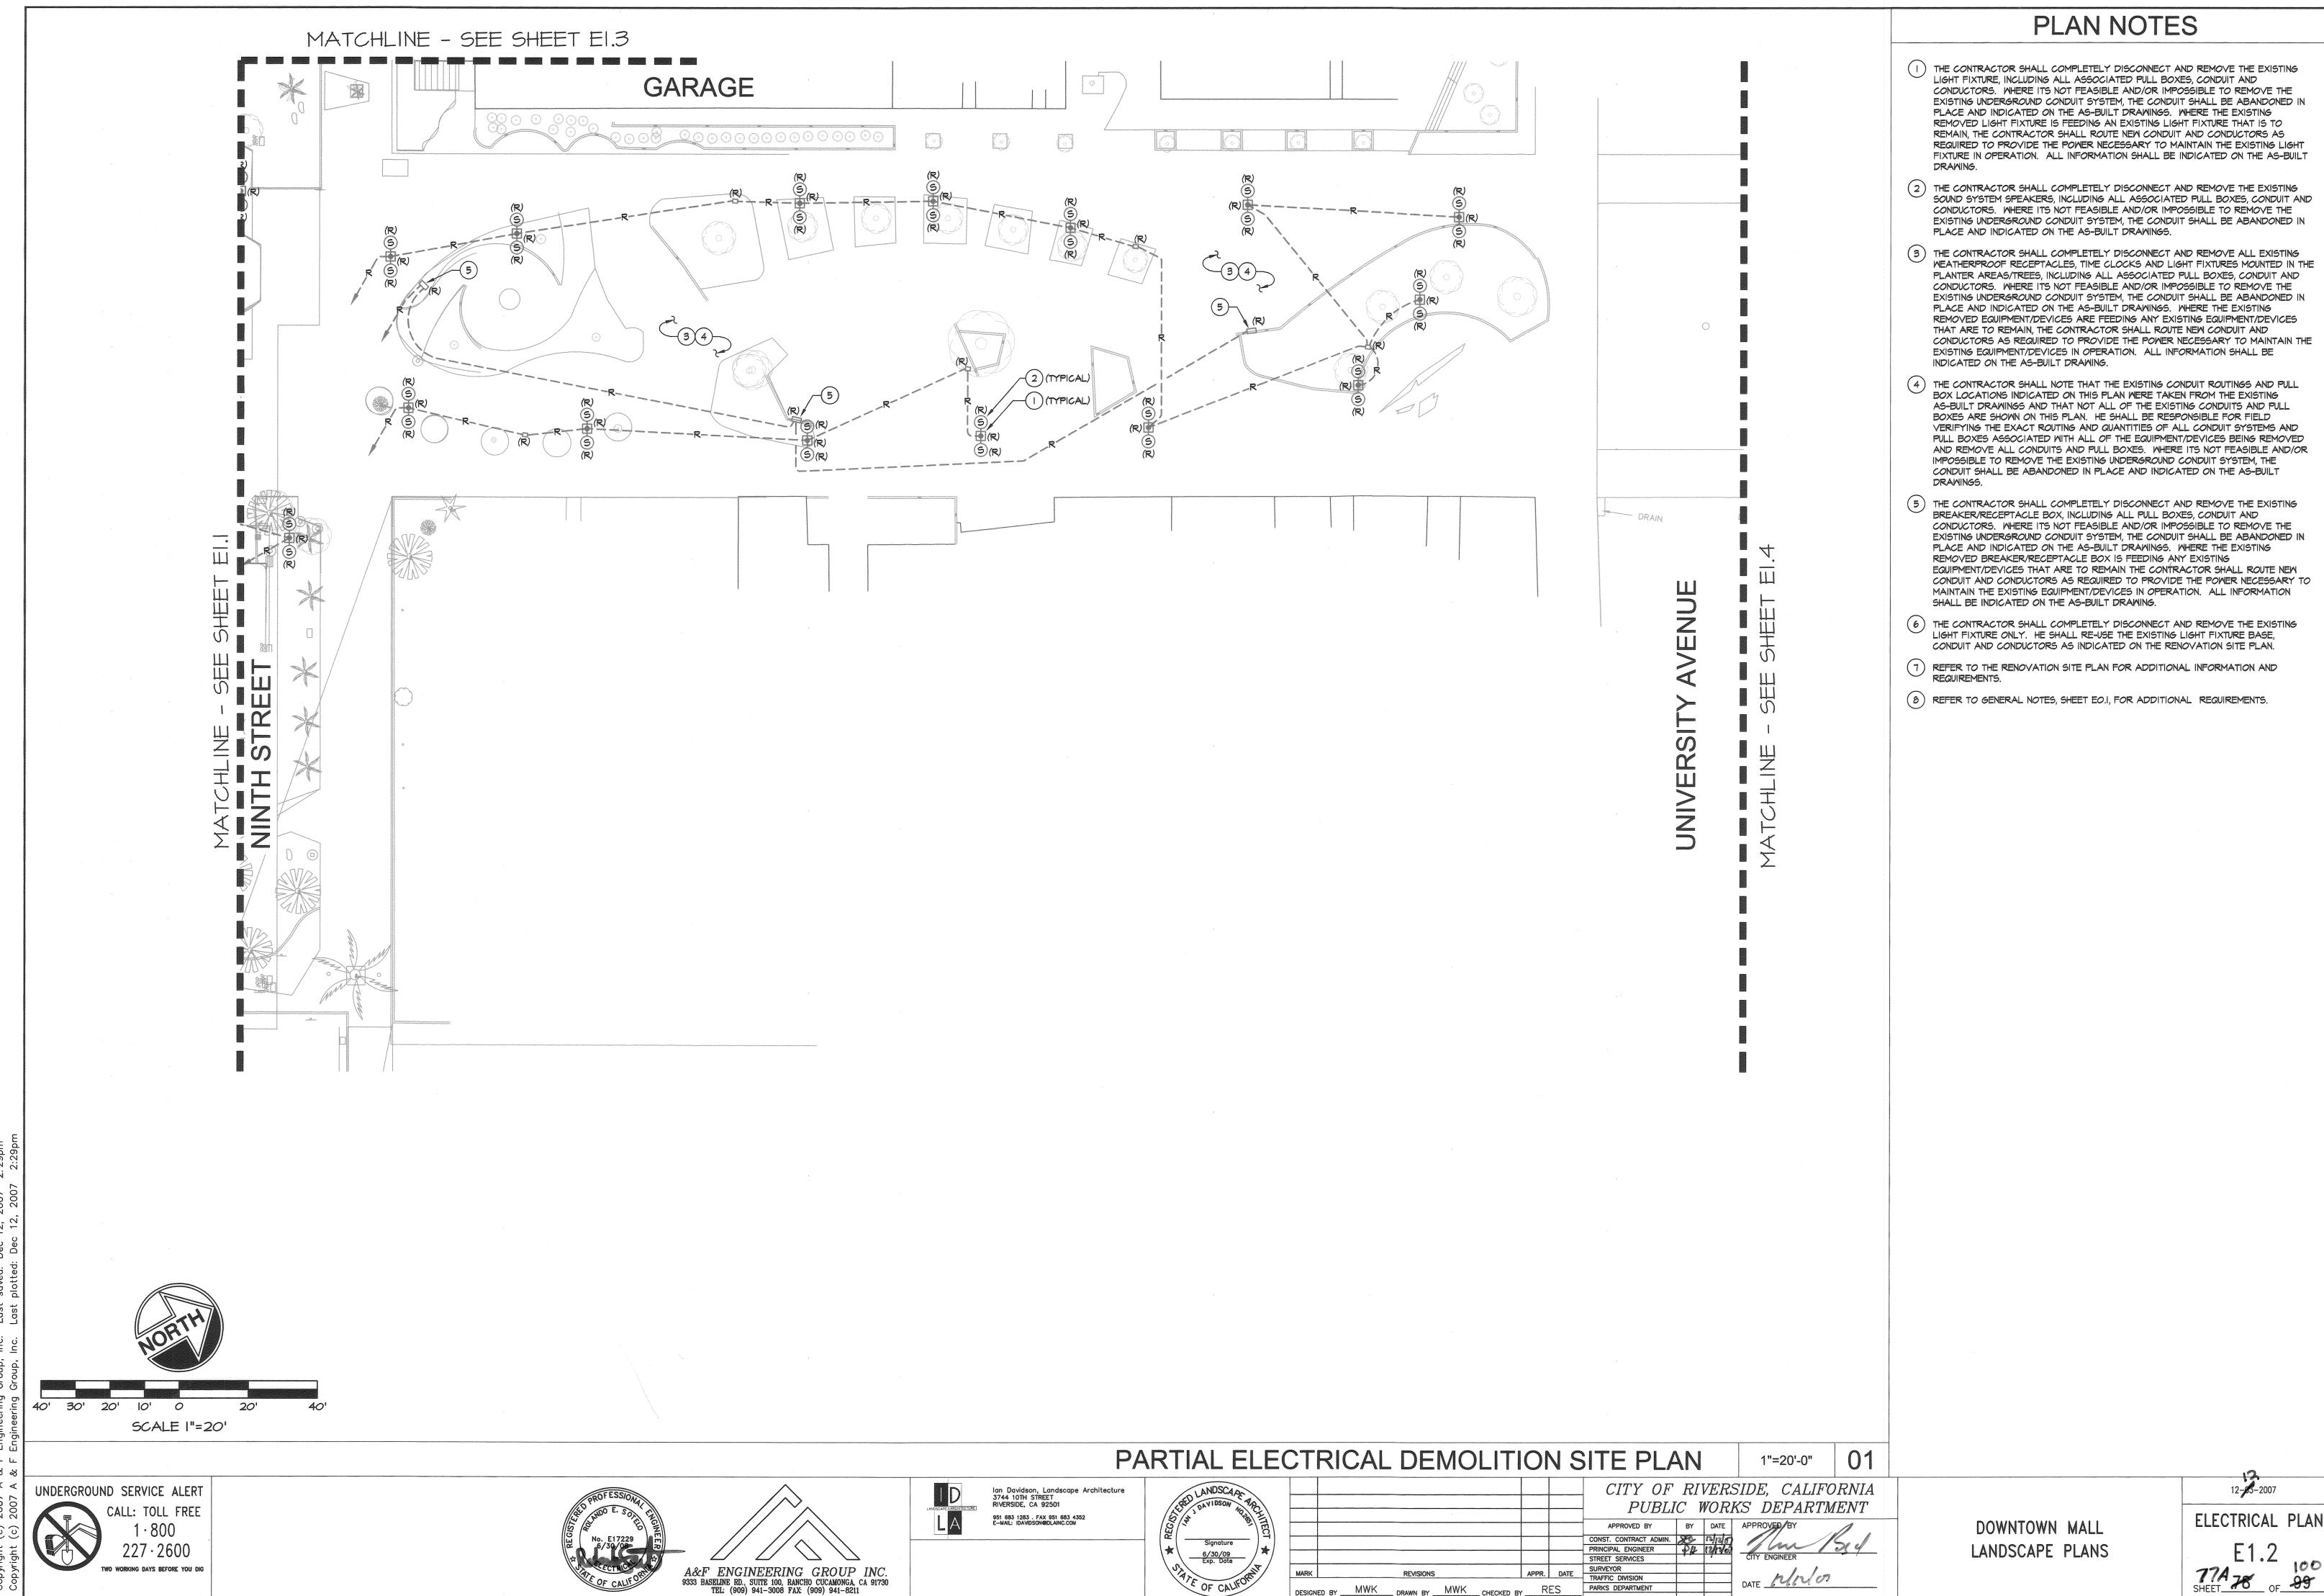


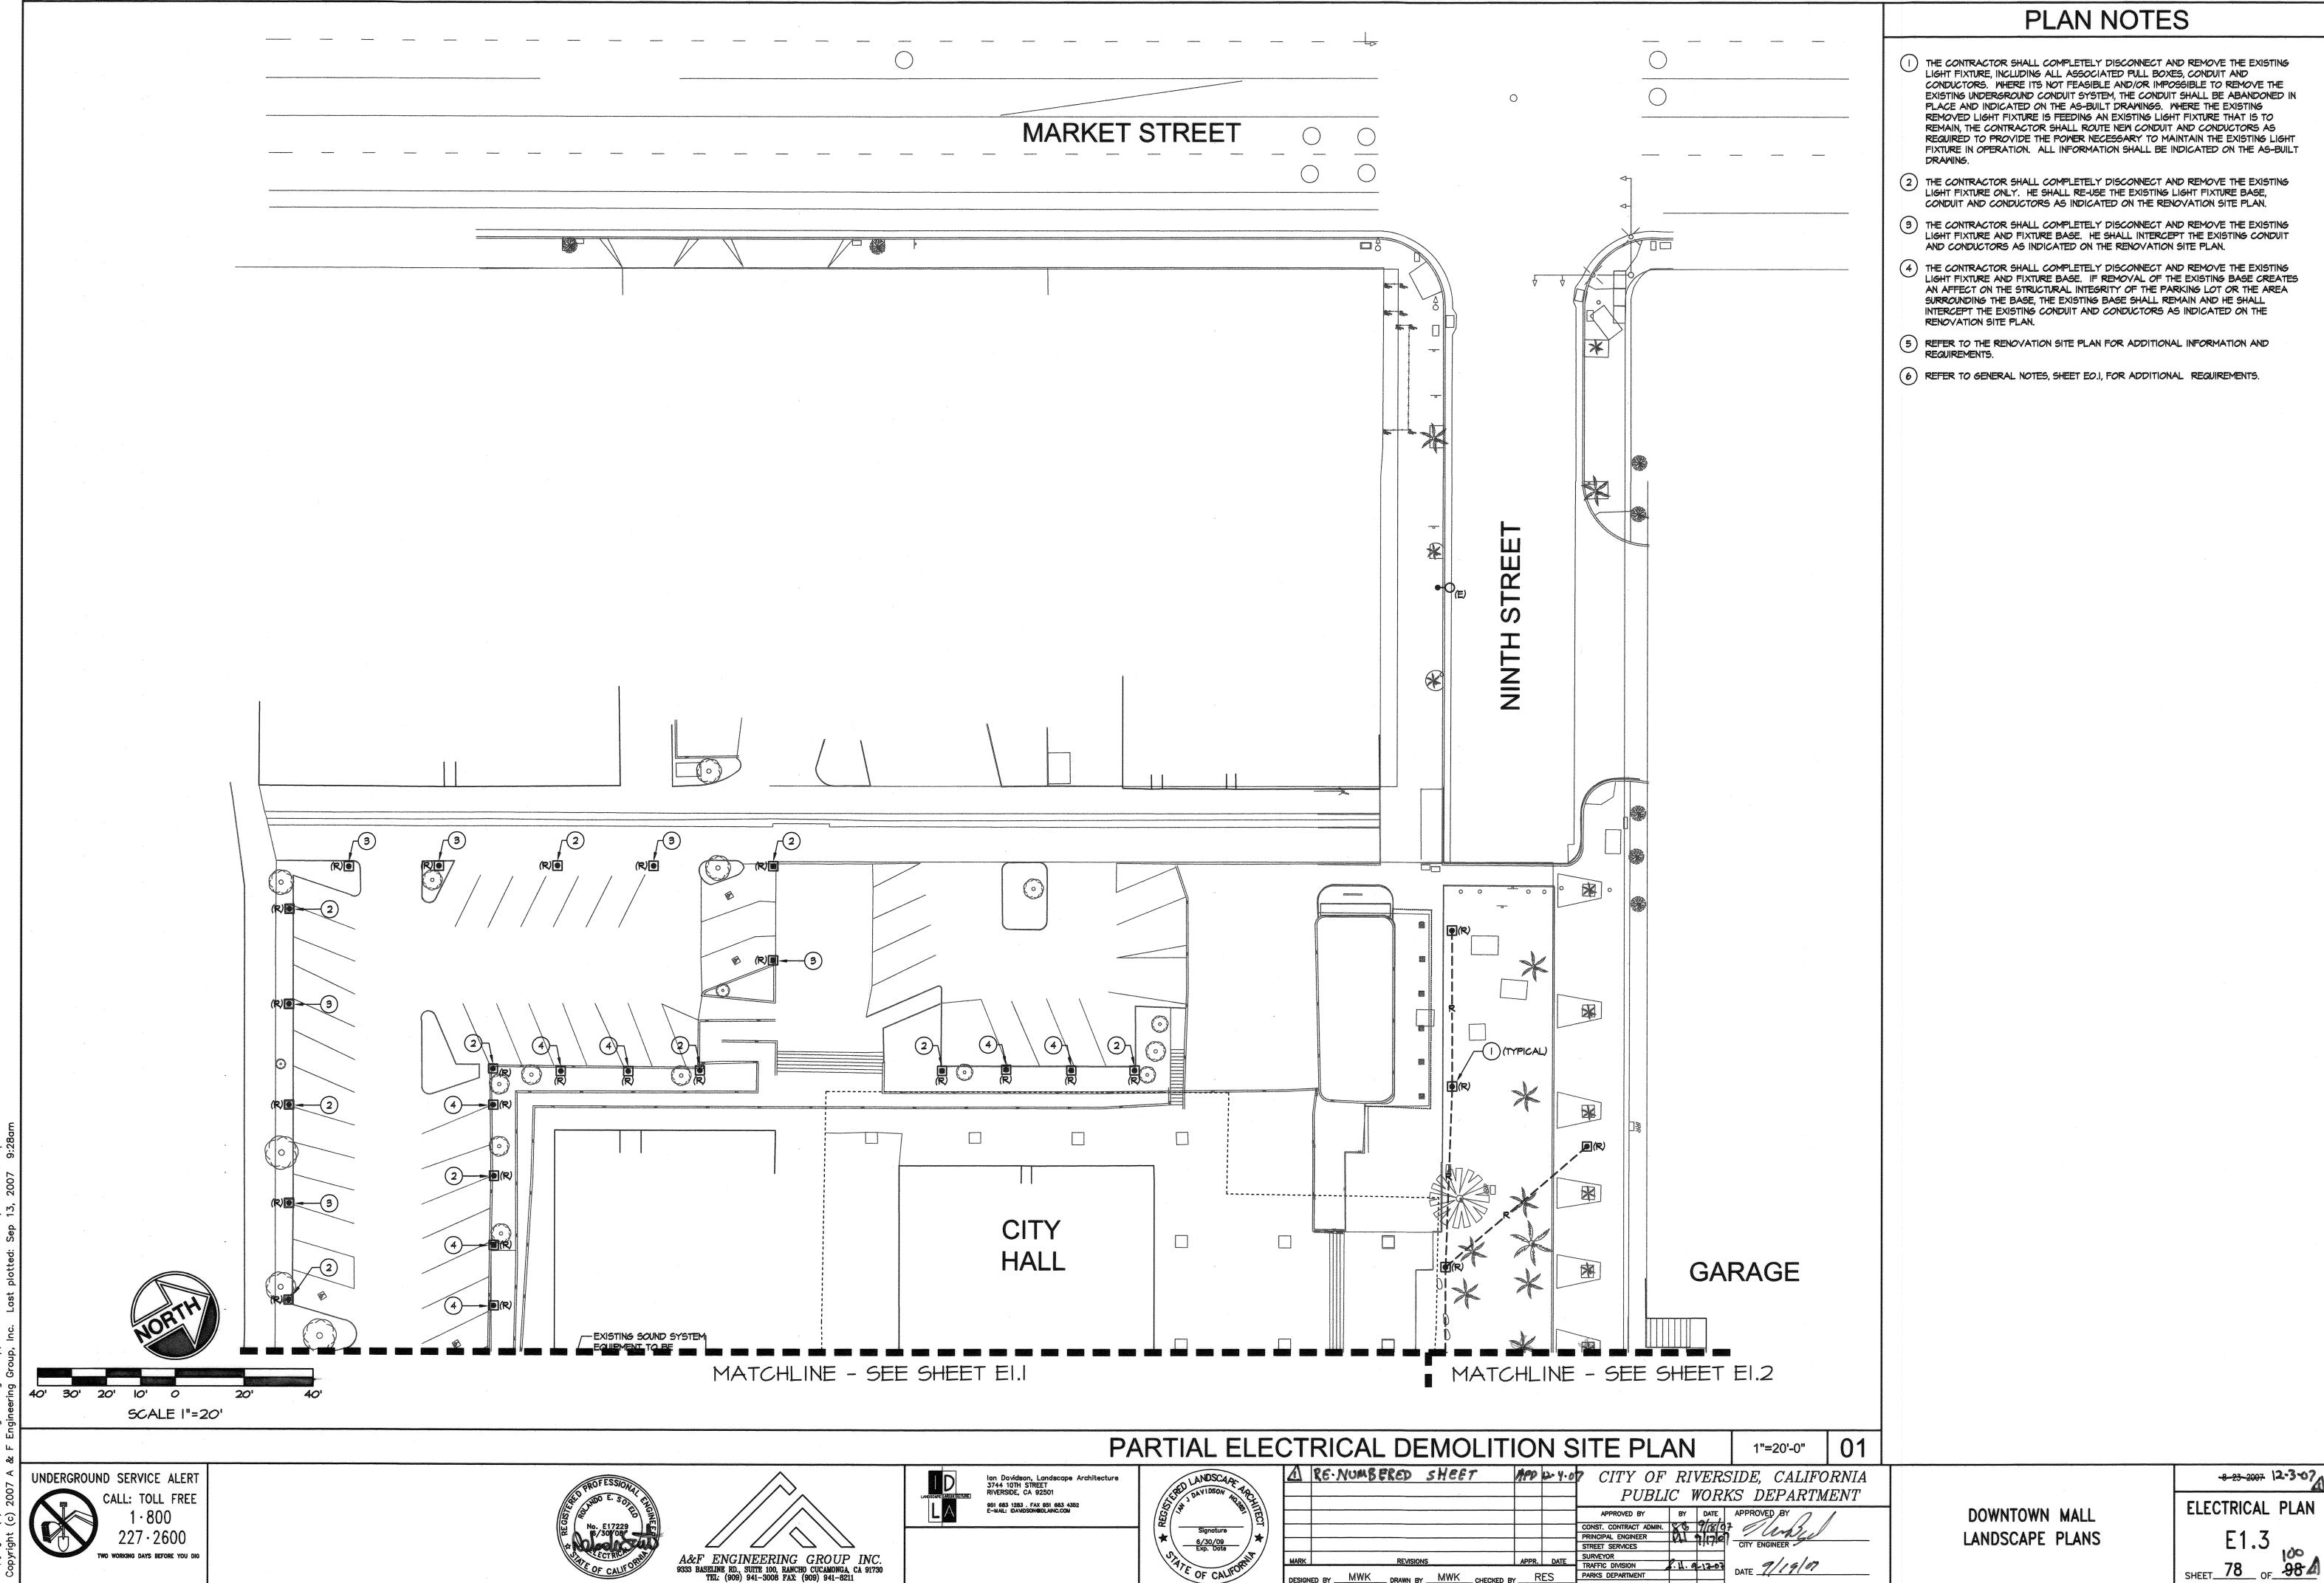

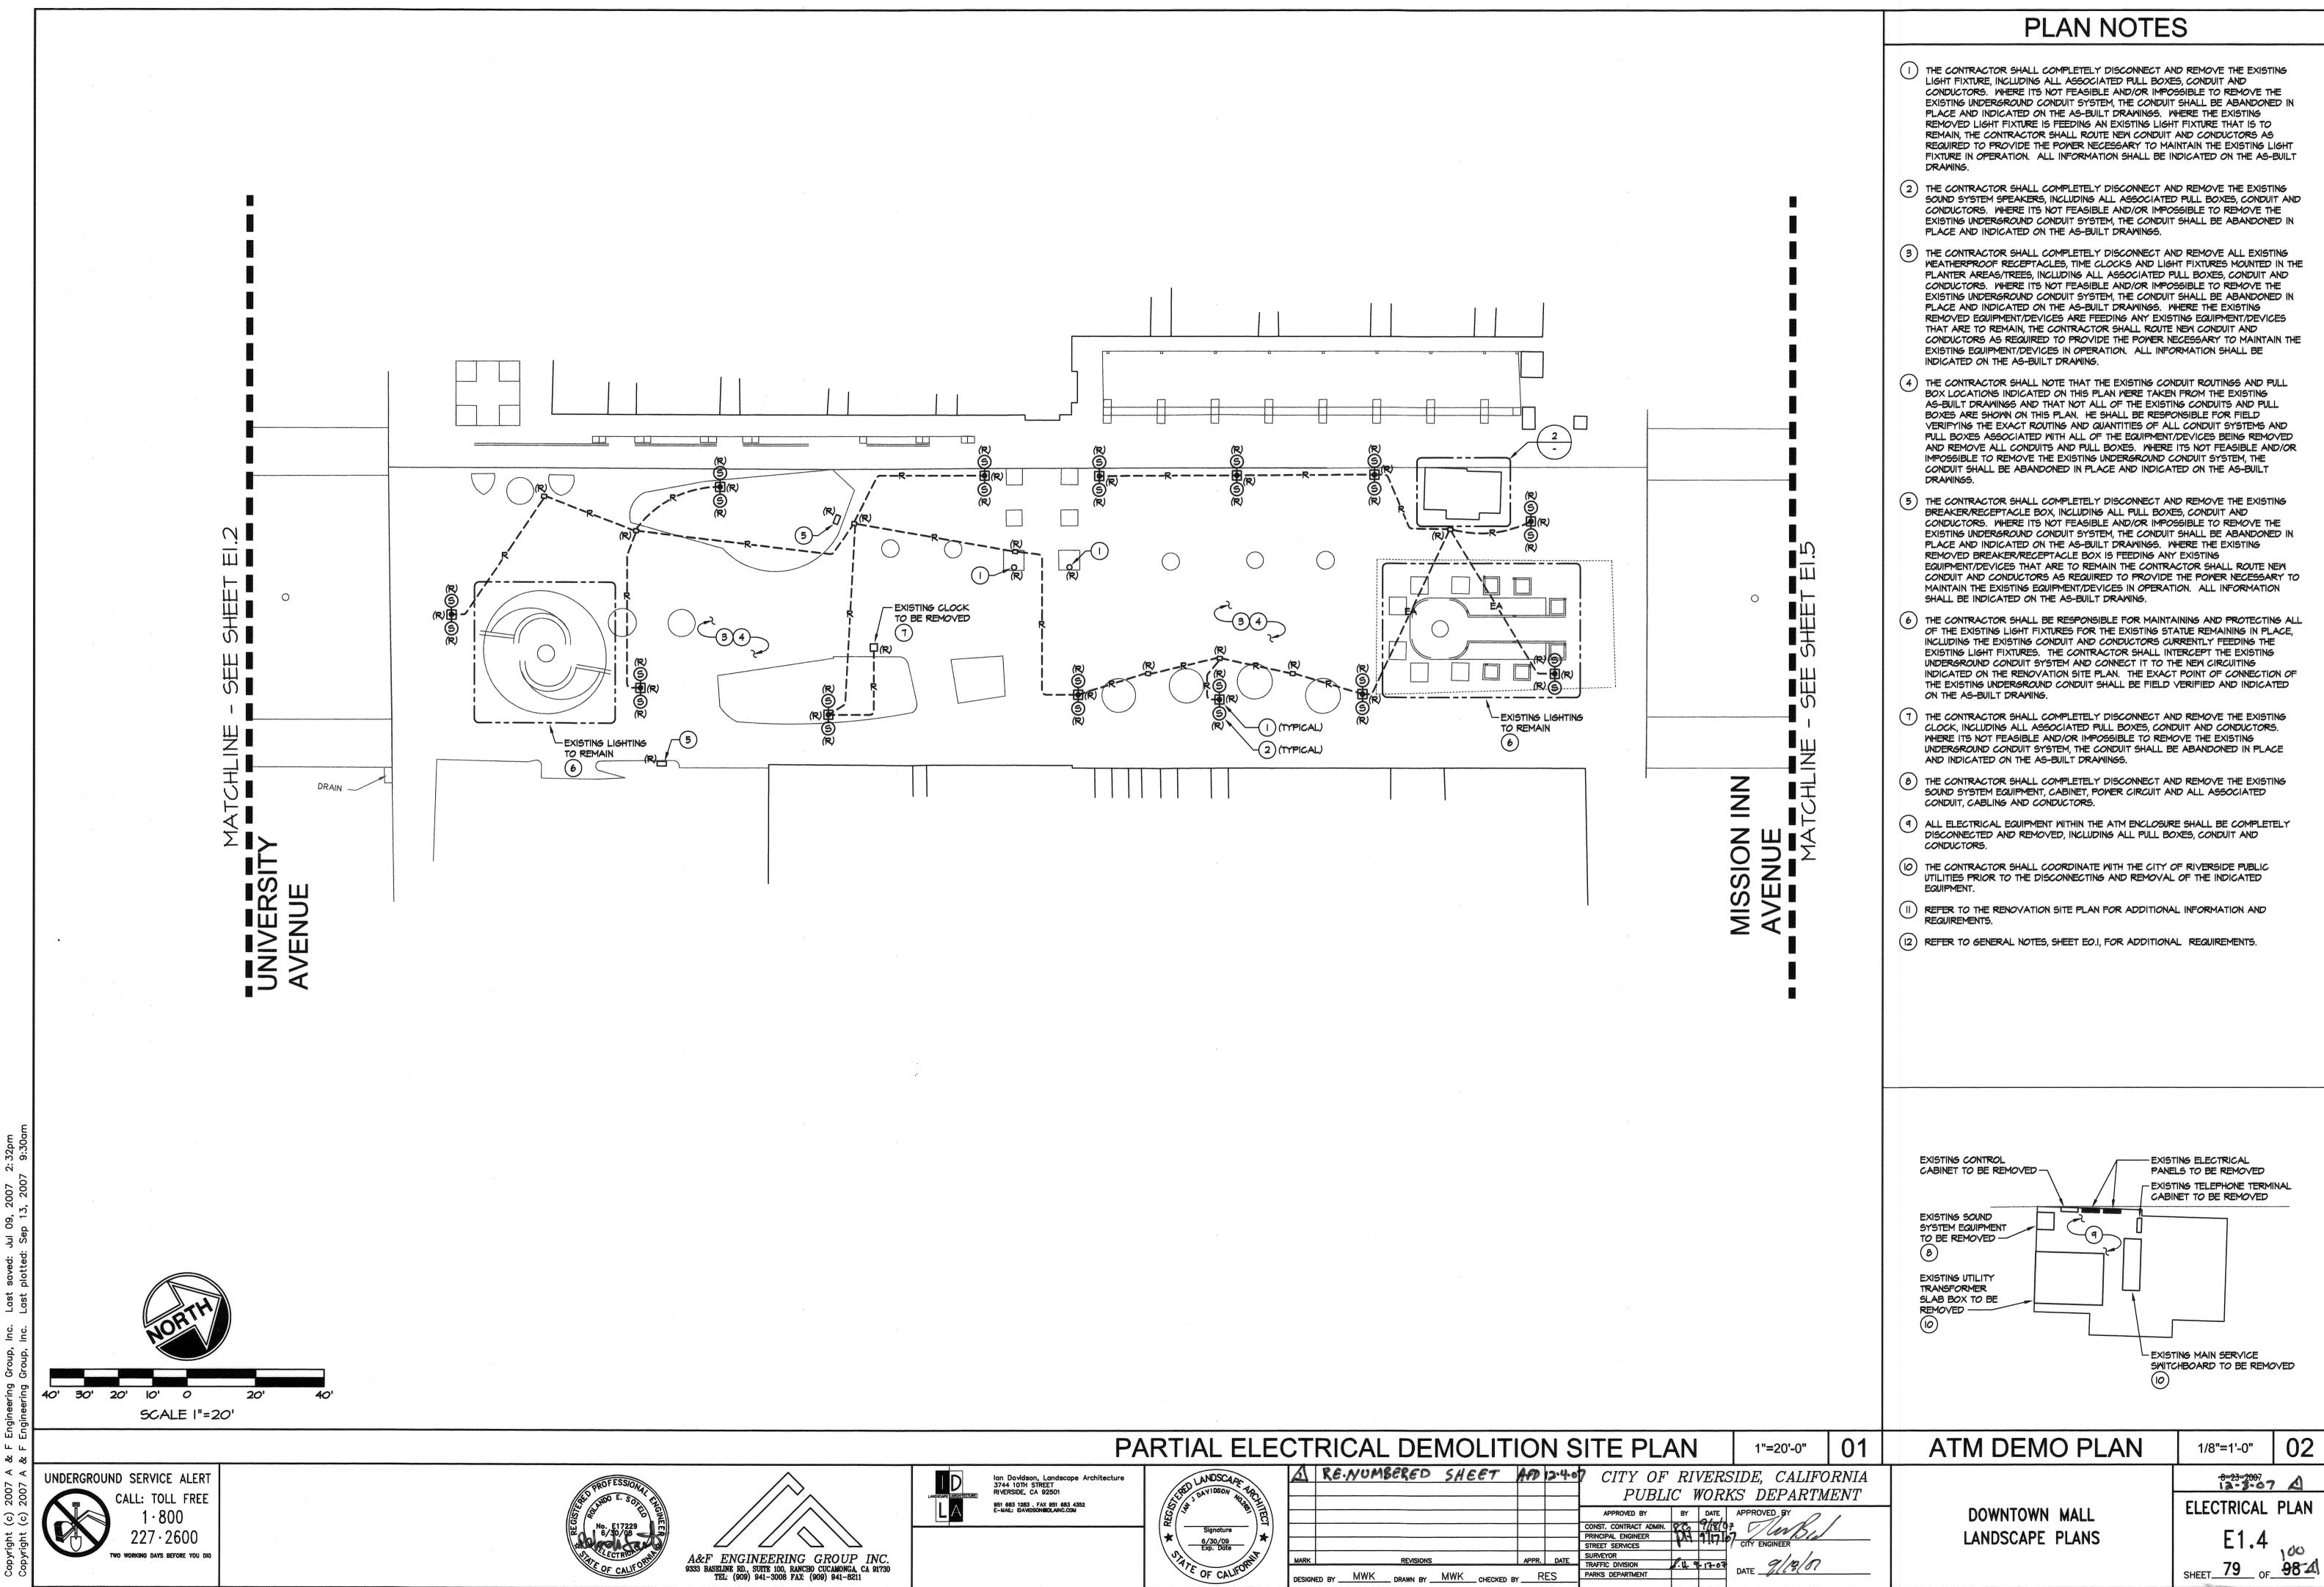

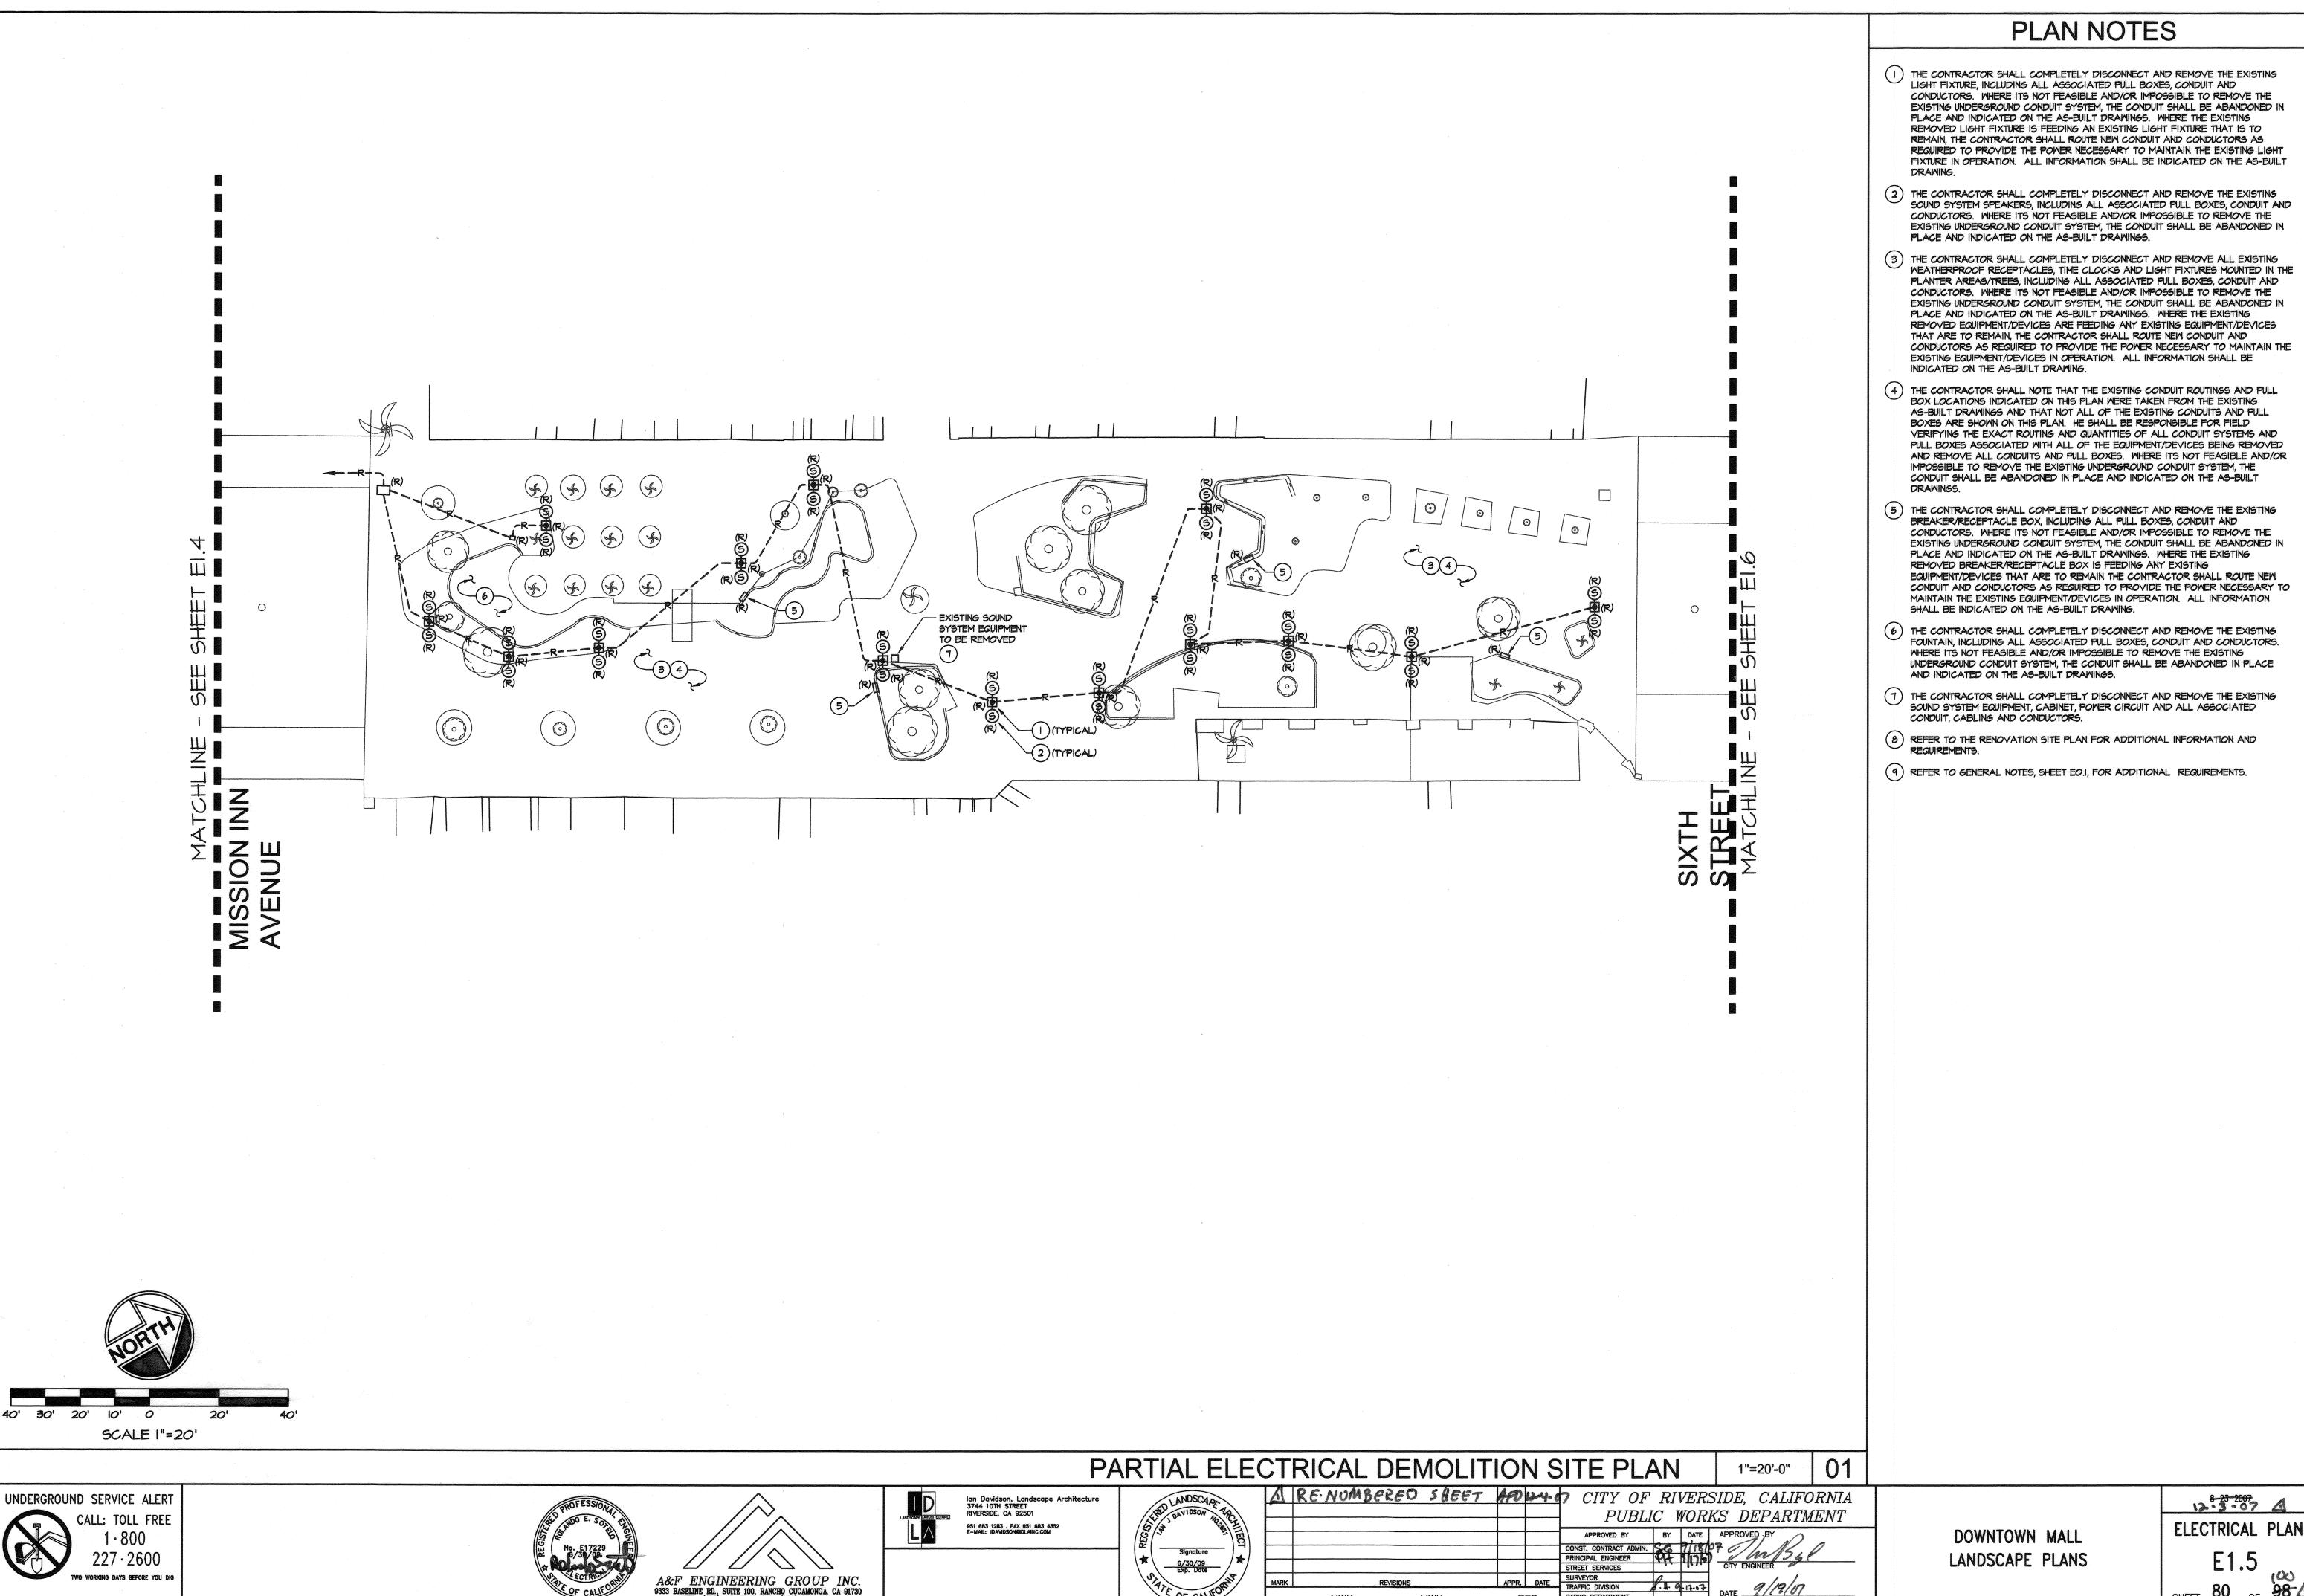

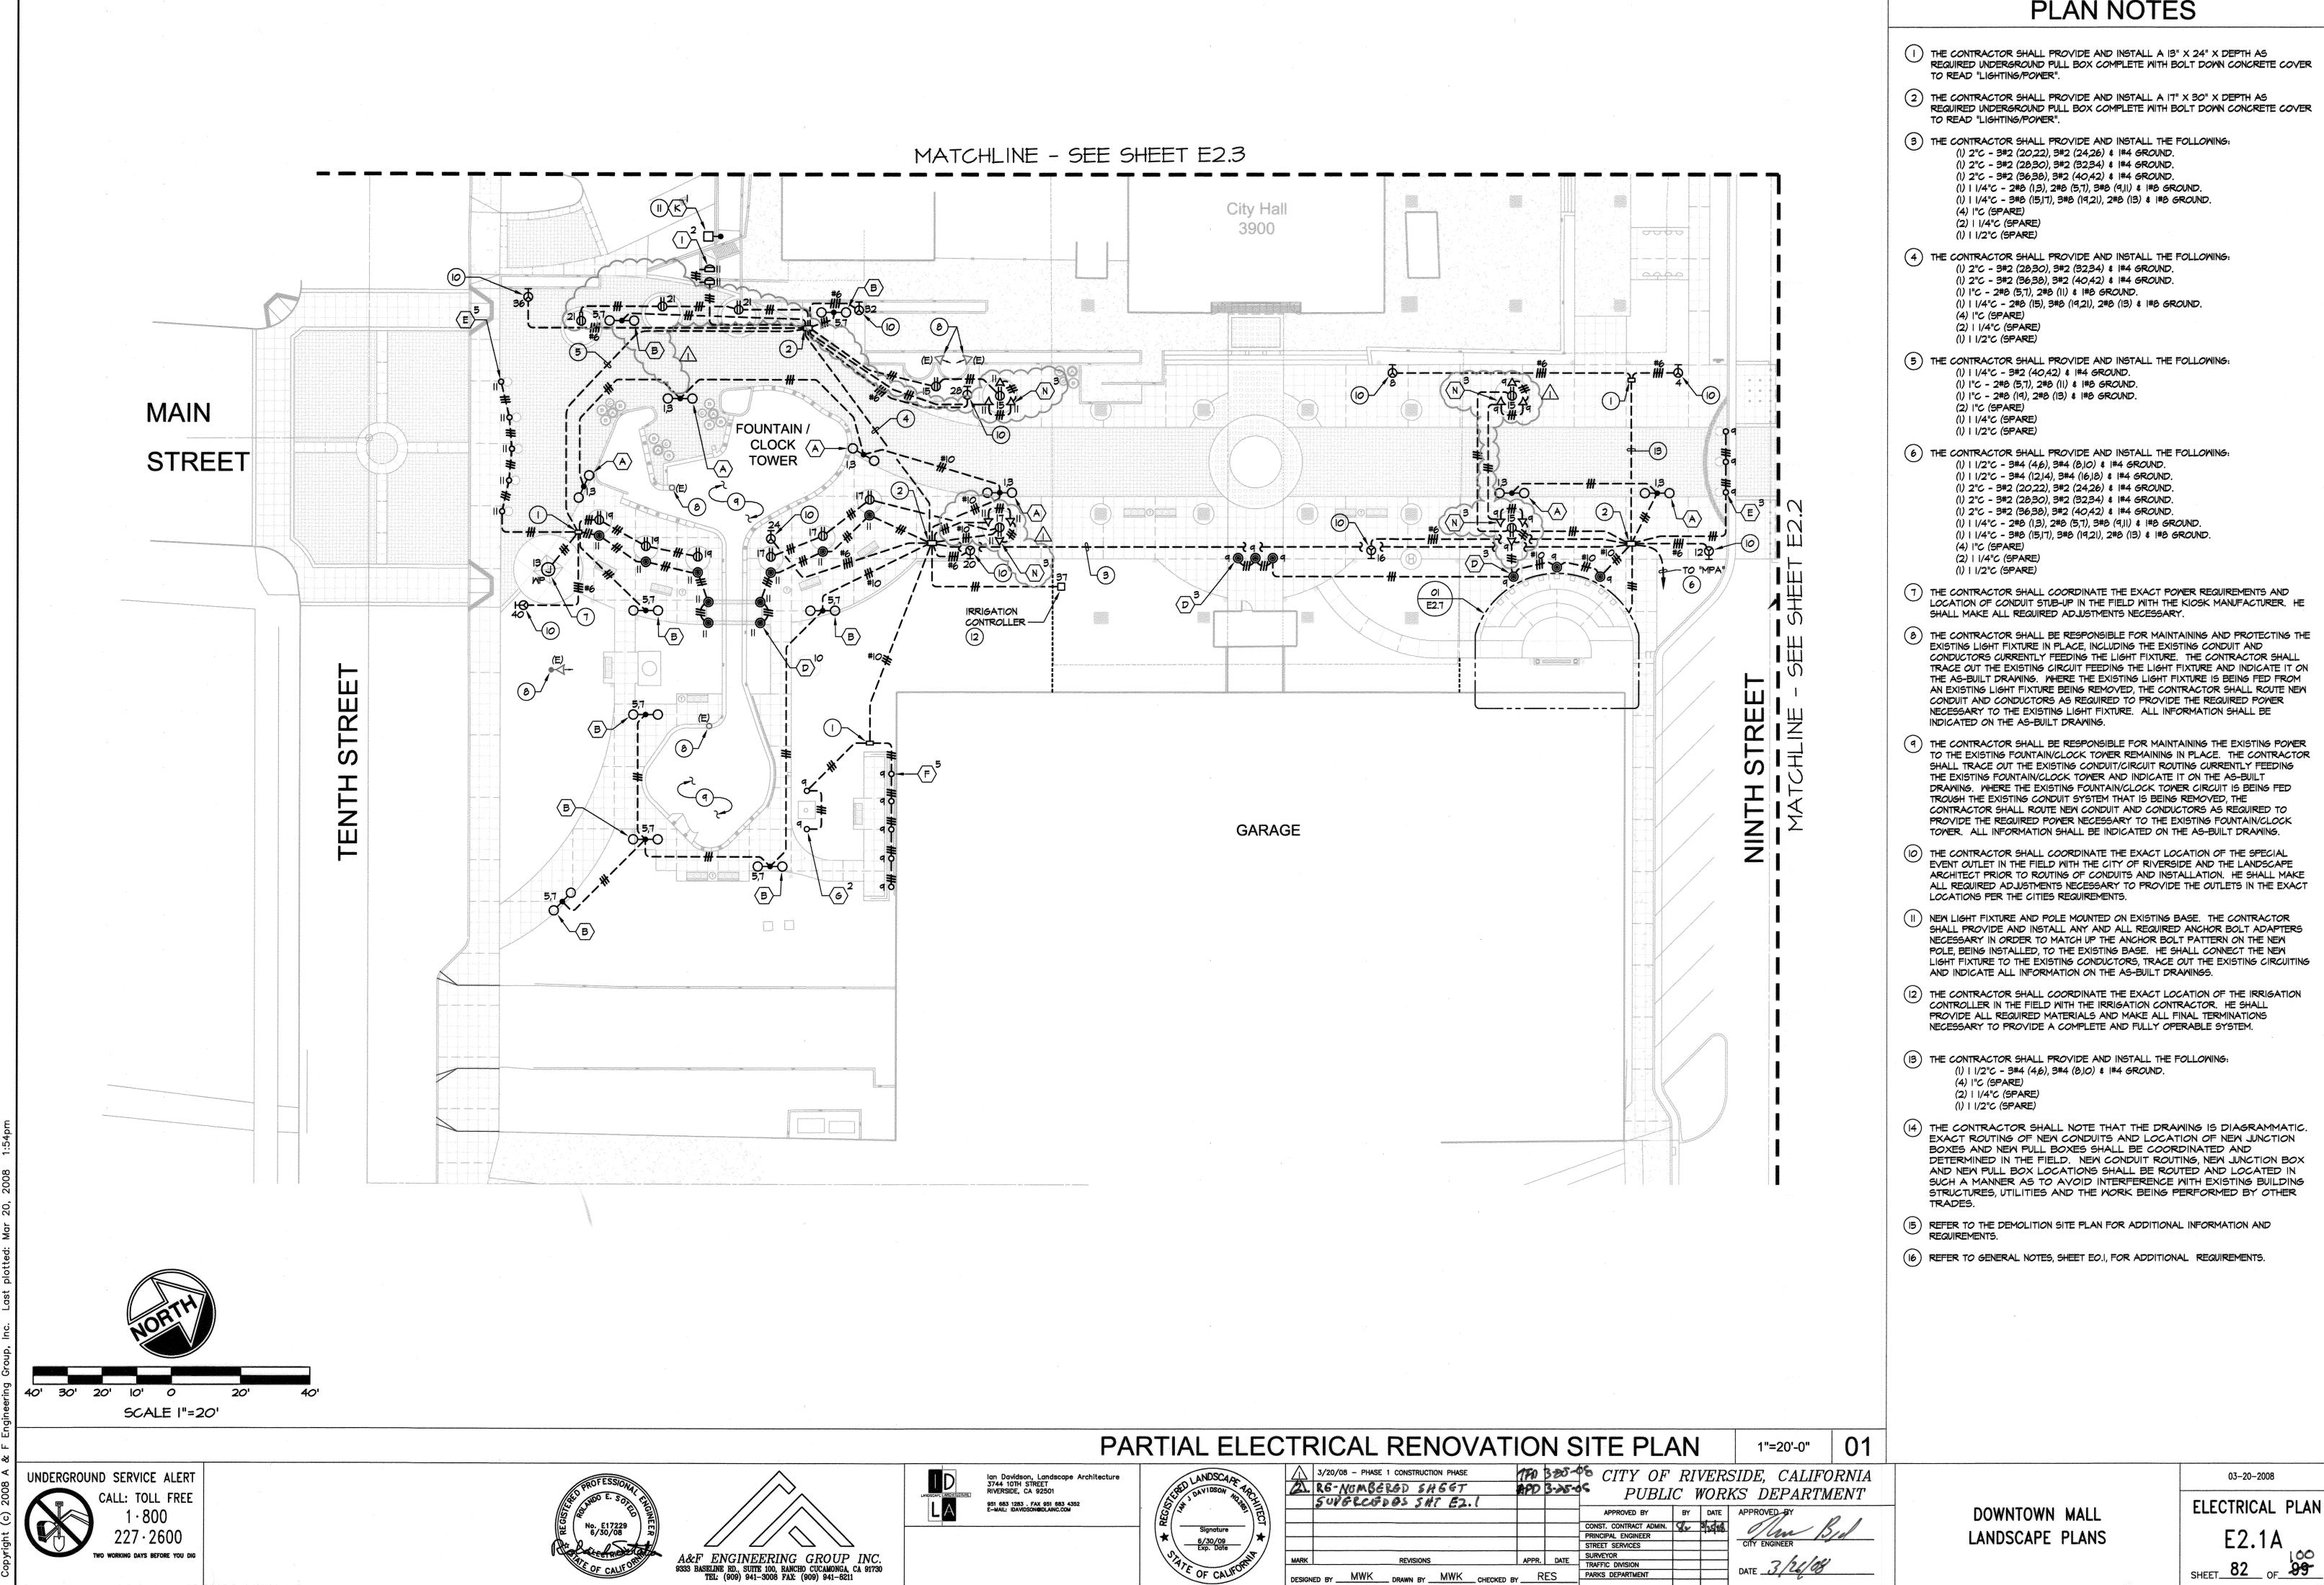

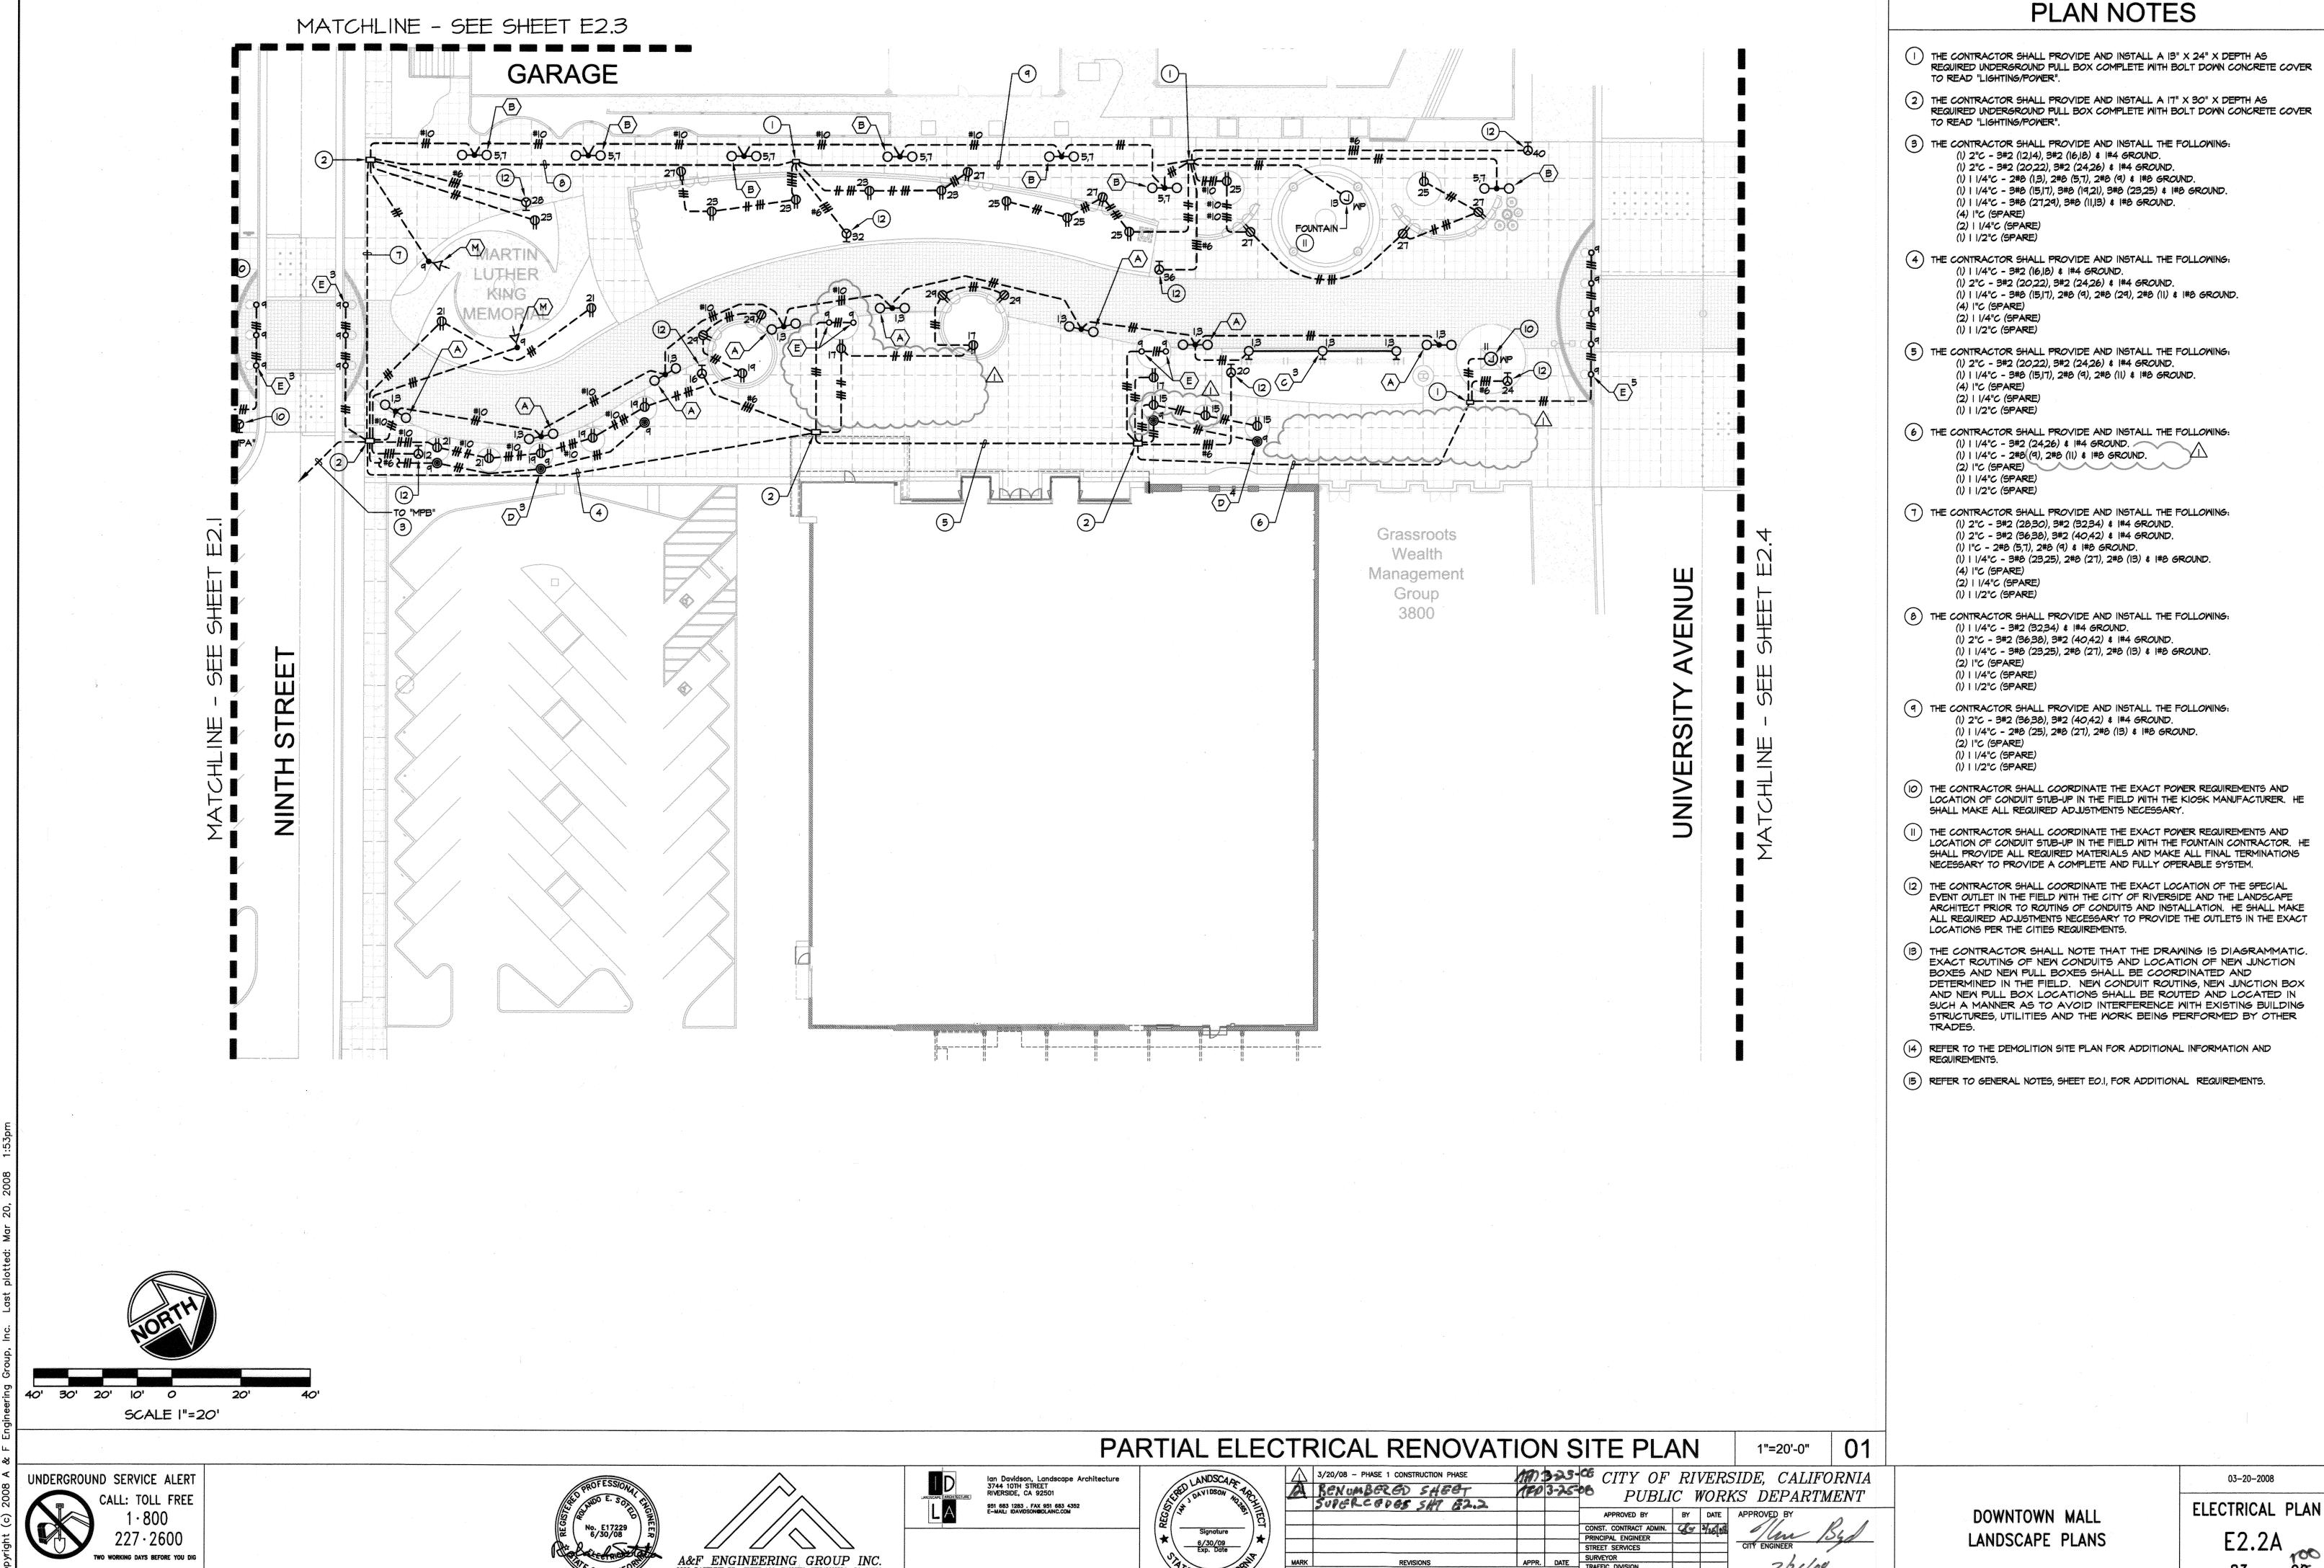











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SHEET 83 OF 99



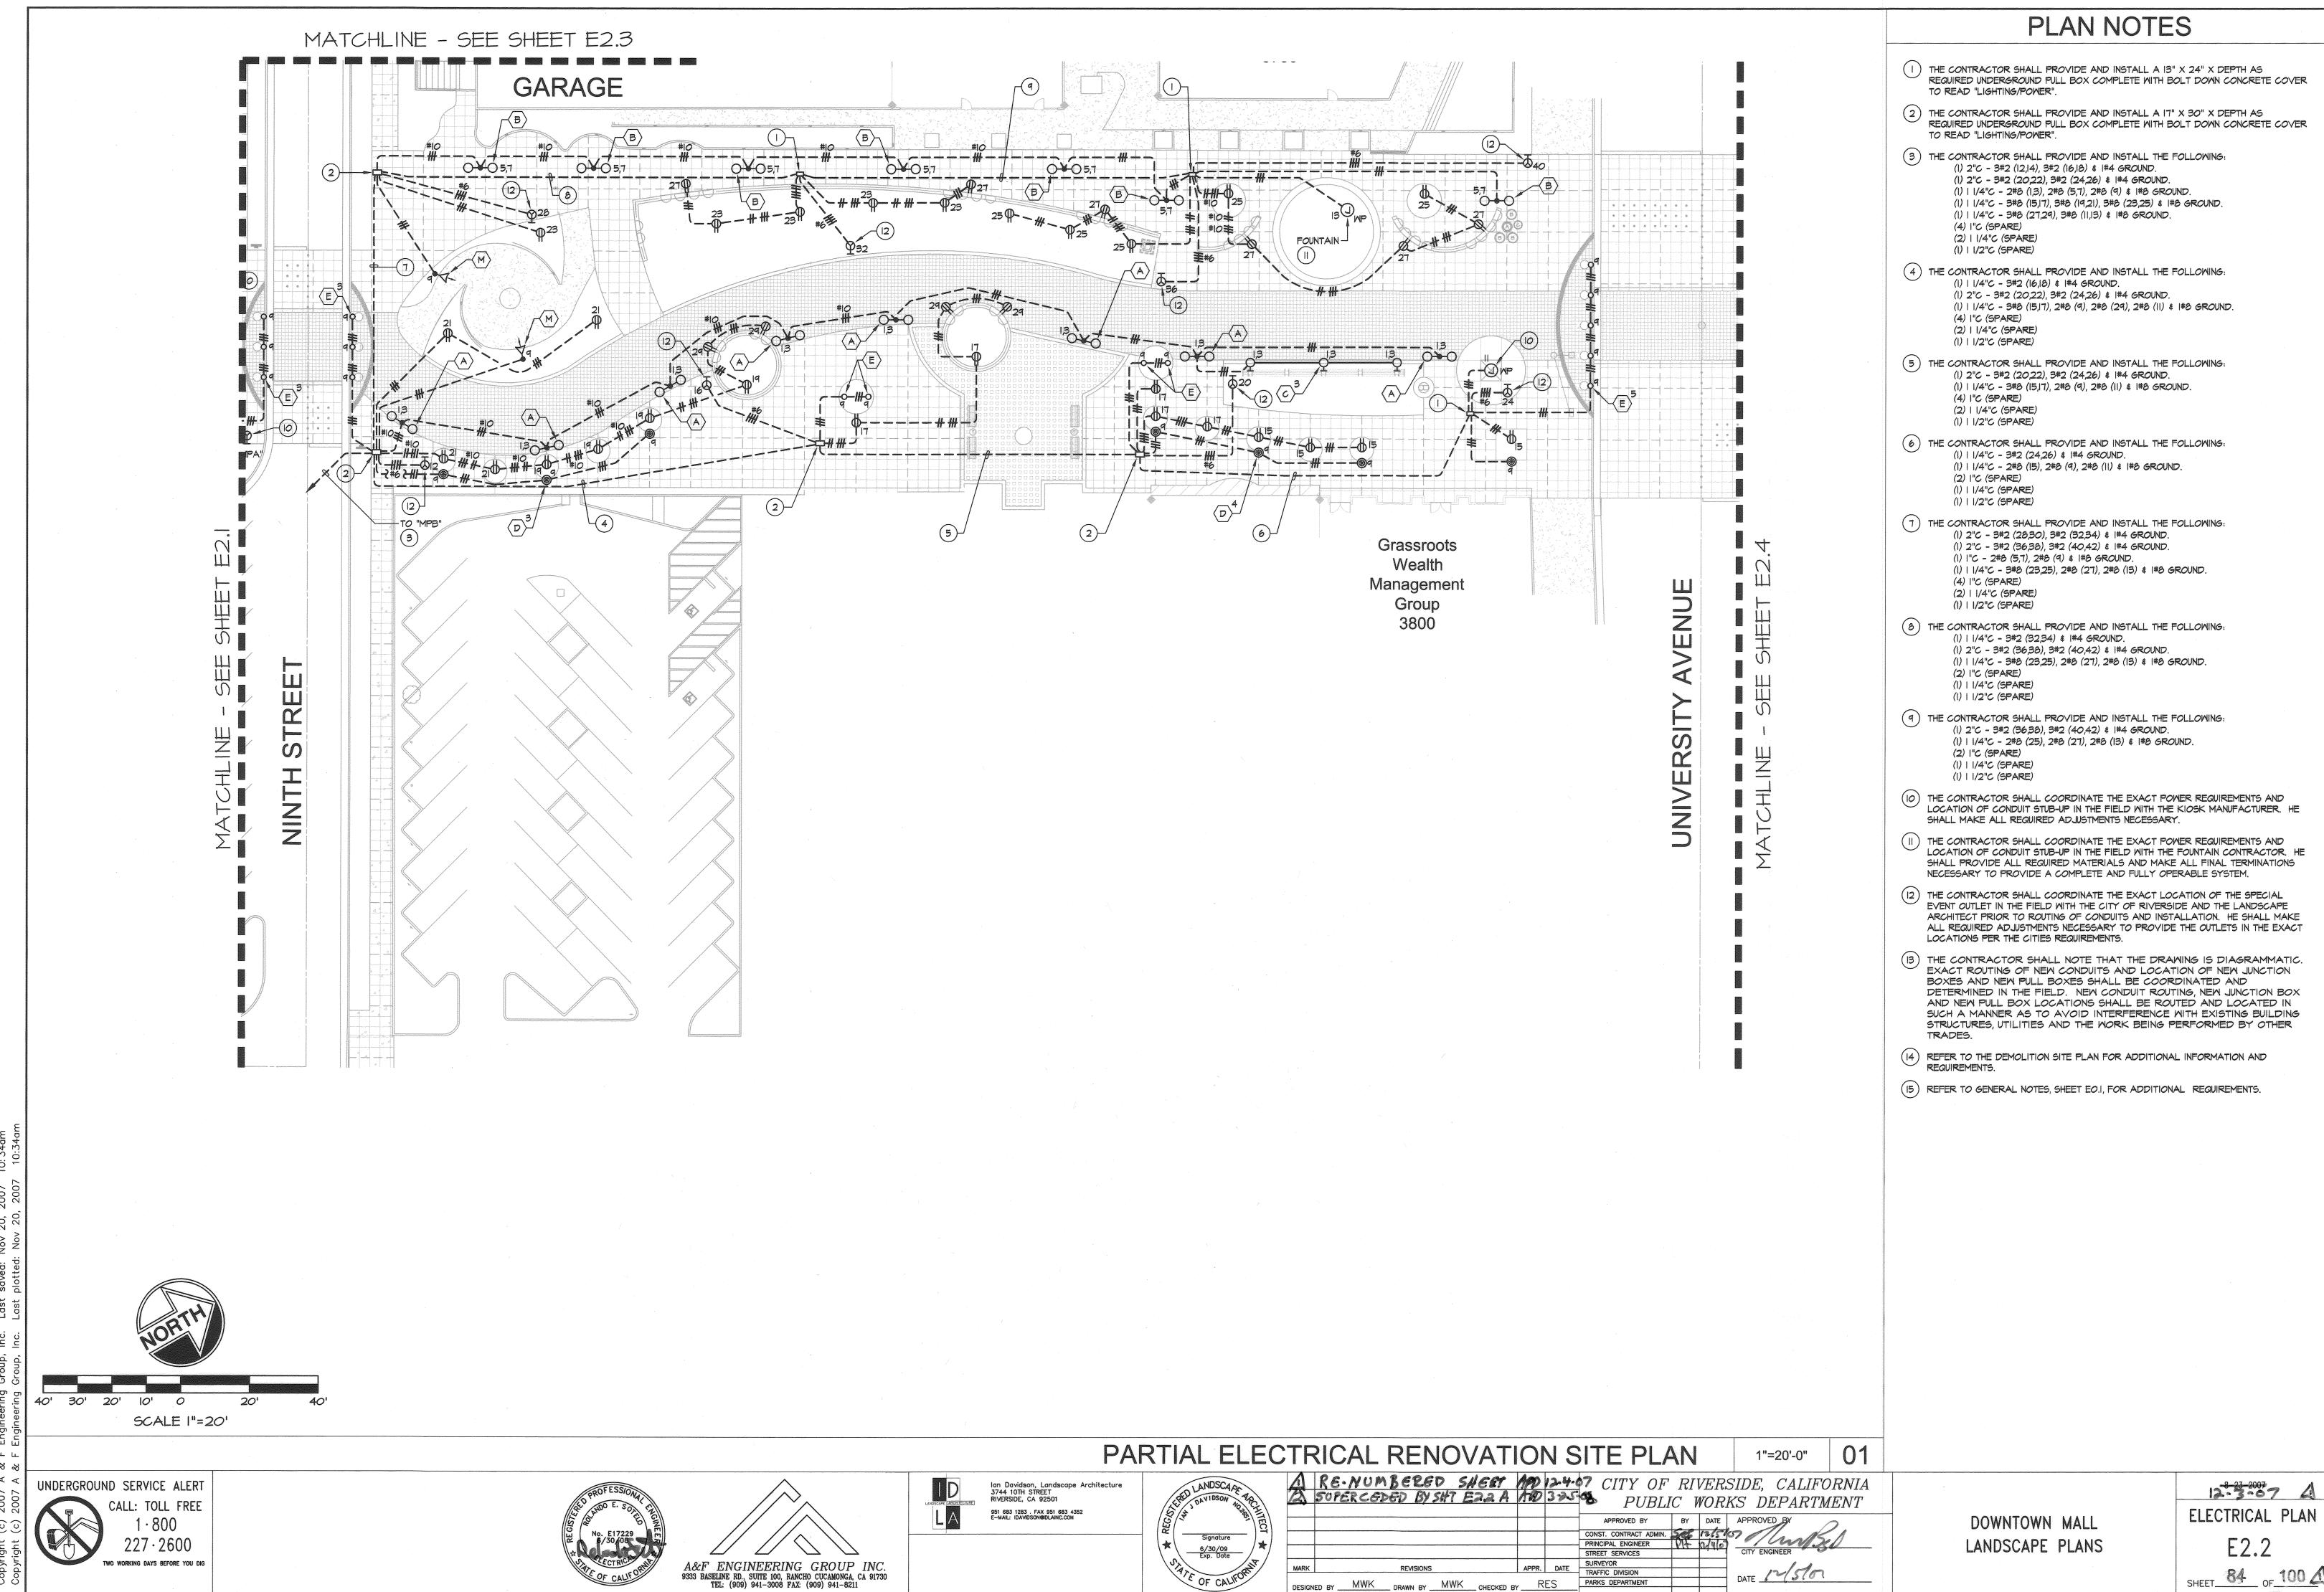

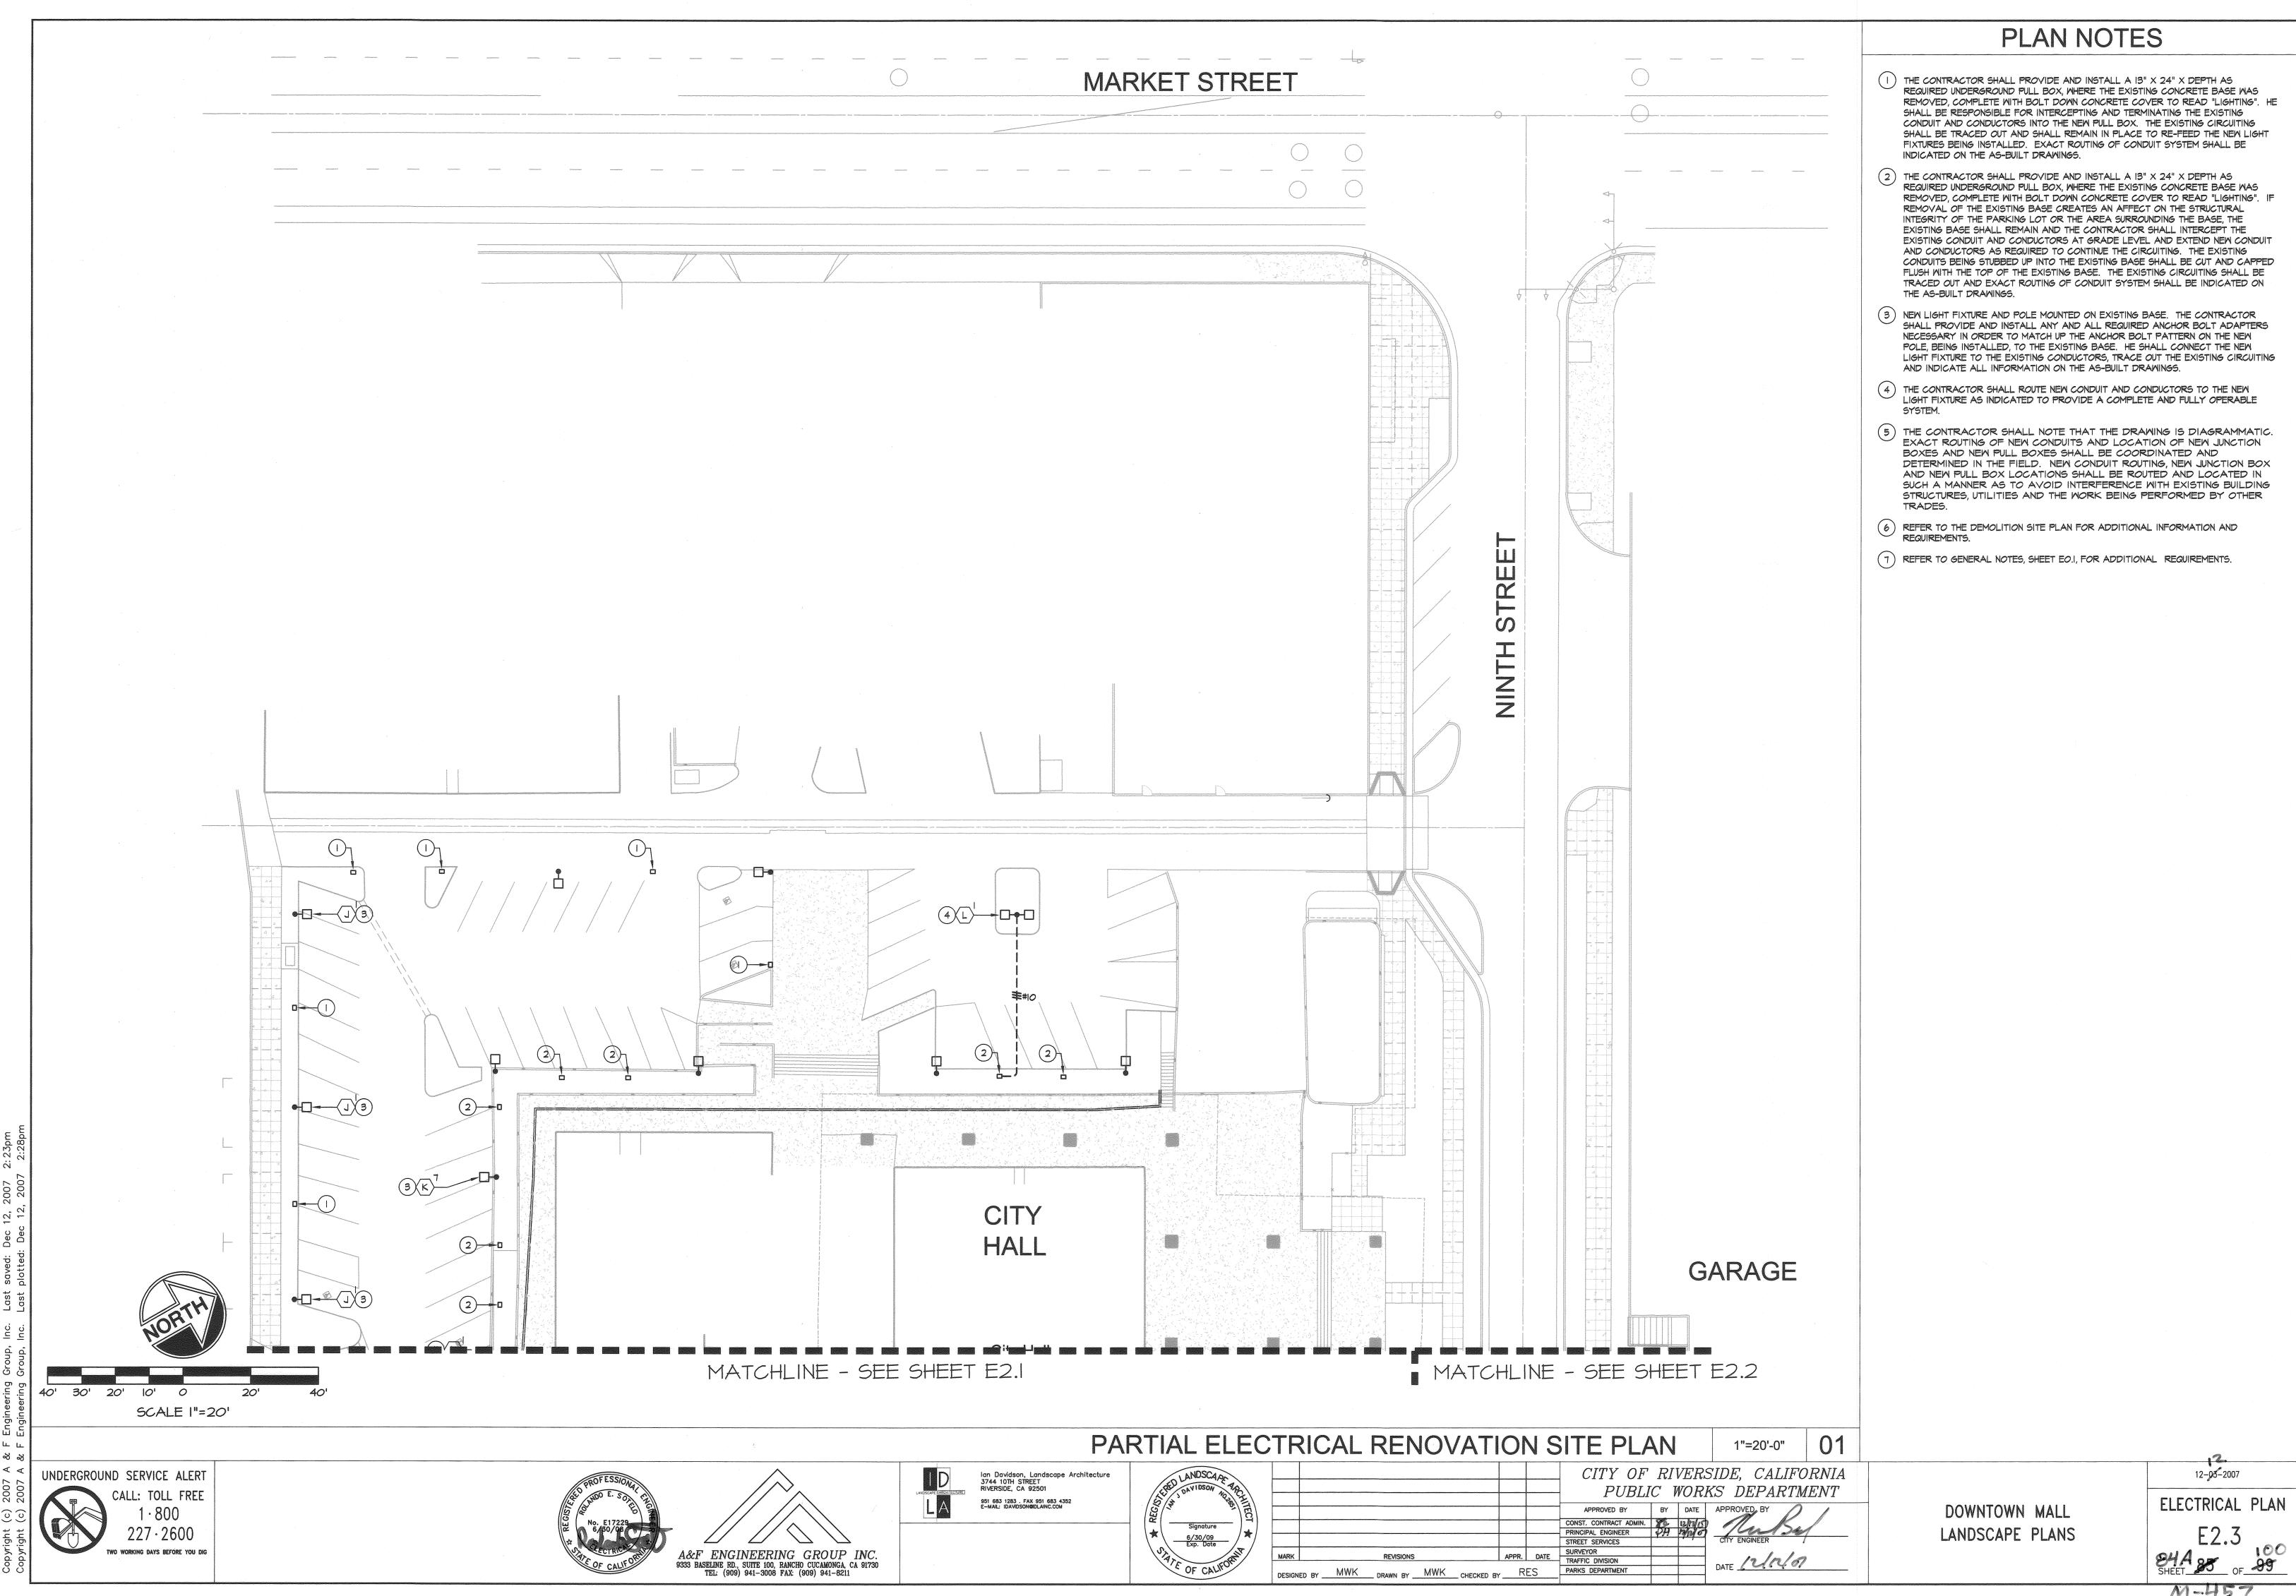

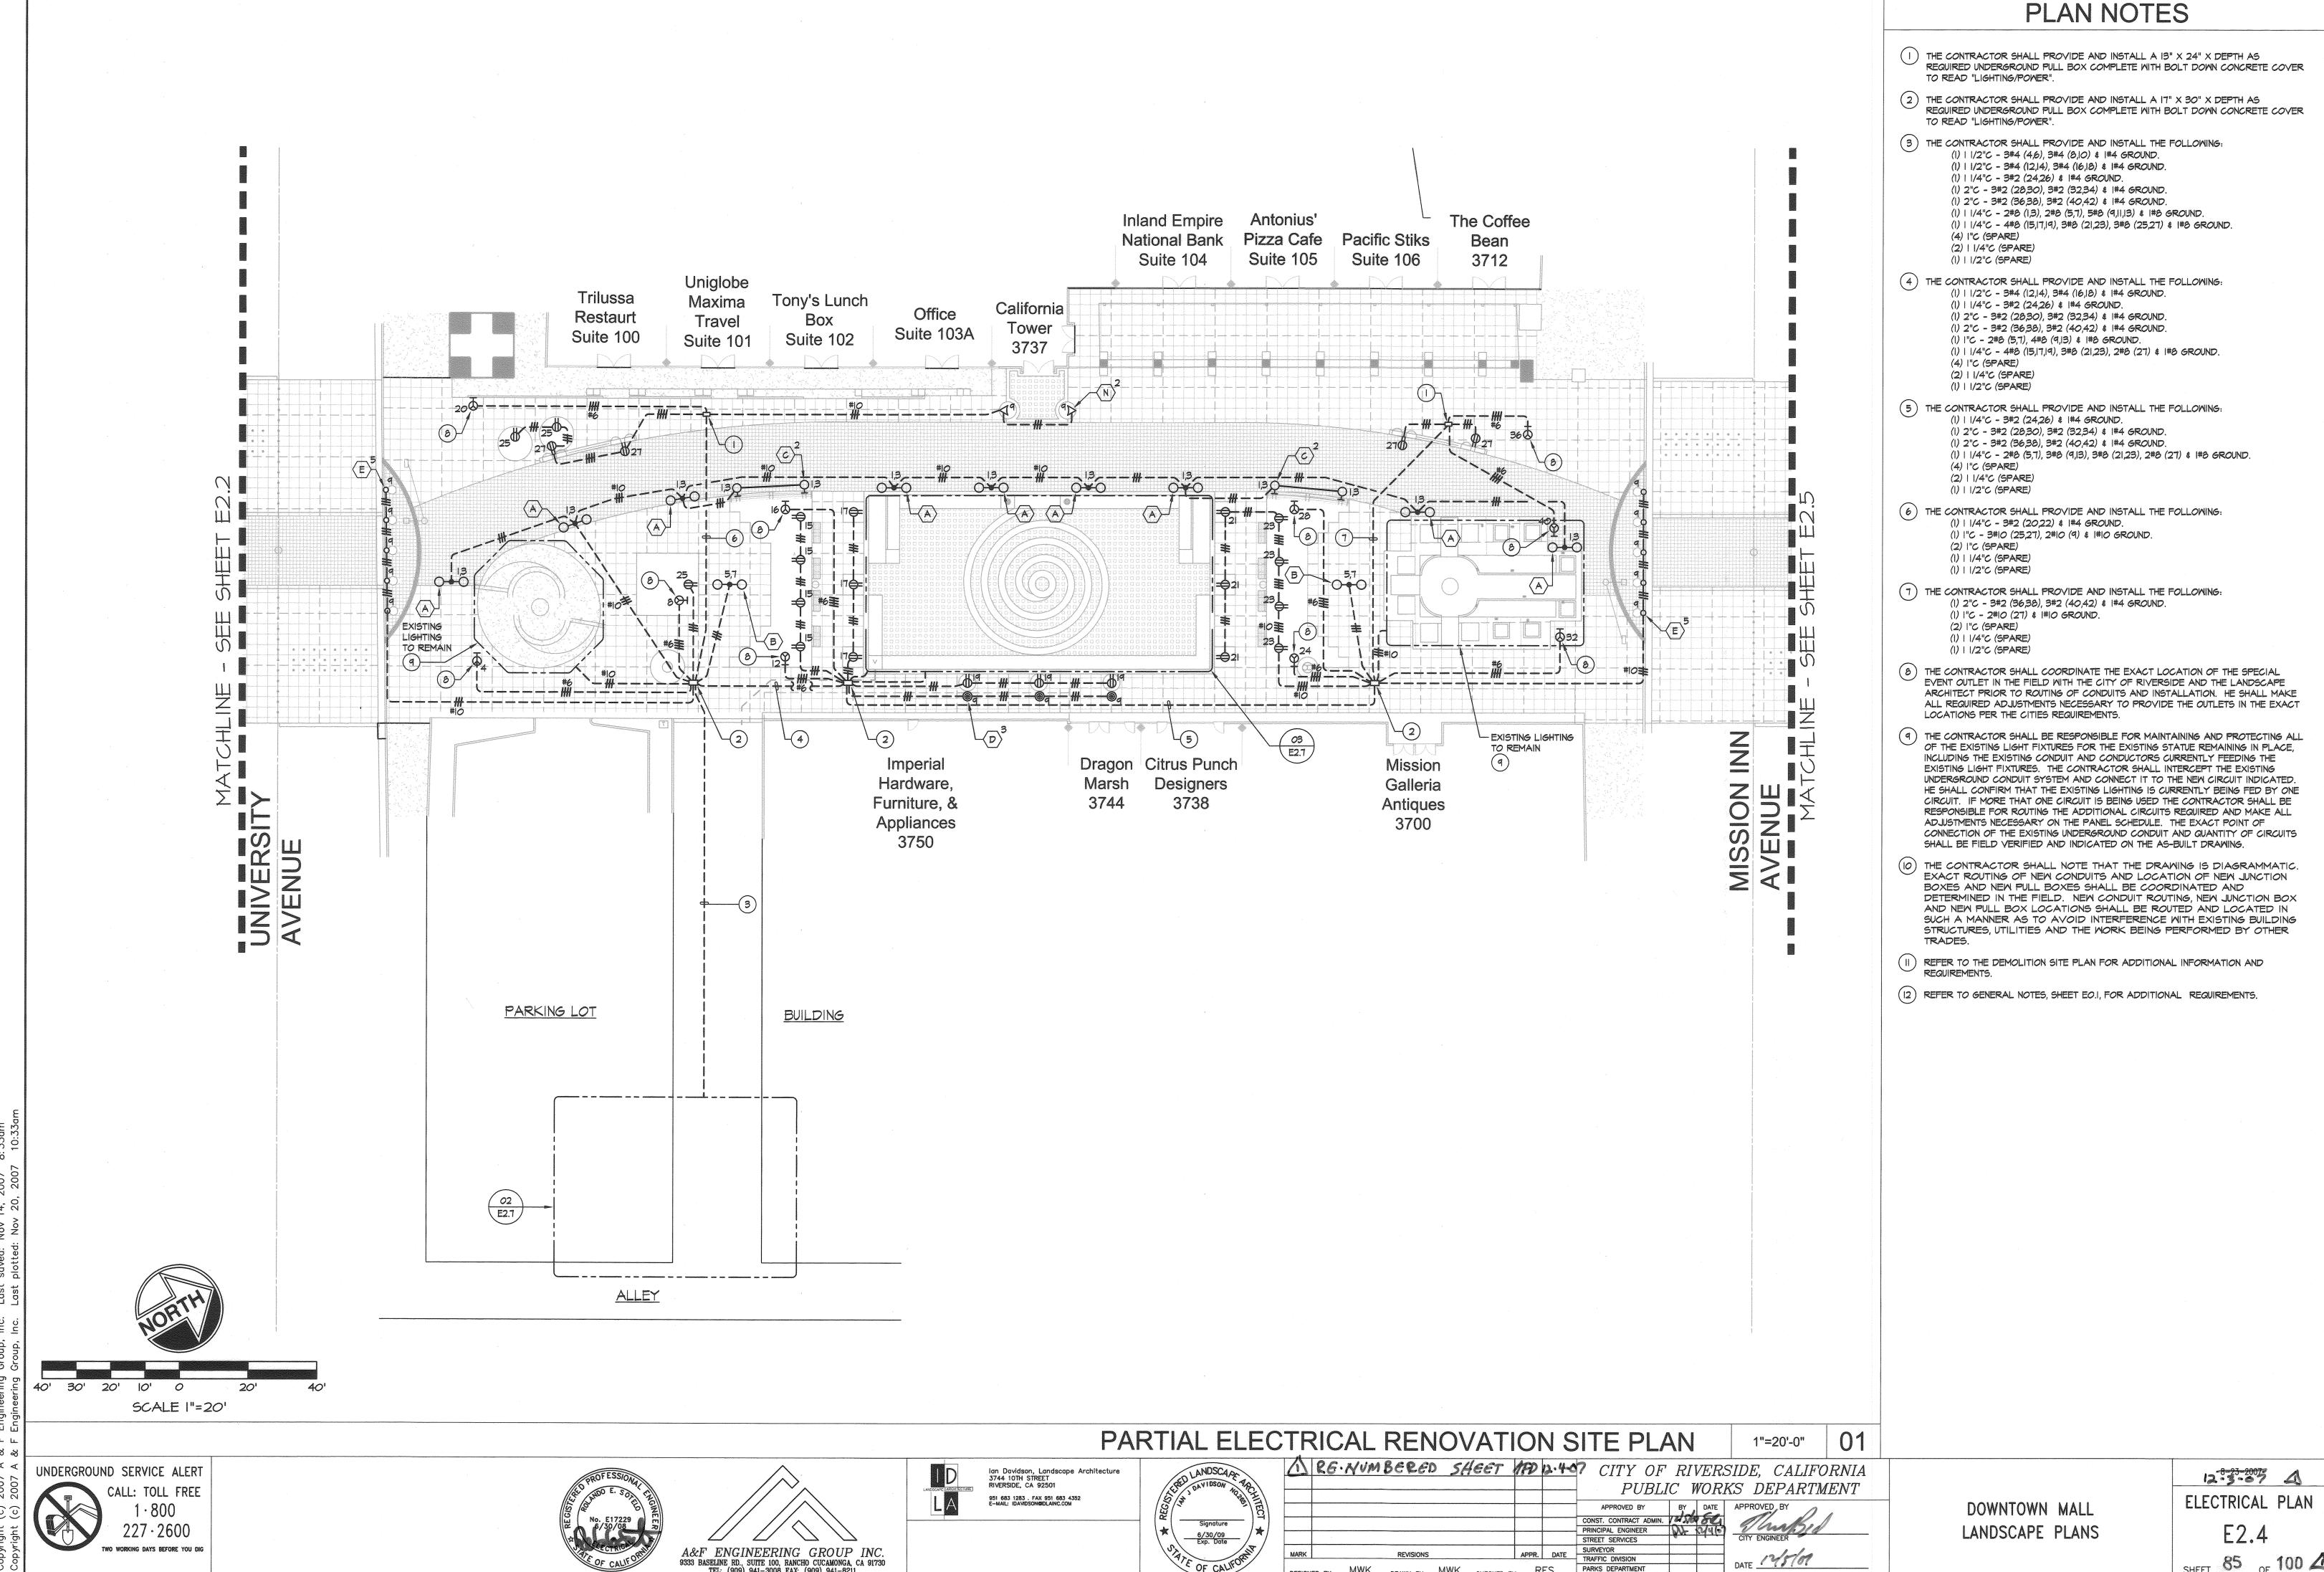

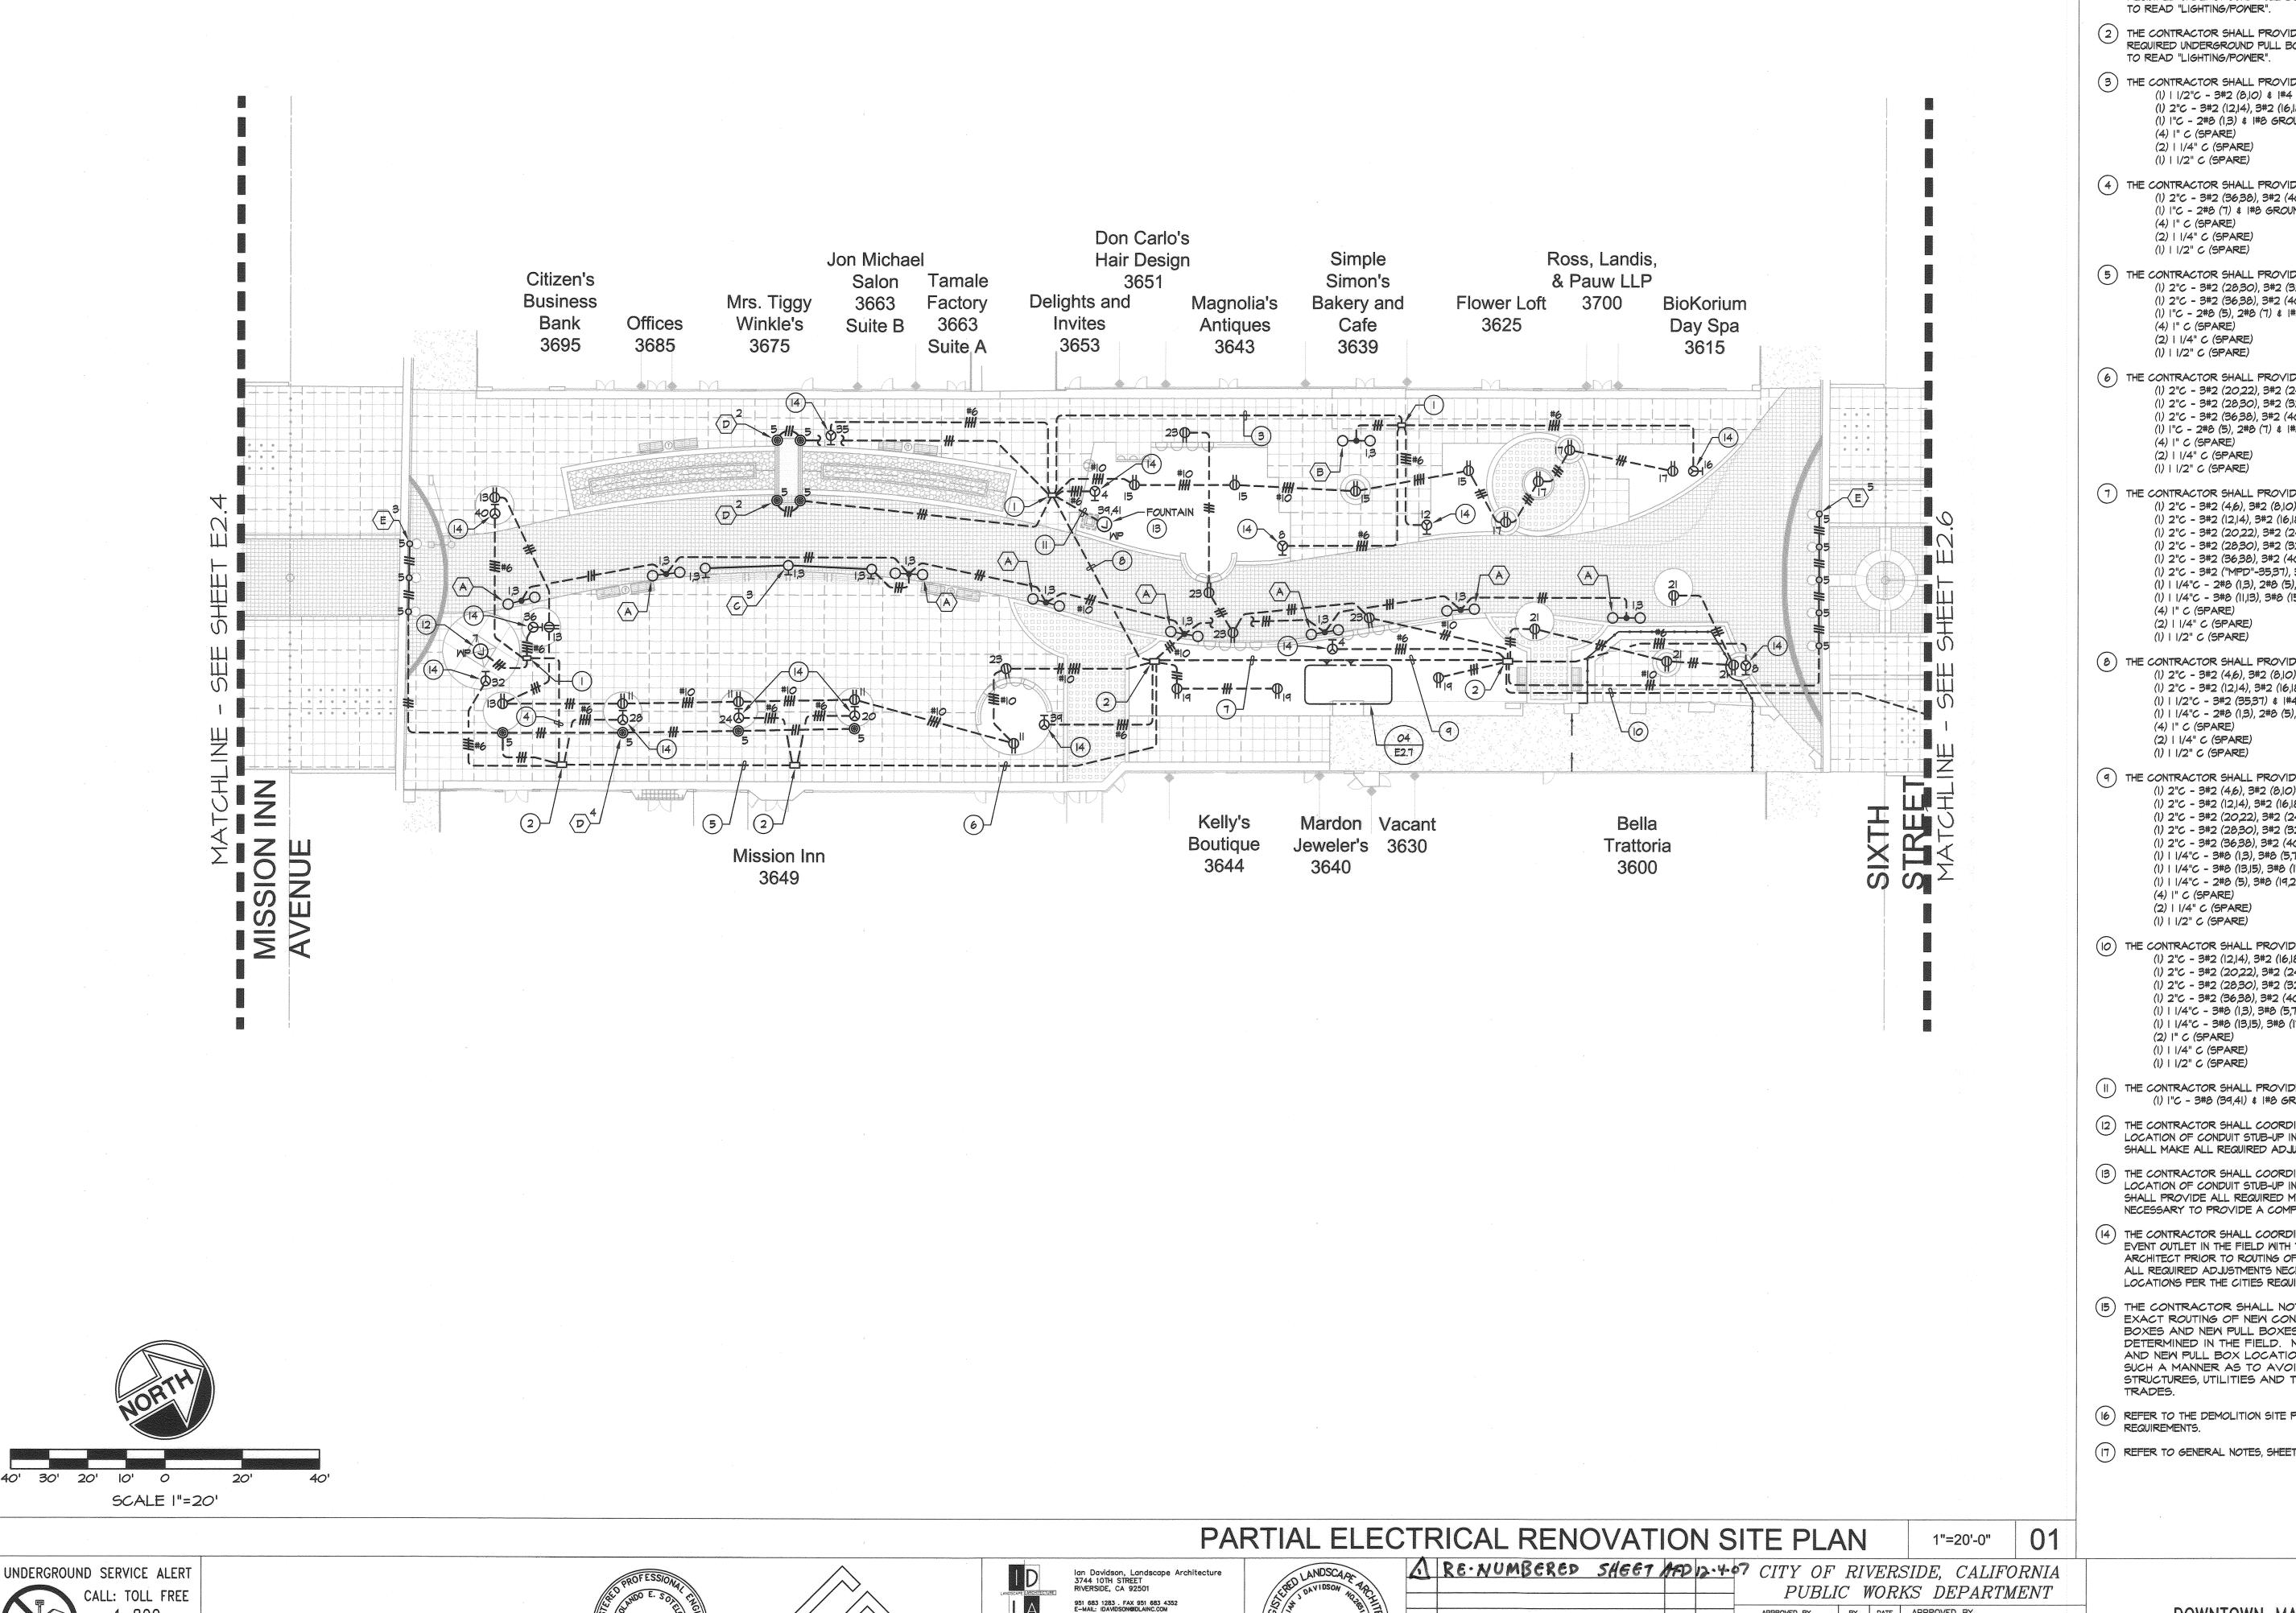Signature

6/30/09 Exp. Date

A&F ENGINEERING GROUP INC. 9333 BASELINE RD., SUITE 100, RANCHO CUCAMONGA, CA 91730 TEL: (909) 941-3008 FAX: (909) 941-8211

·800

TWO WORKING DAYS BEFORE YOU DIG

PLAN NOTES

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  ight)$  THE CONTRACTOR SHALL PROVIDE AND INSTALL A I3" imes 24" imes DEPTH AS REQUIRED UNDERGROUND PULL BOX COMPLETE WITH BOLT DOWN CONCRETE COVER
- 2) THE CONTRACTOR SHALL PROVIDE AND INSTALL A 17" X 30" X DEPTH AS REQUIRED UNDERGROUND PULL BOX COMPLETE WITH BOLT DOWN CONCRETE COVER
- (3) THE CONTRACTOR SHALL PROVIDE AND INSTALL THE FOLLOWING: (1) | 1/2"C - 3#2 (8,10) & 1#4 GROUND. ("MPD") (1) 2"C - 3#2 (12,14), 3#2 (16,18) \$ 1#4 GROUND. ("MPD") (1) 1"C - 2#8 (1,3) \$ 1#8 GROUND. ("MPD")
- (4) THE CONTRACTOR SHALL PROVIDE AND INSTALL THE FOLLOWING: (I) 2"C - 3#2 (36,38), 3#2 (40,42) \$ I#4 GROUND. ("MPD") (1) 1"C - 2#8 (7) & 1#8 GROUND. ("MPD")
- 5) THE CONTRACTOR SHALL PROVIDE AND INSTALL THE FOLLOWING: (1) 2"C - 3#2 (28,30), 3#2 (32,34) \$ 1#4 GROUND. ("MPD") (I) 2"C - 3#2 (36,38), 3#2 (40,42) \$ I#4 GROUND. ("MPD") (1) 1"C - 2#8 (5), 2#8 (7) \$ 1#8 GROUND. ("MPD")
- (6) THE CONTRACTOR SHALL PROVIDE AND INSTALL THE FOLLOWING: (I) 2"C - 3#2 (20,22), 3#2 (24,26) \$ |#4 GROUND. ("MPD") (I) 2"C - 3#2 (28,30), 3#2 (32,34) \$ I#4 GROUND. ("MPD") (I) 2"C - 3#2 (36,38), 3#2 (40,42) \$ I#4 GROUND. ("MPD") (1) 1"C - 2#8 (5), 2#8 (7) \$ 1#8 GROUND. ("MPD")
- (7) THE CONTRACTOR SHALL PROVIDE AND INSTALL THE FOLLOWING: (I) 2"C - 3#2 (4,6), 3#2 (8,10) \$ 1#4 GROUND. ("MPD") (1) 2"C - 3#2 (12,14), 3#2 (16,18) & 1#4 GROUND. ("MPD") (1) 2"C - 3#2 (20,22), 3#2 (24,26) & 1#4 GROUND. ("MPD") (1) 2"C - 3#2 (28,30), 3#2 (32,34) & 1#4 GROUND. ("MPD") (1) 2"C - 3#2 (36,38), 3#2 (40,42) & 1#4 GROUND. ("MPD") (1) 2"C - 3#2 ("MPD"-35,37), 3#2 ("MPE"-39,41) & 1#4 GROUND. (1) | 1/4"C - 2#8 (1,3), 2#8 (5), 2#8 (23), 3#8 (39,41) \$ 1#8 GROUND. ("MPD") (1) | 1/4"C - 3#8 (11,13), 3#8 (15,17), 2#8 (19), 2#8 (7) \$ 1#8 GROUND. ("MPD")
- (8) THE CONTRACTOR SHALL PROVIDE AND INSTALL THE FOLLOWING: (1) 2"C - 3#2 (4,6), 3#2 (8,10) \$ 1#4 GROUND. ("MPD") (1) 2"C - 3#2 (12,14), 3#2 (16,18) \$ 1#4 GROUND. ("MPD") (1) | 1/2"C - 3#2 (35,37) & |#4 GROUND. ("MPD") (1) | 1/4"C - 2#8 (1,3), 2#8 (5), 3#8 (15,17), 3#8 (39,41) \$ 1#8 GROUND. ("MPD")
- (9) THE CONTRACTOR SHALL PROVIDE AND INSTALL THE FOLLOWING: (I) 2"C - 3#2 (4,6), 3#2 (8,10) & I#4 GROUND. ("MPE") (I) 2"C - 3#2 (12,14), 3#2 (16,18) \$ 1#4 GROUND. ("MPE") (I) 2"C - 3#2 (20,22), 3#2 (24,26) & I#4 GROUND. ("MPE") (I) 2"C - 3#2 (28,30), 3#2 (32,34) \$ I#4 GROUND. ("MPE") (1) 2"C - 3#2 (36,38), 3#2 (40,42) \$ 1#4 GROUND. ("MPE") (I) | 1/4"C - 3#8 (1,3), 3#8 (5,7), 3#8 (9,11) \$ 1#8 GROUND. ("MPE") (I) I 1/4"C - 3#8 (13,15), 3#8 (17,19) \$ 1#8 GROUND. ("MPE") (1) | 1/4"C - 2#8 (5), 3#8 (19,21), 2#8 (23) & 1#8 GROUND. ("MPD")
- (IO) THE CONTRACTOR SHALL PROVIDE AND INSTALL THE FOLLOWING: (1) 2"C - 3#2 (12,14), 3#2 (16,18) \$ 1#4 GROUND. ("MPE") (I) 2"C - 3#2 (20,22), 3#2 (24,26) & I#4 GROUND. ("MPE") (1) 2"C - 3#2 (28,30), 3#2 (32,34) \$ 1#4 GROUND. ("MPE") (I) 2"C - 3#2 (36,38), 3#2 (40,42) & I#4 GROUND. ("MPE") (1) 1 1/4"C - 3#8 (1,3), 3#8 (5,7), 3#8 (9,11) \$ 1#8 GROUND. ("MPE") (1) | 1/4"C - 3#8 (13,15), 3#8 (17,19) & 1#8 GROUND. ("MPE")
- (II) THE CONTRACTOR SHALL PROVIDE AND INSTALL THE FOLLOWING: (1) 1"C - 3#8 (39,41) & 1#8 GROUND.
- 12 THE CONTRACTOR SHALL COORDINATE THE EXACT POWER REQUIREMENTS AND LOCATION OF CONDUIT STUB-UP IN THE FIELD WITH THE KIOSK MANUFACTURER. HE SHALL MAKE ALL REQUIRED ADJUSTMENTS NECESSARY.
- 13 THE CONTRACTOR SHALL COORDINATE THE EXACT POWER REQUIREMENTS AND LOCATION OF CONDUIT STUB-UP IN THE FIELD WITH THE FOUNTAIN CONTRACTOR. HE SHALL PROVIDE ALL REQUIRED MATERIALS AND MAKE ALL FINAL TERMINATIONS NECESSARY TO PROVIDE A COMPLETE AND FULLY OPERABLE SYSTEM.
- 14 THE CONTRACTOR SHALL COORDINATE THE EXACT LOCATION OF THE SPECIAL EVENT OUTLET IN THE FIELD WITH THE CITY OF RIVERSIDE AND THE LANDSCAPE ARCHITECT PRIOR TO ROUTING OF CONDUITS AND INSTALLATION. HE SHALL MAKE ALL REQUIRED ADJUSTMENTS NECESSARY TO PROVIDE THE OUTLETS IN THE EXACT LOCATIONS PER THE CITIES REQUIREMENTS.
- 15) THE CONTRACTOR SHALL NOTE THAT THE DRAWING IS DIAGRAMMATIC. EXACT ROUTING OF NEW CONDUITS AND LOCATION OF NEW JUNCTION BOXES AND NEW PULL BOXES SHALL BE COORDINATED AND DETERMINED IN THE FIELD. NEW CONDUIT ROUTING, NEW JUNCTION BOX AND NEW PULL BOX LOCATIONS SHALL BE ROUTED AND LOCATED IN SUCH A MANNER AS TO AVOID INTERFERENCE WITH EXISTING BUILDING STRUCTURES, UTILITIES AND THE WORK BEING PERFORMED BY OTHER
- REFER TO THE DEMOLITION SITE PLAN FOR ADDITIONAL INFORMATION AND
- (17) REFER TO GENERAL NOTES, SHEET EO.I, FOR ADDITIONAL REQUIREMENTS.


DOWNTOWN MALL LANDSCAPE PLANS

APPROVED BY

APPR. DATE SURVEYOR TRAFFIC DIVISION

__ DRAWN BY _____ CHECKED BY ____ RES ____ PARKS DEPARTMENT

12.3-07 ELECTRICAL PLAN

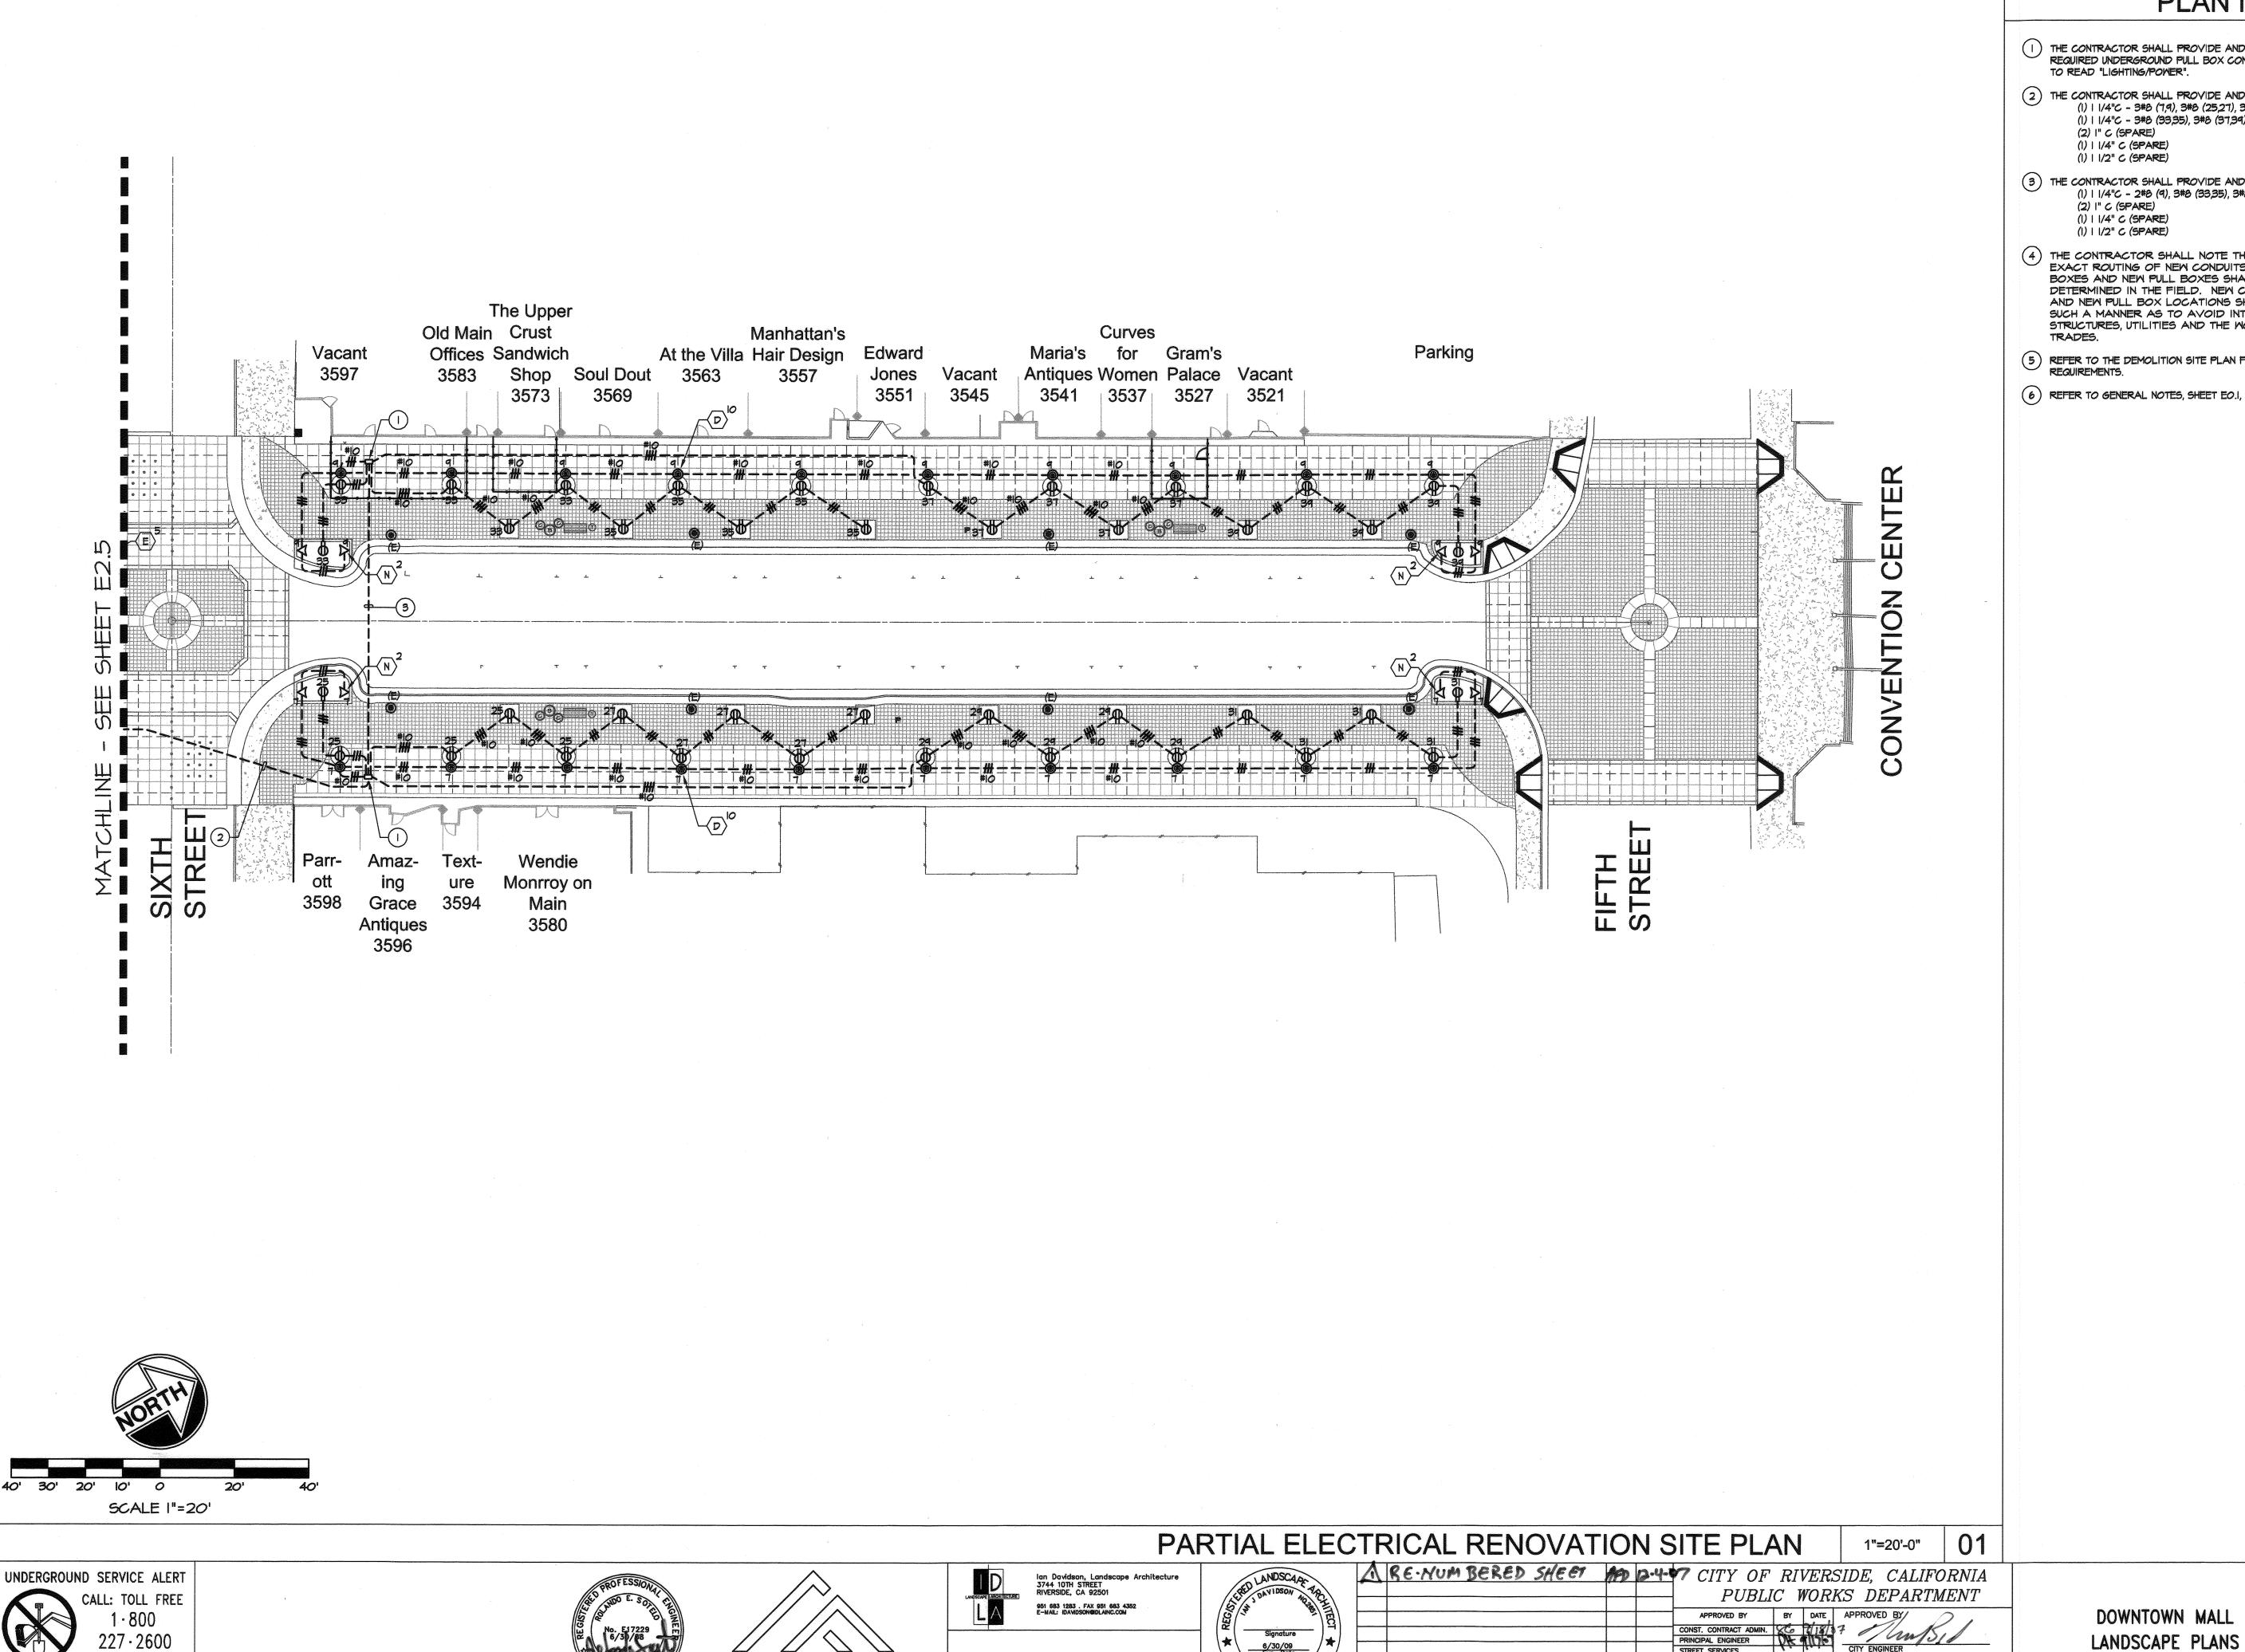

THE CONTRACTOR SHALL PROVIDE AND INSTALL A 13" X 24" X DEPTH AS REQUIRED UNDERGROUND PULL BOX COMPLETE WITH BOLT DOWN CONCRETE COVER

2) THE CONTRACTOR SHALL PROVIDE AND INSTALL THE FOLLOWING: (1) | 1/4"C - 3#8 (7,9), 3#8 (25,27), 3#8 (29,31) & 1#8 GROUND. (1) 1 1/4"C - 3#8 (33,35), 3#8 (37,39) \$ 1#8 GROUND.


3 THE CONTRACTOR SHALL PROVIDE AND INSTALL THE FOLLOWING:
(1) | 1/4"C - 2#8 (9), 3#8 (33,35), 3#8 (37,39) & 1#8 GROUND.
(2) | 1" C (SPARE)

THE CONTRACTOR SHALL NOTE THAT THE DRAWING IS DIAGRAMMATIC. EXACT ROUTING OF NEW CONDUITS AND LOCATION OF NEW JUNCTION BOXES AND NEW PULL BOXES SHALL BE COORDINATED AND DETERMINED IN THE FIELD. NEW CONDUIT ROUTING, NEW JUNCTION BOX AND NEW PULL BOX LOCATIONS SHALL BE ROUTED AND LOCATED IN SUCH A MANNER AS TO AVOID INTERFERENCE WITH EXISTING BUILDING STRUCTURES, UTILITIES AND THE WORK BEING PERFORMED BY OTHER

5 REFER TO THE DEMOLITION SITE PLAN FOR ADDITIONAL INFORMATION AND REQUIREMENTS.

6) REFER TO GENERAL NOTES, SHEET EO.I, FOR ADDITIONAL REQUIREMENTS.

12-3-2007 ELECTRICAL PLAN E2.6 SHEET 87 OF 984

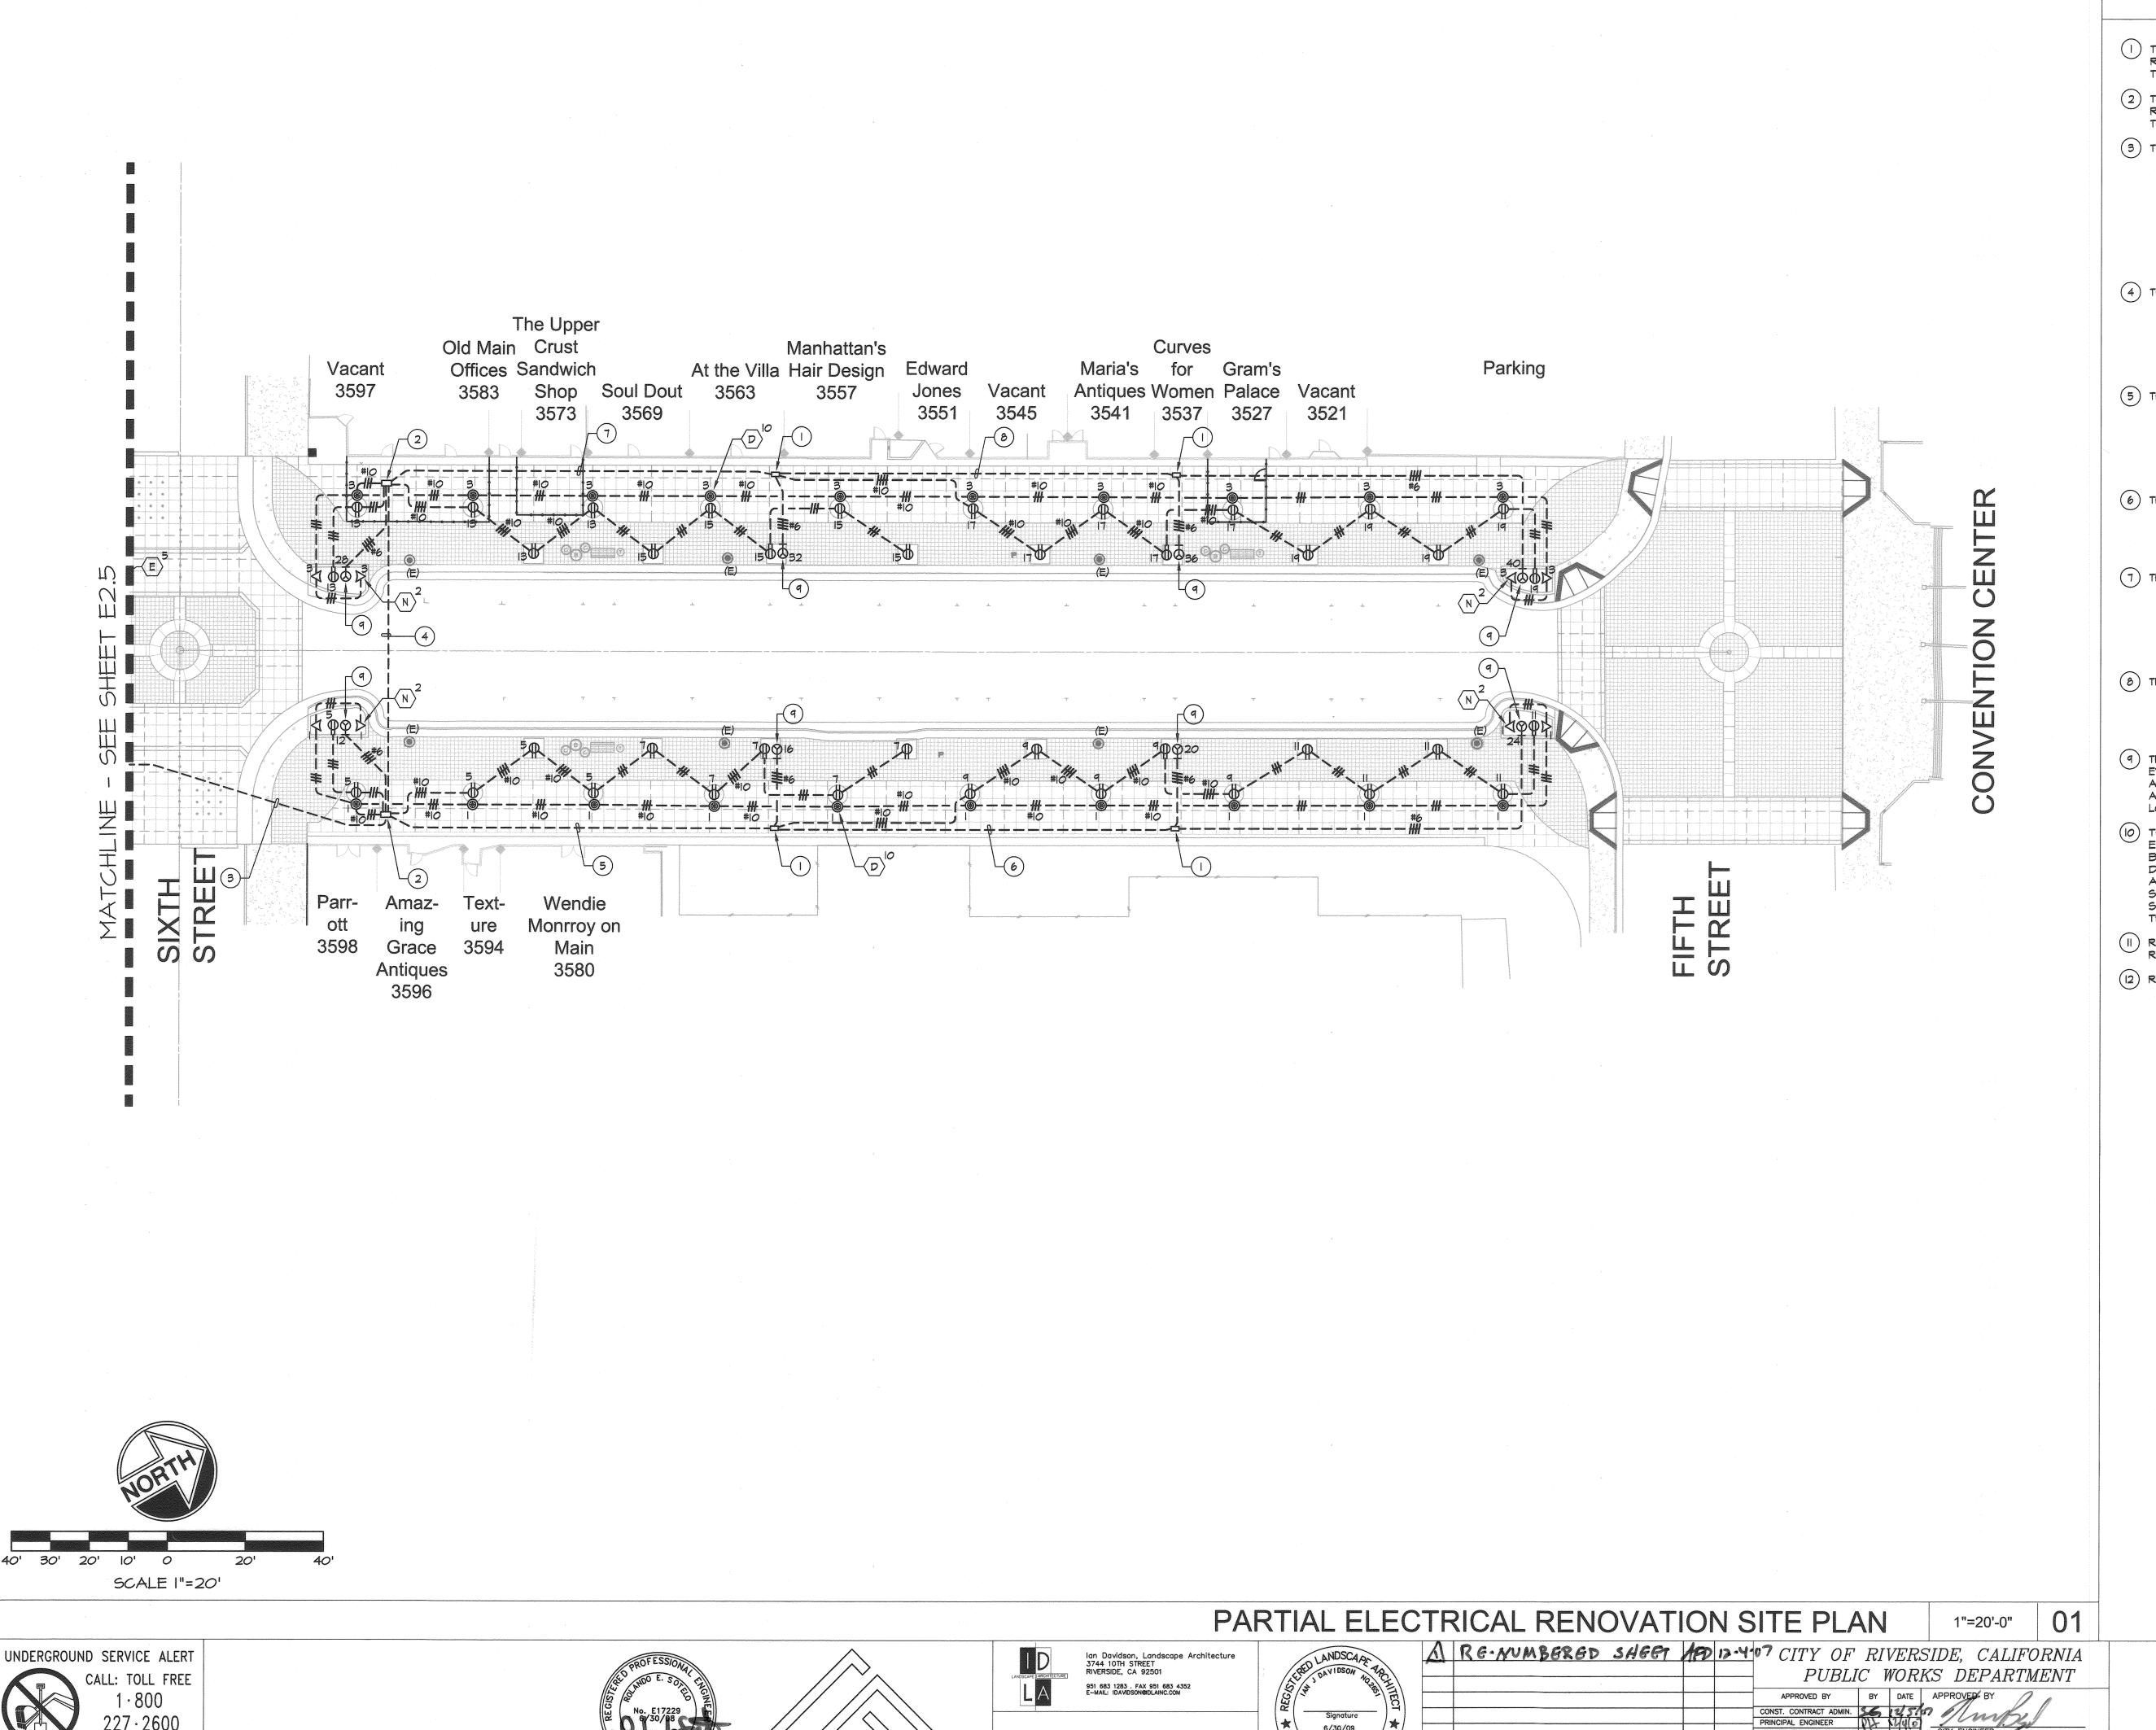

( I ) THE CONTRACTOR SHALL PROVIDE AND INSTALL A 13" X 24" X DEPTH AS REQUIRED UNDERGROUND PULL BOX COMPLETE WITH BOLT DOWN CONCRETE COVER TO READ "LIGHTING/POWER".

2 THE CONTRACTOR SHALL PROVIDE AND INSTALL A 17" X 30" X DEPTH AS REQUIRED UNDERGROUND PULL BOX COMPLETE WITH BOLT DOWN CONCRETE COVER TO READ "LIGHTING/POWER".

3 THE CONTRACTOR SHALL PROVIDE AND INSTALL THE FOLLOWING: (1) 2"C - 3#2 (12,14), 3#2 (16,18) & 1#4 GROUND. (I) 2"C - 3#2 (20,22), 3#2 (24,26) \$ I#4 GROUND. (1) 2"C - 3#2 (28,30), 3#2 (32,34) \$ 1#4 GROUND. (1) 2"C - 3#2 (36,38), 3#2 (40,42) & 1#4 GROUND. (I) I 1/4"C - 3#8 (I,3), 3#8 (5,7), 3#8 (9,11) & 1#8 GROUND. (1) | 1/4"C - 3#8 (13,15), 3#8 (17,19) & 1#8 GROUND. (2) I" C (SPARE) (1) 1 1/4" C (SPARE)

4) THE CONTRACTOR SHALL PROVIDE AND INSTALL THE FOLLOWING: (I) 2"C - 3#2 (28,30), 3#2 (32,34) \$ I#4 GROUND. (I) 2"C - 3#2 (36,38), 3#2 (40,42) \$ I#4 GROUND. (1) 1 1/4"C - 2#8 (3), 3#8 (13,15), 3#8 (17,19) \$ 1#8 GROUND. (2) I" C (SPARE) (I) I 1/4" C (SPARE)

5 THE CONTRACTOR SHALL PROVIDE AND INSTALL THE FOLLOWING: (1) | 1/2"C - 3#2 (16,18) & 1#4 GROUND. (1) 2"C - 3#2 (20,22), 3#2 (24,26) \$ 1#4 GROUND. (1) | "C - 3#8 (9,11) & 1#8 GROUND.

(2) I" C (SPARE) (1) 1 1/4" C (SPARE) (I) I I/2" C (SPARE)

(I) I 1/2" C (SPARE)

(I) I 1/2" C (SPARE)

(6) THE CONTRACTOR SHALL PROVIDE AND INSTALL THE FOLLOWING: (I) 2"C - 3#2 (20,22), 3#2 (24,26) \$ I#4 GROUND. (2) I" C (SPARE) (I) I 1/4" C (SPARE)

(I) I I/2" C (SPARE)

7) THE CONTRACTOR SHALL PROVIDE AND INSTALL THE FOLLOWING: (1) | 1/2"C - 3#2 (32,34) & 1#4 GROUND. (1) 2"C - 3#2 (36,38), 3#2 (40,42) & 1#4 GROUND. (1) | "C - 3#8 (17,19) & 1#8 GROUND.

(2) I" C (SPARE) (I) I 1/4" C (SPARE) (I) I 1/2" C (SPARE)

(I) I 1/2" C (SPARE)

(8) THE CONTRACTOR SHALL PROVIDE AND INSTALL THE FOLLOWING: (I) 2"C - 3#2 (36,38), 3#2 (40,42) & I#4 GROUND. (2) | C (SPARE) (1) 1 1/4" C (SPARE)

(9) THE CONTRACTOR SHALL COORDINATE THE EXACT LOCATION OF THE SPECIAL EVENT OUTLET IN THE FIELD WITH THE CITY OF RIVERSIDE AND THE LANDSCAPE ARCHITECT PRIOR TO ROUTING OF CONDUITS AND INSTALLATION. HE SHALL MAKE ALL REQUIRED ADJUSTMENTS NECESSARY TO PROVIDE THE OUTLETS IN THE EXACT LOCATIONS PER THE CITIES REQUIREMENTS.

(10) THE CONTRACTOR SHALL NOTE THAT THE DRAWING IS DIAGRAMMATIC. EXACT ROUTING OF NEW CONDUITS AND LOCATION OF NEW JUNCTION BOXES AND NEW PULL BOXES SHALL BE COORDINATED AND DETERMINED IN THE FIELD. NEW CONDUIT ROUTING, NEW JUNCTION BOX AND NEW PULL BOX LOCATIONS SHALL BE ROUTED AND LOCATED IN SUCH A MANNER AS TO AVOID INTERFERENCE WITH EXISTING BUILDING STRUCTURES, UTILITIES AND THE WORK BEING PERFORMED BY OTHER TRADES.


(II) REFER TO THE DEMOLITION SITE PLAN FOR ADDITIONAL INFORMATION AND


(12) REFER TO GENERAL NOTES, SHEET EO.I, FOR ADDITIONAL REQUIREMENTS.

DOWNTOWN MALL LANDSCAPE PLANS

12-3-07 ELECTRICAL PLAN E2.6 SHEET 88 OF 100 A



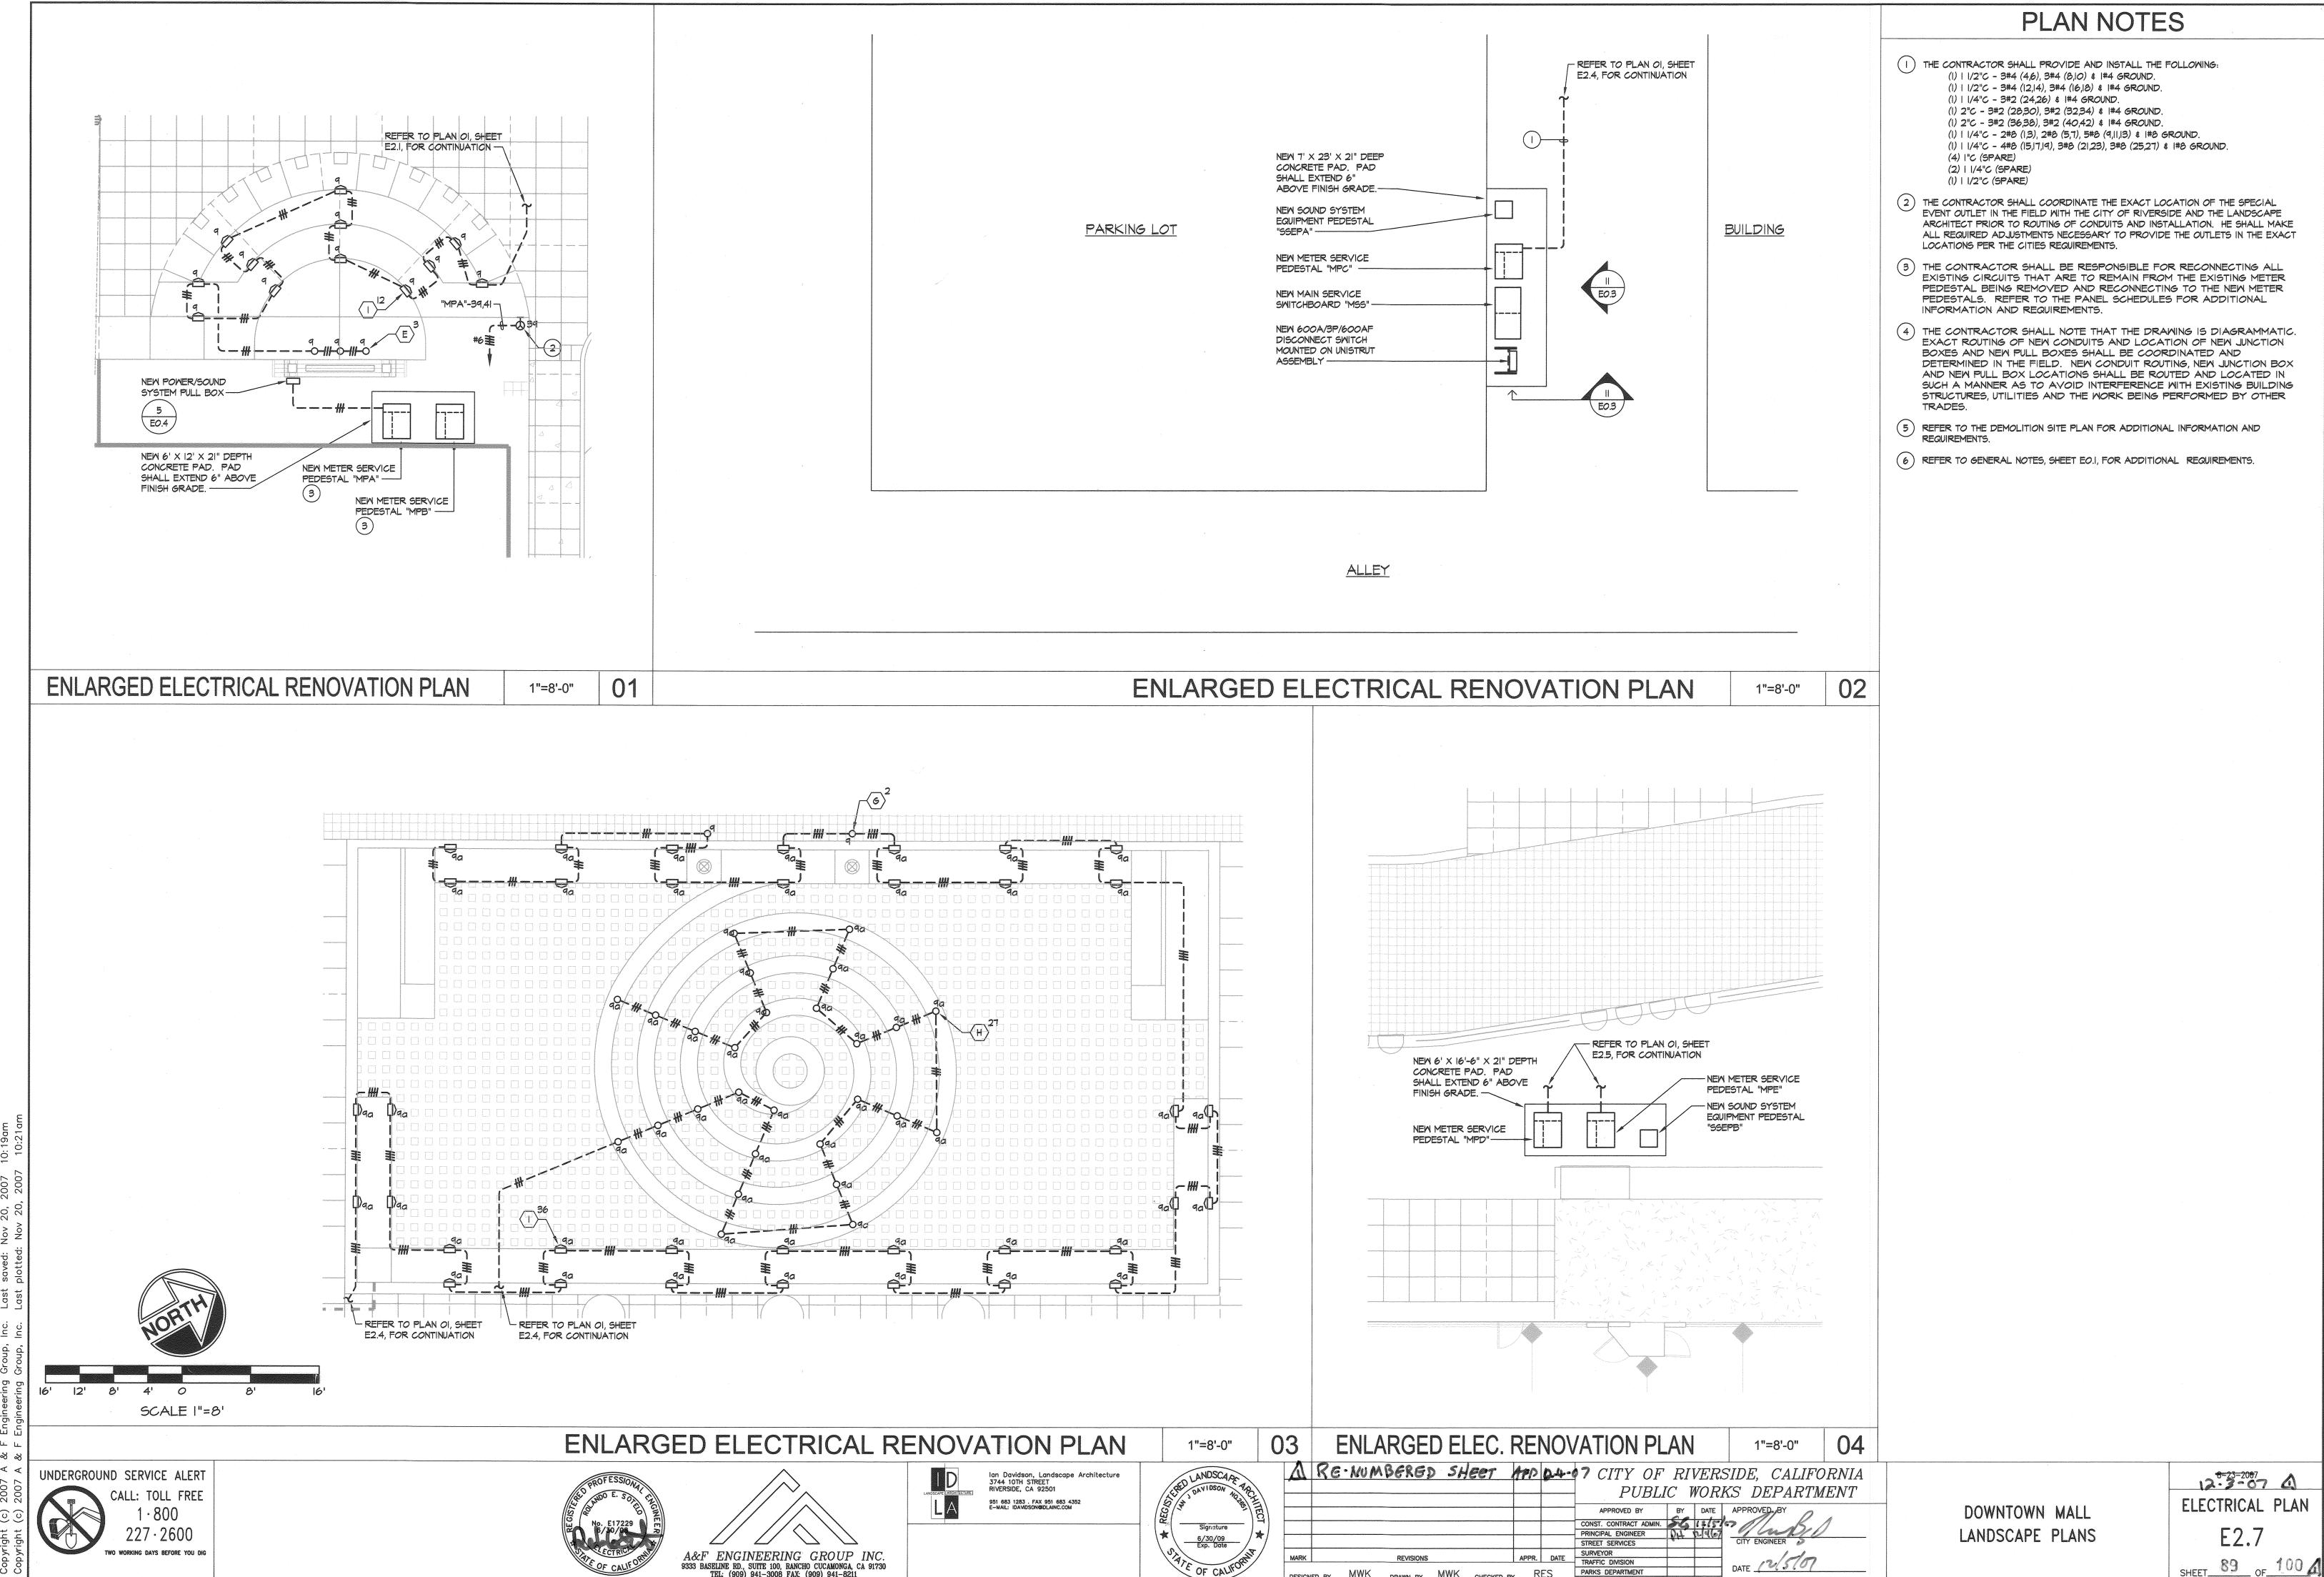

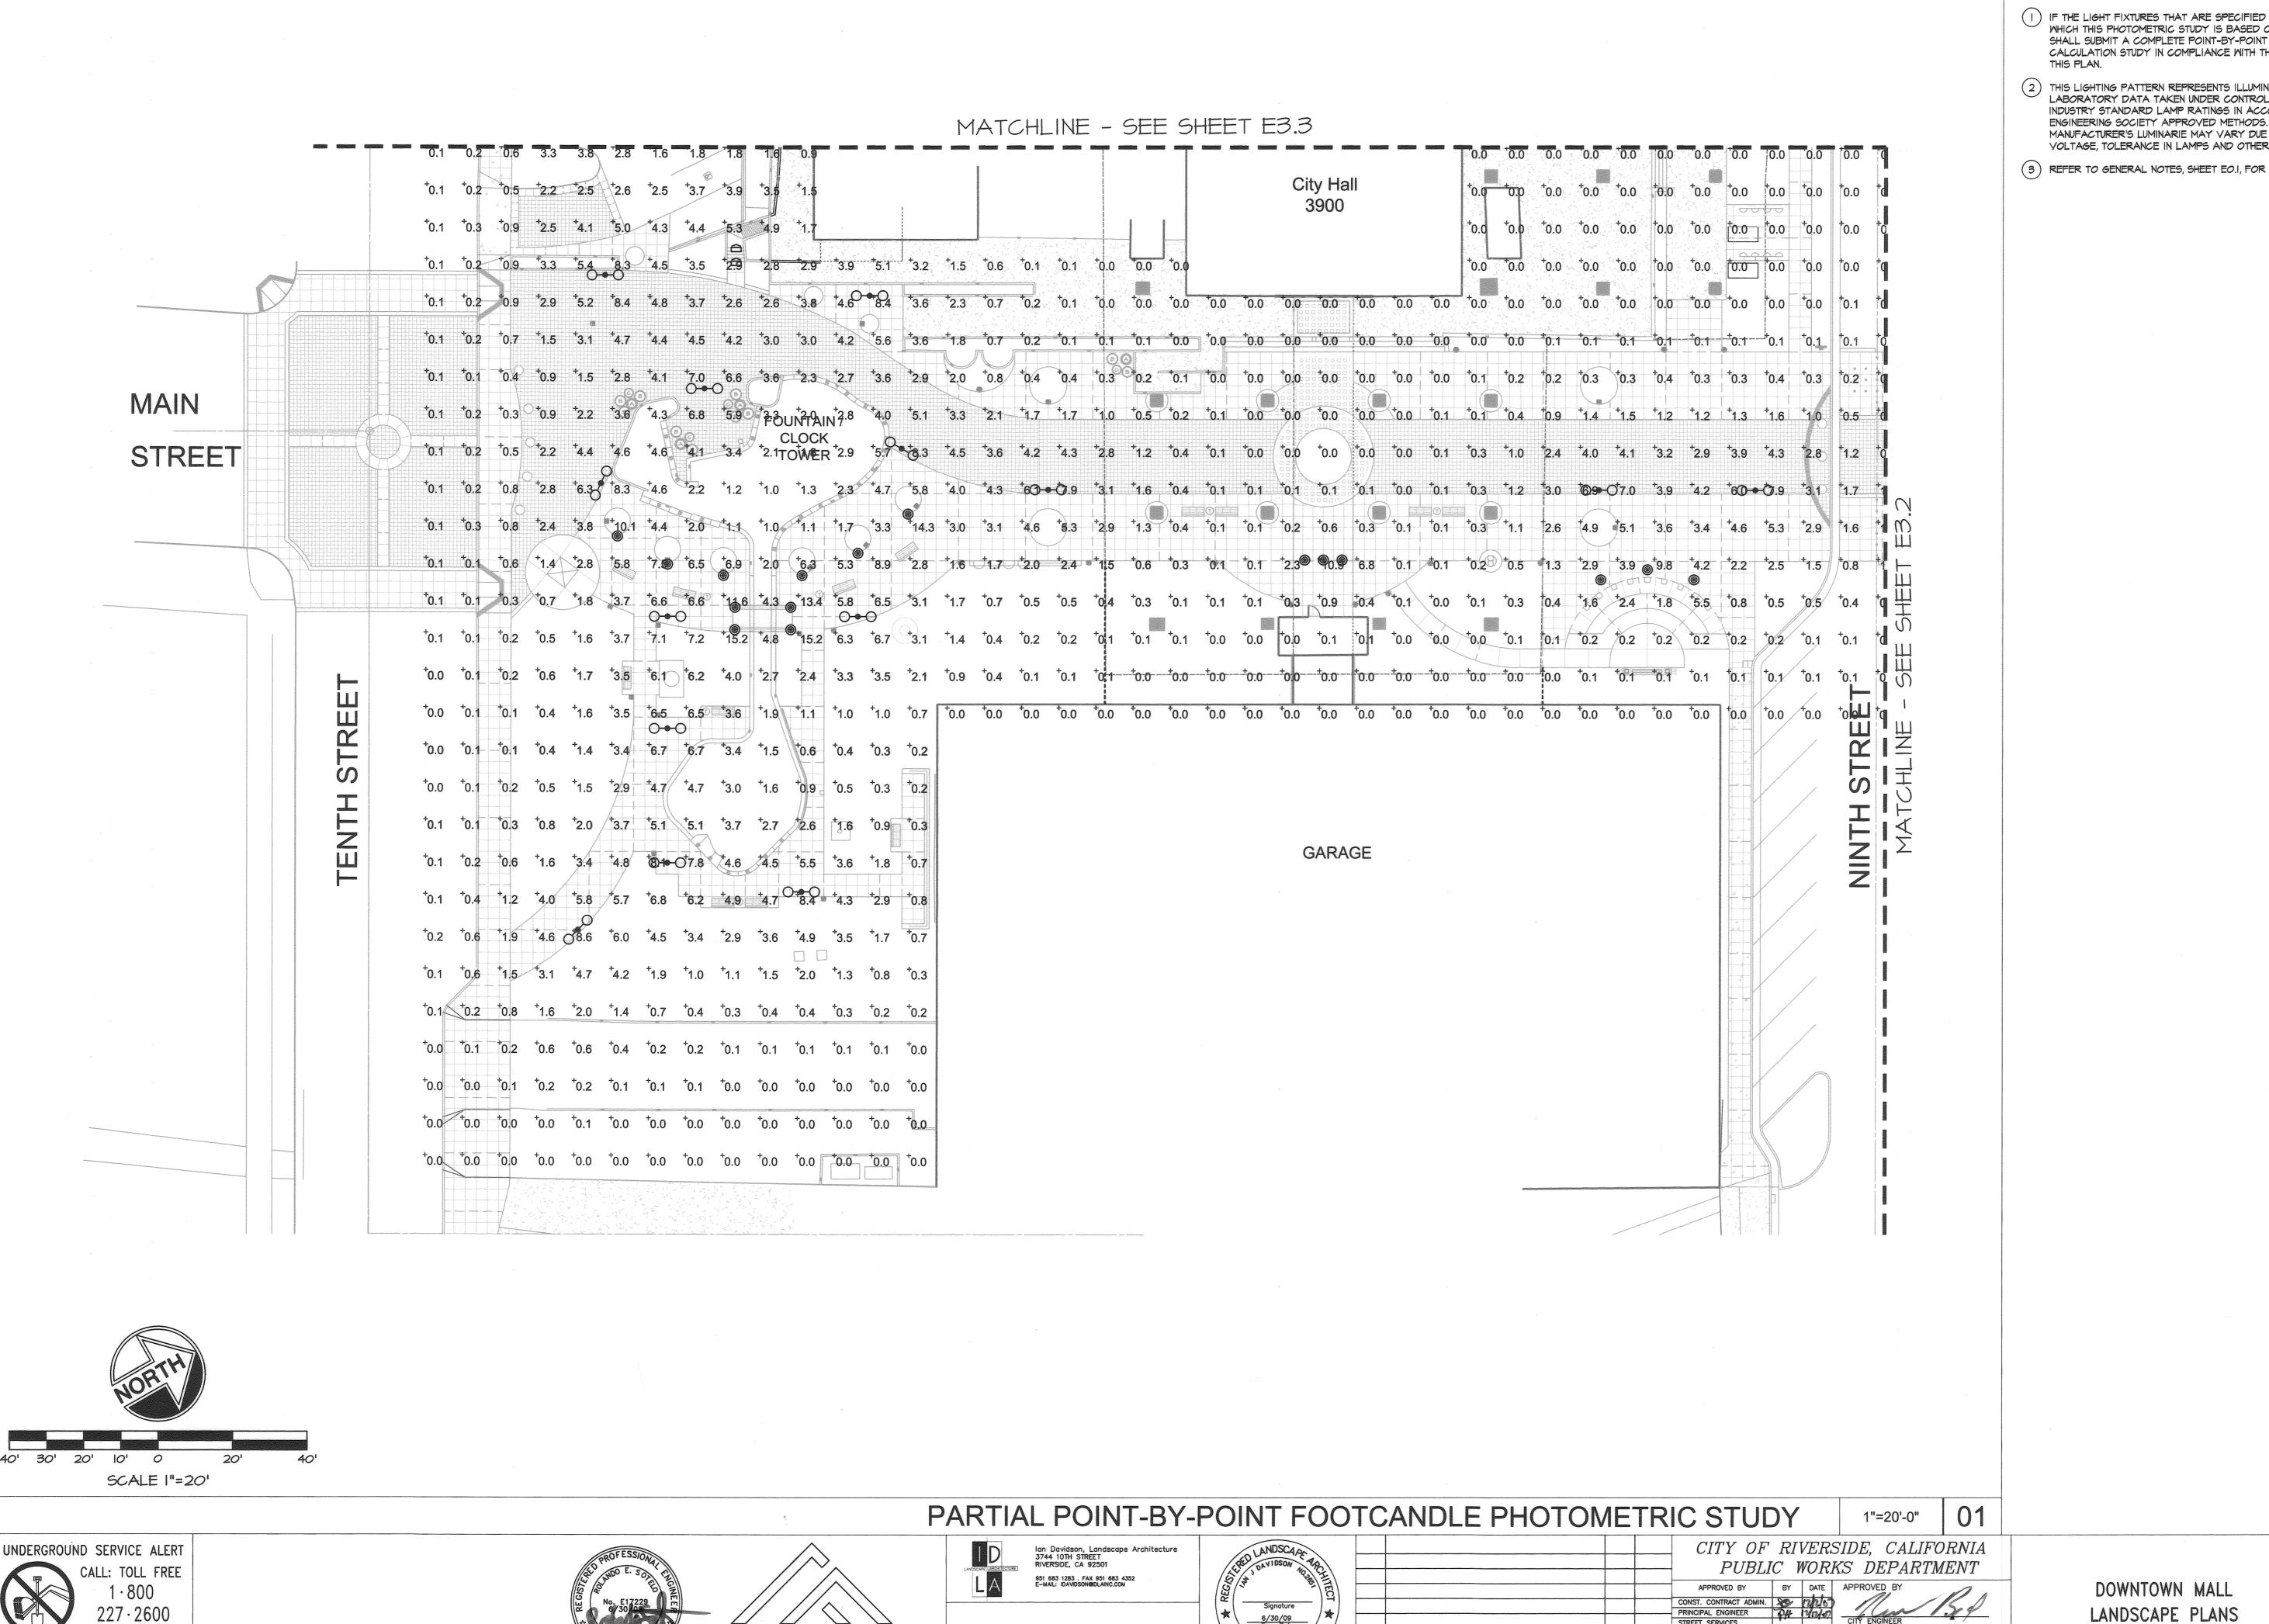


SHALL SUBMIT A COMPLETE POINT-BY-POINT FOOTCANDLE PHOTOMETRIC CALCULATION STUDY IN COMPLIANCE WITH THE FOOTCANDLE LEVELS INDICATED ON


2) THIS LIGHTING PATTERN REPRESENTS ILLUMINATION LEVELS CALCULATED FROM LABORATORY DATA TAKEN UNDER CONTROLLED CONDITIONS UTILIZING CURRENT INDUSTRY STANDARD LAMP RATINGS IN ACCORDANCE WITH ILLUMINATING ENGINEERING SOCIETY APPROVED METHODS. ACTUAL PERFORMANCE OF ANY MANUFACTURER'S LUMINARIE MAY VARY DUE TO VARIATION IN ELECTRICAL VOLTAGE, TOLERANCE IN LAMPS AND OTHER VARIABLE FIELD CONDITIONS.

12-93-2007

LANDSCAPE PLANS

ELECTRICAL PLAN E3.1

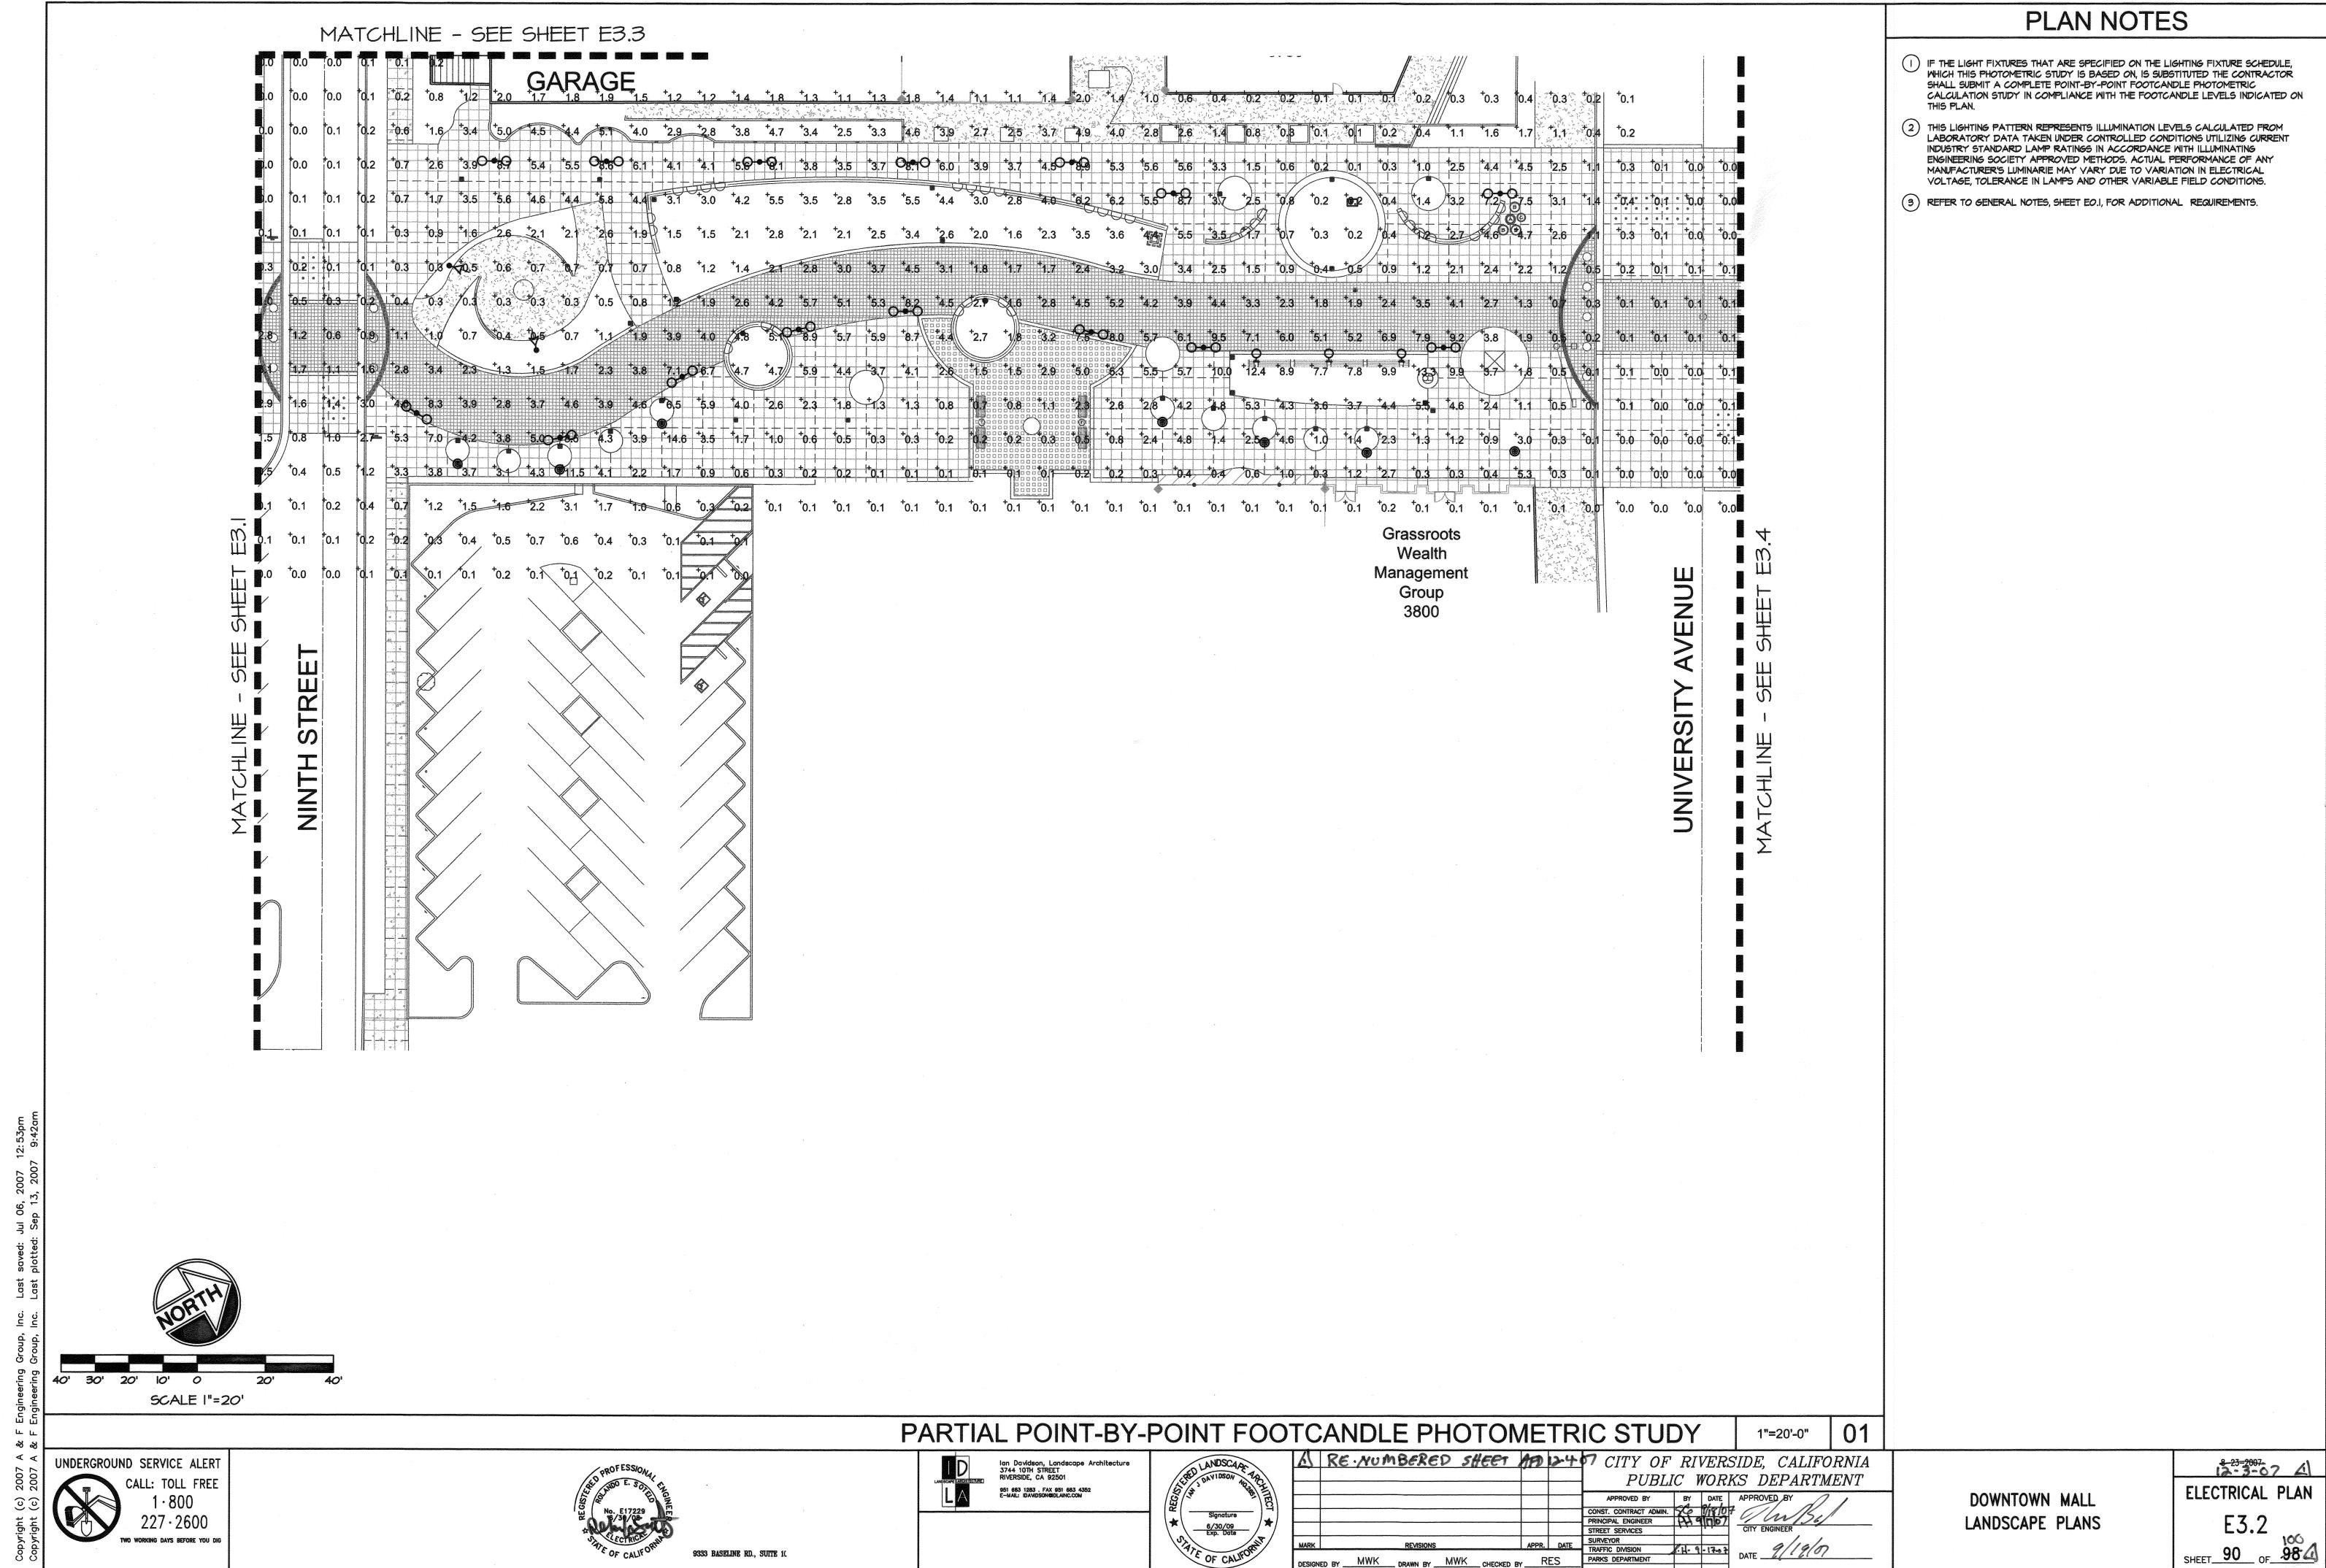

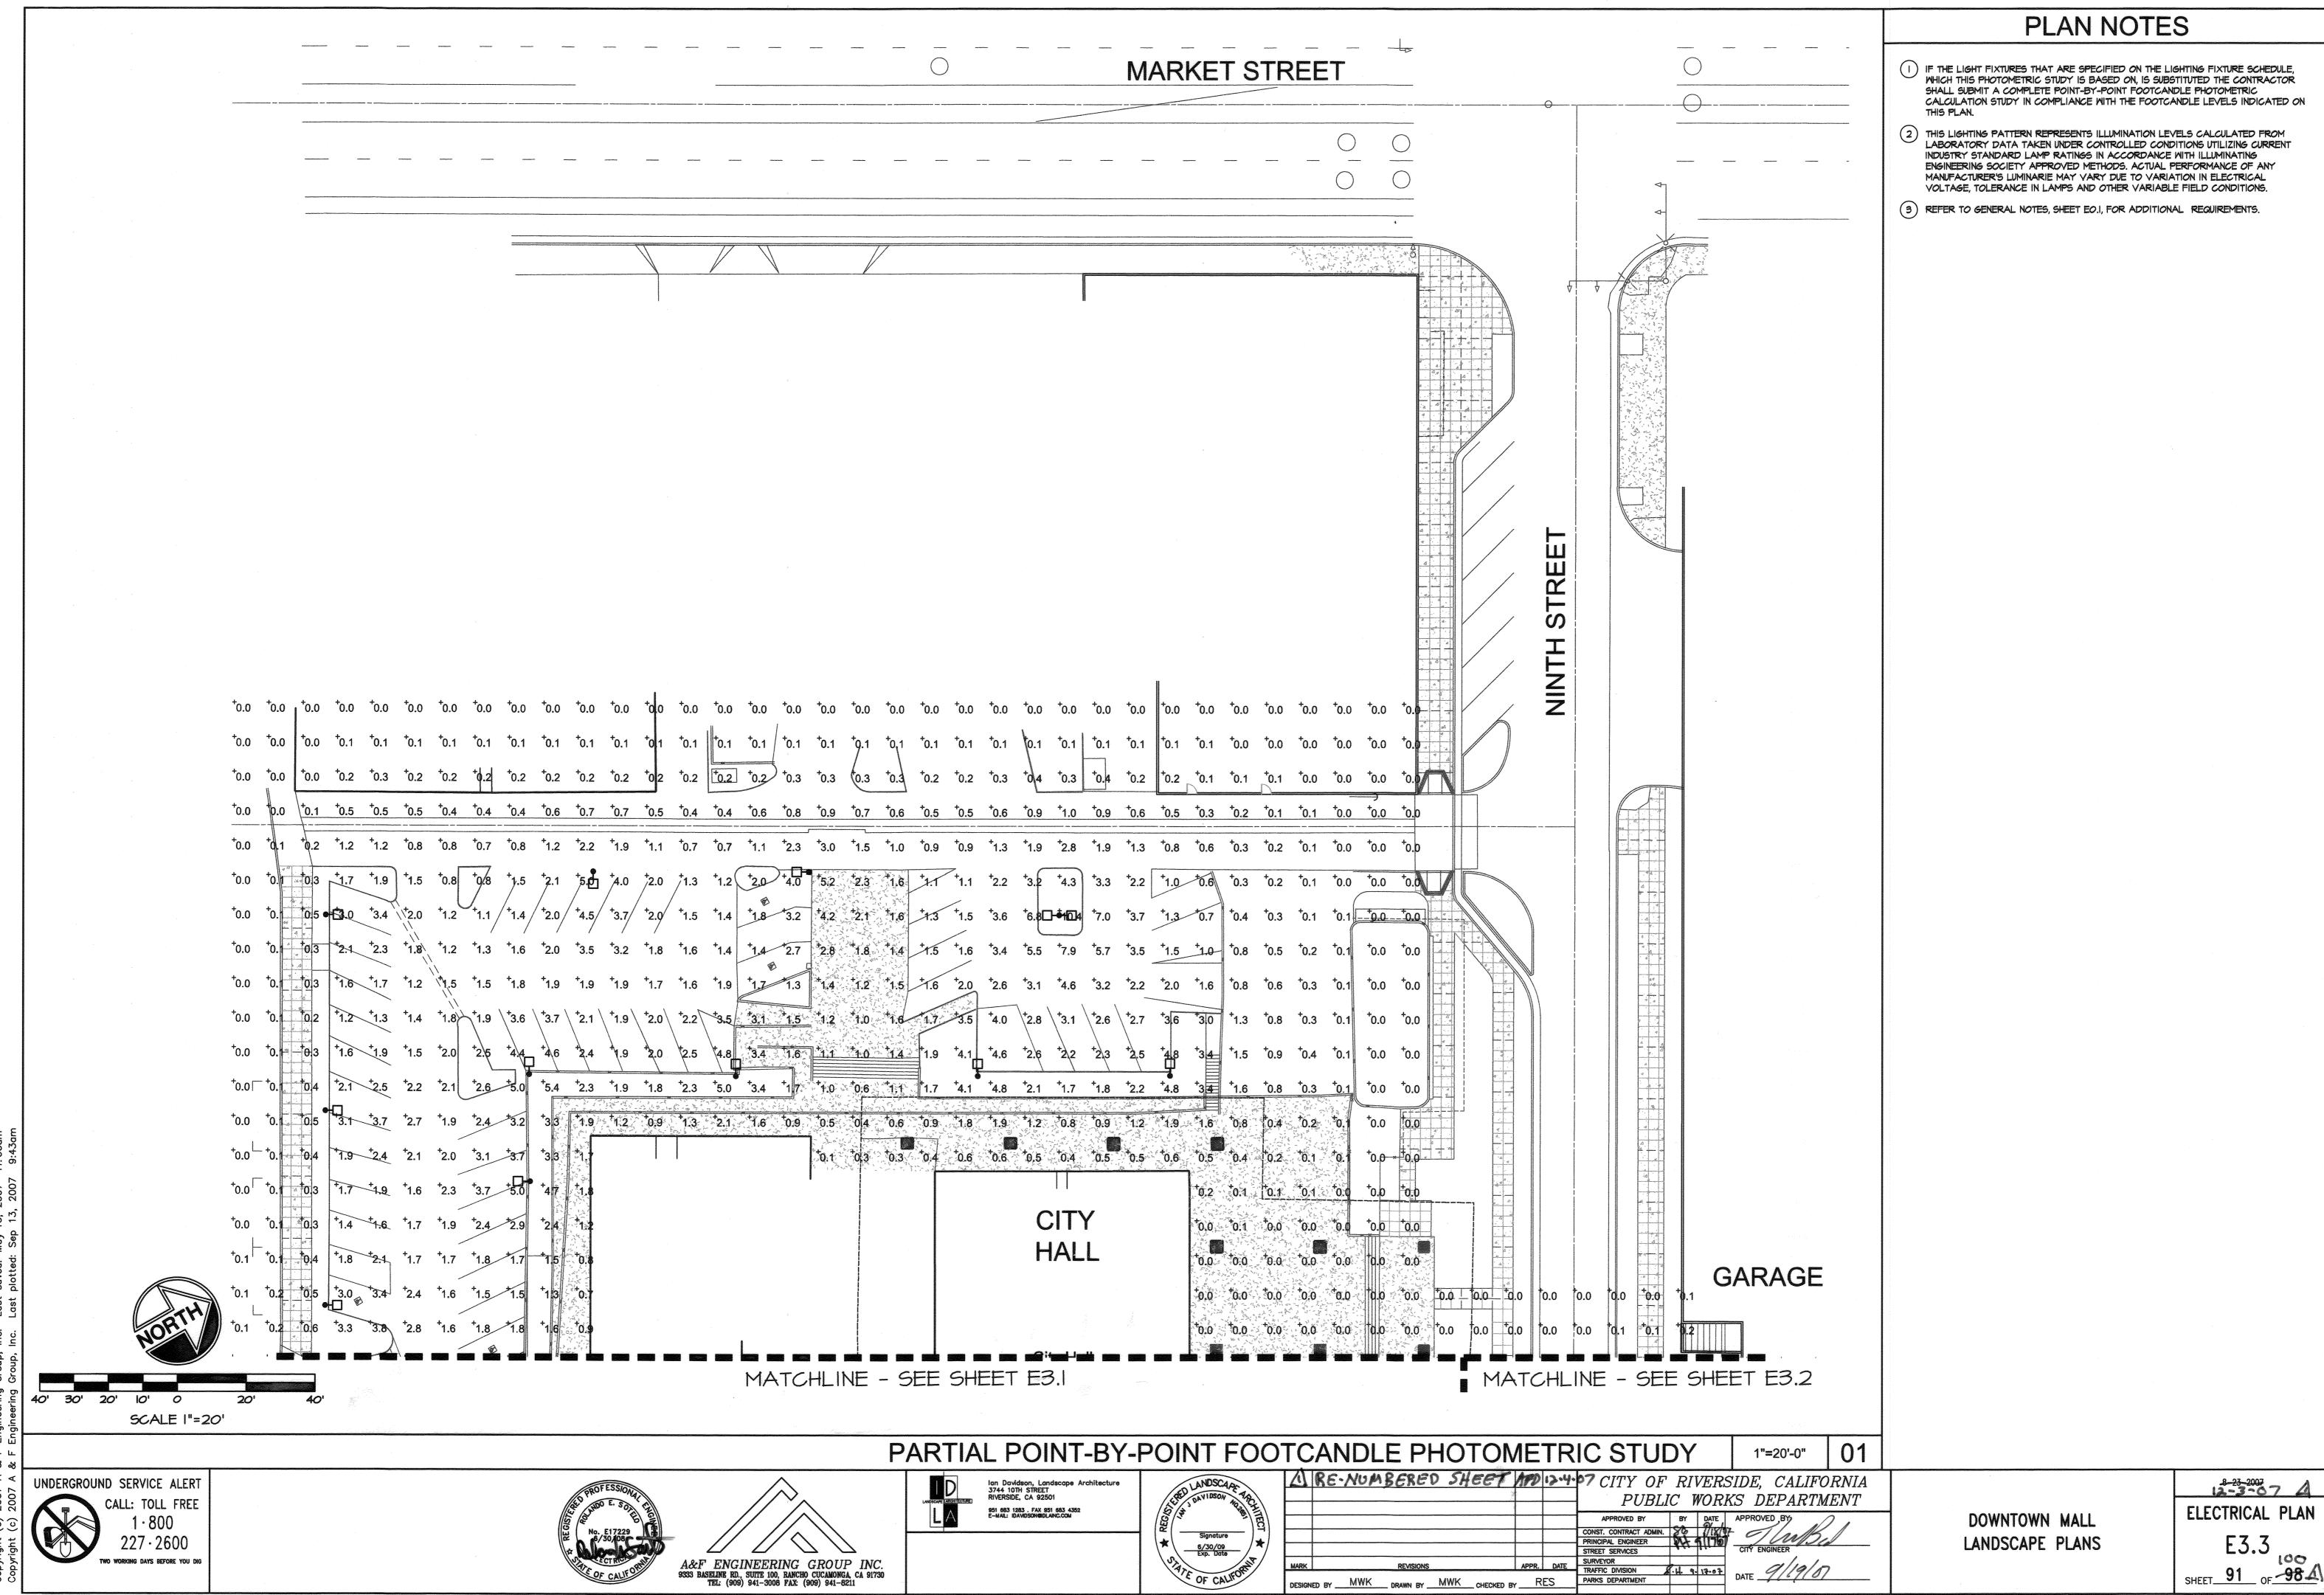










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1			PUBLIC WORKS DEPARTMENT
$\neg$			APPROVED BY BY DATE APPROVED BY
			CONST. CONTRACT ADMIN.  PRINCIPAL ENGINEER  STREET SERVICES  CITY ENGINEER
RK	REVISIONS	APPR. DATE	SURVEYOR TRAFFIC DIVISION  1.4 9-12-0-2    Old   Old
SIGNE	D BY MWK DRAWN BY MWK	CHECKED BY RES	PARKS DEPARTMENT  DATE  ### PARKS DEPARTMENT

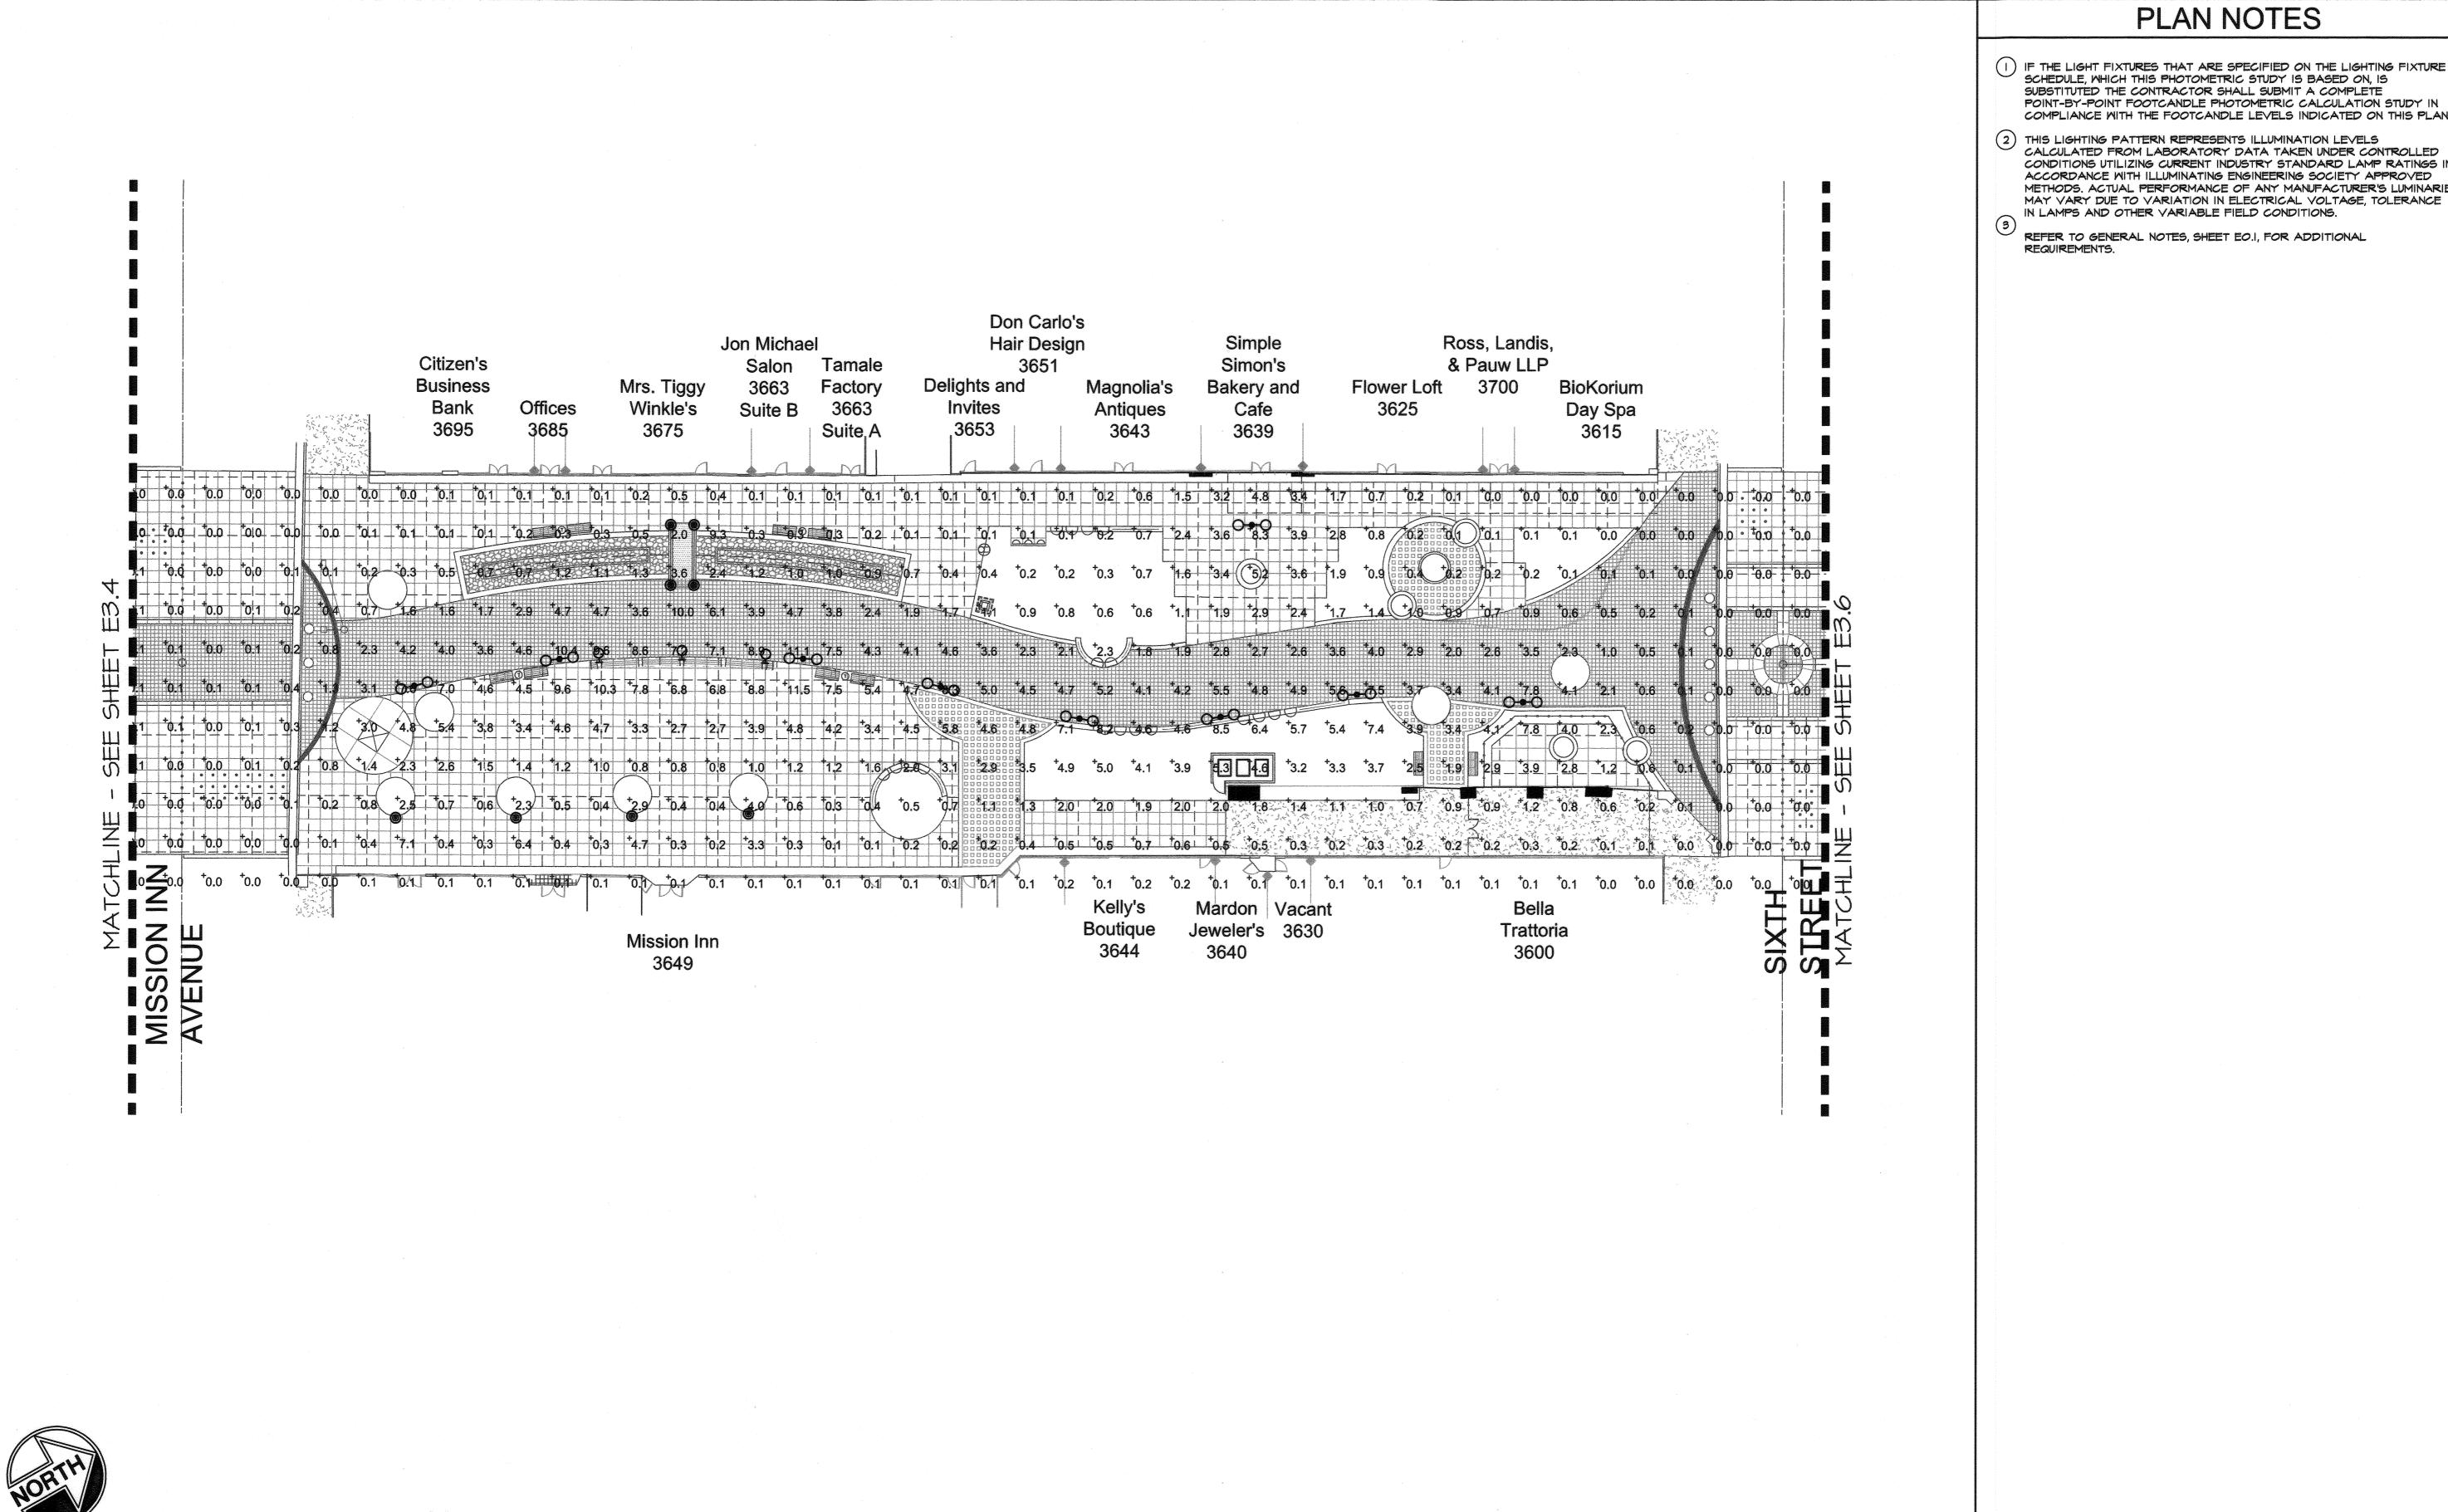


PARTIAL POINT-BY-POINT FOOTCANDLE PHOTOMETRIC STUDY


A RE-NUMBERED SHEET MAD D-4-07 CITY OF RIVERSIDE CALIFORNIA

UNDERGROUND SERVICE ALERT CALL: TOLL FREE

40' 30' 20' 10' 0

SCALE I"=20'

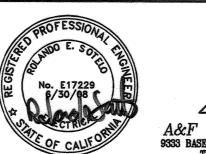

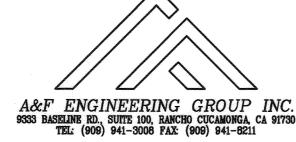





	KG.WALACKED SUCCE		19.4.	P CITY OF RIVERSIDE, CALIFORNIA
				PUBLIC WORKS DEPARTMENT
T				APPROVED BY BY DATE APPROVED BY
				CONST. CONTRACT ADMIN. CONTRACT ADMIN. PRINCIPAL ENGINEER
				STREET SERVICES CITY ENGINEER
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DOWNTOWN MALL LANDSCAPE PLANS

01

1"=20'-0"

PLAN NOTES

POINT-BY-POINT FOOTCANDLE PHOTOMETRIC CALCULATION STUDY IN COMPLIANCE WITH THE FOOTCANDLE LEVELS INDICATED ON THIS PLAN.

CONDITIONS UTILIZING CURRENT INDUSTRY STANDARD LAMP RATINGS IN ACCORDANCE WITH ILLUMINATING ENGINEERING SOCIETY APPROVED METHODS. ACTUAL PERFORMANCE OF ANY MANUFACTURER'S LUMINARIE MAY VARY DUE TO VARIATION IN ELECTRICAL VOLTAGE, TOLERANCE


SCHEDULE, WHICH THIS PHOTOMETRIC STUDY IS BASED ON, IS SUBSTITUTED THE CONTRACTOR SHALL SUBMIT A COMPLETE


IN LAMPS AND OTHER VARIABLE FIELD CONDITIONS.

REQUIREMENTS.


REFER TO GENERAL NOTES, SHEET EO.I, FOR ADDITIONAL

2-3-2007 ELECTRICAL PLAN E3.5 SHEET 93 OF 98 6

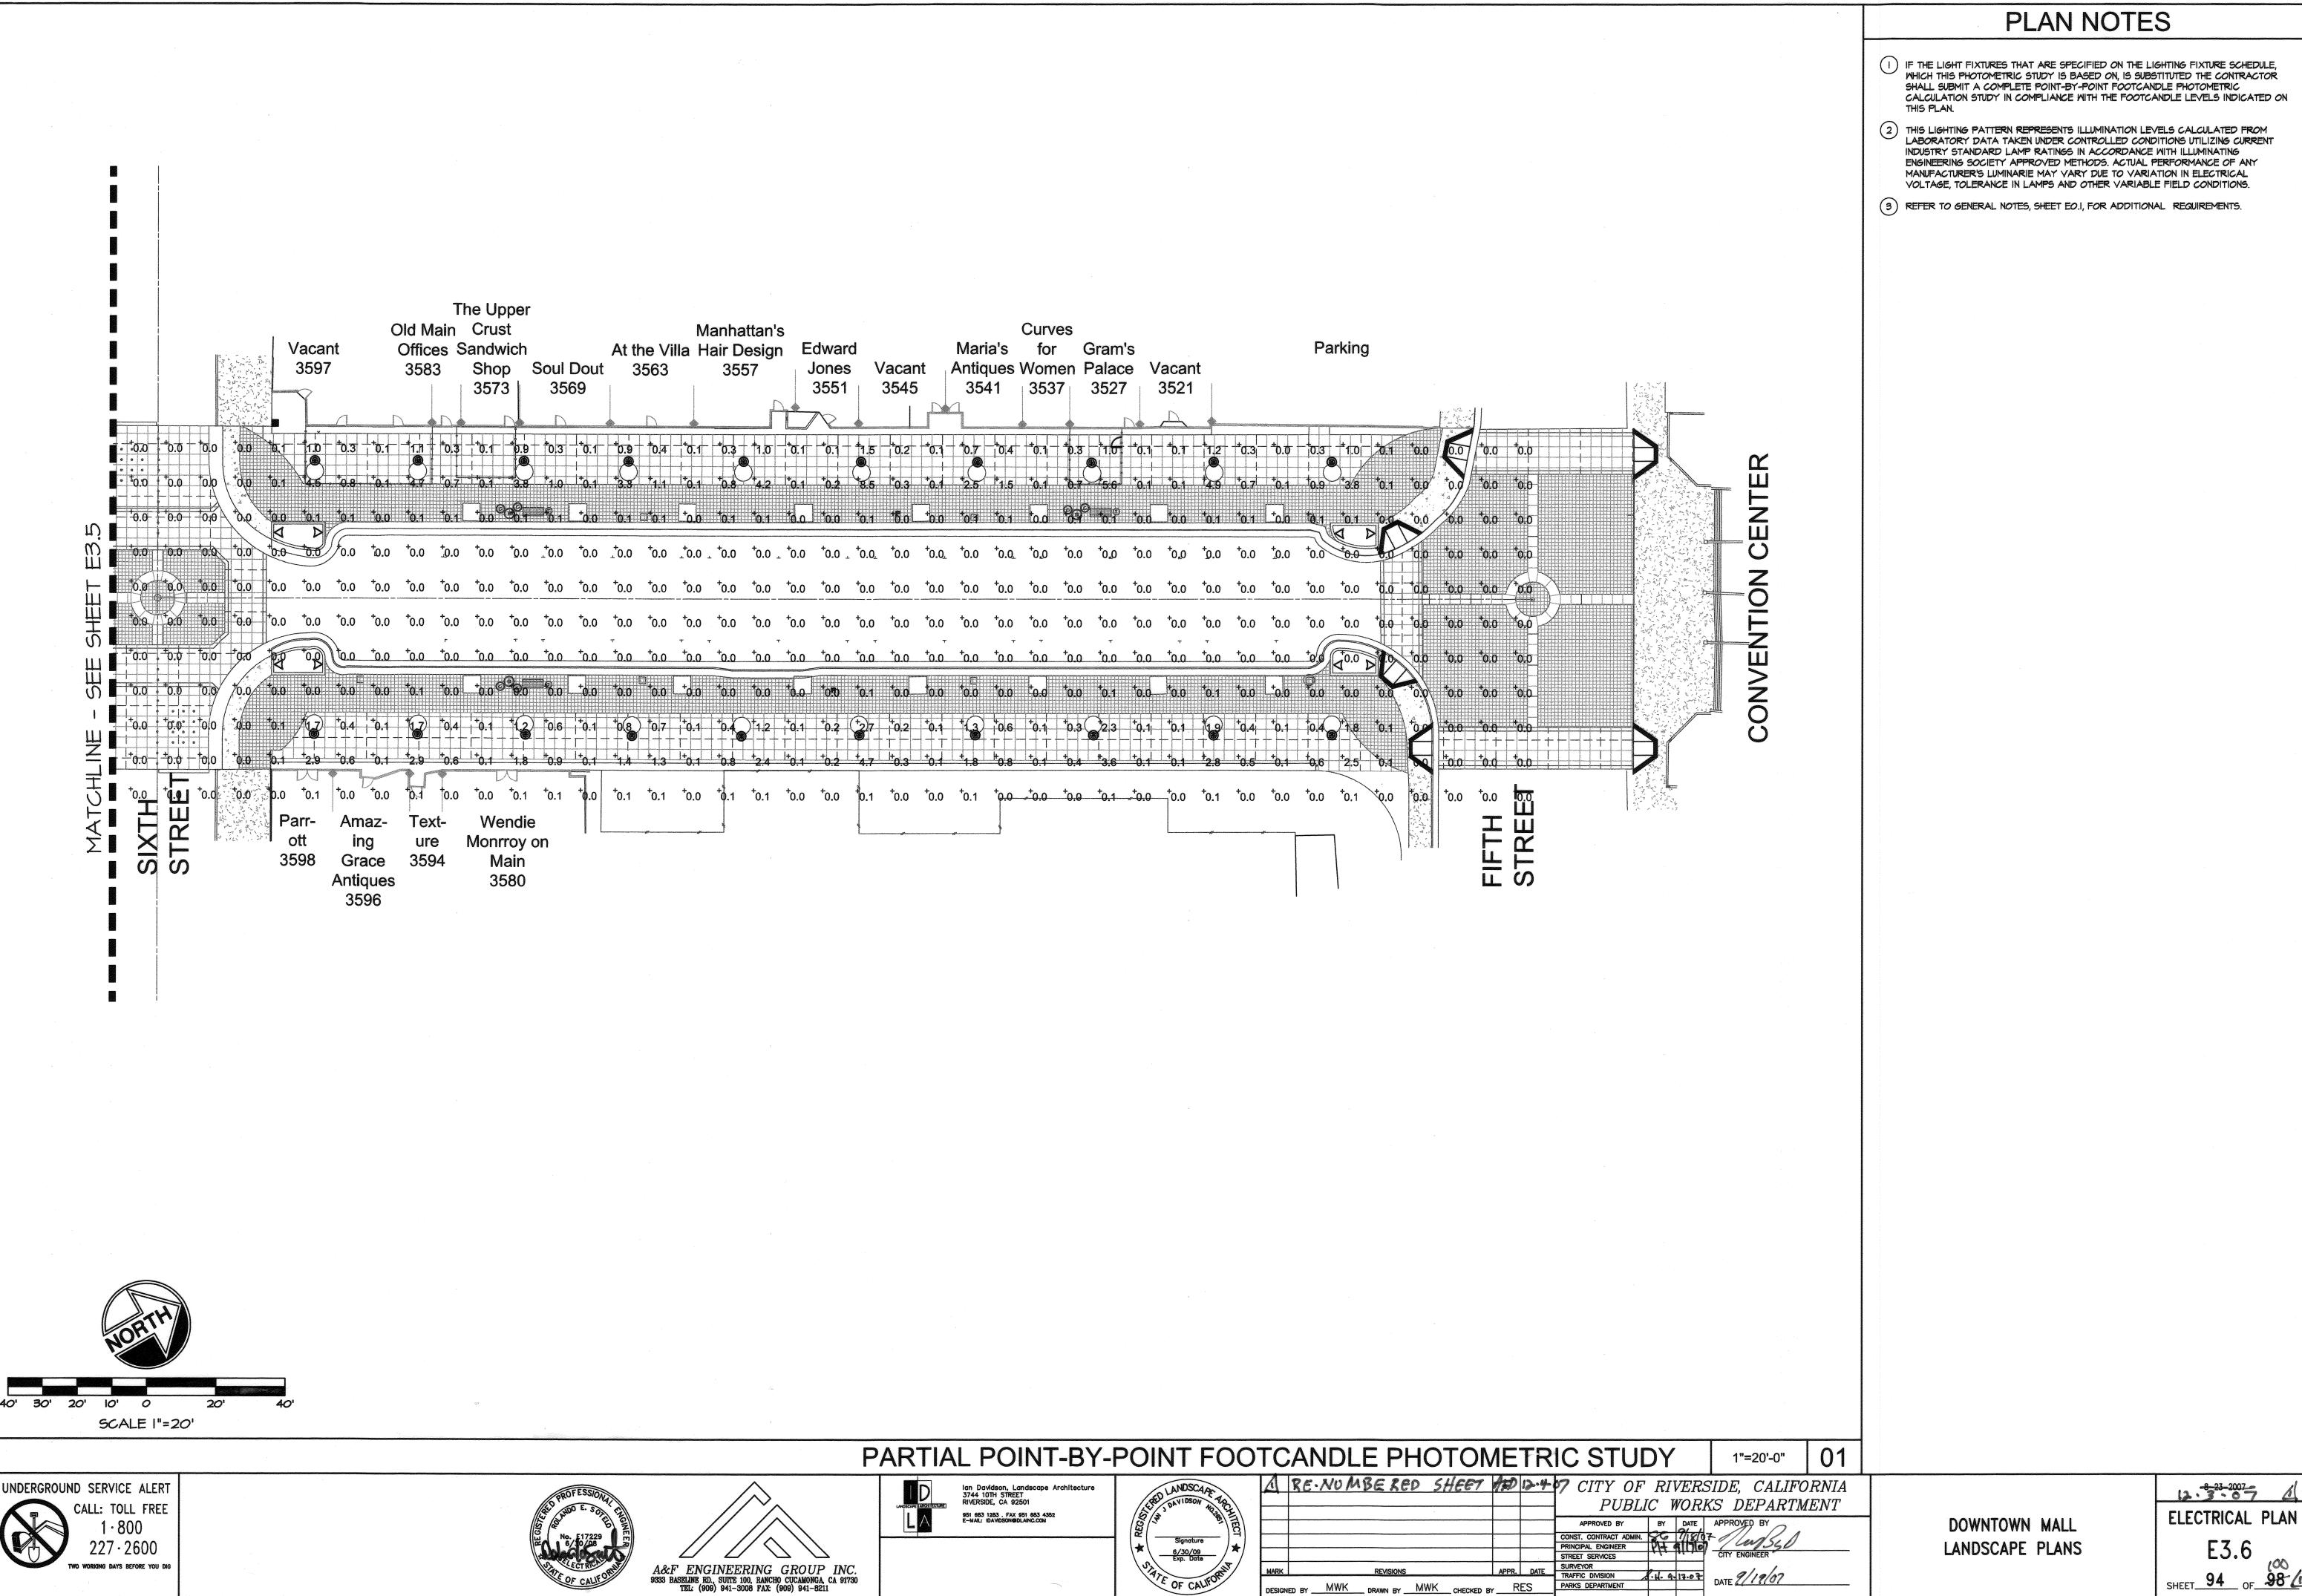

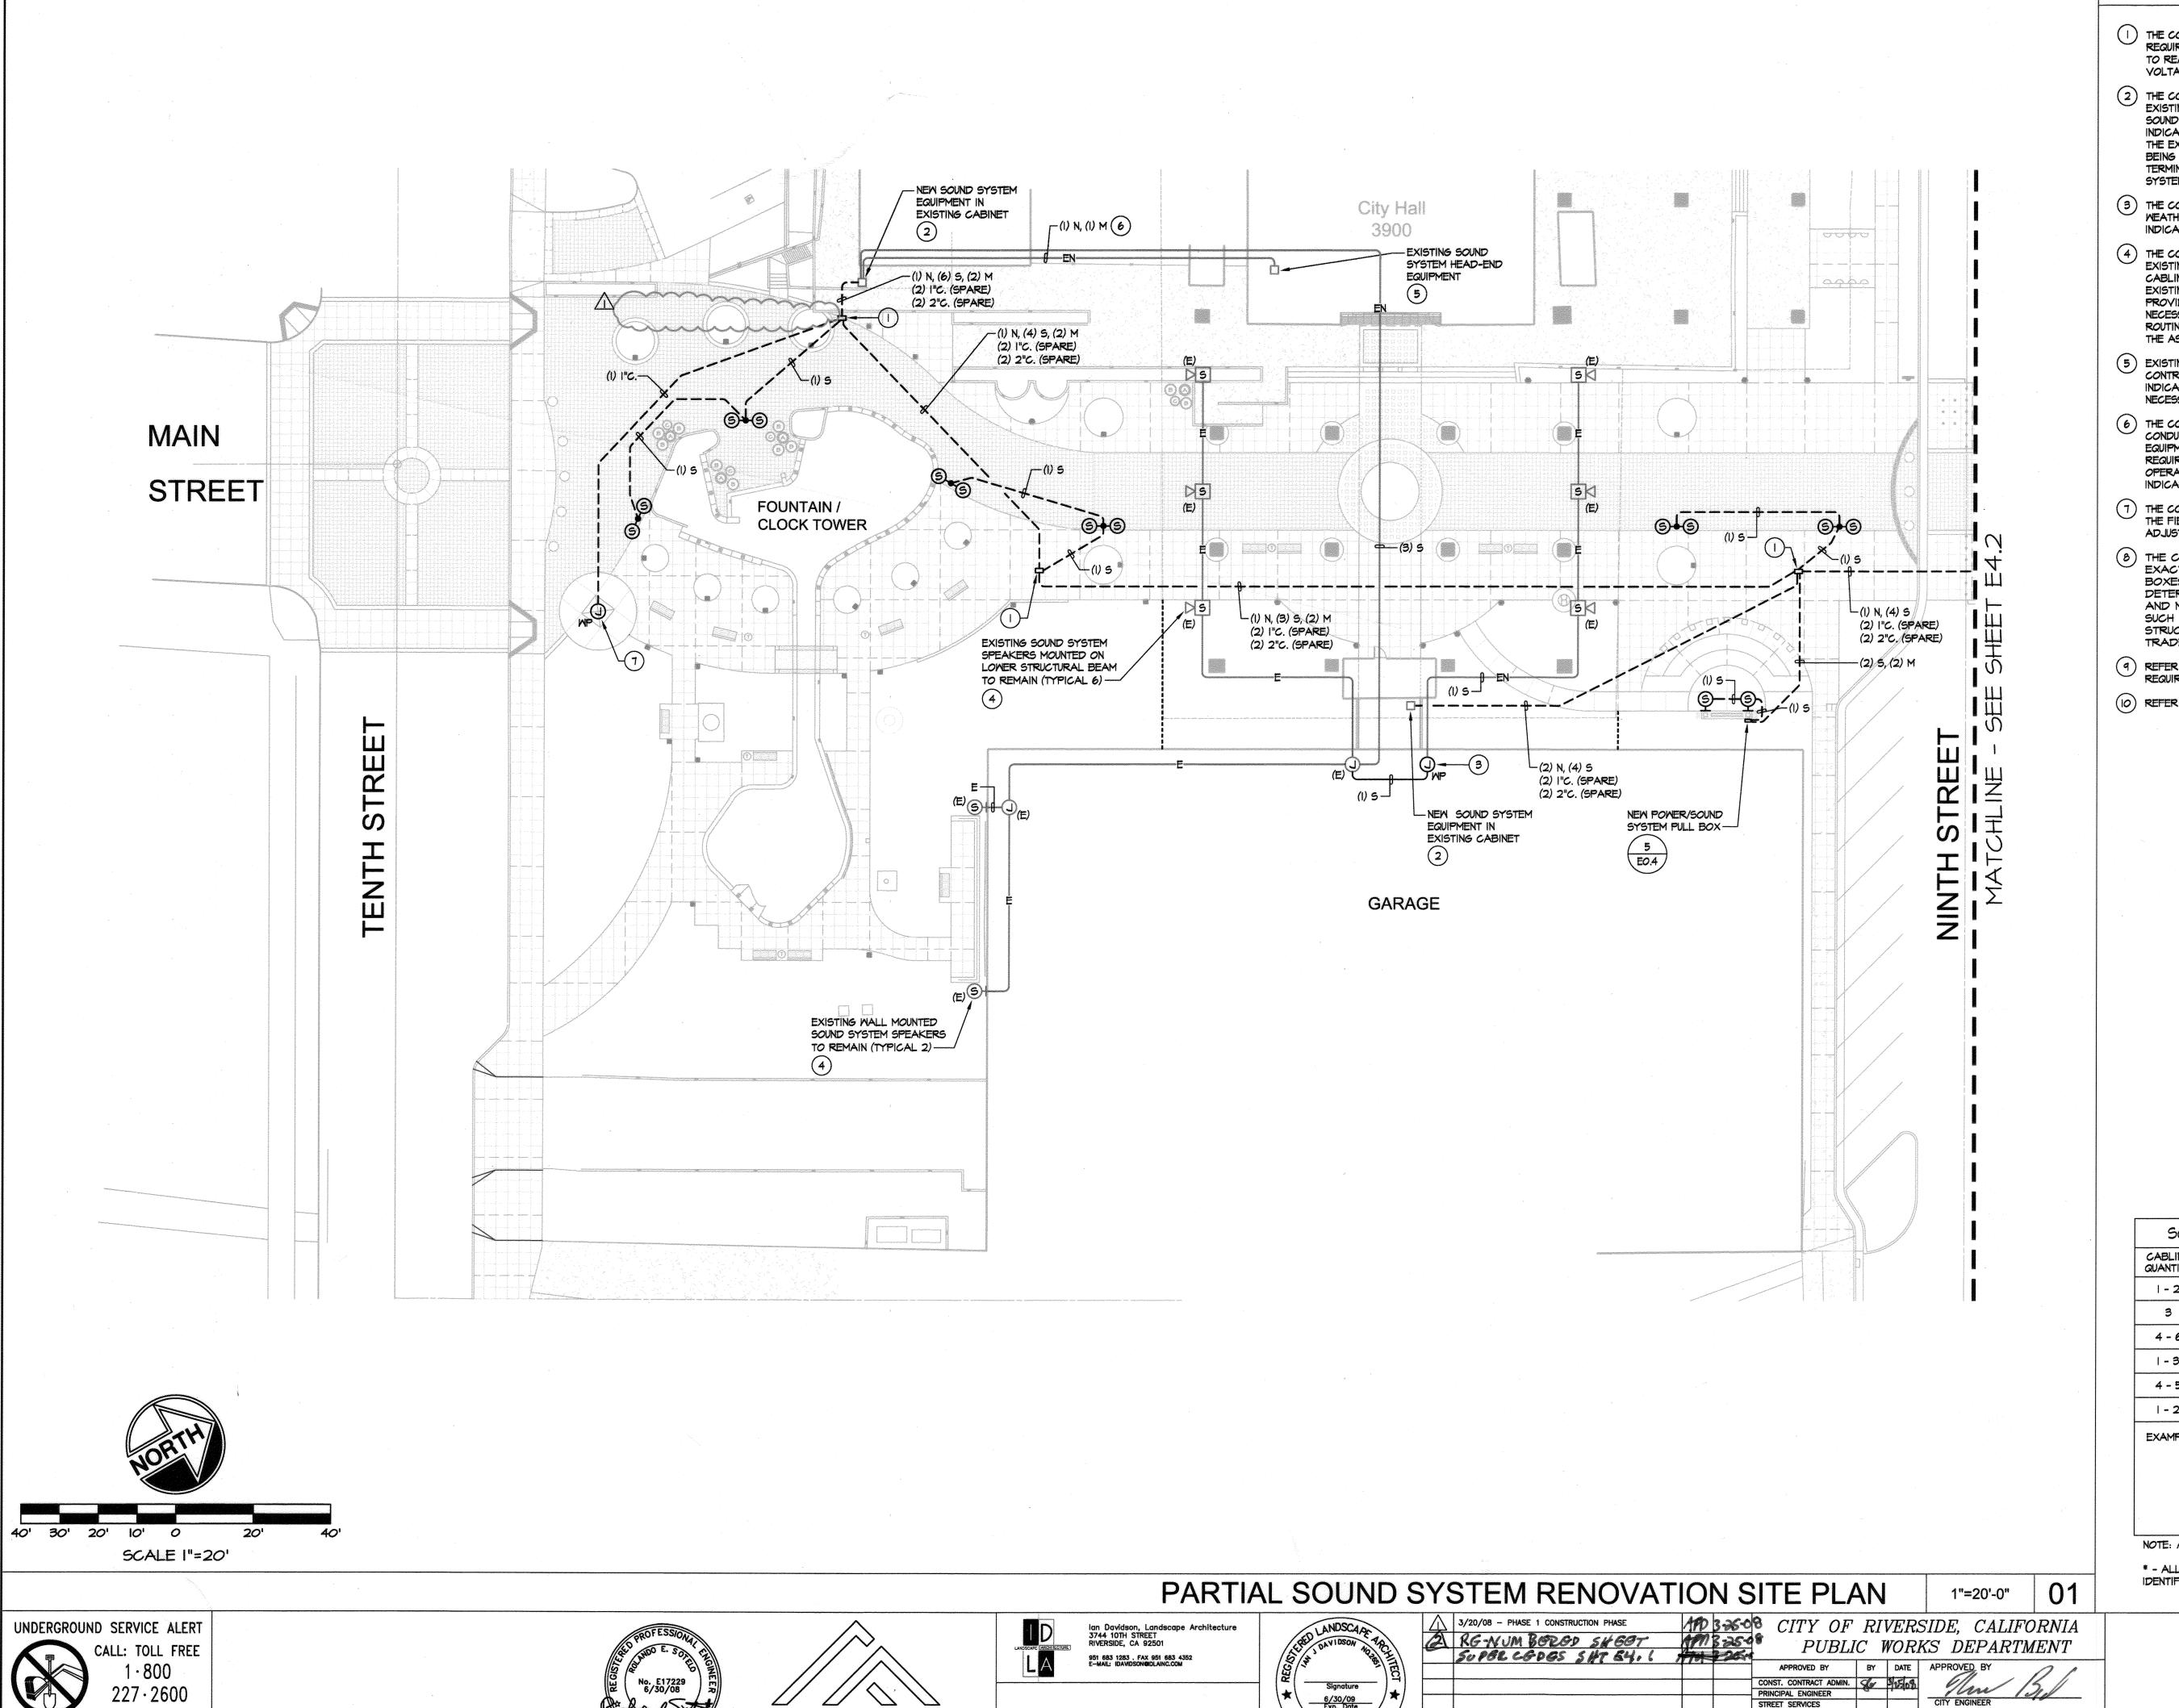

- THE CONTRACTOR SHALL PROVIDE AND INSTALL A 13" X 24" X DEPTH AS REQUIRED UNDERGROUND PULL BOX COMPLETE WITH BOLT DOWN CONCRETE COVER TO READ "SOUND SYSTEM". SPLICES WITHIN UNDERGROUND PULL BOXES FOR LOW VOLTAGE CABLING IS NOT ALLOWED.
- THE CONTRACTOR SHALL BE RESPONSIBLE FOR MAINTAINING AND PROTECTING THE EXISTING SOUND SYSTEM CABINET IN PLACE. HE SHALL PROVIDE AND INSTALL NEW SOUND SYSTEM EQUIPMENT IN EXISTING CABINET TO FEED THE SPEAKERS INDICATED. THE CONTRACTOR SHALL MAKE ALL MODIFICATIONS NECESSARY TO THE EXISTING CABINET TO ACCOMMODATE FOR THE NEW EQUIPMENT AND CONDUITS BEING INSTALLED, PROVIDE ALL REQUIRED MATERIALS AND MAKE ALL FINAL TERMINATIONS NECESSARY TO PROVIDE A COMPLETE AND FULLY OPERABLE
- 3 THE CONTRACTOR SHALL INTERCEPT THE EXISTING CONDUIT SYSTEM WITH A NEW WEATHERPROOF JUNCTION BOX AND EXTEND NEW CONDUIT AND CABLING AS
- 4 THE CONTRACTOR SHALL BE RESPONSIBLE FOR MAINTAINING AND PROTECTING THE EXISTING SOUND SYSTEM SPEAKERS IN PLACE. HE SHALL TERMINATE THE EXISTING CABLING TO THE NEW SOUND SYSTEM EQUIPMENT BEING INSTALLED. WHERE EXISTING CABLING IS NOT ADEQUATE OR DAMAGE, THE CONTRACTOR SHALL PROVIDE NEW CABLING AS REQUIRED AND MAKE ALL FINAL TERMINATIONS NECESSARY TO PROVIDE A COMPLETE AND FULLY OPERABLE SYSTEM. EXACT ROUTING OF CONDUIT AND CABLING SHALL BE FIELD VERIFIED AND INDICATED ON THE AS-BUILT DRAWINGS.
- 5 EXISTING SOUND SYSTEM HEAD-END EQUIPMENT TO REMAIN IN PLACE. THE CONTRACTOR SHALL PROVIDE AND INSTALL ALL NEW NETWORKING EQUIPMENT INDICATED IN THE SPECIFICATIONS AND MAKE ALL FINAL TERMINATIONS NECESSARY TO PROVIDE A COMPLETE AND FULLY OPERABLE SYSTEM.
- 6 THE CONTRACTOR SHALL FIELD VERIFY THE EXACT ROUTING OF THE EXISTING CONDUIT SYSTEM THAT CONNECTS THE EXISTING SOUND SYSTEM HEAD-END EQUIPMENT TO THE REMOTE SOUND SYSTEM EQUIPMENT. HE SHALL MAKE ALL REQUIRED ADJUSTMENTS NECESSARY TO PROVIDE A COMPLETE AND FULLY OPERABLE SYSTEM. EXACT ROUTING OF EXISTING CONDUIT SYSTEM SHALL BE INDICATED ON THE AS-BUILT DRAWINGS.
- THE CONTRACTOR SHALL COORDINATE EXACT LOCATION OF CONDUIT STUB-UP IN THE FIELD WITH THE KIOSK MANUFACTURER. HE SHALL MAKE ALL REQUIRED ADJUSTMENTS NECESSARY.
- 8 THE CONTRACTOR SHALL NOTE THAT THE DRAWING IS DIAGRAMMATIC. EXACT ROUTING OF NEW CONDUITS AND LOCATION OF NEW JUNCTION BOXES AND NEW PULL BOXES SHALL BE COORDINATED AND DETERMINED IN THE FIELD. NEW CONDUIT ROUTING, NEW JUNCTION BOX AND NEW PULL BOX LOCATIONS SHALL BE ROUTED AND LOCATED IN SUCH A MANNER AS TO AVOID INTERFERENCE WITH EXISTING BUILDING STRUCTURES, UTILITIES AND THE WORK BEING PERFORMED BY OTHER
- (9) REFER TO THE DEMOLITION SITE PLAN FOR ADDITIONAL INFORMATION AND REQUIREMENTS.
- (IO) REFER TO GENERAL NOTES, SHEET EO.I, FOR ADDITIONAL REQUIREMENTS.

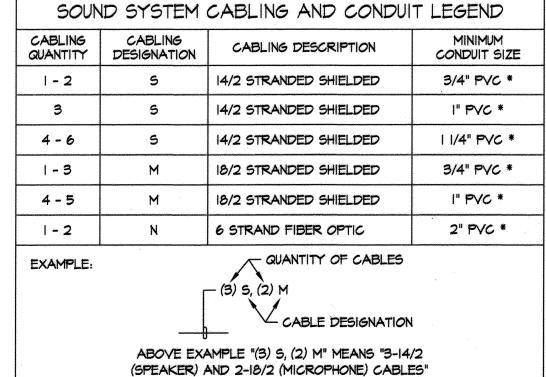

NOTE: ALL CABLES SHALL BE RATED FOR UNDERGROUND USE.


* - ALL CONDUITS SHALL BE PROVIDED WITH A 3/16" PULL ROPE, TAGGED AND IDENTIFIED WITH THE LOCATION OF TERMINATION.










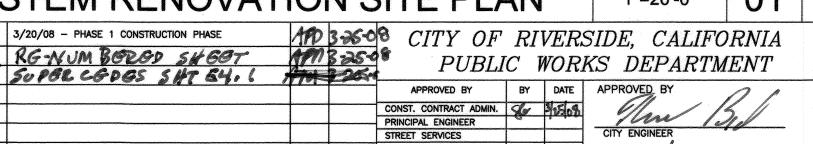

DOWNTOWN MALL LANDSCAPE PLANS

03-20-2008 ELECTRICAL PLAN

SHEET 95 OF 99

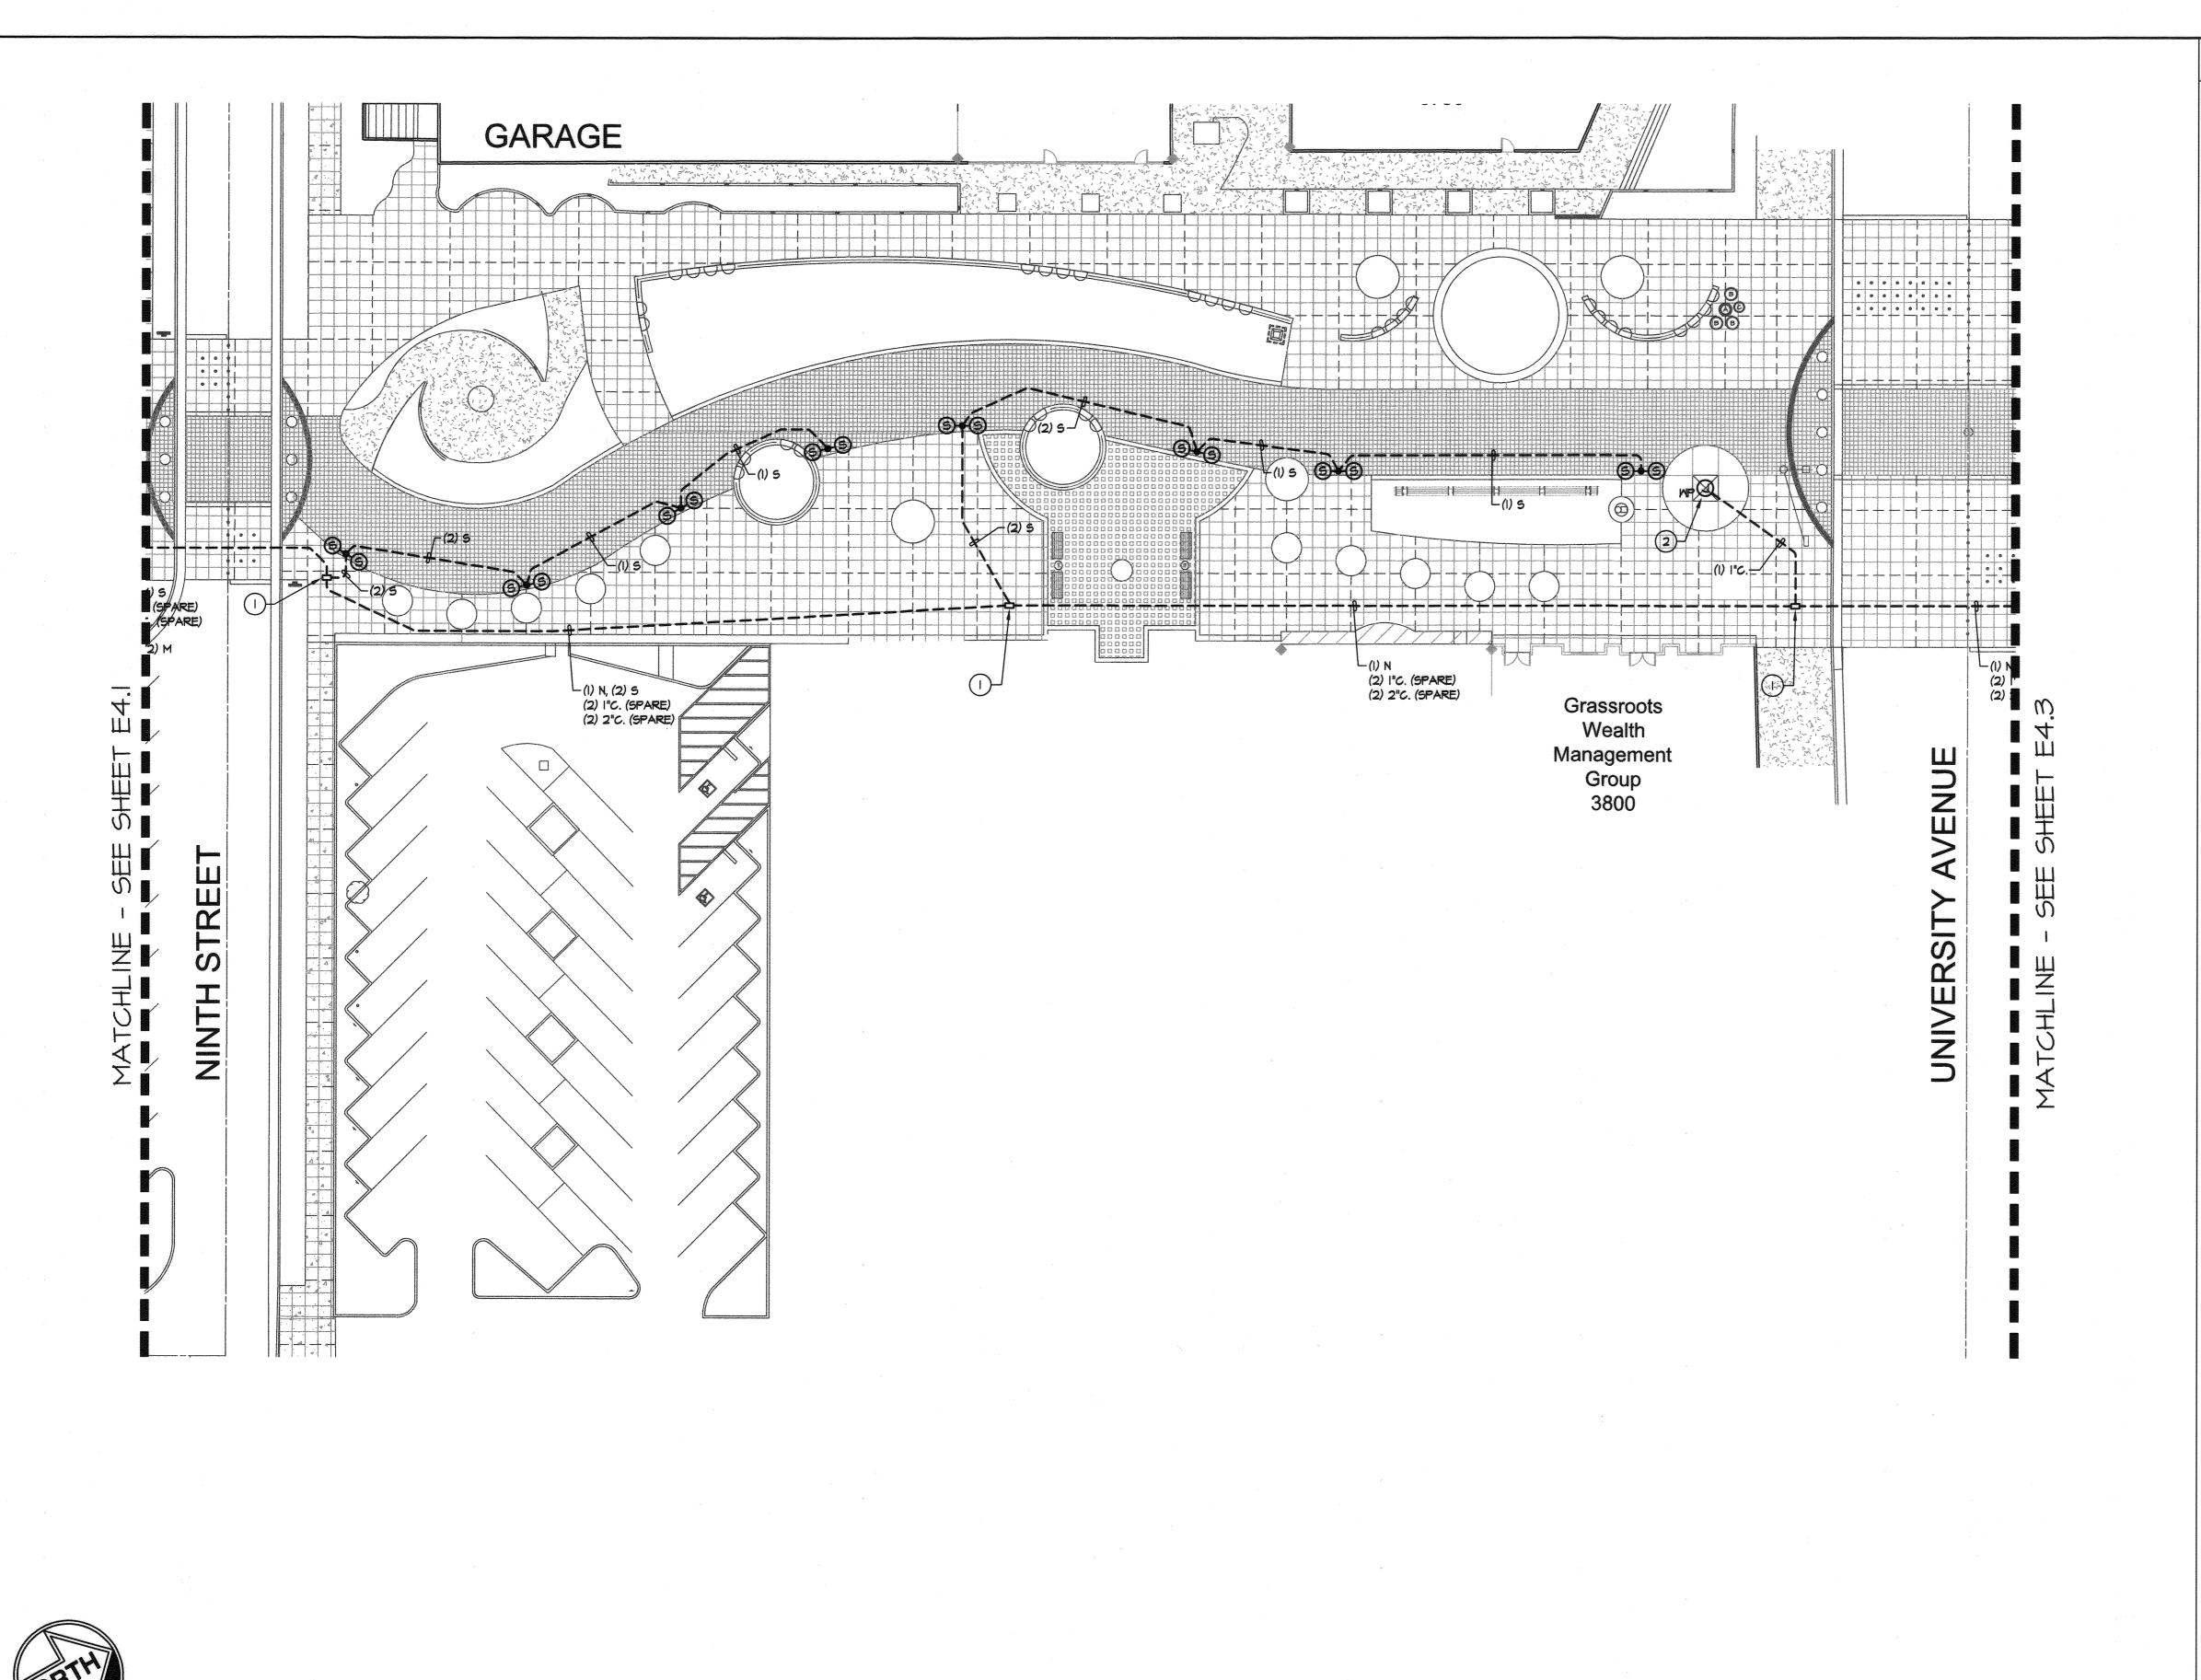

- THE CONTRACTOR SHALL PROVIDE AND INSTALL A 13" X 24" X DEPTH AS REQUIRED UNDERGROUND PULL BOX COMPLETE WITH BOLT DOWN CONCRETE COVER TO READ "SOUND SYSTEM". SPLICES WITHIN UNDERGROUND PULL BOXES FOR LOW VOLTAGE CABLING IS NOT ALLOWED.
- THE CONTRACTOR SHALL COORDINATE EXACT LOCATION OF CONDUIT STUB-UP IN THE FIELD WITH THE KIOSK MANUFACTURER. HE SHALL MAKE ALL REQUIRED ADJUSTMENTS NECESSARY.
- 3 THE CONTRACTOR SHALL NOTE THAT THE DRAWING IS DIAGRAMMATIC. EXACT ROUTING OF NEW CONDUITS AND LOCATION OF NEW JUNCTION BOXES AND NEW PULL BOXES SHALL BE COORDINATED AND DETERMINED IN THE FIELD. NEW CONDUIT ROUTING, NEW JUNCTION BOX AND NEW PULL BOX LOCATIONS SHALL BE ROUTED AND LOCATED IN SUCH A MANNER AS TO AVOID INTERFERENCE WITH EXISTING BUILDING STRUCTURES, UTILITIES AND THE WORK BEING PERFORMED BY OTHER
- 4 REFER TO THE DEMOLITION SITE PLAN FOR ADDITIONAL INFORMATION AND REQUIREMENTS.
- (5) REFER TO GENERAL NOTES, SHEET EO:I, FOR ADDITIONAL REQUIREMENTS.


SOUN	ID SYSTEM	CABLING AND CONDUI	T LEGEND
CABLING QUANTITY	CABLING DESIGNATION	CABLING DESCRIPTION	MINIMUM CONDUIT SIZE
1-2	5	14/2 STRANDED SHIELDED	3/4" PVC *
3	5	14/2 STRANDED SHIELDED	1" PVC *
4-6	5	14/2 STRANDED SHIELDED	1 1/4" PVC *
1-3	М	18/2 STRANDED SHIELDED	3/4" PVC *
4 - 5	М	18/2 STRANDED SHIELDED	I" PVC *
1-2	N	6 STRAND FIBER OPTIC	2" PVC *
EXAMPLE:	<u> </u>	QUANTITY OF CABLES	

NOTE: ALL CABLES SHALL BE RATED FOR UNDERGROUND USE.

* - ALL CONDUITS SHALL BE PROVIDED WITH A 3/16" PULL ROPE, TAGGED AND IDENTIFIED WITH THE LOCATION OF TERMINATION.

UNDERGROUND SERVICE ALERT

SCALE I"=20'

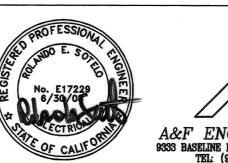








PARTIA	AL SOUND S	SYSTEM RENOVAT	ION S	SITE PLAN	1"=20'-0" 01	
Landscape Architecture REET 92501 FAX 951 883 4352 NGIDLAINC.COM	Signature 6/30/09 Exp. Date  OF CALIFORNIA	MARK REVISIONS  DESIGNED BY MWK DRAWN BY MWK CHECKED	APPR. DATE	APPROVED BY BY DATE  CONST. CONTRACT ADMIN.  PRINCIPAL ENGINEER  STREET SERVICES  SURVEYOR  TRAFFIC DIVISION	APPROVED BY CITY ENGINEER  DATE 2/9/07	

DOWNTOWN MALL LANDSCAPE PLANS

12-3-23-2007 ELECTRICAL PLAN E4.2

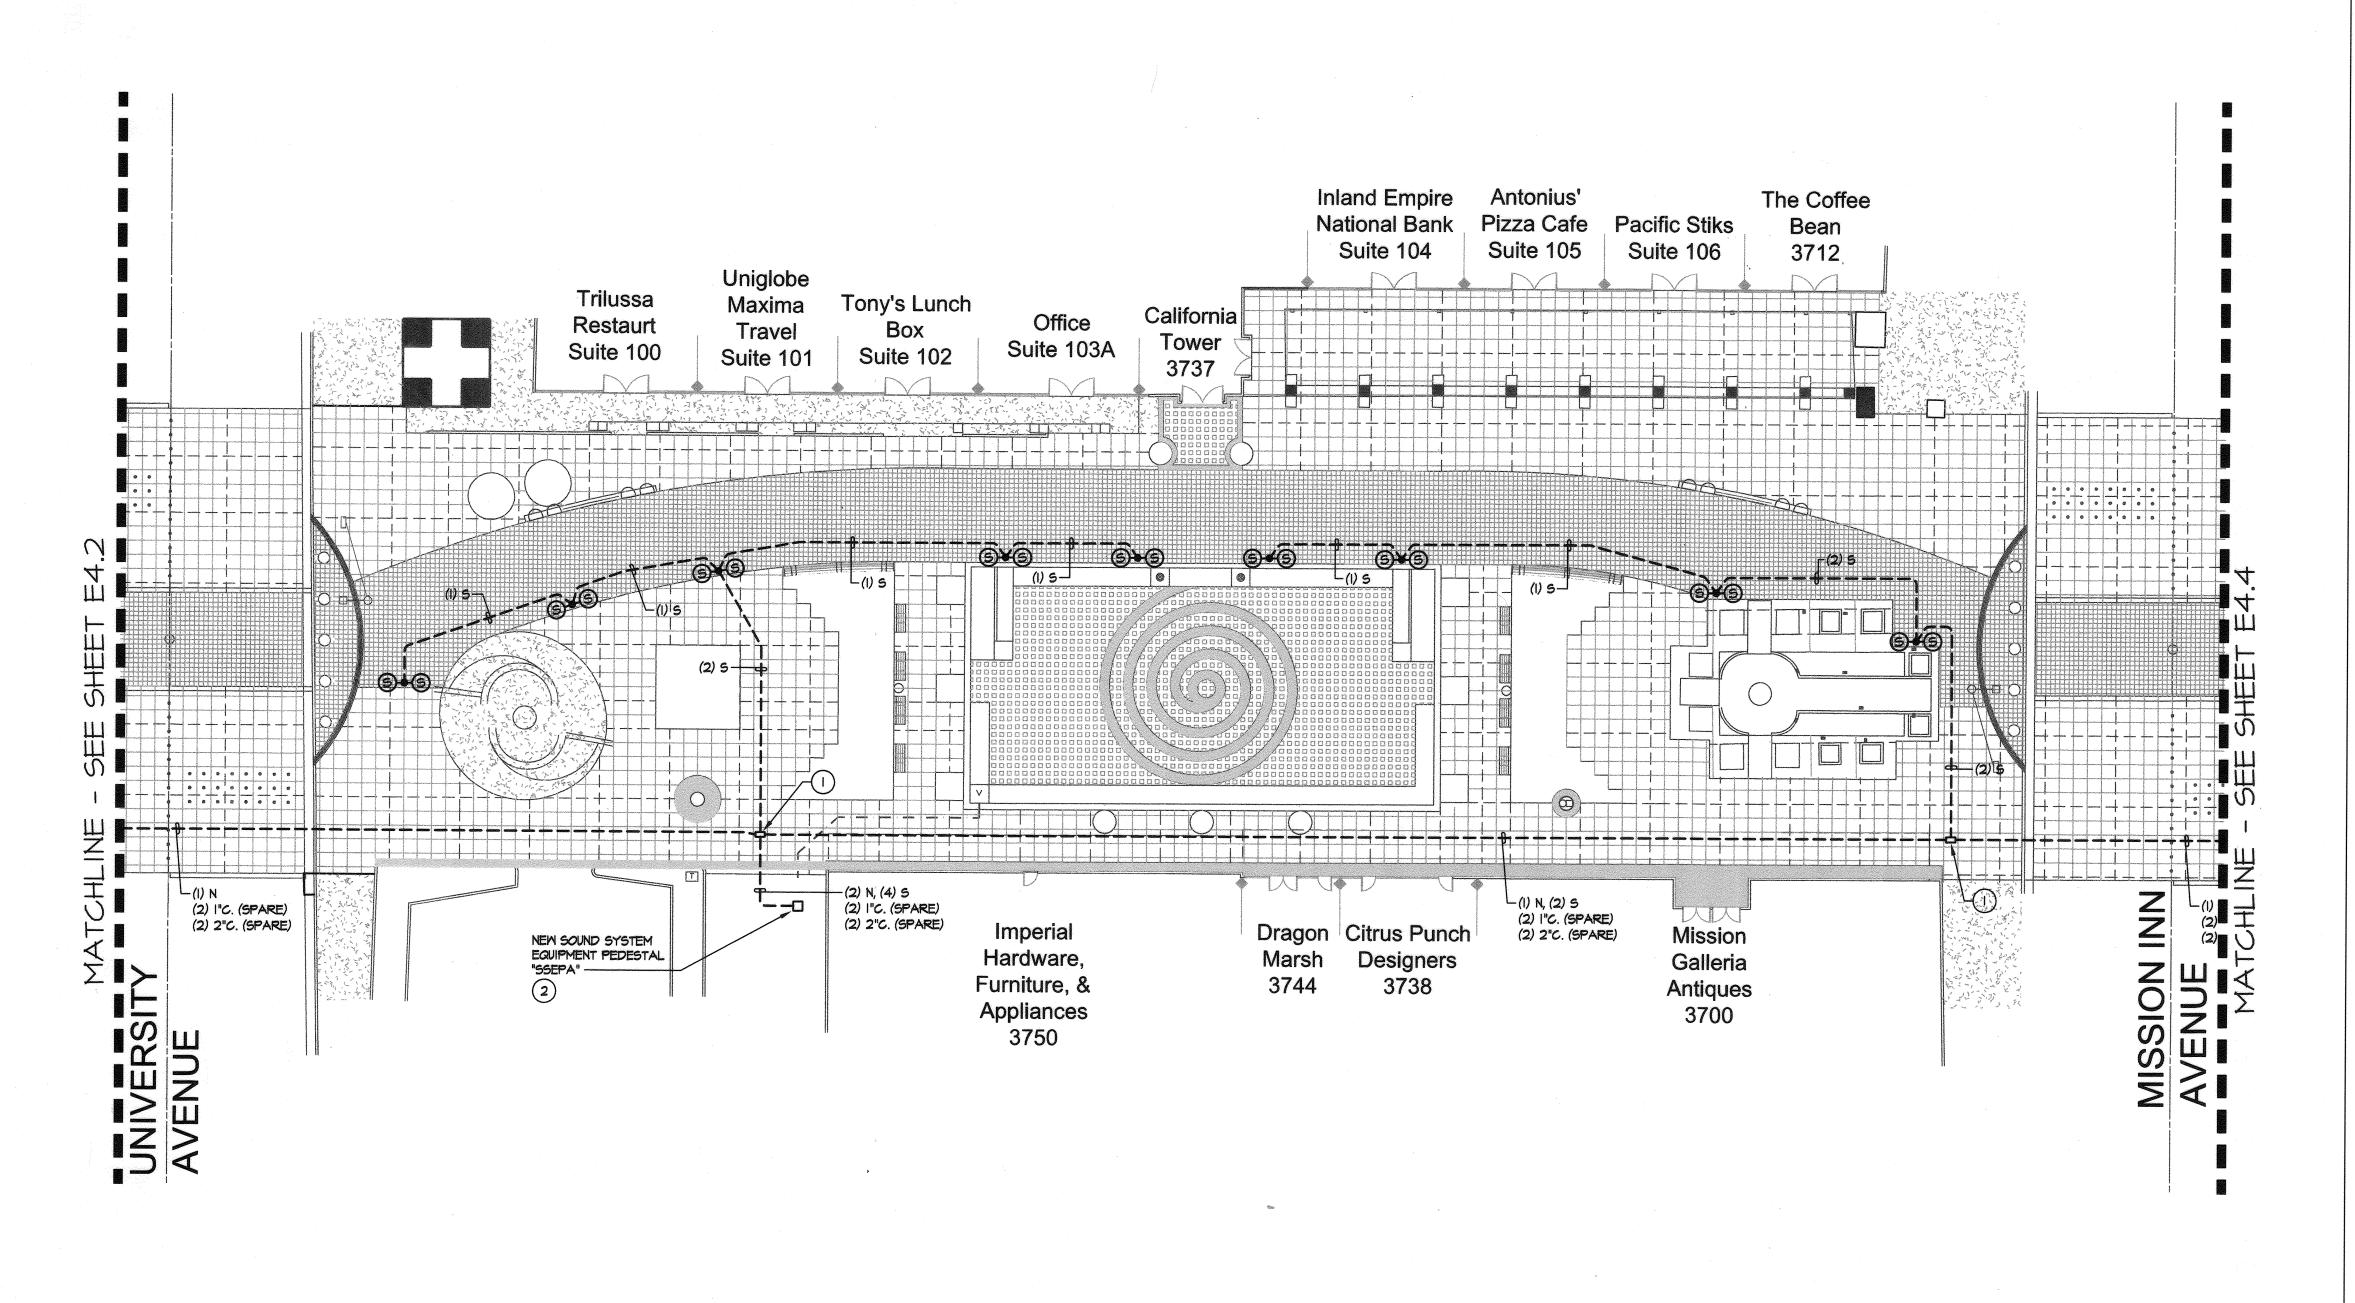

- THE CONTRACTOR SHALL PROVIDE AND INSTALL A 13" X 24" X DEPTH AS REQUIRED UNDERGROUND PULL BOX COMPLETE WITH BOLT DOWN CONCRETE COVER TO READ "SOUND SYSTEM". SPLICES WITHIN UNDERGROUND PULL BOXES FOR LOW VOLTAGE CABLING IS NOT ALLOWED.
- 2) THE CONTRACTOR SHALL PROVIDE AND INSTALL NEW SOUND SYSTEM EQUIPMENT IN NEW PEDESTAL. HE SHALL PROVIDE ALL REQUIRED MATERIALS AND MAKE ALL FINAL TERMINATIONS NECESSARY TO PROVIDE A COMPLETE AND FULLY OPERABLE
- 3 THE CONTRACTOR SHALL NOTE THAT THE DRAWING IS DIAGRAMMATIC. EXACT ROUTING OF NEW CONDUITS AND LOCATION OF NEW JUNCTION BOXES AND NEW PULL BOXES SHALL BE COORDINATED AND DETERMINED IN THE FIELD. NEW CONDUIT ROUTING, NEW JUNCTION BOX AND NEW PULL BOX LOCATIONS SHALL BE ROUTED AND LOCATED IN SUCH A MANNER AS TO AVOID INTERFERENCE WITH EXISTING BUILDING STRUCTURES, UTILITIES AND THE WORK BEING PERFORMED BY OTHER
- REFER TO THE DEMOLITION SITE PLAN FOR ADDITIONAL INFORMATION AND REQUIREMENTS
- 5) REFER TO GENERAL NOTES, SHEET EO.I, FOR ADDITIONAL REQUIREMENTS.

SOUN	ND SYSTEM	CABLING AND CONDUI	T LEGEND
CABLING QUANTITY	CABLING DESIGNATION	CABLING DESCRIPTION	MINIMUM CONDUIT SIZE
1-2	5	14/2 STRANDED SHIELDED	3/4" PVC *
3	5	14/2 STRANDED SHIELDED	I" PVC *
4-6	5	14/2 STRANDED SHIELDED	1 1/4" PVC *
1-3	М	18/2 STRANDED SHIELDED	3/4" PVC *
4 - 5	М	18/2 STRANDED SHIELDED	I" PVC *
1-2	N	6 STRAND FIBER OPTIC	2" PVC *
EXAMPLE:	[	QUANTITY OF CABLES - (3) 5, (2) M	

(SPEAKER) AND 2-18/2 (MICROPHONE) CABLES"


NOTE: ALL CABLES SHALL BE RATED FOR UNDERGROUND USE.


* - ALL CONDUITS SHALL BE PROVIDED WITH A 3/16" PULL ROPE, TAGGED AND IDENTIFIED WITH THE LOCATION OF TERMINATION.

UNDERGROUND SERVICE ALERT 227 · 2600

40' 30' 20' 10' 0

SCALE I"=20'

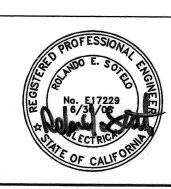

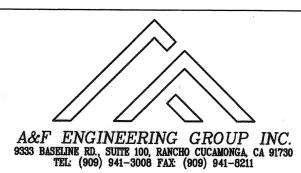






PARTIA	L SOUND S	SYSTEM RENOVATION			1"=20'-0"	
Landscape Architecture REET 92501 AX 951 683 4352 NGDLAINC.COM	Signature 6/30/09 Exp. Date  OF CALIFORNIA		PPR. DATE T	APPROVED BY  BY  DATE  CONST. CONTRACT ADMIN.  PRINCIPAL ENGINEER  STREET SERVICES  SUBJECTOR	IDE, CALIFORNIA S DEPARTMENT  APPROVED BY  CITY ENGINEER  DATE 9/19/07	

DOWNTOWN MALL LANDSCAPE PLANS

は・まっつう 4 ELECTRICAL PLAN E4.3

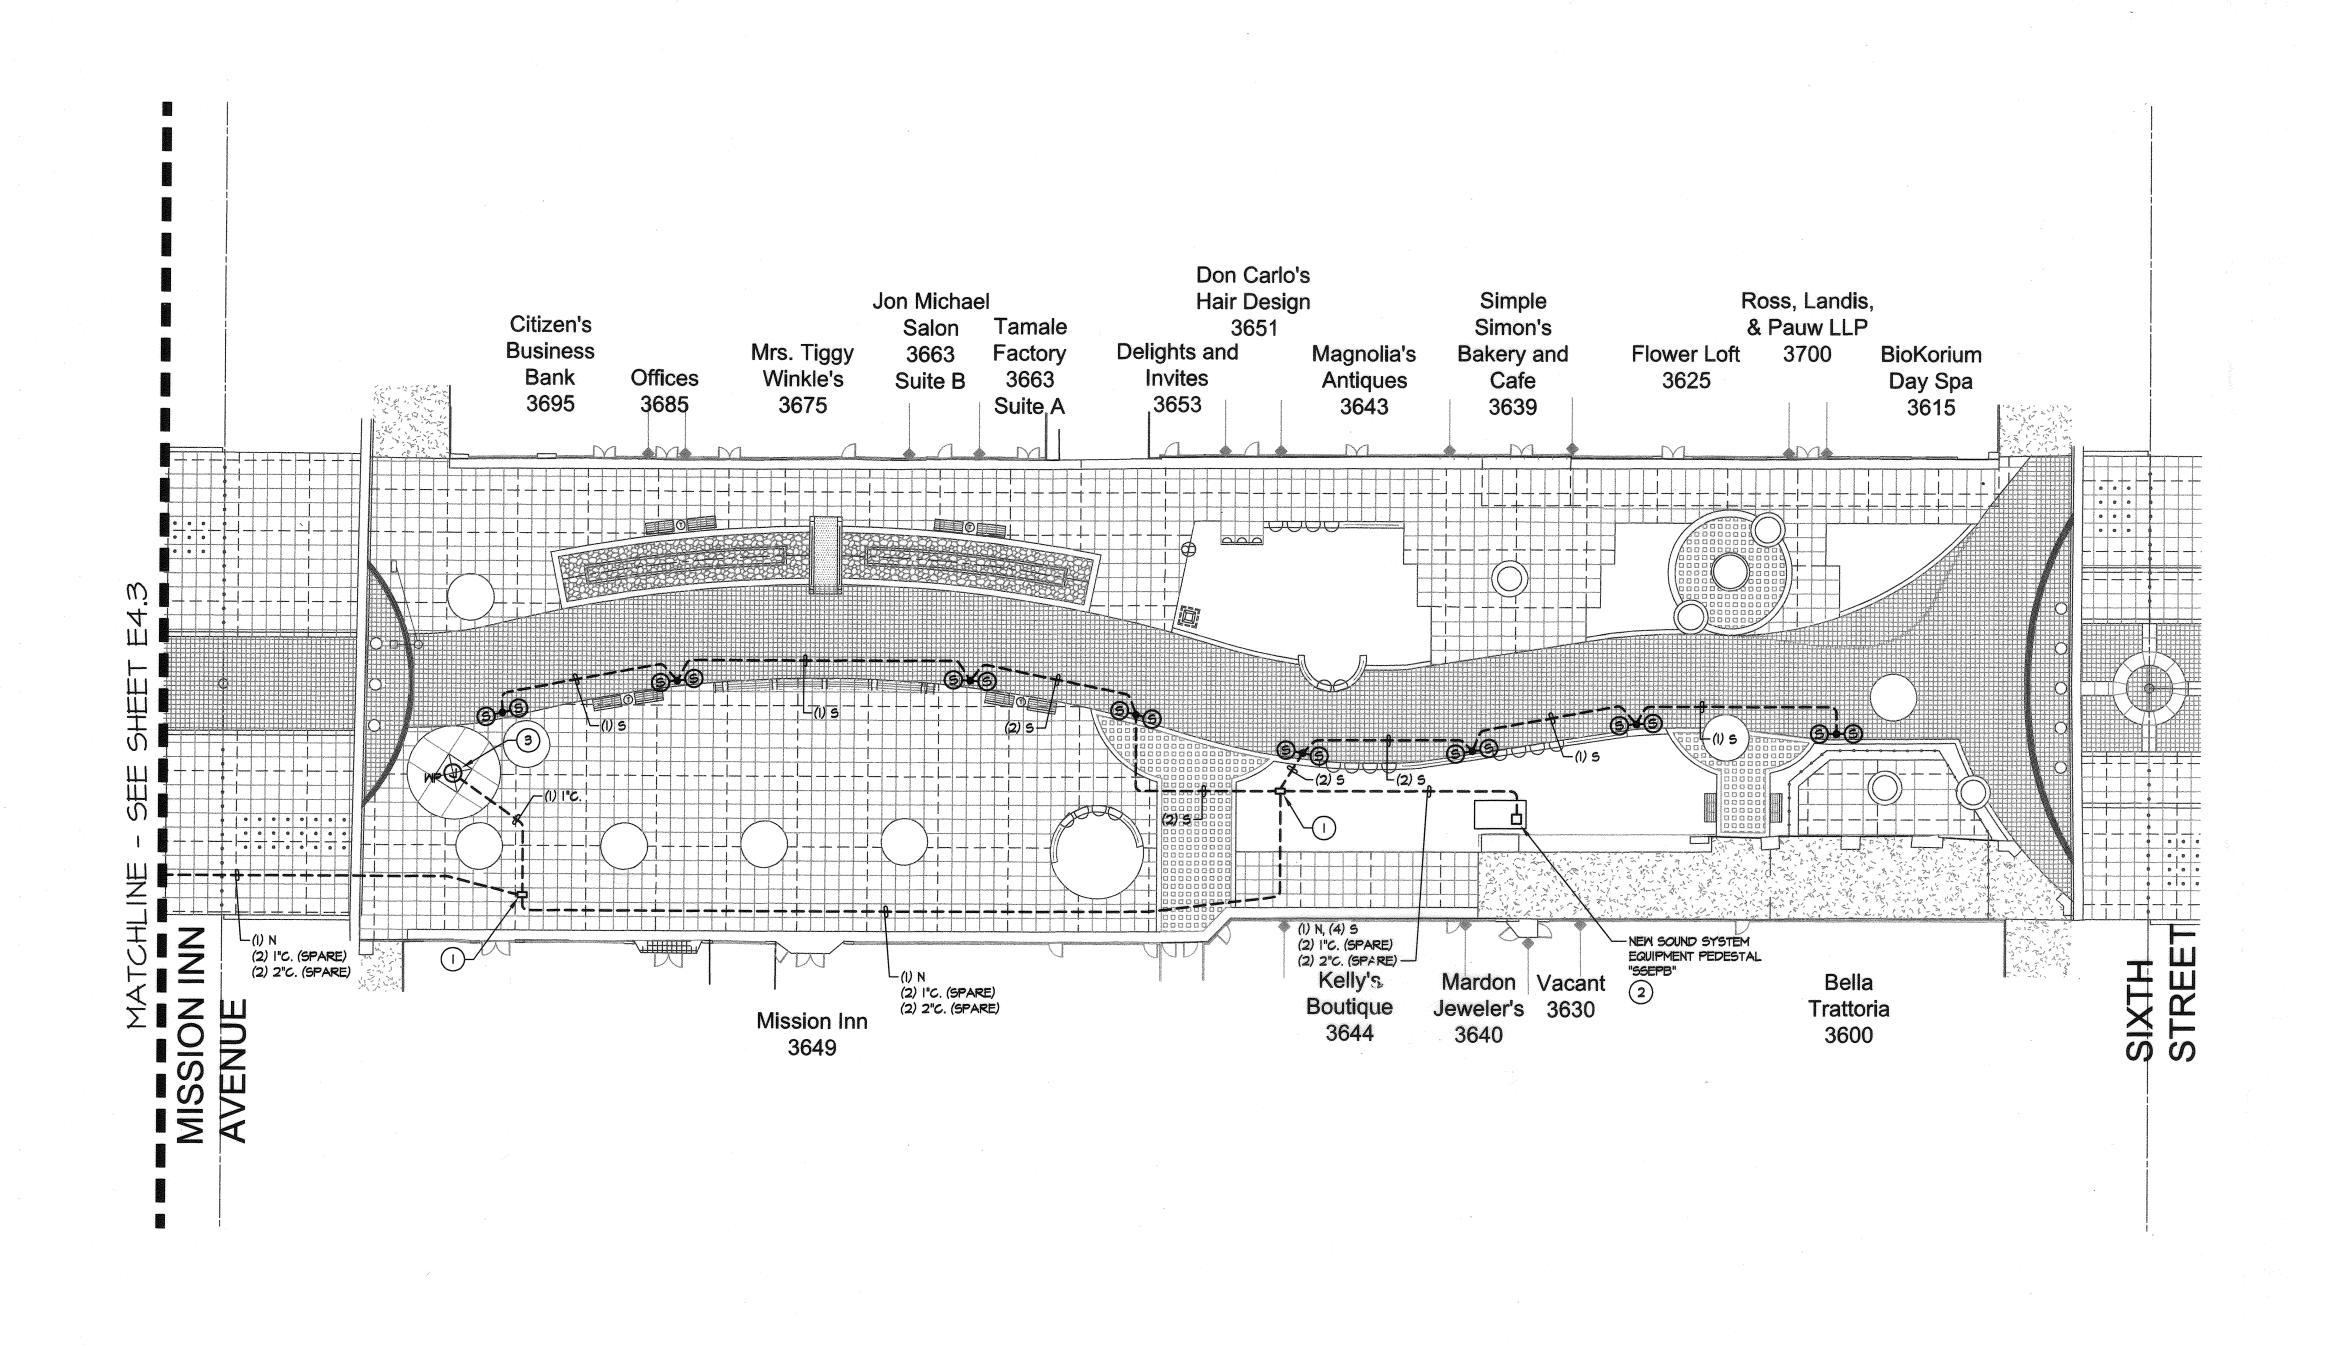

- THE CONTRACTOR SHALL PROVIDE AND INSTALL A 13" X 24" X DEPTH AS REQUIRED UNDERGROUND PULL BOX COMPLETE WITH BOLT DOWN CONCRETE COVER TO READ "SOUND SYSTEM". SPLICES WITHIN UNDERGROUND PULL BOXES FOR LOW VOLTAGE CABLING IS NOT ALLOWED.
- 2) THE CONTRACTOR SHALL PROVIDE AND INSTALL NEW SOUND SYSTEM EQUIPMENT IN NEW PEDESTAL. HE SHALL PROVIDE ALL REQUIRED MATERIALS AND MAKE ALL FINAL TERMINATIONS NECESSARY TO PROVIDE A COMPLETE AND FULLY OPERABLE
- 3 THE CONTRACTOR SHALL COORDINATE EXACT LOCATION OF CONDUIT STUB-UP IN THE FIELD WITH THE KIOSK MANUFACTURER. HE SHALL MAKE ALL REQUIRED ADJUSTMENTS NECESSARY.
- 4 THE CONTRACTOR SHALL NOTE THAT THE DRAWING IS DIAGRAMMATIC. EXACT ROUTING OF NEW CONDUITS AND LOCATION OF NEW JUNCTION BOXES AND NEW PULL BOXES SHALL BE COORDINATED AND DETERMINED IN THE FIELD. NEW CONDUIT ROUTING, NEW JUNCTION BOX AND NEW PULL BOX LOCATIONS SHALL BE ROUTED AND LOCATED IN SUCH A MANNER AS TO AVOID INTERFERENCE WITH EXISTING BUILDING STRUCTURES, UTILITIES AND THE WORK BEING PERFORMED BY OTHER
- 5 REFER TO THE DEMOLITION SITE PLAN FOR ADDITIONAL INFORMATION AND REQUIREMENTS.
- 6 REFER TO GENERAL NOTES, SHEET EO.I, FOR ADDITIONAL REQUIREMENTS.

SOUN	ID SYSTEM	CABLING AND CONDUI	T LEGEND
CABLING QUANTITY	CABLING DESIGNATION	CABLING DESCRIPTION	MINIMUM CONDUIT SIZE
1-2	5	14/2 STRANDED SHIELDED	3/4" PVC *
3	5	14/2 STRANDED SHIELDED	I" PVC *
4-6	5	14/2 STRANDED SHIELDED	1 1/4" PVC *
1-3	М	18/2 STRANDED SHIELDED	3/4" PVC *
4-5	М	18/2 STRANDED SHIELDED	I" PVC *
1-2	N	6 STRAND FIBER OPTIC	2" PVC *
EXAMPLE:	Elizabeth et alexandra and alexandra (1915) (1915) (1916) (1916) (1916) (1916) (1916) (1916) (1916) (1916) (19	QUANTITY OF CABLES	Manager pro-

- (3) S, (2) M

NOTE: ALL CABLES SHALL BE RATED FOR UNDERGROUND USE.


* - ALL CONDUITS SHALL BE PROVIDED WITH A 3/16" PULL ROPE, TAGGED AND IDENTIFIED WITH THE LOCATION OF TERMINATION.


UNDERGROUND SERVICE ALERT CALL: TOLL FREE

40' 30' 20' 10' 0

SCALE I"=20'

20'

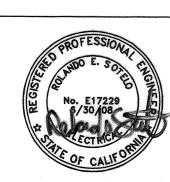

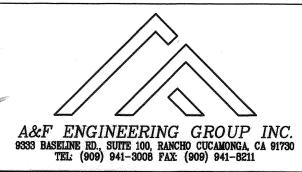







PARTIA	AL SOUND S	SYSTEM RENOVAT	TON S	SITE PLAN	1"=20'-0"	)1
Landscape Architecture REET 92501 NX 951 883 4352	LANDSCAPE AND LA	A RE-NUMBERED SHEET	AFD 12.4-		SIDE, CALIFORN KS DEPARTMEN	i i
AX 951 883 4352 IGIDLAINC.COM	Signature Signature			APPROVED BY BY DATE CONST. CONTRACT ADMIN. SO TIME	APPROVED BY	
	6/30/08 Exp. Date	MARK REVISIONS	APPR. DATE	PRINCIPAL ENGINEER STREET SERVICES SURVEYOR	CITY ENGINEER	
	PIE OF CALFORN	DESIGNED BY MWK DRAWN BY MWK CHECKED	DEC	TRAFFIC DIVISION J. 4. 17-12-0 PARKS DEPARTMENT	DATE 9/19/67	

DOWNTOWN MALL LANDSCAPE PLANS 12-3 8-23-2007 ELECTRICAL PLAN E4.4 100

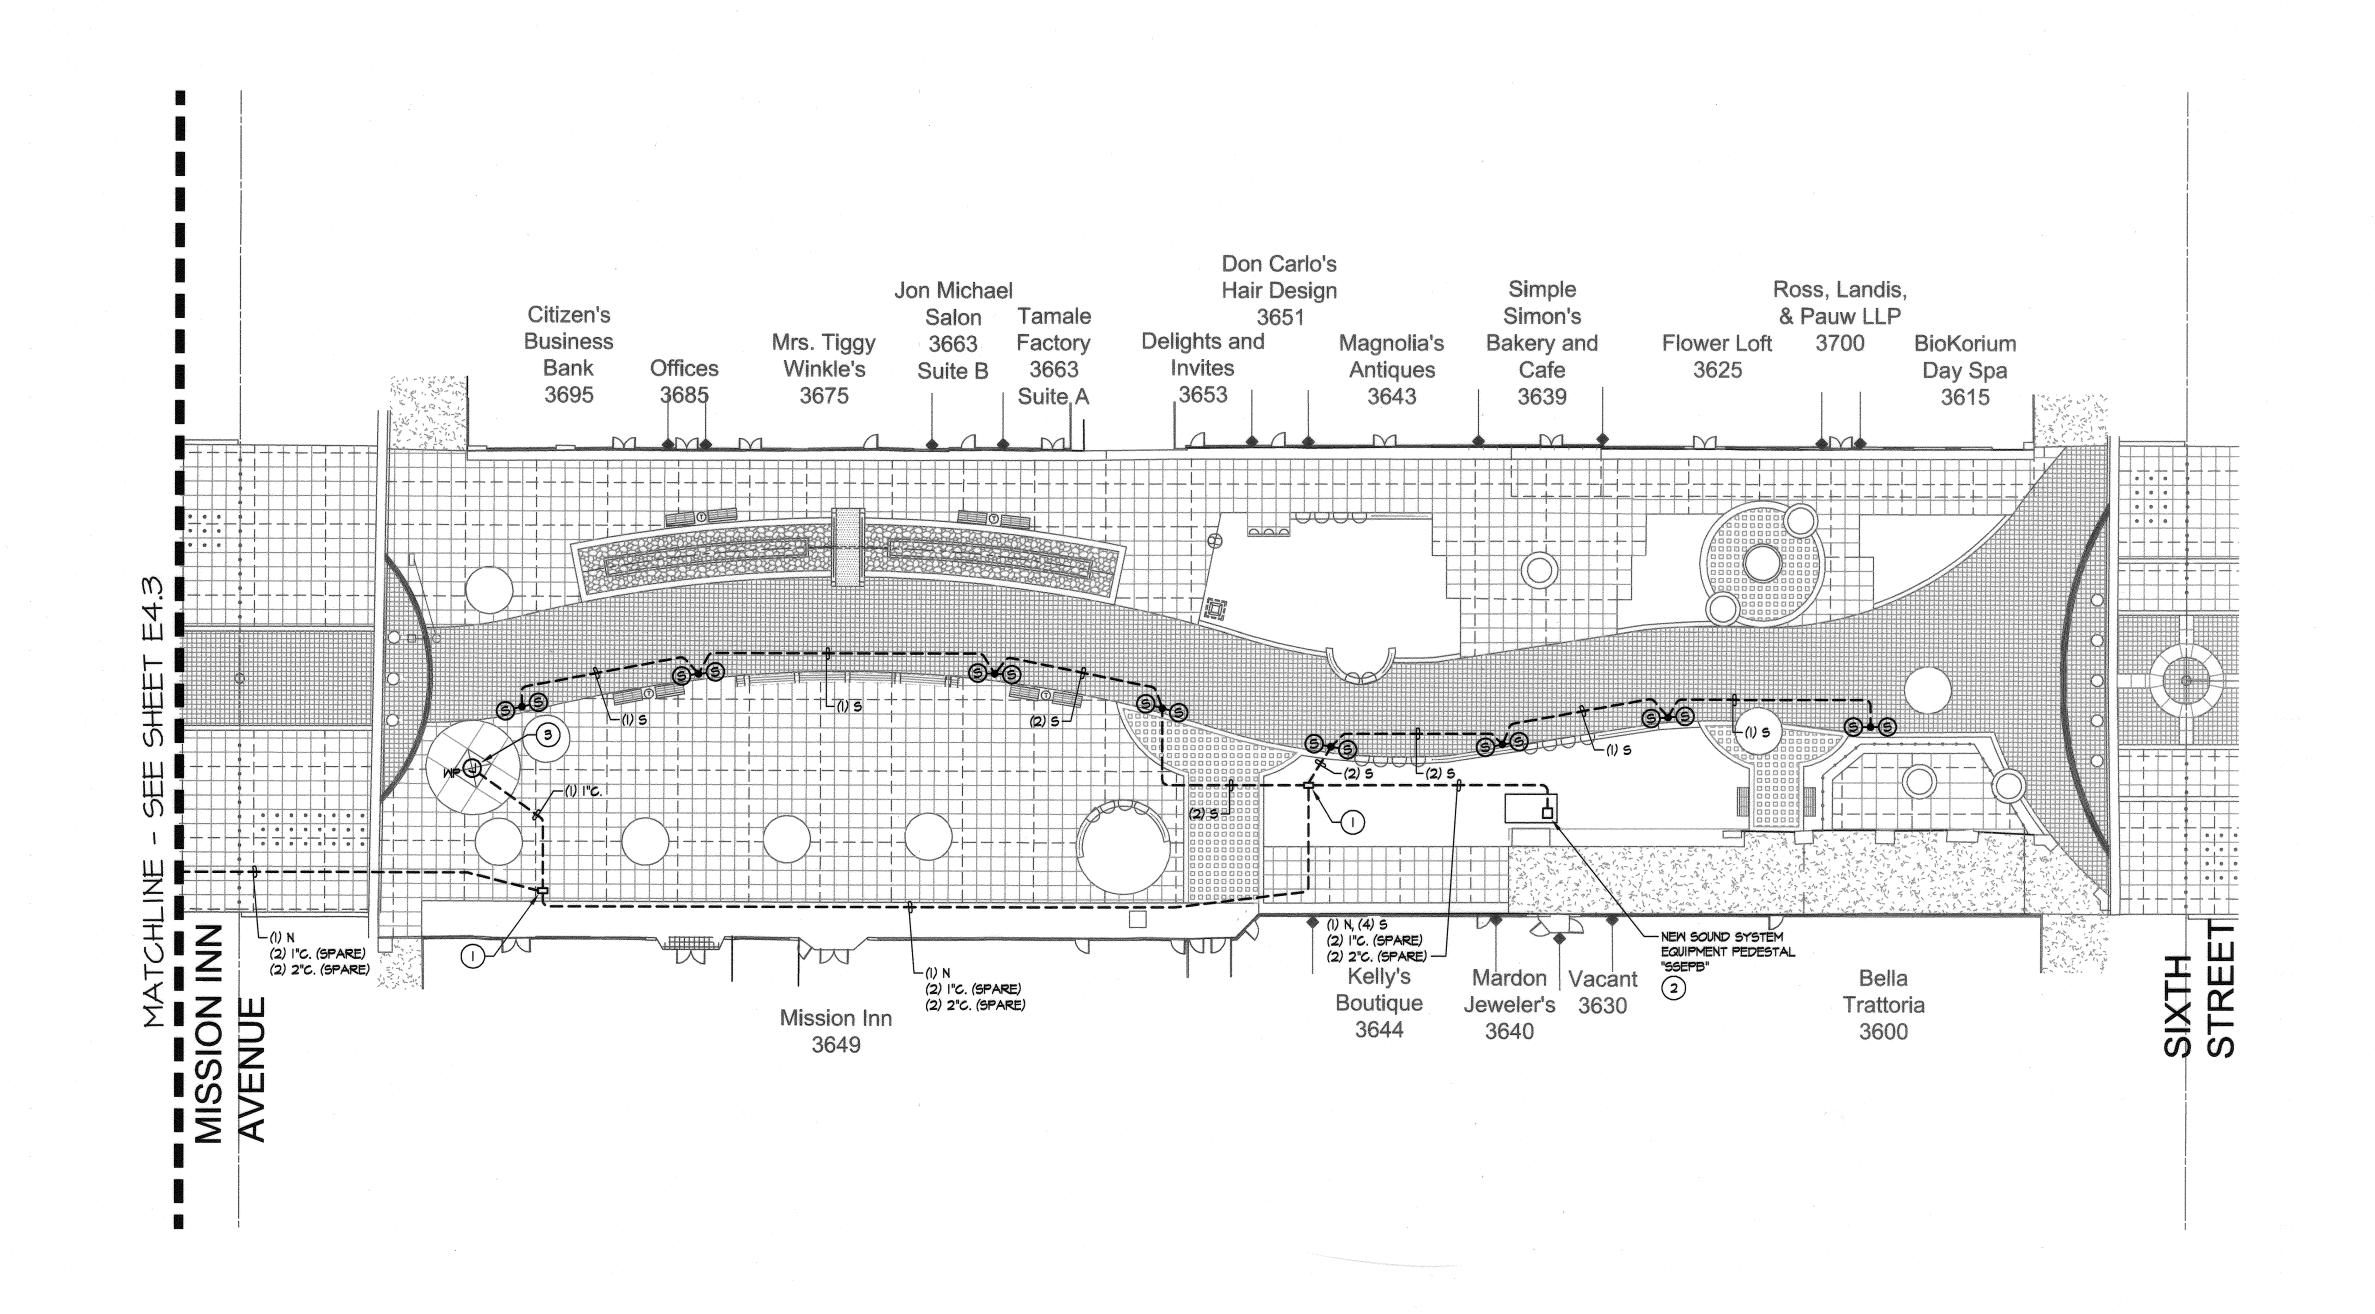

- THE CONTRACTOR SHALL PROVIDE AND INSTALL A 13" X 24" X DEPTH AS REQUIRED UNDERGROUND PULL BOX COMPLETE WITH BOLT DOWN CONCRETE COVER TO READ "SOUND SYSTEM". SPLICES WITHIN UNDERGROUND PULL BOXES FOR LOW YOLTAGE CABLING IS NOT ALLOWED.
- THE CONTRACTOR SHALL PROVIDE AND INSTALL NEW SOUND SYSTEM EQUIPMENT IN NEW PEDESTAL. HE SHALL PROVIDE ALL REQUIRED MATERIALS AND MAKE ALL FINAL TERMINATIONS NECESSARY TO PROVIDE A COMPLETE AND FULLY OPERABLE
- 3 THE CONTRACTOR SHALL COORDINATE EXACT LOCATION OF CONDUIT STUB-UP IN THE FIELD WITH THE KIOSK MANUFACTURER. HE SHALL MAKE ALL REQUIRED ADJUSTMENTS NECESSARY.
- 4 THE CONTRACTOR SHALL NOTE THAT THE DRAWING IS DIAGRAMMATIC. EXACT ROUTING OF NEW CONDUITS AND LOCATION OF NEW JUNCTION BOXES AND NEW PULL BOXES SHALL BE COORDINATED AND DETERMINED IN THE FIELD. NEW CONDUIT ROUTING, NEW JUNCTION BOX AND NEW PULL BOX LOCATIONS SHALL BE ROUTED AND LOCATED IN SUCH A MANNER AS TO AVOID INTERFERENCE WITH EXISTING BUILDING STRUCTURES, UTILITIES AND THE WORK BEING PERFORMED BY OTHER
- 5 REFER TO THE DEMOLITION SITE PLAN FOR ADDITIONAL INFORMATION AND REQUIREMENTS
- 6 REFER TO GENERAL NOTES, SHEET EO.I, FOR ADDITIONAL REQUIREMENTS.

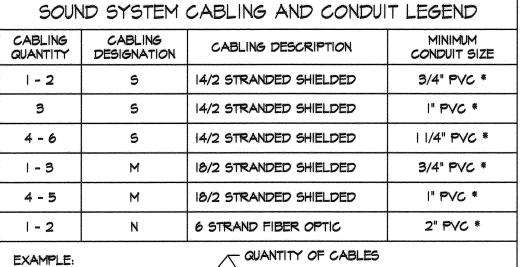


(3) S, (2) M ABOVE EXAMPLE "(3) S, (2) M" MEANS "3-14/2 (SPEAKER) AND 2-18/2 (MICROPHONE) CABLES"


NOTE: ALL CABLES SHALL BE RATED FOR UNDERGROUND USE.

* - ALL CONDUITS SHALL BE PROVIDED WITH A 3/16" PULL ROPE, TAGGED AND

IDENTIFIED WITH THE LOCATION OF TERMINATION.

UNDERGROUND SERVICE ALERT

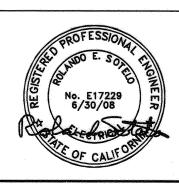

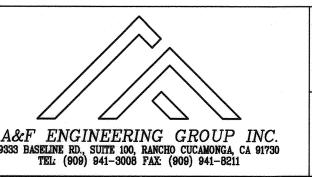





PARTIAL SOUND SYSTEM RENOVATION SITE PLAN

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1	RENUMBERED SHEET		12-04.	O CITY OF	RIVI	ERSI	DE, CALIFORNIA	
-							S DEPARTMENT	
				APPROVED BY			APPROVED BY	
				CONST. CONTRACT ADMIN. PRINCIPAL ENGINEER	100	15/67	glantsel	
				STREET SERVICES	- T 1 1 1 1 1 1 1 1 1 1 1 1 1 1 1 1 1 1	- 115	CITY ENGINEER	
	REVISIONS	APPR.	DATE	SURVEYOR TRAFFIC DIVISION			ntelm	
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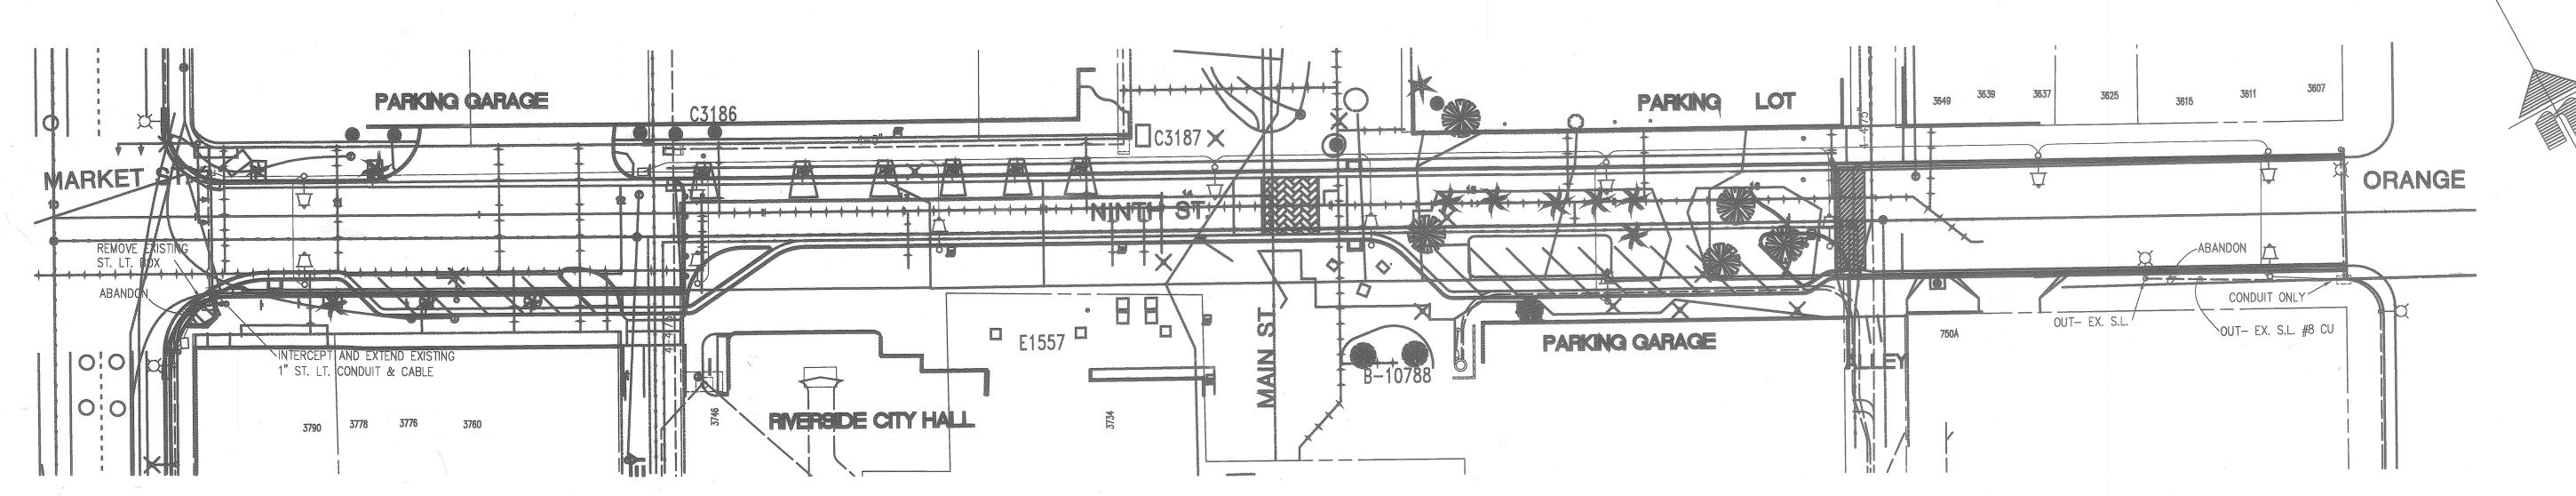
1"=20'-0"

DOWNTOWN MALL LANDSCAPE PLANS

12-03-2007 ELECTRICAL PLAN

40' 30' 20' 10' 0


SCALE I"=20'




#### STREET LIGHT NOTES

- 1. ALL FACILITIES INSTALLED BY DEVELOPER SHALL BE INSPECTED AND APPROVED BY THE DEPARTMENT CONSTRUCTION INSPECTOR (951 826-2415). ANY CHANGES SHALL BE APPROVED BY THE DEPARTMENT PRIOR TO EXECUTION. THE CONTRACTOR SHALL BE RESPONSIBLE FOR COORDINATING ALL PHASES OF CONSTRUCTION WITH THE DEPARTMENT CONSTRUCTION INSPECTOR.
- 2. PROVIDE AND INSTALL ALL STREET LIGHT FACILITIES SHOWN INCLUDING STREET LIGHT CABLE, IN CONFORMANCE WITH THE FOLLOWING STANDARD DRAWINGS: UGS-100, UGS-800 RC & STREET LIGHT SPECIFICATION #2-6.
- 3. EXCAVATION FOR STREET LIGHT CONDUIT & ELECTROLIER FOUNDATIONS MUST BE DONE AFTER INSTALLATION OF CURBS & GUTTERS, BUT BEFORE INSTALLATION OF CURB RETURNS WITH SPANDRELS, CROSS GUTTERS, SIDEWALKS, AND DRIVE APRONS.
- 4. INSTALL A WATERPROOF "IN-LINE" FUSE HOLDER ON THE PHASE LEG CONDUCTOR(S) IN THE BASE OF EACH STREET LIGHT STANDARD. FUSE HOLDER TO BE "BUSSMAN TRON" #HEB COMPATIBLE WITH SIZE AND TYPE OF WIRE WITH A "BUSSMAN" FNM 10 AMP 250V FUSE OR APPROVED EQUAL.
- 5. MARK INSTALLATION DATE ON PHOTO CONTROLS AND LAMPS AS PROVIDED FOR BY
- 6. ACQUIRE A STREET OPENING PERMIT PRIOR TO EXCAVATING IN STREET RIGHT-OF-WAY.
- 7. THIS PLAN IS ACCURATE FOR STREET LIGHT FACILITIES ONLY. SEE STREET IMPROVEMENT PLAN R-3922 FOR STREET IMPROVEMENT DETAILS.
- 8. ALL STREET LIGHT FEED POINTS TO BE CONNECTED BY PUBLIC UTILITIES AND ENERGIZED WHEN CLEARED BY DEPARTMENT INSPECTOR.
- 9. STREET LIGHT SERVICE POINTS ARE 3 WIRE, 240V SYSTEM. THE THIRD STREET LIGHT WIRE IS TO BE USED AS A BOND WIRE ONLY, AS NOTED IN SPECIFICATION # 2-6. FEED POINTS TO BE CONFIRMED AT THE TIME OF CONSTRUCTION.
- 10. ALL CABLE TO BE AWG. #8 COPPER AS SPECIFIED IN STREET LIGHT SPECIFICATION #2-6 (STREET LIGHT CABLE).
- 11. CONDUIT AND FITTINGS TO BE IN CONFORMANCE WITH UGS-100. BACKFILL TO BE TYPE AND COMPACTED AS SPECIFIED IN UGS-100.1.
- 12. STREET LIGHT DOOR OPENING TO FACE SIDEWALK.
- 13. ALL CONTRACTORS WORKING ON OR AROUND THE DEPARTMENT'S UNDERGROUND ELECTRICAL FACILITIES MUST HAVE THE PROPERLY QUALIFIED PERSONNEL AND EQUIPMENT TO PERFORM THE SPECIFIED WORK. THE CONTRACTOR WILL BE SOLELY RESPONSIBLE TO ESTABLISH AND MAINTAIN A SAFE WORKING ENVIRONMENT INCLUDING, BUT NOT LIMITED TO WORK AROUND ENERGIZED HIGH VOLTAGE FACILITIES, GAS TESTING OF CONFINED SPACES, TRAFFIC AND PROTECTION. THE DEPARTMENT'S POLICY IS TO PROVIDE ONE (1) QUALIFIED OBSERVER AFTER 24 HOURS NOTICE, TO STAND BY DURING WORK AND PROVIDE RADIO CONTACT WITH CITY OPERATIONS CONTROL. EVERY ENTRY BY ANY PERSONNEL INTO A PUBLIC UTILITIES HIGH VOLTAGE STRUCTURE WILL REQUIRE THE PRESENCE OF A QUALIFIED ELECTRICAL WORKER IN ACCORDANCE WITH Cal/OSHA. ALL DEVELOPERS AND CONTRACTORS ARE REQUIRED TO SUBMIT REQUIRED DOCUMENTATION AND FOLLOW REQUIRED PROCEDURES. COPIES OF THE POLICY AND DOCUMENTS MAY BE OBTAINED AT 3900 MAIN ST. RIVERSIDE, CA OR AT WWW.RIVERSIDEPUBLICUTILITES.COM
- 14. THE CITY OBSERVER HAS THE AUTHORITY TO STOP THE CONTRACTOR'S WORK IF HE DETERMINES THAT ADEQUATE SAFETY PRECAUTIONS ARE NOT BEING TAKEN. HOWEVER, THE PRESENCE OF THE CITY OBSERVER DOES NOT RELIEVE THE CONTRACTOR OF HIS RESPONSIBILITY FOR INSURING SAFE AND APPROPRIATE WORK PRACTICES.

CONTACT ENGINEER- CHRIS BARNES (951) 826-5911

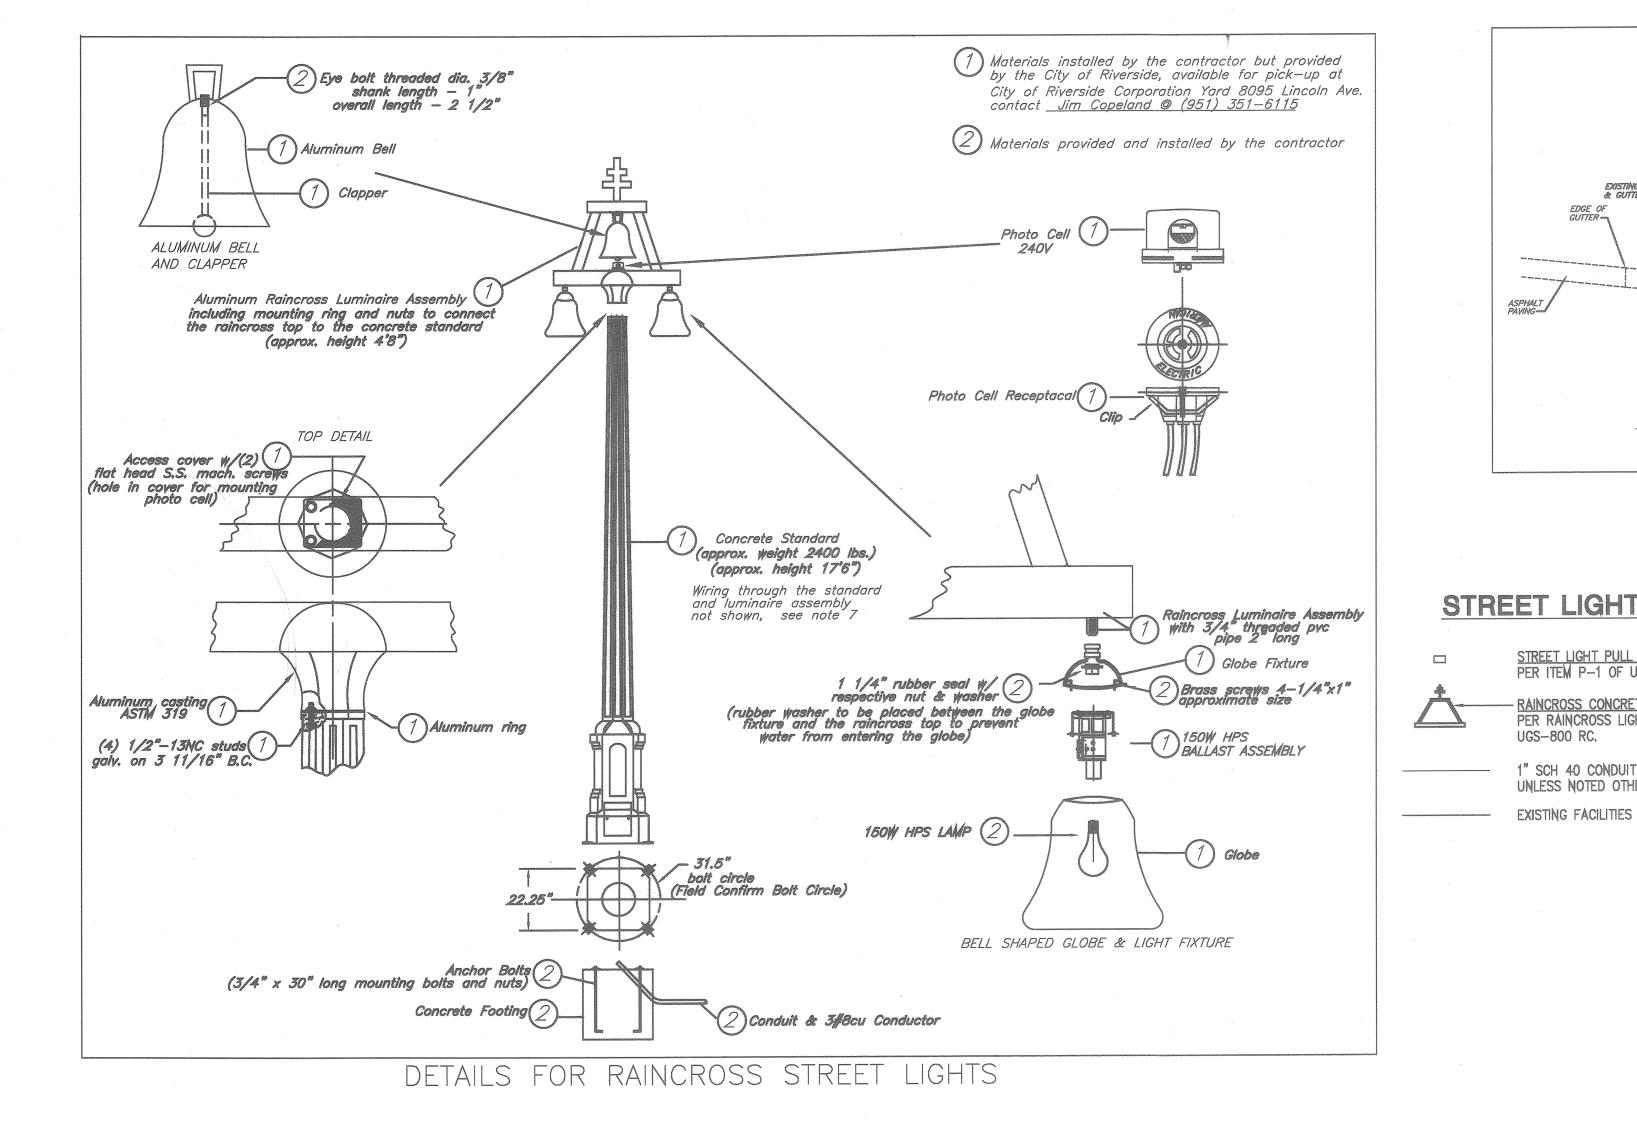


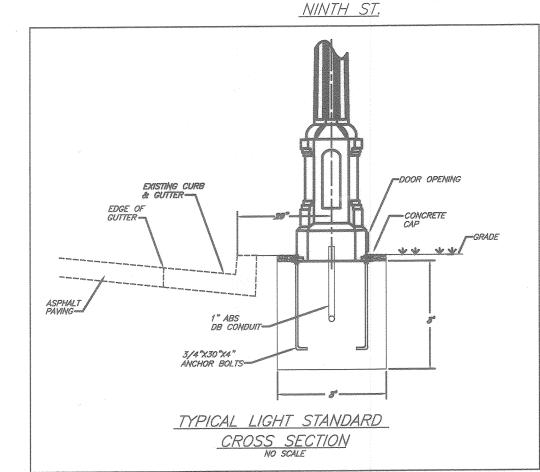

# STREET LIGHT LEGEND


STREET LIGHT PULL BOX (10"X17"X12")
PER ITEM P-1 OF UGS-800, INSTALL PER UGS-320 - RAINCROSS CONCRETE DECORATIVE LIGHTING PER RAINCROSS LIGHTING REQUIREMENTS,

UGS-800 RC. 1" SCH 40 CONDUIT WITH 3 #8 CU 600V CABLES UNLESS NOTED OTHERWISE.

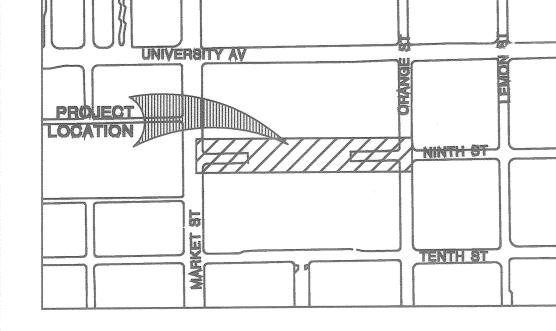





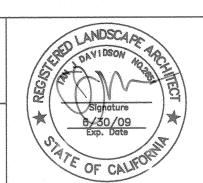

		P				CITY OF RIVERSIDE, CALIFORNIA PUBLIC WORKS DEPARTMENT
A RE	P.ACE	PLAN	SHEET	AFD.	1260	APPROVED BY  CONST. CONTRACT ADMIN.  PRINCIPAL ENGINEER  OU  OTHER STREET SERVICES  APPROVED BY  CITY ENGINEER  CITY ENGINEER
MARK		REVISIONS		APPR.	DATE	SURVEYOR TRAFFIC DIVISION

DOWNTOWN MALL LANDSCAPE PLANS

12/95/07 NINTH ST. LIGHTS M - 457SHEET 100 OF 100