


BENCH MARK: F.R. 505/46 WEISS
LEAD # TIN ON TOP OF DRAIN
HEADWALL - 5/8\"/>

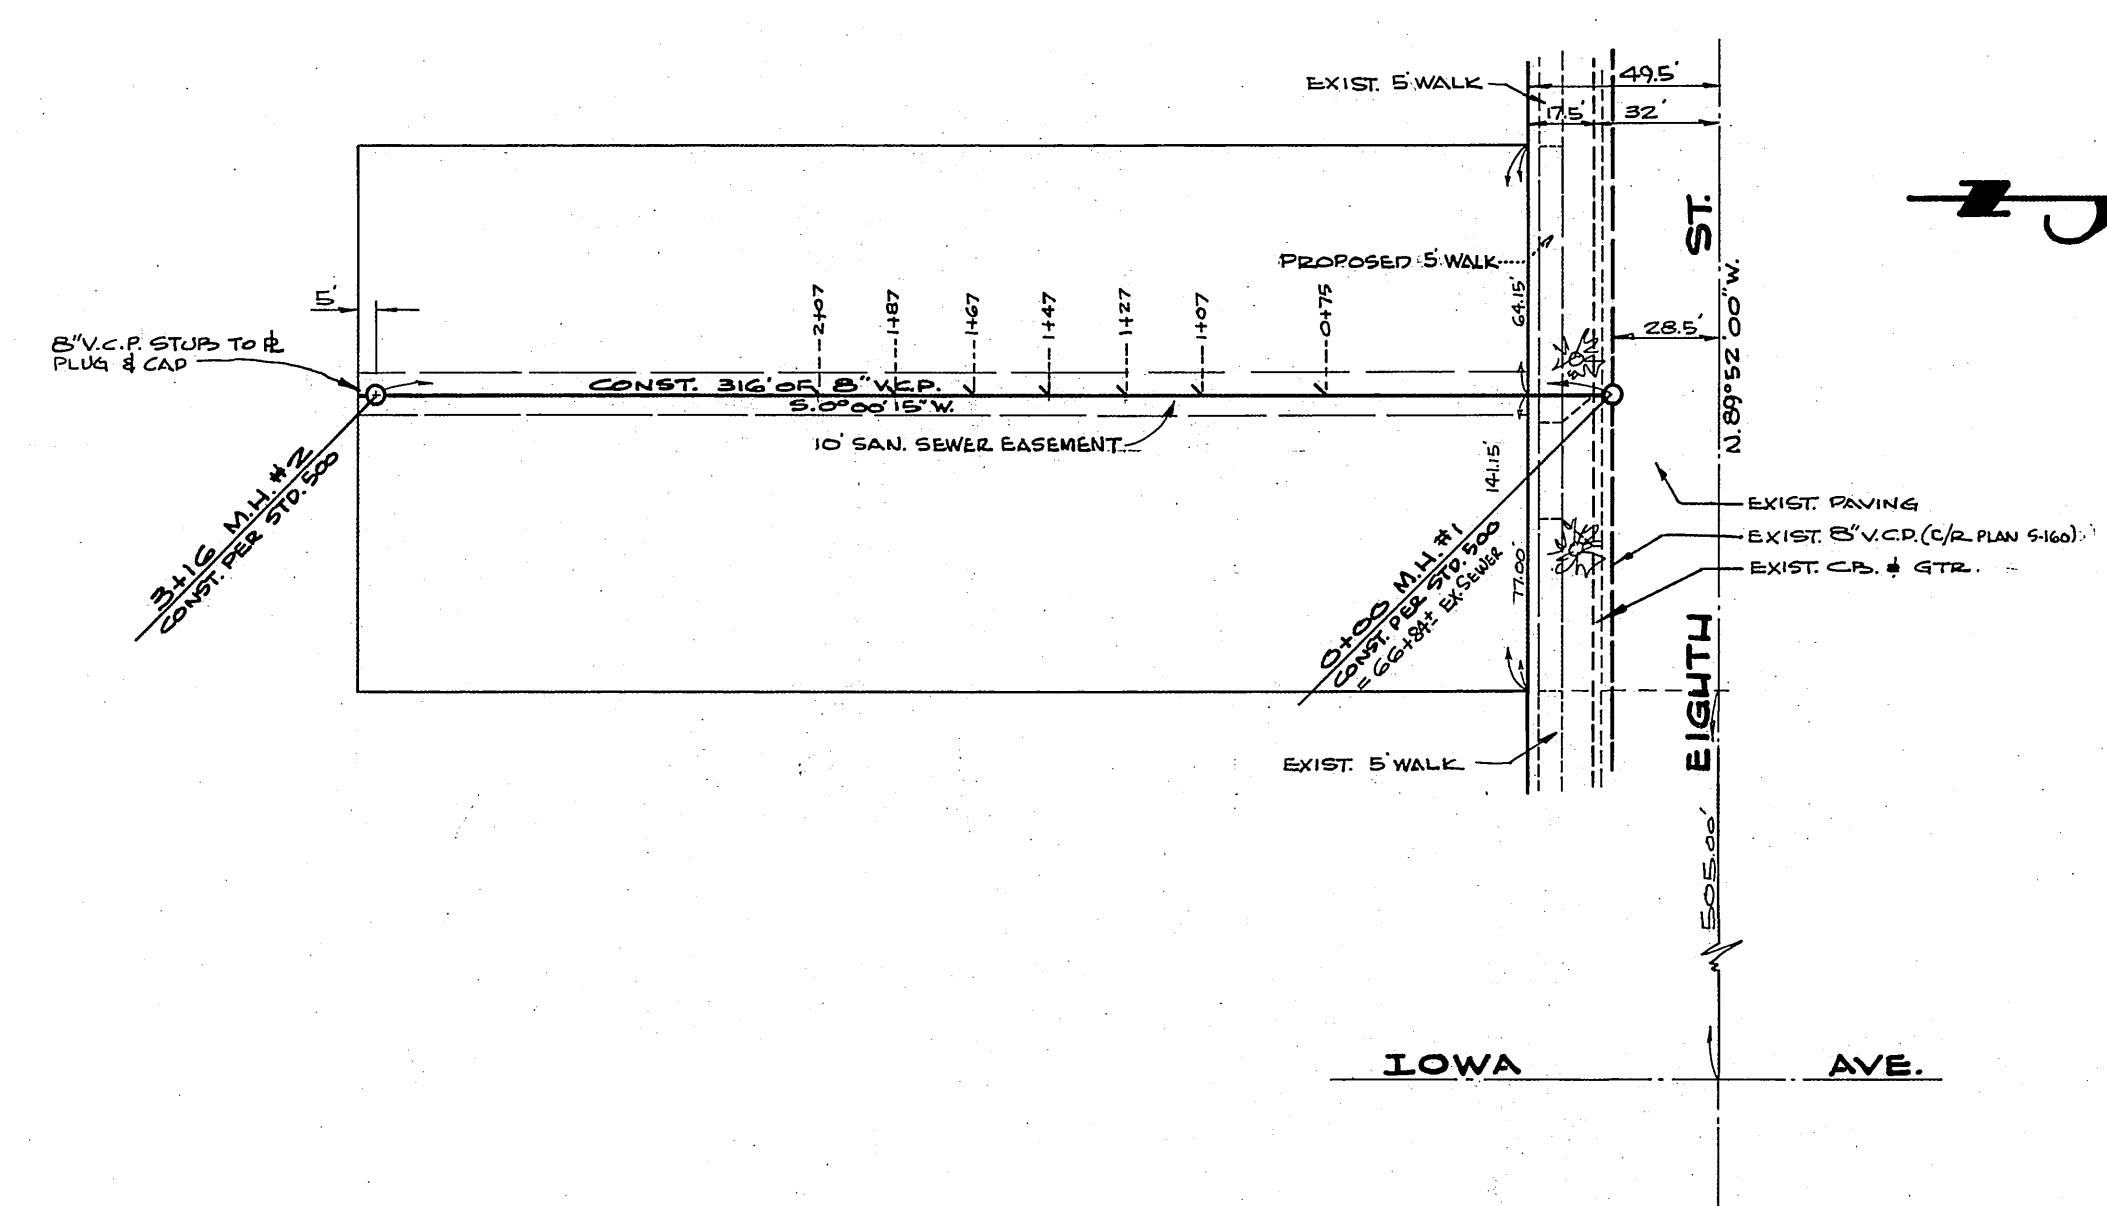

QUANTITY ESTIMATE

8" VITRIFIED CLAY PIPE	316 L.F.
MANHOLE - STD. 500	2 EA.
PAVING REPLACEMENT	15 S.F.
8" x 4" WYES	7 EA.

GENERAL NOTES

1. CONSTRUCTION SHALL BE IN ACCORDANCE WITH THE CITY OF RIVERSIDE, DEPARTMENT OF PUBLIC WORKS, STANDARD SPECIFICATIONS NO. 461 AND STANDARD DRAWINGS.
2. IT SHALL BE THE RESPONSIBILITY OF THE CONTRACTOR TO CLEAR THE RIGHT OF WAY IN ACCORDANCE WITH THE PROVISIONS OF THE LAW AS IT AFFECTS EACH UTILITY INCLUDING IDENTIFICATION LINES AND APPURTENANCES AND AT NO COST TO THE CITY.
3. JOINTS IN VITRIFIED CLAY PIPE SEWERS SHALL CONFORM TO ASTM STANDARD C-425-60T, OR THE LATEST REVISION THEREOF.
4. PIPE SHALL BE BEDDED PER CASE II, STANDARD DRAWING NO. 452, UNLESS OTHERWISE SPECIFIED ON PLAN.
5. PRIOR TO CONSTRUCTION OF SEWER, CONTRACTOR IS TO EXPOSE EXISTING SEWER AND CONTACT ENGINEER FOR VERIFICATION OF EXISTING LOCATION AND ELEVATION.
6. MANHOLE FRAMES AND COVERS TO BE SET TO EXISTING PAVING GRADES UNLESS OTHERWISE NOTED.

NOTICE TO CONTRACTOR:
THE EXISTENCE AND LOCATION OF ANY UNDERGROUND UTILITY PIPES OR STRUCTURES SHOWN ON THESE PLANS ARE OBTAINED BY A SEARCH OF THE AVAILABLE RECORDS. TO THE BEST OF OUR KNOWLEDGE, THERE ARE NO EXISTING UTILITIES, EXCEPT AS SHOWN ON THESE PLANS.
THE CONTRACTOR IS TO TAKE THE PRECAUTIONARY MEASURES TO PROTECT THE UTILITY LINES SHOWN AND ANY OTHER LINES NOT OF RECORD OR NOT SHOWN ON THESE PLANS.

Not built
Jan 11/18/71

ALBERT A. WEBB ASSOCIATES CIVIL ENGINEERS RIVERSIDE, CALIFORNIA APPROVED BY <i>[Signature]</i> DATE 10/4/66 R.E. No. 3876	CITY OF RIVERSIDE, CALIFORNIA DEPARTMENT OF PUBLIC WORKS APPROVED BY <i>[Signature]</i> DATE 11-19-64 DIRECTOR OF PUBLIC WORKS	PROJECT NO. S-587
		SHEET 1 OF 1 FILE NO. 64-310 B
W.O. 24-310 FOR: M. WEISS F.B. 505 DESIGNED BY D.R.B. DRAWN BY D.R.B. CHECKED BY A.W.	REVISIONS APPR. DATE	SEWER PLAN AND PROFILE R. S. 861 EASEMENT SEWER SOUTHERLY FROM EIGHTH STREET WESTERLY OF IOWA AVENUE HORIZ. SCALE: 1" = 50' VERT. SCALE: 1" = 5'