

BENCH MARK:
STEEL PIN IN WEST CURB MULBERRY ST
5' SOUTH OF E. FIRST ST. ELEV. 627.199

CONST. PORTION OF ALLEY APPROACH
PER STD. 302 TO JOIN EXISTING
IMPROVEMENTS AS SHOWN.
REMOVE EXIST. CURB, GUTTER, SIDEWALK,
& PAVING & DRIVEWAY APPROACH
REMOVE EXIST. COAL BIN ACCESS
2" x 4" REDWOOD HEADERS


QUANTITY ESTIMATE

- CURB ONLY - 8' CFT. TO JOIN EXIST.
- DRIVEWAY APPROACH - STD. 302 - (AS SHOWN)
- ALLEY GUTTER - 4' CONC. - STD. 110
- 2 1/2" A.C. PAVING
- IMPROVED BASE MATERIAL
- REMOVE EXIST. CURB, GUTTER, SIDEWALK,
& PAVING & DRIVEWAY APPROACH
- REMOVE EXIST. COAL BIN ACCESS
- 2" x 4" REDWOOD HEADERS

- 1 EA.
- 101 LF.
- 20 CY.
- L.C.
- L.C.
- 9 LF.

- GENERAL NOTES
- (1) It shall be the responsibility of the contractor to obtain all necessary rights of way in accordance with each utility, including utility of no cost to the City.
 - (2) Construction shall be in accordance with the Department of Public Works drawings.
 - (3) Prime coat, seal coat, and paint binder shall be applied.
 - (4) Grading will require a permit under Chapter 1141, existing HDS will be maintained.
 - (5) Traffic signs and markings shall be installed in accordance with the Department of Public Works drawings.
 - (6) Traffic signs and markings shall be installed in accordance with the Department of Public Works drawings.

- (A) ALL STREET LIGHT STANDARDS AND PULLBOXES TO BE LOCATED IN THE ROAD.
 - (B) ALL STREET LIGHT STANDARDS SHALL BE CHECKED FOR CLEARANCE OF DRIVEWAYS AND PLACED 5' FROM END OF CURB RETURNS.
 - (C) SEE CITY OF RIVERSIDE DES. NO. 11-FR-008 FOR LIGHT STANDARD DETAILS.
 - (D) ALL CABLE TO BE AWG NO. 8 COPPER.
 - (E) THIS IS A 2 WIRE, 120 VOLT MULTIPLE SYSTEM.
 - (F) ALL CONSTRUCTION TO COMPLY WITH CITY OF RIVERSIDE STREET LIGHT SPECIFICATIONS.
 - (G) INSPECTION SHALL BE CALLED FOR AS OUTLINED IN SPECS.
 - (H) FEED POINT TO BE CONFIRMED AT TIME OF CONSTRUCTION.
 - (I) \$75.00 CONNECTION FEE PER STD. 10-7-65.
- ⊗ INDICATES CITY OF RIVERSIDE MARGARETTE LIGHT STANDARD NO. 11026 WITH 12000L 250W TYPE III LINE MANTREL MERCURY VAPOR LUMINAIRE WITH INDIVIDUAL PHOTO ELECTRIC RECEPTACLE AND CONTROL UNIT. CAT. NO. LM46A2.
- INDICATES 1" O.D. GALV. STEEL CONDUIT, EXCEPT AS NOTED.
- INDICATES FEED POINT.

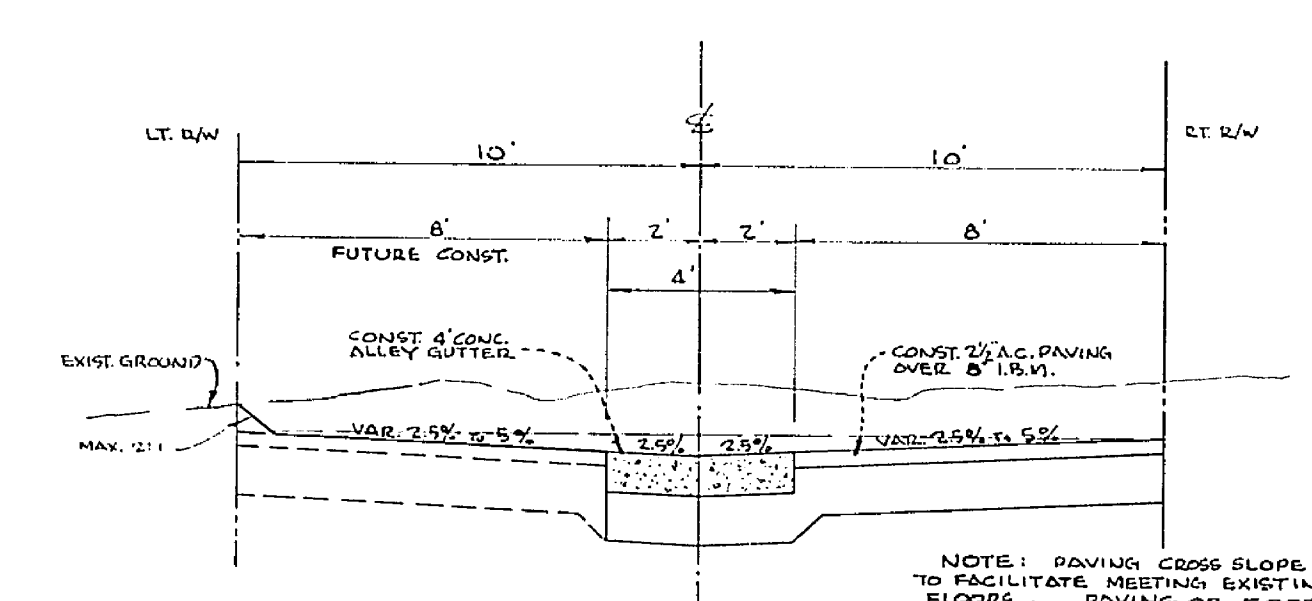

TYPICAL ALLEY SECTION
CONSTRUCT PER STD. 110
NO SCALE

NOTE: PAVING CROSS SLOPE TO VARY TO FACILITATE MEETING EXISTING GARAGE FLOORS. 1

APPROVED BY
Don Campbell
GEN. SUPE. & CHIEF ENGINEER
DATE Oct. 6, 1965

ALBERT A. WEBB ASSOCIATES CIVIL ENGINEERS RIVERSIDE CALIFORNIA APPROVED BY <i>Albert A. Webb</i> DATE 7/17/65 D.E. No. 9876 NO. 65-139 FOR: FILED S. MILLER	DESIGNED BY <i>D.R.B.</i> DRAWN BY <i>D.B.B.</i> CHECKED BY <i>C</i>	CITY OF RIVERSIDE, CALIFORNIA DEPARTMENT OF PUBLIC WORKS APPROVED BY <i>W.B.</i> DATE 11/15 OFFICE ENGINEER PARK DEPARTMENT TRAFFIC DIVISION ASSISTANT CITY ENG.	APPROVED BY <i>Ran C. J.</i> DIRECTOR OF PUBLIC WORKS DATE 11-15-65	STREET PLAN AND PROFILE ALLEY NORTHERLY FROM FIRST STREET BETWEEN MULBERRY ST. & LIME ST. ZONING CASE 12-121-645	PROJECT NO. 15-13115 2-1087 SHEET 1 OF 1 FILE NO. 65-239A
		HORIZ. SCALE: 1" = 20' VERT. SCALE: 1" = 4'			