


BENCH MARK
 Elev. 890.471, County No. 6079-68
 about 87' north, northeast along the 47.15' R. railway from station of
 Riverside, 600 feet northward of the intersection of E. La Cadena
 Drive and First St., behind property of 2336 E. La Cadena Dr.
 T.B.M. Elev. 888.6
 Chk. 15 on top of C.B. & S. 443750 N.W. side of La Cadena

- GENERAL NOTE**
1. Construction shall be in accordance with the Standard Specifications for Public Works Construction 1970 Edition for City of Riverside Standard Drawings.
 2. All flagged elevations shall be stated in the field by the Engineer.
 3. The Subdivider shall arrange for a soil test to be made by a State Engineer after the street has been prepared to rough grade, depth of base material and R.C. paving shall be determined by the City of Riverside design Standards and test procedures.
 4. Location of driveway approaches Standard No. 302, to be determined at the time of construction.
 5. The amount of gravel overlay on existing pavement has been estimated by the Engineer to be approximately 2.5" base.

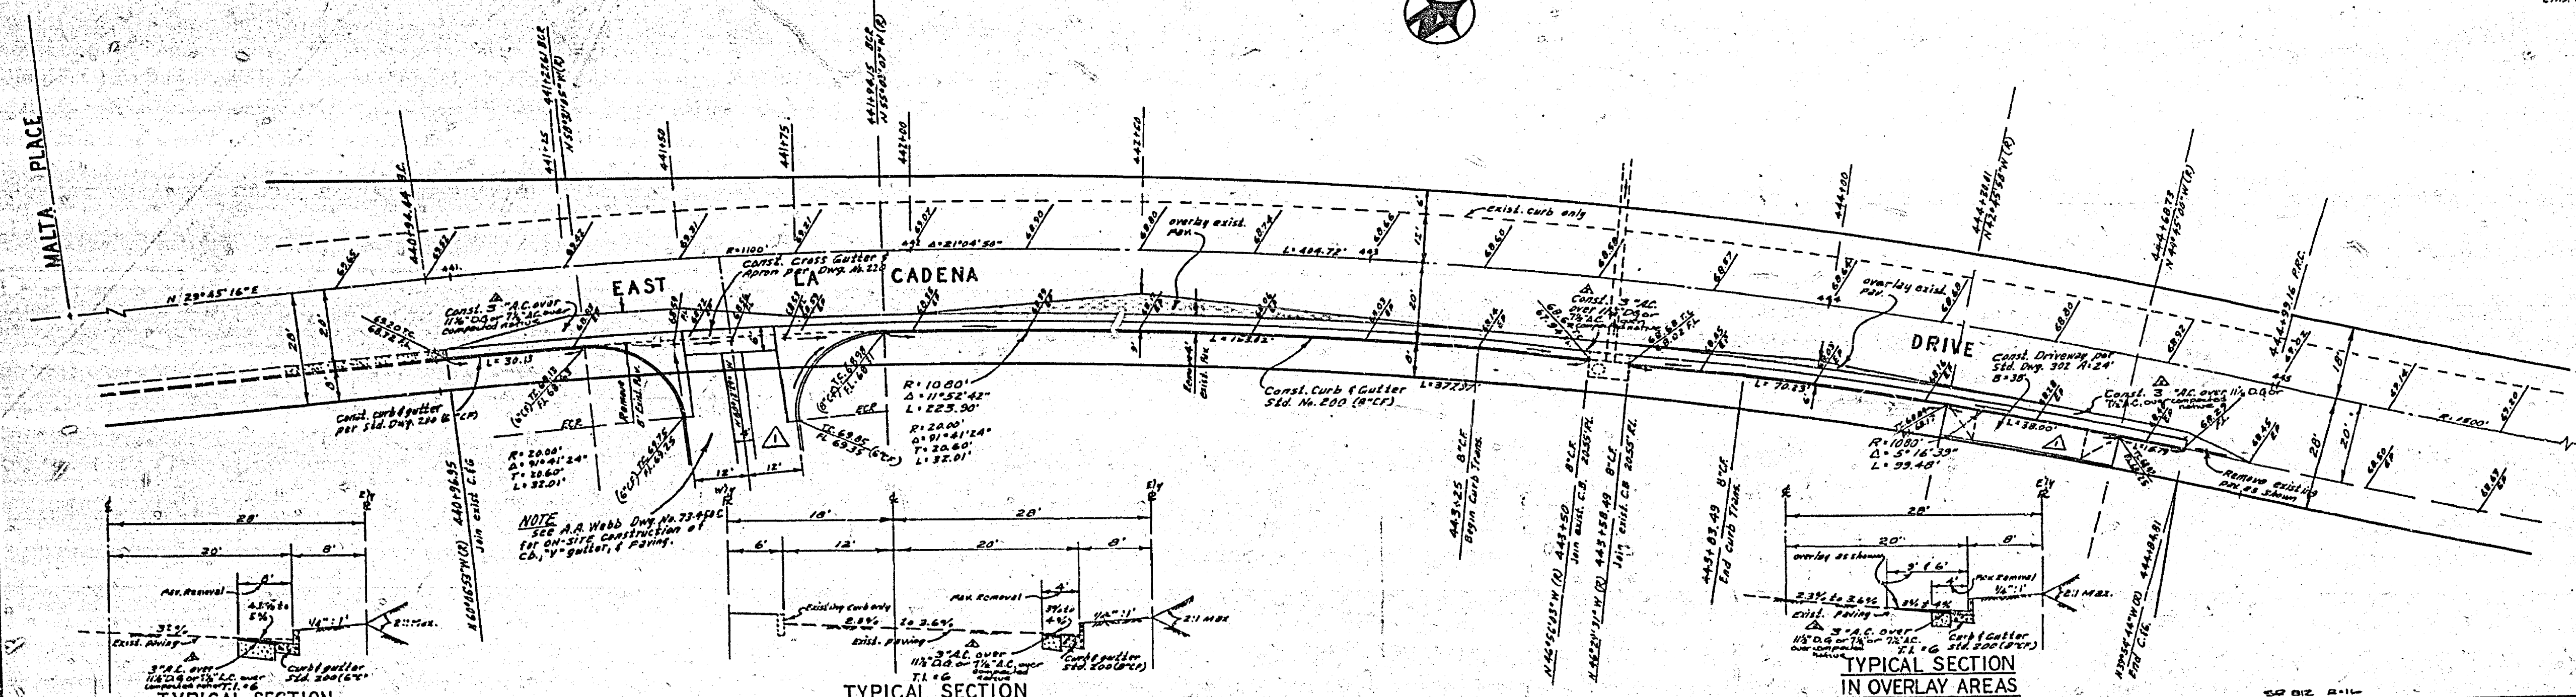

TYPICAL SECTION
 STA. 441+00 TO 441+75
 1/4" SCALE

TYPICAL SECTION
 EAST LA CADENA DRIVE
 1/4" SCALE

TYPICAL SECTION
 IN OVERLAY AREAS
 1/4" SCALE

ALBERT A. WEBB ASSOCIATES CIVIL ENGINEERS RIVERSIDE, CALIFORNIA APPROVED BY: <i>E. N. Webb</i> DATE: 12/20/73 R.E. No. 9876	CITY OF RIVERSIDE, CALIFORNIA PUBLIC WORKS DEPARTMENT APPROVED BY: <i>[Signature]</i> DATE: 2-10-73 PRINCIPAL ENGINEER TRAFFIC DIVISION CHIEF PUBLIC WORKS ENGINEER	STREET PLAN AND PROFILE EAST LA CADENA DR. EASTERLY SIDE BETWEEN MALTA PLACE AND KANSAS AVENUE BLDG. PERMIT	ACCOUNT NO.
			DRAWING NUMBER
W.O. 72-450 FOR 2.5% Properties F.B. 1029	DESIGNED BY: B.L. DRAWN BY: B.L. CHECKED BY: B.L.	SCALE: 1" = 20' HORIZ. 1" = 4' VERT.	72-450-A