


**BENCH MARK**  
 B.M. 25-D F.D. P.K. MAIL IN ELY HEADWALL OF GAGE CANAL & GRATTON ST. ELEVATION = 1005.913  
 T.B.M. SET CHIS. "O" 5' NLY. OF SLY. END CURB ON W. SIDE GRATTON ST. STA. 20+175. ELEVATION = 974.95

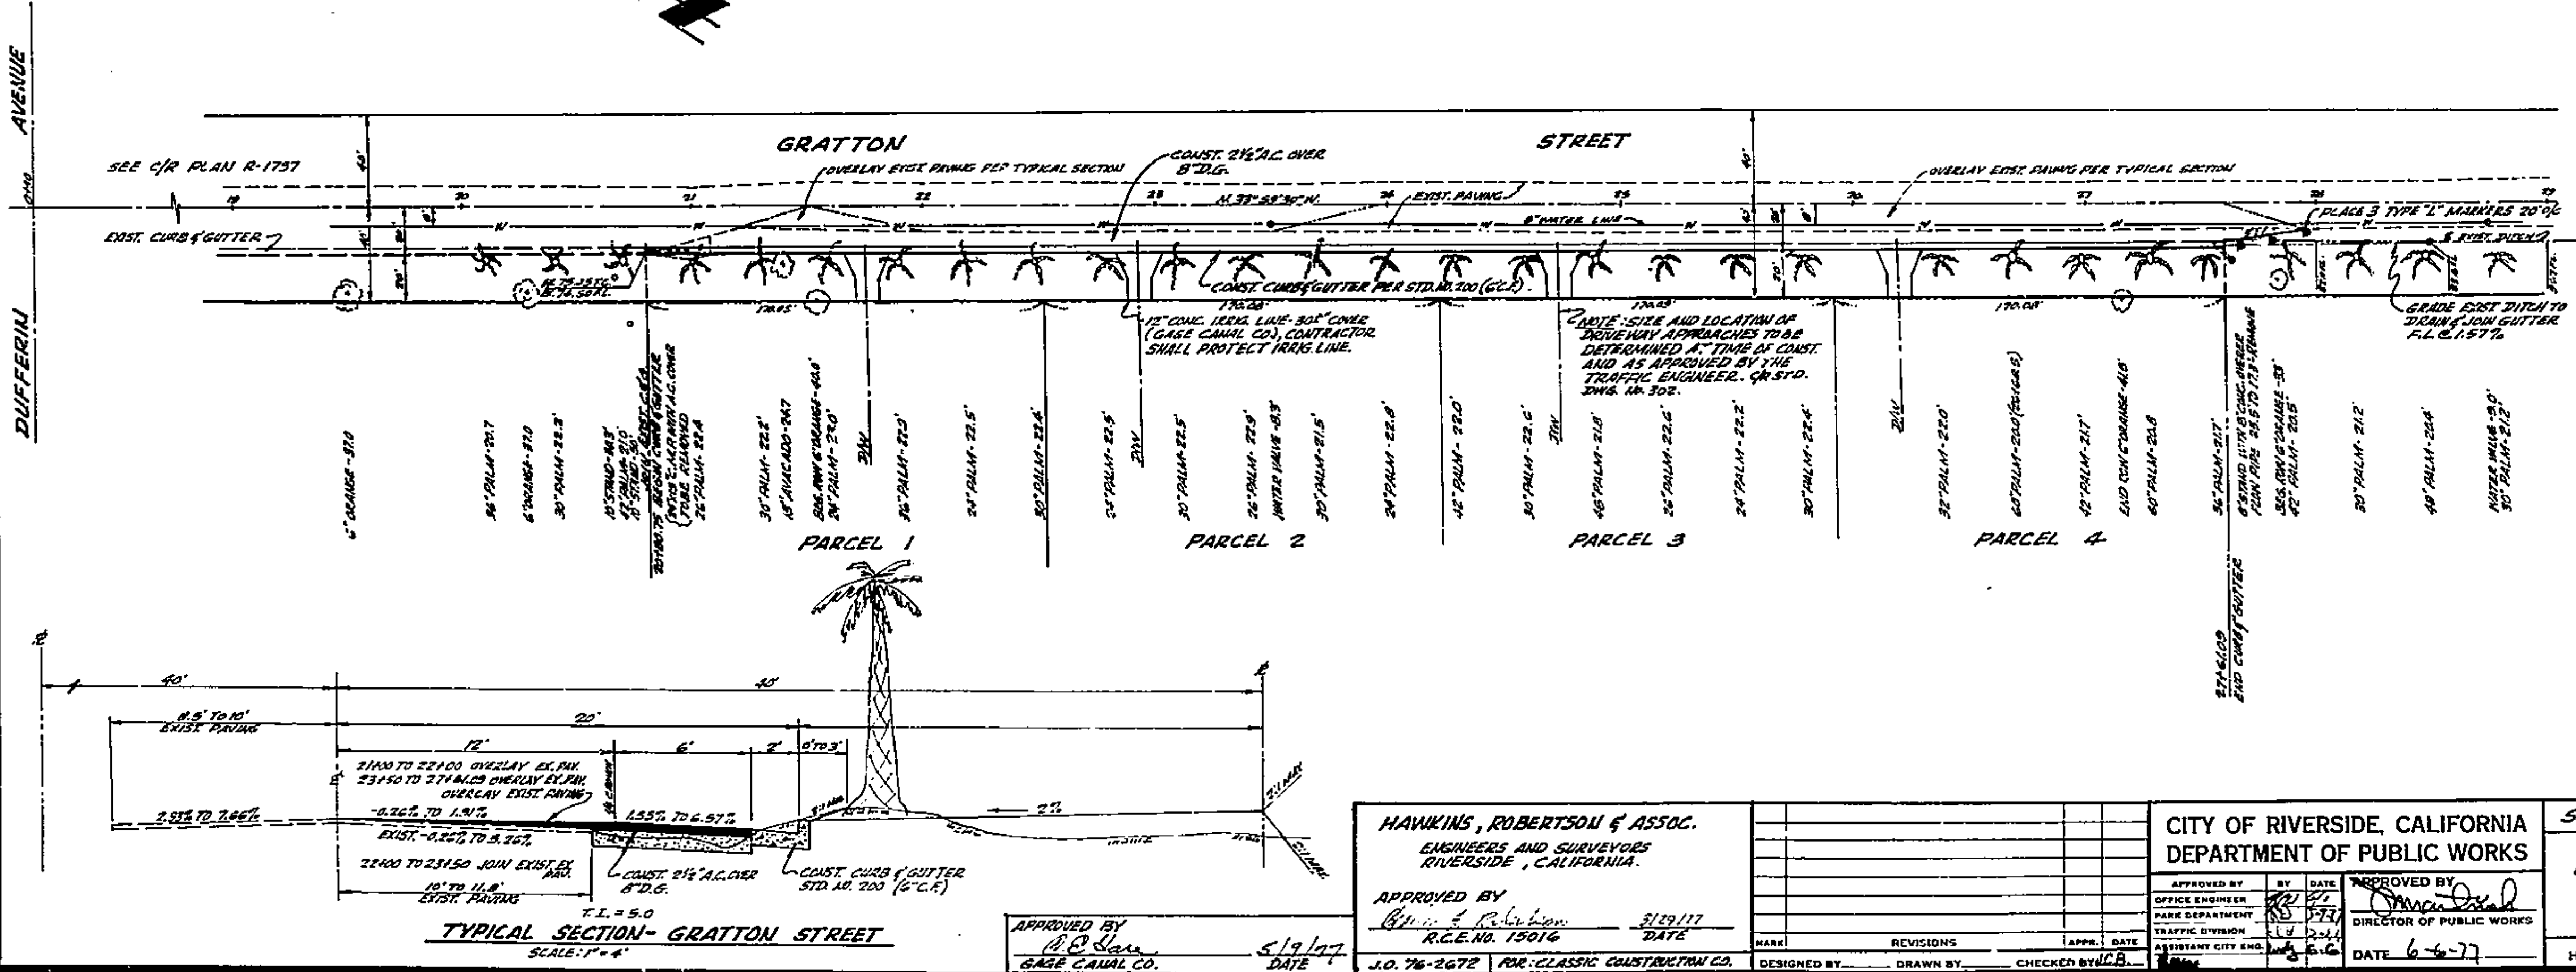

- GENERAL NOTES:**
- CONSTRUCTION SHALL BE IN ACCORDANCE WITH THE STANDARD SPECIFICATIONS FOR PUBLIC WORKS CONSTRUCTION 1976 EDITION AND PER CITY OF RIVERSIDE STANDARD DRAWINGS.
  - ALL FLAGGED ELEVATIONS SHALL BE STAKED IN THE FIELD BY THE PRIVATE ENGINEER.
  - CURBS & GUTTER TO BE STAKED ON A 3' OFFSET & AT 25' INTERVALS.
  - IT SHALL BE THE RESPONSIBILITY OF THE CONTRACTOR TO CLEAR THE RIGHT OF WAY IN ACCORDANCE WITH THE PROVISIONS OF PLAN AS IT AFFECTS EACH UTILITY INCLUDING IRRIGATION LINES AND APPURTENANCES AND AT NO COST TO THIS CITY.
  - TRIM EDGE OF EXISTING PAVING WHERE NEW PAVEMENT JOINS TO A SMOOTH STRAIGHT LINE. CONTRACTOR MATCH-UP PAVING AS SHOWN ON PLAN. OVERLAY PAVING AS DIRECTED IN THE FIELD TO PRODUCE A SMOOTH SECTION. ENGINEER ESTIMATES OVERLAY TO BE 26 TONS.
  - CONSTRUCT DRIVEWAY APPROACHES PER STD. DWS. NO. 302. EXACT SIZE AND LOCATION TO BE DETERMINED AT TIME OF CONSTRUCTION AS APPROVED BY THE TRAFFIC ENGINEER.
  - CONTRACTOR TO PROTECT OR RELOCATE EXISTING 12" CON. IRRIGATION LINE AT HIS EXPENSE. IF COVER OVER 18" IS REQUIRED TO LESS THAN 30" PIPE MUST BE PROTECTED OR STRENGTHENED AT DRIVEWAY APPROACHES.
  - THE PRIVATE ENGINEER SIGNING THESE PLANS IS RESPONSIBLE FOR THE ACCURACY AND ACCEPTABILITY OF THE WORK HEREON. IN THE EVENT OF DISCREPANCIES ARISING DURING CONSTRUCTION, THE PRIVATE ENGINEER SIGNING SHALL BE RESPONSIBLE FOR DETERMINING AN ACCEPTABLE SOLUTION AND REVISING THE PLANS FOR APPROVAL BY THE CITY.
  - CONTRACTOR TO CALL GAGE CANAL CO. 48 HOURS PRIOR TO STARTING CONSTRUCTION. PHONE 784-683-8228

<b>HAWKINS, ROBERTSON &amp; ASSOC.</b> ENGINEERS AND SURVEYORS RIVERSIDE, CALIFORNIA. APPROVED BY: <i>Robertson</i> 3/19/77 R.C.E. NO. 15014 DATE		CITY OF RIVERSIDE, CALIFORNIA DEPARTMENT OF PUBLIC WORKS APPROVED BY: <i>[Signature]</i> DIRECTOR OF PUBLIC WORKS DATE: 6-2-77		STREET PLAN AND PROFILE <b>GRATTON STREET</b> PARCEL MAP 9359 PROJECT NO. <b>R-1984</b> SHEET 1 OF 1 FILE NO. 76-2672
DESIGNED BY: _____ DRAWN BY: _____ CHECKED BY: _____	REVISIONS: _____ APPR. DATE: _____	INDEXED 2-A	HORIZ. SCALE: 1" = 40' VERT. SCALE: 1" = 8'	