GENERAL CONSTRUCTION NOTES:

- EXISTING UTILITIES SHOWN ON THIS PLAN ARE PLOTTED FROM UTILITY RECORDS. THE CONTRACTOR IS REQUIRED TO TAKE DUE PRECAUTIONARY MEASURES TO LOCATE AND PROTECT ALL UTILITIES WHETHER OR NOT SHOWN ON THIS PLAN. IF THE COVER OF A UTILITY IS KNOWN, IT IS SHOWN IN THE PROFILE. UTILITIES SHOWN IN THE PROFILE EXPECTED TO CONFLICT WITH THE PROPOSED IMPROVEMENTS.
- CONFLICTING UTILITIES IN THE CONSTRUCTION AREA SHALL BE RELOCATED OR ABANDONED. PIPE ABANDONMENT SHALL CONFORM TO STATE STANDARDS AND
- CONSTRUCTION SHALL BE IN ACCORDANCE WITH THE CITY OF RIVERSIDE STANDARD
 DRAWINGS AND STANDARD SPECIFICATIONS FOR PUBLIC WORKS CONSTRUCTION, 1997
 EDITION, INCLUDING 1998 SUPPLEMENT. REFERENCE TO STATE STD. REFERS TO STATE
 OF CALIFORNIA, BUSINESS AND TRANSPORTATION AGENCY, DEPARTMENT OF TRANSPORTATION STANDARD PLANS AND SPECIFICATIONS, 1995 METRIC EDITION.
- WHERE SURVEY MONUMENTS EXIST, SUCH MONUMENTS SHALL BE PROTECTED (4) OR SHALL BE REFERENCED AND RESET PURSUANT TO BUSINESS AND
- PROFESSIONS CODE, SECTIONS 8700 TO 8805 (LAND SURVEYOR'S ACT). (5) ALL ELEVATIONS SHOWN ON THE PLANS SHALL BE STAKED IN THE FIELD.
- PRIME CONTRACTORS BIDDING THIS WORK SHALL HAVE A CLASS "A" OR "C-12" LICENSE.
- THE CONTRACTOR SHALL ADEQUATELY EXPOSE REINFORCEMENT OF EXISTING STORMDRAINS TO CONNECT PROPOSED IMPROVEMENTS. ALL SPLICING OF REINFORCEMENT SHALL BE IN CONFORMANCE WITH SECTION 52-1.08A OF
 - CALTRANS SPECIFICATIONS DATED JULY 1992. ALL SIGNING, STRIPING, AND PAVEMENT MARKINGS SHALL BE IN CONFORMANCE WITH THE CURRENT EDITION OF THE TRAFFIC MANUAL, PUBLISHED BY THE
- STATE OF CALIFORNIA, DEPARTMENT OF TRANSPORTATION, AND THE SPECIAL PROVISIONS. ALL PAVEMENT MARKINGS SHALL BE THERMOPLASTIC UNLESS THERWISE NOTED ON THE PLANS. CONTRACTOR SHALL COORDINATE ALL LOCAL STREET CONSTRUCTION SIGNING WITH CONSTRUCTION SIGNING REQUIRED FOR RAMPS.

CONSTRUCTION NOTES SHEETS 2-4

- PROTECT EXISTING DECORATIVE SIDEWALK.
- ADJUST TO GRADE BY CONTRACTOR
- ADJUST TO GRADE BY OTHERS.
- RELOCATE/RECONSTRUCT BY OTHERS.
- CONSTRUCT STANDARD 122 REVERSE TAPER, L=120', W=10'.
- CONSTRUCT STANDARD 122 REVERSE TAPER, L=120', W=13'.
- CONSTRUCT STANDARD 123 PARABOLIC FLARE, L=45' W=3'
- CONSTRUCT STANDARD 200 CURB AND GUTTER, TYPE I, 6" CURB FACE
- CONSTRUCT STANDARD 200 CURB, TYPE II, 8" CURB FACE.
- CONSTRUCT STANDARD 325 SIDEWALK, SEE HARDSCAPE PLANS
- FOR DECORATIVE SCORING AND BANDING.
- EXISTING 3' CHAIN LINK FENCE, PROTECT IN PLACE.
- PROPOSED 3' CHAIN LINK FENCE 1.5' BEHIND SIDEWALK, SEE SPECIAL PROVISIONS EXISTING 6' CLF TO BE REMOVED BY OTHERS.
- CONSTRUCT DRIVEWAY APPROACH, TYPE V, A=30', B=52', SEE HARDSCAPE PLANS.
- CONSTRUCT DRIVEWAY APPROACH, TYPE V, A=40', B=62', SEE HARDSCAPE PLANS.
- EXISTING SIGN, REINSTALL, SEE STRIPING PLAN.
- EXISTING SIGN, RETURN TO CITY, SEE STRIPING PLAN AND SPECIFICATIONS. CONSTRUCT TREE WELL, SEE HARDSCAPE AND LANDSCAPE PLANS.
- CONSTRUCT MEDIAN EDGING, SEE HARDSCAPE PLANS.
- FXISTING PALM TREE TO BE RELOCATED, SEE PLANTING PLANS.
- PROPOSED PEDESTRIAN LIGHTING, SEE LIGHTING PLAN.
- EXISTING 96" RCP OUTLET STRUCTURE AND PIPE TO BE REMOVED. AS PART OF CLEARING AND GRUBBING. SEE PLAN D-669.
- STREET LIGHTING FACILITY, SEE LIGHTING PLAN.
- SIGNAL FACILITY, SEE SIGNAL PLAN X-326.
- SIGNAL FACILITY, SEE SIGNAL PLAN X-467.
- CONSTRUCT STANDARD 405 CATCH BASIN, W=4', V=5'.
- CONSTRUCT STD 423 JUNCTION STRUCTURE, B=80°, D=24"
- INSTALL 24" RCP, 2000D.
- REMOVE EXISTING 18" CMP DRAIN.
- REMOVE EXISTING DRAINS. CONSTRUCT STD 411 UNDERSIDEWALK DRAIN.
- CONSTRUCT TEMPORARY AC WALKWAY BEHIND CURB, W=5', T=3". WIDEN AS NECESSARY TO PROVIDE 4' MIN. CLEARANCE AT LIGHTING STANDARDS.
- CONSTRUCT PCC BUS BAY. PAVEMENT SECTION = 8" PCC WITH #3 REBAR AT 24" O.C. OVER 12" CRUSHED AGGREGATE BASE.
- COSMETIC CONCRETE REPAIR TO VAULT AS PART OF SIDEWALK CONSTRUCTION.
- ADJUST ELECTRIC VAULT FRAME AND COVER TO GRADE.
- REMOVE INTERFERING PLANTINGS AND ADJUST SPRINKLER SYSTEM AS REQUIRED.
- CONSTRUCT 96" STORM DRAIN FACILITY. SEE PLAN D-669.
- INSTALL 8" WATER SERVICE LATERAL. SEE WATER PLAN.
- INSTALL 8" WATER LINE. CONNECTIONS BY CITY FORCES. SEE WATER PLAN.
- INSTALL 4-2" SCH. 40 PVC SLEEVES WITH PULL ROPES TERMINATING IN PULL BOXES. LENGTH = 110 L.F. 2' MIN COVER. 6" MIN CONCRETE ENCASEMENT.
- CONSTRUCT STD 250 AC BERM, TYPE I
- PLANTING AREA. SEE LANDSCAPE PLANS.
- STAMPED CONCRETE CROSS WALK WITH BANDING, SEE HARDSCAPE PLANS.


RIVERSIDE CITY OF RIVERSIDE CALIFORN



PUBLIC WORKS DEPARTMENT

IOWA AVENUE STREETSCAPE UNIVERSITY AVENUE TO LINDEN STREET

EDA Project No. 07-01-03654

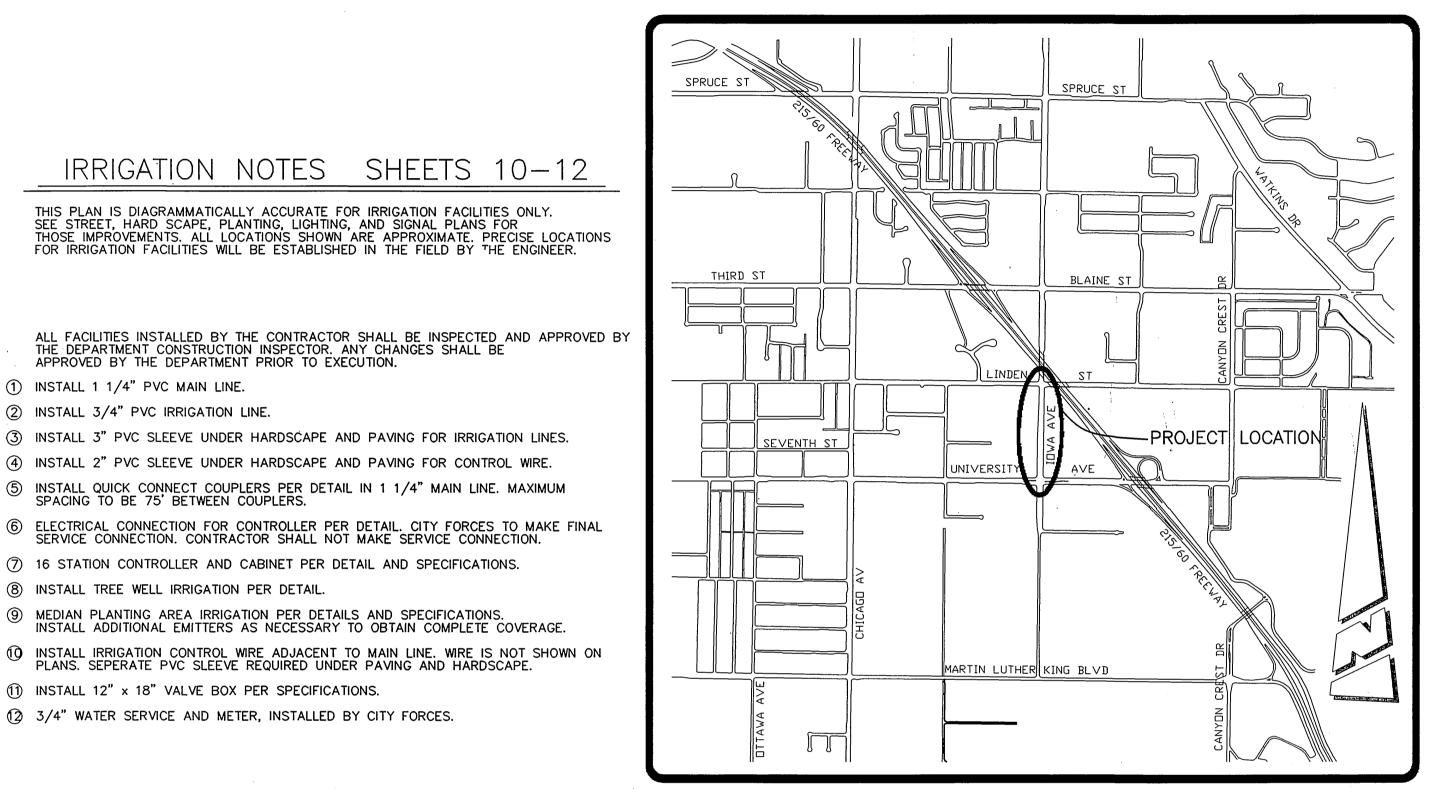

VICINITY MAP

ALL STREET LIGHTING FACILITIES INSTALLED BY THE CONTRACTOR SHALL BE INSPECTED AND APPROVED BY THE PUBLIC UTILITIES DEPARTMENT CONSTRUCTION INSPECTOR (PH. 782-5429). ALL OTHER LIGHTING

INSPECTOR(S) AND THE PUBLIC UTILITIES DEPARTMENT CONSTRUCTION SUPERINTENDENT (PH. 351-6173).

FACILITIES SHALL BE INSPECTED AND APPROVED BY THE PUBLIC WORKS DEPARTMENT. ANY CHANGES

SHALL BE APPROVED BY THE ENGINEER PRIOR TO EXECUTION. THE CONTRACTOR SHALL BE

RESPONSIBLE FOR COORDINATING ALL PHASES OF CONSTRUCTION WITH THE CONSTRUCTION

PROVIDE AND INSTALL ALL LIGHTING FACILITIES SHOWN, INCLUDING WIRING AS SHOWN IN CONFORMANCE WITH THE FOLLOWING STANDARD DRAWINGS:

EXCAVATION FOR LIGHTING CONDUIT AND FOUNDATIONS MUST BE DONE AFTER

INSTALLATION OF CURBS AND GUTTERS, BUT BEFORE INSTALLATION OF CURB RETURNS WITH SPANDRELS, CROSS GUTTERS, SIDEWALKS, AND DRIVE APRONS, UNLESS

SURVEY CHECKS LINE AND GRADE OF ANCHOR BOLTS PRIOR TO POUR OF FOUNDATION.

INSTALL A WATER PROOF "IN-LINE" FUSE HOLDER ON THE PHASE LEG CONDUCTOR(S) IN

MARK INSTALLATION DATE ON PHOTO CONTROLS AND LAMPS AS PROVIDED FOR BY MFGR.

SEE STREET, HARDSCAPE, LANDSCAPE (PLANTING AND IRRIGATION), AND SIGNAL PLANS FOR

ACQUIRE A STREET OPENING PERMIT PRIOR TO EXCAVATING IN STREET RIGHT-OF-WAY.

ALL LOCATIONS ARE APPROXIMATE. PRECISE LOCATIONS SHALL BE ESTABLISHED IN THE

ALL STREET LIGHT FEED POINTS TO BE CONNECTED BY THE PUBLIC UTILITIES DEPARTMENT AND ENERGIZED WHEN CLEARED BY THE DEPARTMENT INSPECTOR. STREET LIGHT SERVICE

IF THESE PLANS AND/OR SPECIAL PROVISIONS SPECIFY MANUFACTURERS NAMES ALONG WITH THE TERM "CITY APPROVED EQUAL", THE FOLLOWING SHALL APPLY:

F THE CONTRACTOR PROPOSES TO FURNISH EQUIPMENT AND/OR MATERIAL OTHER THAN

CONSTRUCTION AND WILL NOT BE ACCEPTED FOR INSTALLATION UNLESS APPROVED BY THE ENGINEER. JUDGMENT SHALL BE BASED ON INTENDED USE, MAINTENANCE, QUALITY AND

THAT SPECIFIED, A SAMPLE OF THE ITEM(S) MUST BE SUBMITTED TO THE ENGINEER TO DETERMINE ITS EQUALITY. THE ITEM(S) MUST BE REVIEWED PRIOR TO THE BEGINNING OF

POINTS ARE 2 WIRE 240V. SYSTEM, UNLESS OTHERWISE NOTED. FEED POINTS ARE TO BE

PEDESTRIAN LIGHTING FACILITIES ON THE WESTERLY SIDE OF IOWA AVENUE WILL INCLUDE CONSTRUCTION OF FOUNDATIONS, STANDARDS, LUMINAIRES, LAMPS, PHOTO CONTROL,

AND CONDUIT. WIRING WILL BE INSTALLED BY OTHERS AT TIME OF CONSTRUCTION

THIS PLAN IS ACCURATE FOR STREET AND PEDESTRIAN LIGHTING FACILITIES ONLY

THE BASE OF EACH LIGHT STANDARD. FUSE HOLDER TO BE "BUSSMAN TRON" #HEX COMPATIBLE WITH SIZE AND TYPE OF WIRE, WITH A "BUSSMAN" FNM 10 AMP 250 V FUSE OR

UGS-800, UGS-801, AND STREET LIGHT SPECIFICATION #2-6.

PLAN SHEET INDEX

PLANTING NOTES SHEETS 7-8

1. ALL RELATED WORK SHALL CONFORM TO THE CITY OF RIVERSIDE PARK

WHEN CALLING FOR INSPECTIONS, CONTACT THE PARK PROJECTS

WRITTEN APPROVAL FOR EACH STAGE OF INSPECTION. A VERBAL

AND RECREATION DEPARTMENT STANDARDS AND SPECIFICATIONS FOR

PLANTING AND IRRIGATION WORK. (SPECIFICATION SECTIONS 02441 AND

INSPECTOR A MINIMUM OF 48 HOURS IN ADVANCE AT (909) 715-3469

APPROVAL WILL NOT BE ACCEPTABLE. INSPECTIONS ARE REQUIRED PER

THE SPECIFICATIONS, AND INCLUDE BUT ARE NOT NECESSARILY LIMITED

A. AFTER COMPLETION OF ROUGH GRADING OF THE PROJECT SITE

CONSTANT PRESSURE MAINLINES, BUT PRIOR TO BACKFILL OF

TRENCHES FOR SAME (NOTE: MAINLINES MUST BE PRESSURE

C. AT TIME OF INSTALLATION OF IRRIGATION VALVES, LATERALS AND

D. FOR SPOTTING OF ALL TREES PRIOR TO DIGGING PLANT PITS.

F. AFTER PLANTING AND ALL OTHER INDICATED OR SPECIFIED

G. AT SUBSTANTIAL COMPLETION OF THE PROJECT FOR CITY'S

E. WHILE DIGGING PLANT PITS AND PLANTING/RELOCATING TREES.

WORK HAS BEEN COMPLETED, FOR START OF MAINTENANCE.

ACCEPTANCE TO START THE REQUIRED MAINTENANCE PERIOD

H. AT THE END OF THE MAINTENANCE PERIOD, THE CONTRACTOR

SHALL CALL THE PARK PROJECTS INSPECTOR FOR A FINAL

ACCEPTANCE INSPECTION IN ORDER TO BE RELEASED FROM

MAINTENANCE. BONDS WILL NOT BE RELEASED UNTIL AFTER

RECEIPT OF WRITTEN NOTIFICATION FROM THE CITY THAT THE

PROJECT HAS PASSED FINAL INSPECTION AND THE PARK AND

PLANTINGS FOR A PERIOD OF ONE YEARFOR TREES AND 90 DAYS FOR TURPAND SHRUES

RECREATION DEPARTMENT IS ASSUMING MAINTENANCE

4. ALL LANDSCAPE AREAS TO BE PUBLICLY MAINTAINED SHALL BE

3 THE CONTRACTOR SHALL BE RESPONSIBLE TO ACCEPTABLY MAINTAIN ALL

*NOTE: IN THE INTEREST OF PUBLIC SAFETY AND MAINTENANCE, THE

PARK PROJECTS INSPECTOR SHALL HAVE THE AUTHORITY TO REVISE THE

TREE QUANTITIES AND LOCATIONS SHOWN ON APPROVED PLANS BASED

UPON FIELD CONDITIONS FOUND AT THE TIME OF INSTALLATION OF THE

WHEN ALL UTILITY SERVICES AND SEWER LATERALS HAVE BEEN MARKED. BUT PRIOR TO INITIATING ANY TREE RELOCATION OR

TO SCHEDULE AN INSPECTION. A FIELD NOTICE WILL BE ISSUED AS

LANDSCAPE WORK WITHIN THE PUBLIC RIGHT OF WAY.

B. AT TIME OF INSTALLATION OF IRRIGATION SLEEVES AND

TESTED IN THE PRESENCE OF THE PARKS PROJECTS

SHEET 10-12 13-15 16-17

02480).

TO THE FOLLOWING:

INSPECTOR).

RESPONSIBILITIES.

AUTOMATICALLY IRRIGATED.

TREES.

HEADS.

TITLE SHEET CONSTRUCTION PLAN **CROSS SECTIONS** PLANTING PLAN IRRIGATION PLAN HARDSCAPE PLAN LIGHTING PLAN REMOVAL AND PAVING PLAN

DESCRIPTION

PLANT DESIGN IS DIAGRAMMATIC AND SHALL NOT TAKE PLACE WHERE UNFORESEEN

SITE CONDITIONS PREVENT EXECUTION OF THE DESIGNERS INTENT. WHEN UNEXPECTED SITE CONDITIONS CAUSE UNREASONABLE DEVIATIONS IN THE INTENDED PLANTING SCHEME THE CONTRACTOR SHALL IMMEDIATELY INFORM THE ENGINEER.

SLOPE RATIO EXPRESSED AS RISE:RUN

PEDESTRIAN PUSH BUTTON

TRAFFIC SIGNAL ON MAST ARM

TRAFFIC SIGNAL PRESSURE DETECTOR

TRAFFIC SIGNAL LOOP DETECTOR

TRAFFIC SIGNAL CONTROLLER

O——— STREET LIGHT & TRAFFIC SIGNAL

STREET LIGHT (UPRIGHT)

ON MAST ARM

O STREET LIGHT ON MAST ARM

STEEL POST

WOOD POST

RAILROAD TRACKS

RAILROAD SIGNAL

RAILROAD SIGN

O=---- TRAFFIC SIGNAL

ELECTRICAL CONDUIT

TOP OF SLOPE

O---- POLE & GUY ANCHOR

POWER POLE

TELEPHONE POLE

TELEPHONE RISER

JOINT USE POLE

TRAFFIC SIGN

PARKING METER

FIRE ALARM BOX

STREET NAME SIGN

WALK-DON'T WALK

PEDESTRIAN SIGNAL

TTTTTT CALTRANS ACCESS CONTROL

ELECTROLYSIS TEST STATION

PULL BOX

GAS METER

MAIL BOX

FAUCET

WHEEL STOP

THE A.C. BERM

- MAINTENANCE PERIOD SHALL BE 90 DAYS FROM DATE OF ACCEPTANCE. TREE PLANTING SHALL BE GUARANTEED FOR ONE YEAR. MAINTENANCE SHALL INCLUDE BI-WEEKLY WEED AND RODENT ABATEMENT PROCEDURES INCLUDING 4 FOLIAR APPLICATIONS OF CHELATED IRON AND TRACE MINERALS 90 DAYS APART.
- REPLACEMENT OF DAMAGED OR DESTROYED ITEMS SHALL TAKE PLACE WITHIN 48 HOURS OF NOTIFICATION BY THE CITY'S REPRESENTATIVE, OR SAID REPLACEMENT ITEMS SHALL BE DEDUCTED FROM THE CONTRACTOR'S FINAL BILLING.
- 4. REPLACEMENT ITEMS SHALL BE EXACT DUPLICATE OF ORIGINAL WORK OR PLANTS. UNLESS OTHERWISE APPROVED BY THE ENGINEER OR CITY'S REPRESENTATIVE.
- TREES AND SHRUBS SHALL BE PLANTED AFTER CONCRETE PLACEMENT, BUT NOT BEFORE IRRIGATION COVERAGE HAS BEEN APPROVED.
- 6. PLACE TREES BETWEEN SPRAY HEADS WHEREVER POSSIBLE.
- AREAS TO BE PLANTED WITH GROUND COVER SHALL HAVE THE FOLLOWING TILLED INTO THE TOP 6" OF SOIL PER 1,000 SQ. FT.: 4 CU. YDS. NITROLIZED WOOD SHAVINGS 20 LBS. 12-12-12 COMMERCIAL FERTILIZER (BEST PRODUCTS OR EQUAL)
 - 100 LBS. AG. GYPSUM 10 LBS SOIL SULFUR 20 LBS. IRON SULFATE
- PRIOR TO PLANTING OF GROUND COVER FLATS. A GRANULAR PRE-EMERGENT. NON-SELECTIVE HERBICIDE SHALL BE APPLIED ACCORDING TO MANUFACTURER'S
- 8. TREE BACKFILL MIX SHALL CONSIST OF THE FOLLOWING PER CU. YD.:
- 2/3 YD. SCREENED SITE SOIL
- 1/3 YD. NITROLIZED WOOD SHAVINGS 1 LB. 12-12-12 COMMERCIAL FERTILIZER
- 10 LBS. AG GYPSUM
- 1 LBS. SOIL SULFUR
- 2 LBS. IRON SULFATE

EXISTING UNDERGROUND UTILITIES:

SANITARY SEWER

BLOCK WALL

_____ CHAIN LINK FENCE

BOARD FENCE

ABANDONDED UTILITY ————6"G(ABAN'D.)

SANITARY SEWER M.H.

O C.D. SANITARY SEWER CLEANOUT

STORM DRAIN M.H

IRRIGATION WEIR

WATER M.H.

ELECTRIC M.H.

WATER METER

SPRINKLER HEAD

BUS STOP SIGN

O B.O. BLOW-OFF VALVE

(SP) IRRIGATION STAND PIPE

CONCRETE

ASPHALT

BUILDING

TELEPHONE M.H.

GAS M.H.

♀ FIRE HYDRANI

⊗ VALVE

• AIR VENT

EXISTING TOPOGRAPHY.

- 9. IRRIGATION SYSTEM SHALL BE INSTALLED PRIOR TO PLANT MATERIAL. CLEAN-UP SHALL TAKE PLACE ON A DAILY BASIS UNLESS OTHERWISE APPROVED
- BY THE CITY'S REPRESENTATIVE.
- 11. CONTACT THE PARK PROJECTS INSPECTOR AT 715-3469 TWO WORKING DAYS (48 HOURS) PRIOR TO INSTALLING ANY PLANT MATERIAL.
- 12. WATERING BASINS MAY BE REMOVED AFTER THE MAINTENANCE PERIOD.
- 13. FOR STAKING INFORMATION AS APPLICABLE, REFER TO STAKING DETAIL.
- 14. FOR GUYING INFORMATION AS APPLICABLE, REFER GUYING DETAIL.
- 15. FOR SPECIFICATION INFORMATION, REFER TO CITY OF RIVERSIDE PARK AND
- RECREATION DEPARTMENT STANDARD SPECIFICATIONS, SECTION 02480 PLANTING. 16. PROVIDE FERTILIZER TABLETS AS FOLLOWS:
- 2 TABLETS 1 GALLON PLANT 5 GALLON PLANT 3 TABLETS 5 TABLETS 15 GALLON PLANT 24" BOX PLANT 2 TABLETS

17. TREE HEIGHTS LISTED IN THE PALM TREE RELOCATION TABLE ARE FOR INFORMATIONAL PURPOSES ONLY. CONTRACTOR SHALL EVALUATE TREES TO BE RELOCATED AND SHALL ASSUME RESPONSIBILITY FOR TREE HEIGHT DETERMINATION.

ADJACENT TO EACH HATCHED AREA ON THE PLAN SHOWING PLANT TYPE IS THE APPROXIMATE SQUARE FOOTAGE AREA OF THAT TYPE OF PLANT. THESE PLANS ARE INTENDED TO BE DIAGRAMMATIC IN NATURE AND ADJUSTMENTS MAY BE MADE IN THE FIELD BY THE INSPECTOR.

19. ALL AREAS WITHIN THE MEDIANS SHALL BE BACKFILLED WITH CLASS "A" TOPSOIL TO A MINIMUM THICKNESS OF 12".

20. ALL SHRUB AREAS WITHIN THE MEDIAN NOSES SHALL RECEIVE A 2" LAYER OF MULCH.

THE DEPARTMENT CONSTRUCTION INSPECTOR. ANY CHANGES SHALL BE

(3) INSTALL 3" PVC SLEEVE UNDER HARDSCAPE AND PAVING FOR IRRIGATION LINES.

(4) INSTALL 2" PVC SLEEVE UNDER HARDSCAPE AND PAVING FOR CONTROL WIRE.

(7) 16 STATION CONTROLLER AND CABINET PER DETAIL AND SPECIFICATIONS.

MEDIAN PLANTING AREA IRRIGATION PER DETAILS AND SPECIFICATIONS.

(5) INSTALL QUICK CONNECT COUPLERS PER DETAIL IN 1 1/4" MAIN LINE. MAXIMUM

INSTALL ADDITIONAL EMITTERS AS NECESSARY TO OBTAIN COMPLETE COVERAGE.

PLANS. SEPERATE PVC SLEEVE REQUIRED UNDER PAVING AND HARDSCAPE.

HARDSCAPE NOTES SHEETS 13-15

16" WIDE, 4" THICK STAMPED CONCRETE BANDING

WHEELCHAIR RAMP PER CITY OF RIVERSIDE PUBLIC

CURB AND GUTTER PER CITY OF RIVERSIDE PUBLIC

TREEWELL, 4 FEET SQUARE, STATIONING IS TO

NATURAL GREY CONCRETE SIDEWALK WITH LIGHT

NATURAL GREY CONCRETE BANDING WITH SMOOTH

DRIVEWAY APPROACH PER CITY OF RIVERSIDE PUBLIC WORKS STANDARD DRAWING NO. 302, TYPE V.

DRIVEWAY APPROACH PER CITY OF RIVERSIDE PUBLIC

WORKS STANDARD DRAWING NO. 302, TYPE V.

STAMPED CONCRETE CROSS WALK W/BANDING

(12) 1 1/2" TO 4" SALT RIVER ROCK SET IN MORTAR BED

CENTERLINE OF TREEWELL. SEE DETAIL, SHEET LH3

WORKS STANDARD DRAWING NO. 200, TYPE I, 6" CURB FACE

CURB AND GUTTER PER CITY OF RIVERSIDE PUBLIC WORKS STANDARD DRAWING NO. 200, TYPE II, 8" CURB FACE

WORKS STANDARD DRAWING NO. 304

APPROVED BY THE DEPARTMENT PRIOR TO EXECUTION.

(1) INSTALL 1 1/4" PVC MAIN LINE.

(2) INSTALL 3/4" PVC IRRIGATION LINE.

SPACING TO BE 75' BETWEEN COUPLERS.

(8) INSTALL TREE WELL IRRIGATION PER DETAIL.

(1) NOTE NOT USED

NOTE NOT USED

EXPANSION JOINT

TOOLED SCORE JOINT

WOOD FLOAT FINISH

SEE DETAIL SHEET

TO MEDIUM BROOM FINISH

TEMPORARY AC WALKWAY.

WIDTH = 5', THICKNESS = 3"

MEDIAN ISLAND LANDSCAPE AREA

SEE LANDSCAPE PLANTING PLANS

A=24', B=46'. SEE DETAIL SHEET

A=40', B=62'. SEE DETAIL SHEET

(1) INSTALL 12" x 18" VALVE BOX PER SPECIFICATIONS.

12 3/4" WATER SERVICE AND METER, INSTALLED BY CITY FORCES.

IMPORTANT NOTICE Section 4216/4217 of the Government Co. requires a Dig Alert Identification Number to be issued before a "Permit to Excavate" will be valid. For your Dig Alert I.D. Number call CALL TOLL FREE 48 HOURS BEFORE YOU DIG 'NDERGROUND SERVICE ALERT -800 - 227 - 2600

ENGINEER IN RESPONSIBLE CHARGE Ronald C. Mueller

R.C.E. No. 29510 expires 3/31/03

RONALD C. MUELLER

NTERCHANGEABILITY, IF APPLICABLE.

LIGHTING NOTES

THOSE IMPROVEMENT DETAILS.

CONFIRMED AT TIME OF CONSTRUCTION.

FIELD BY THE ENGINEER.

OF ONSITE IMPROVEMENTS



δπΨ CHECKED BY ROM

PUBLIC WORKS / DEPARTMENT BY DATE APPROVED BY APPROVED BY ENGINEERING MANAGER
PRINCIPAL ENGINEER
CHIEF PURINSBURGE
TRAFFIC DIVISION
TRAFFIC DIVISION TRAFFIC DIVISION DATE 12-9-99

CITY OF RIVERSIDE, CALIFORNIA

IOWA AVENUE FROM UNIVERSITY AVE. TO LINDEN ST.

SHEET 1 OF 18


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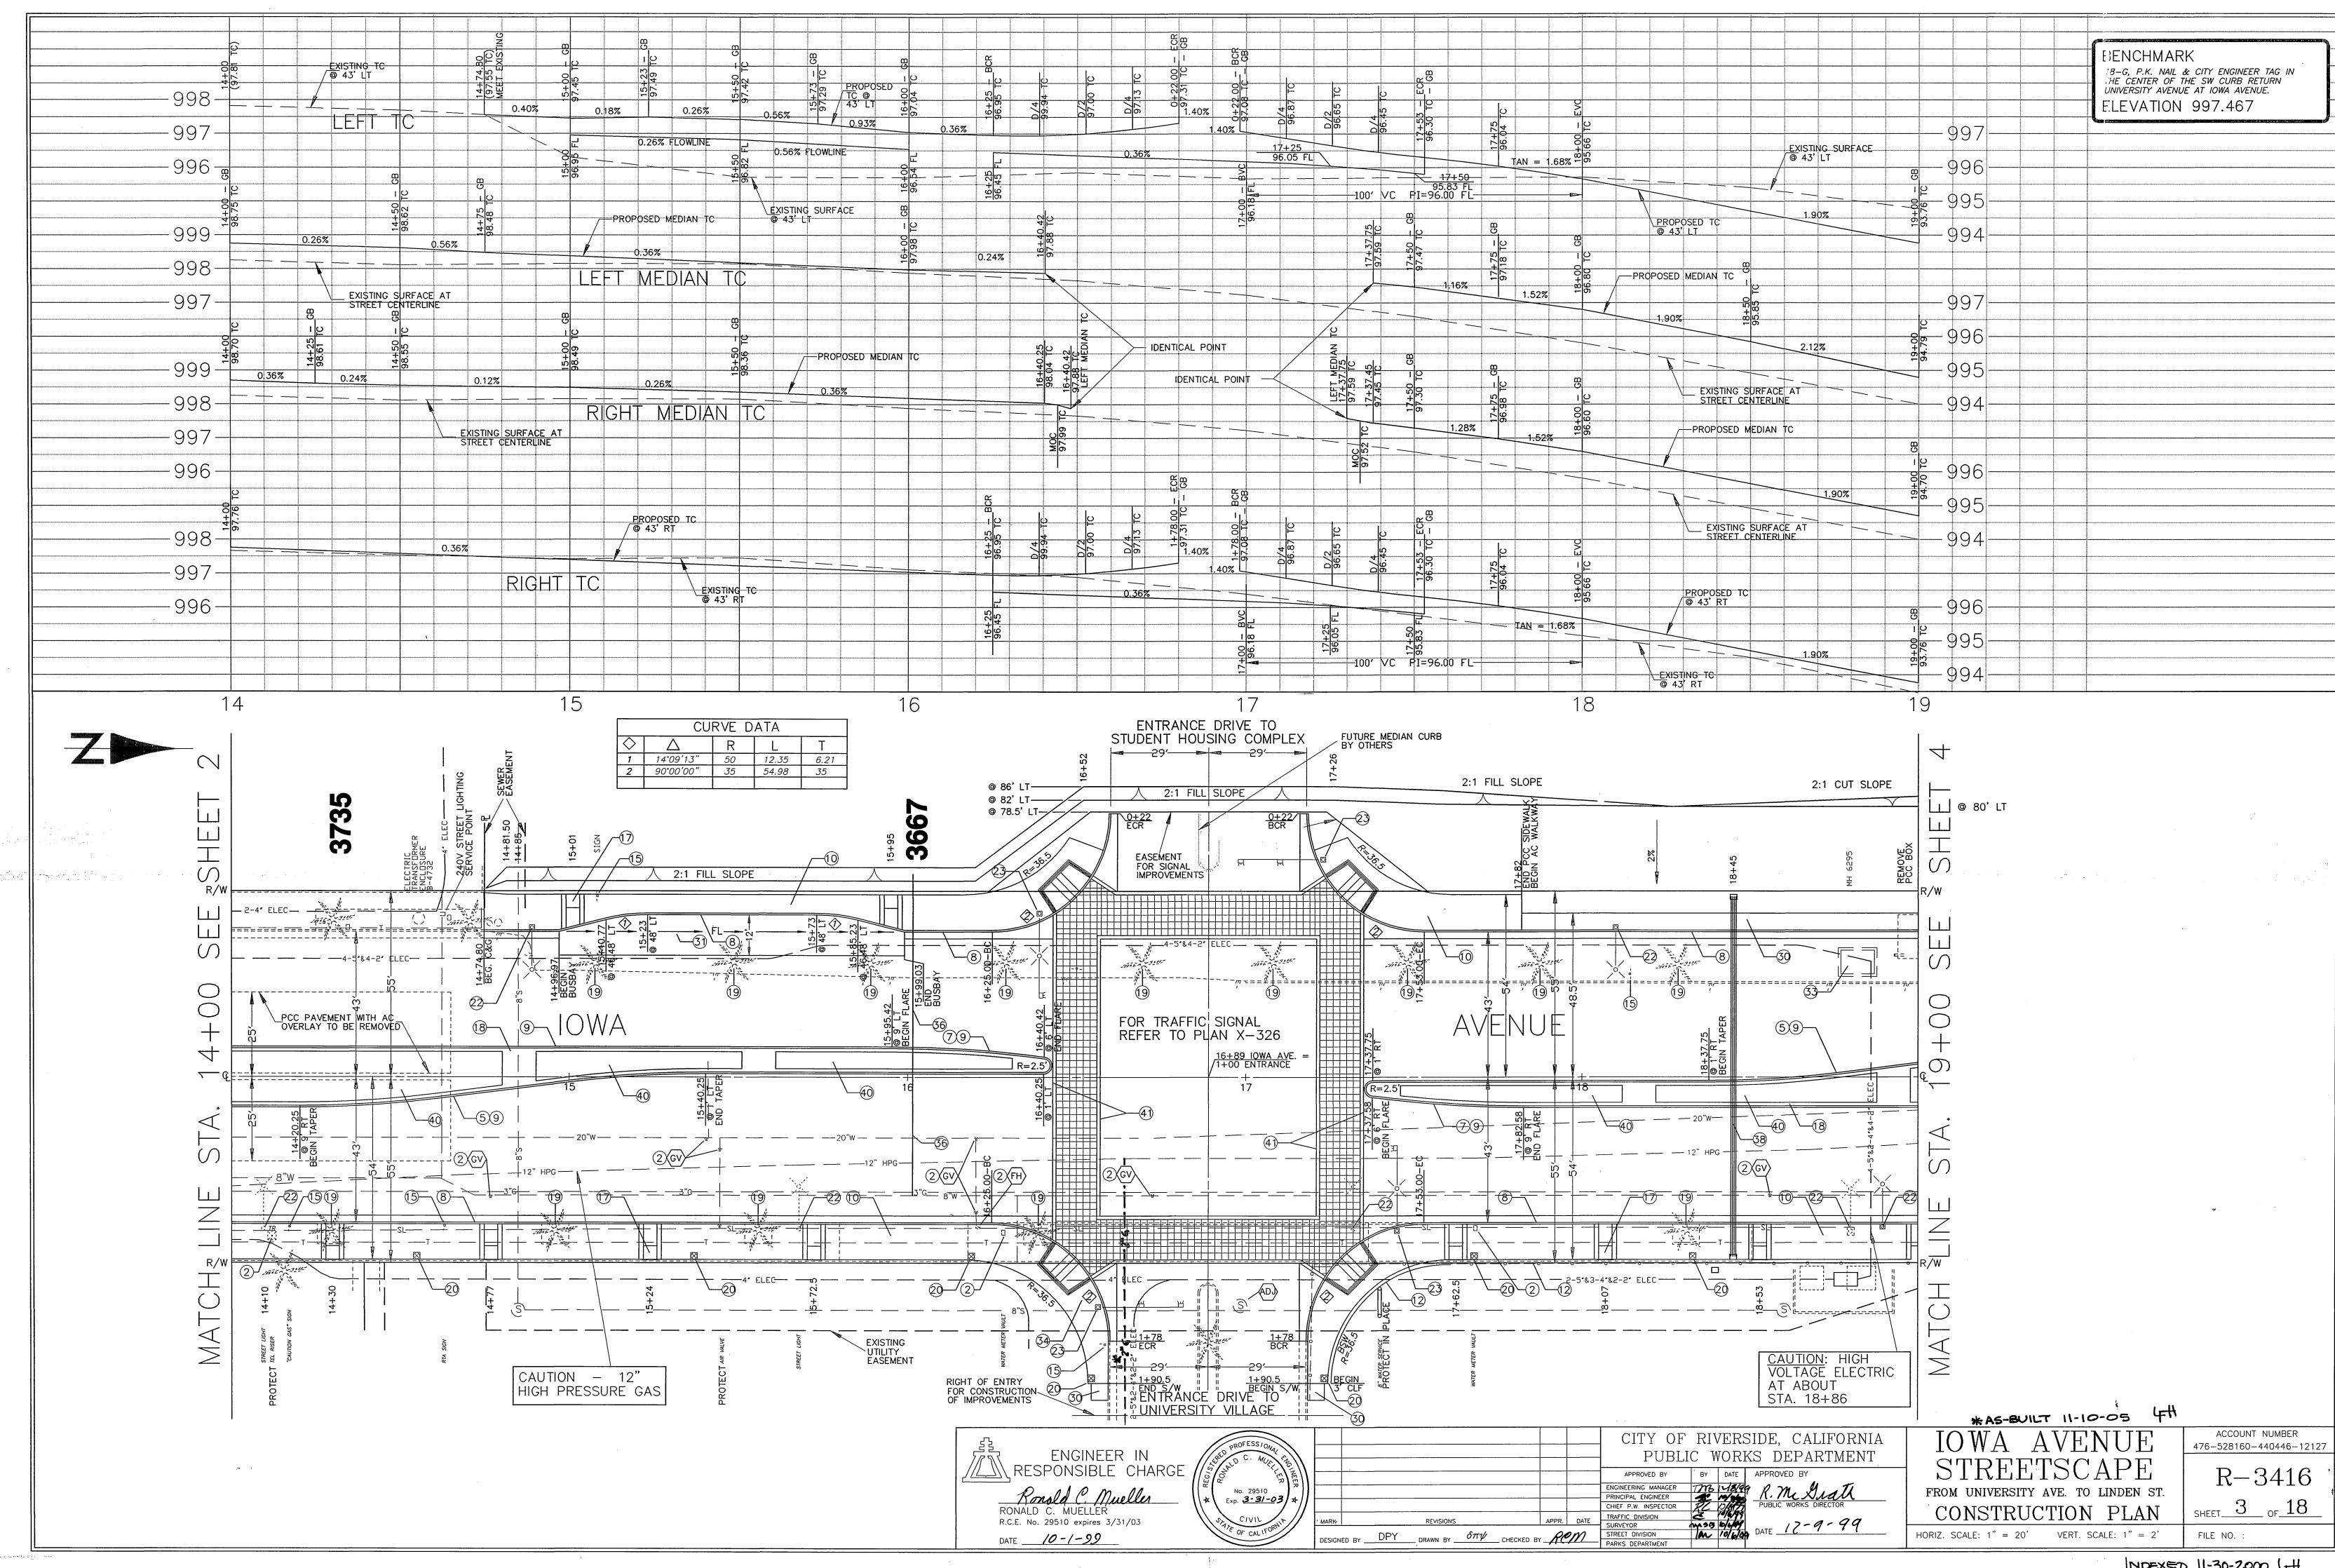
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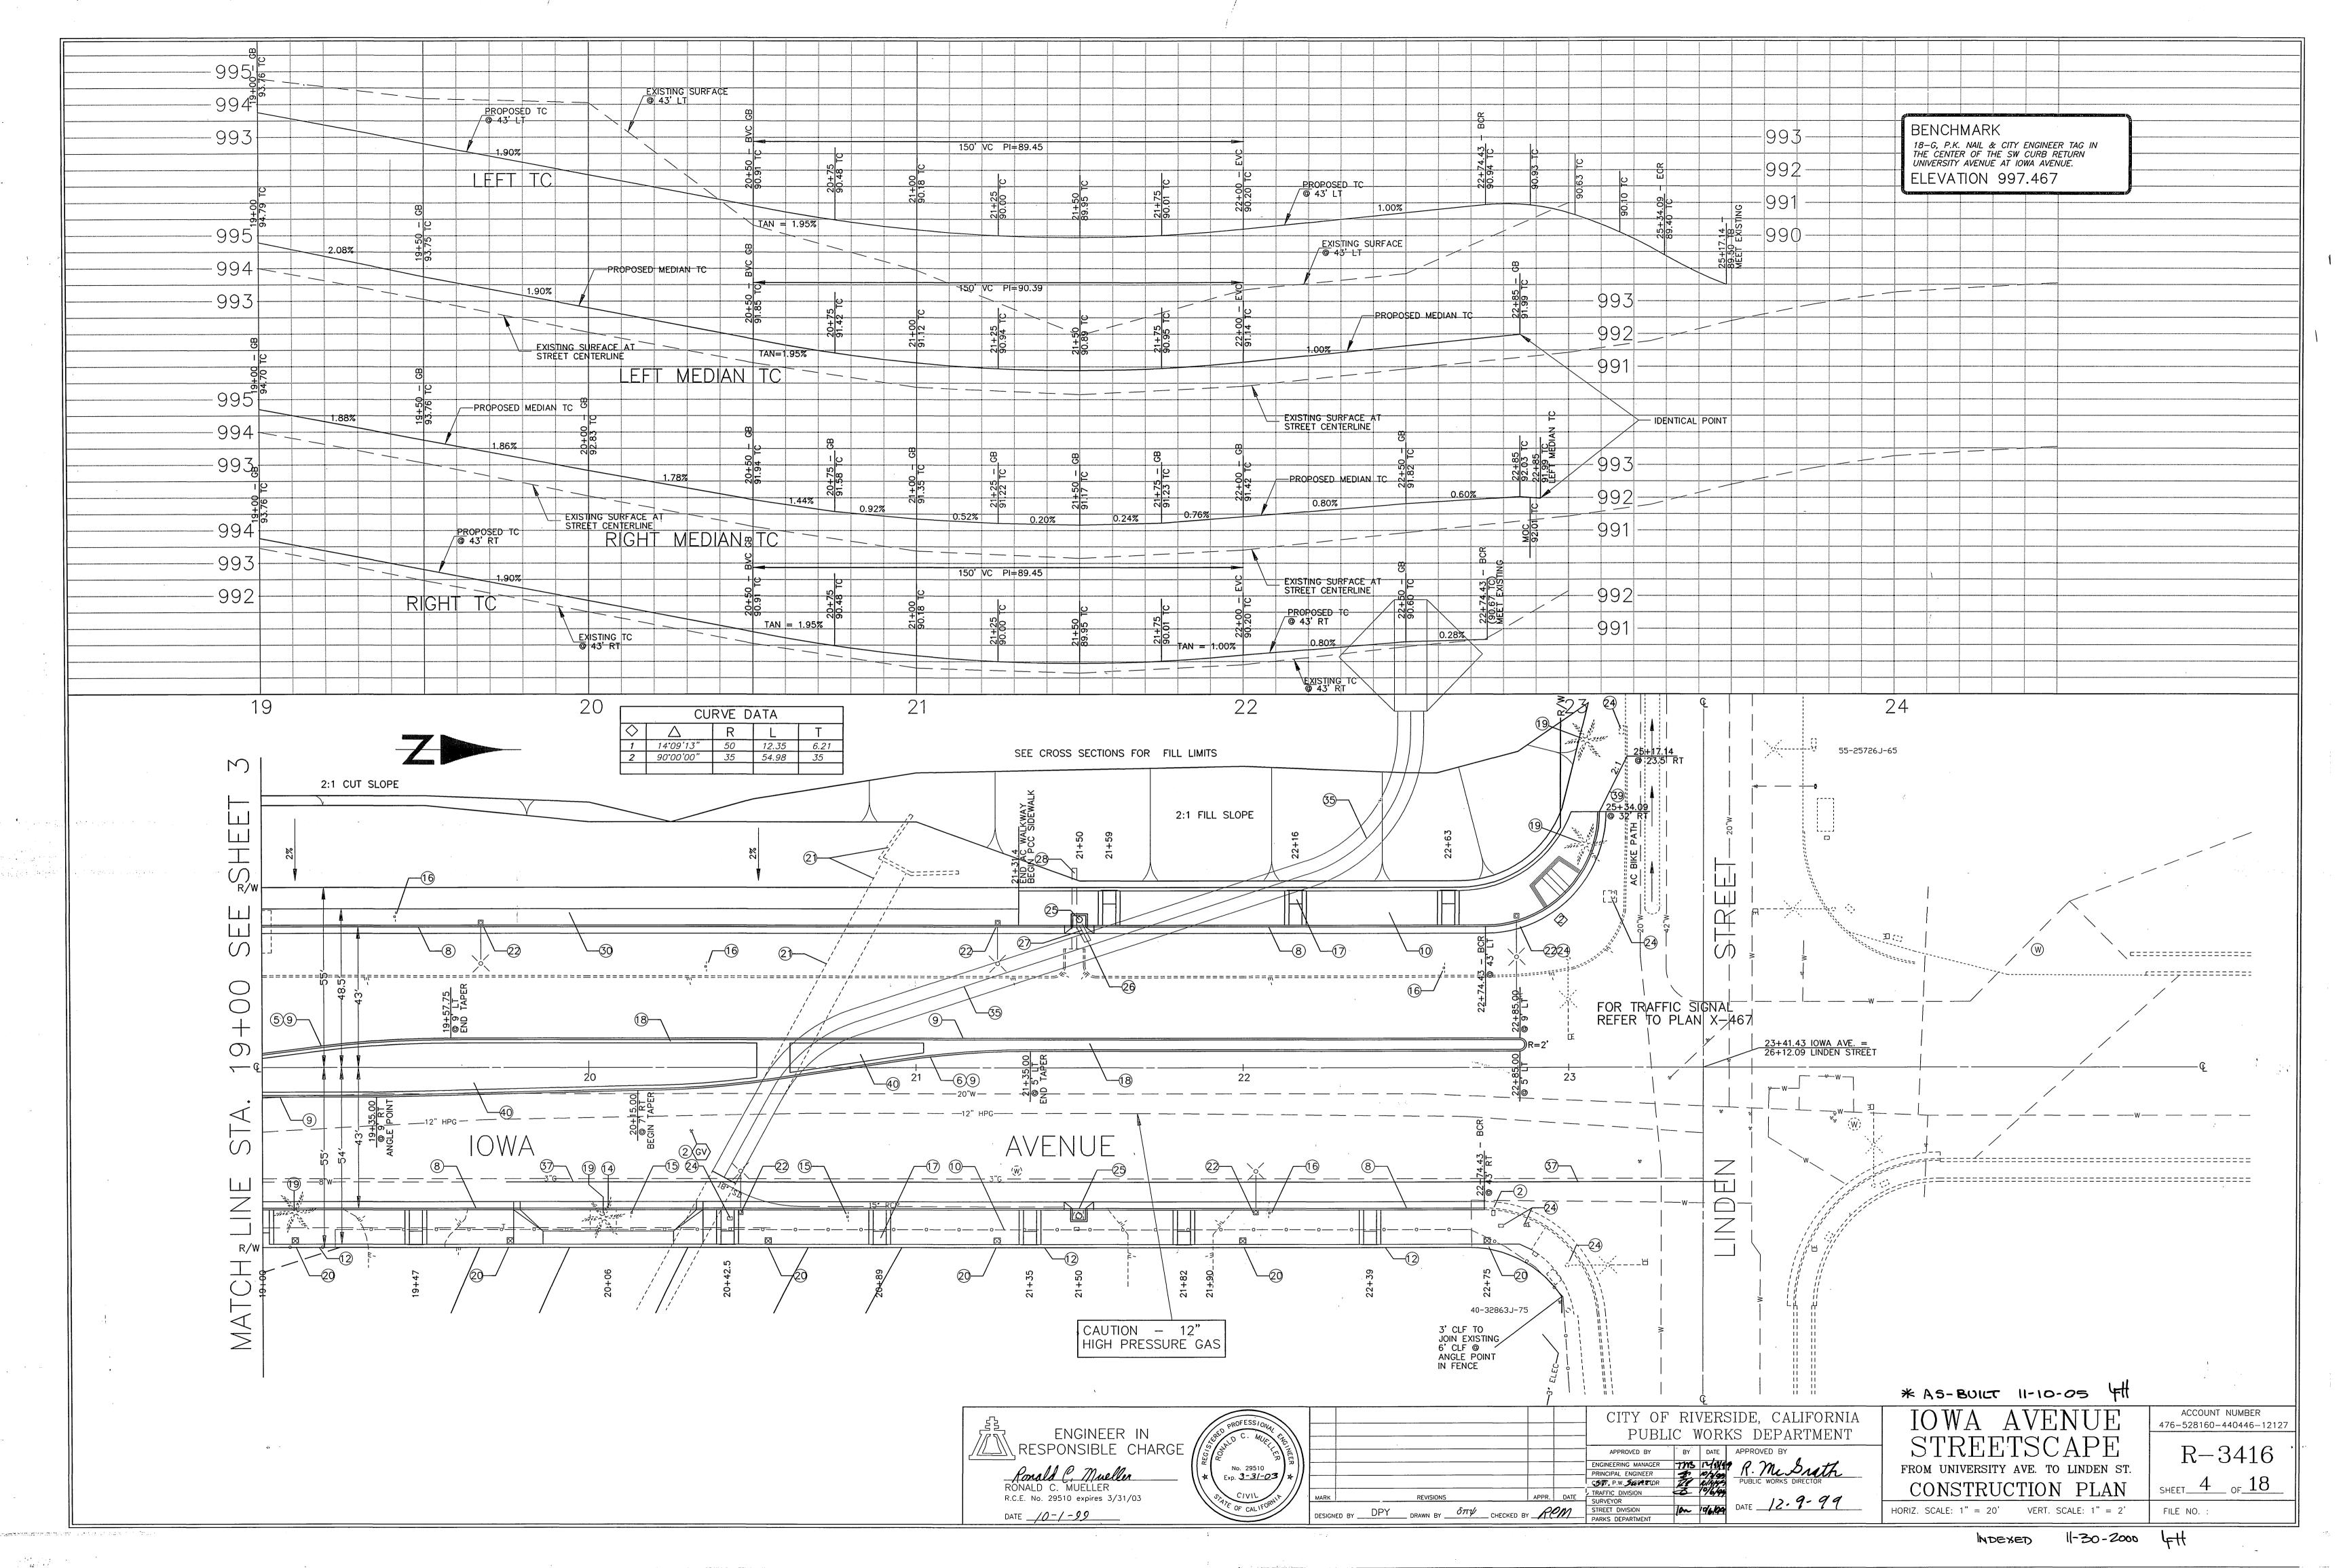
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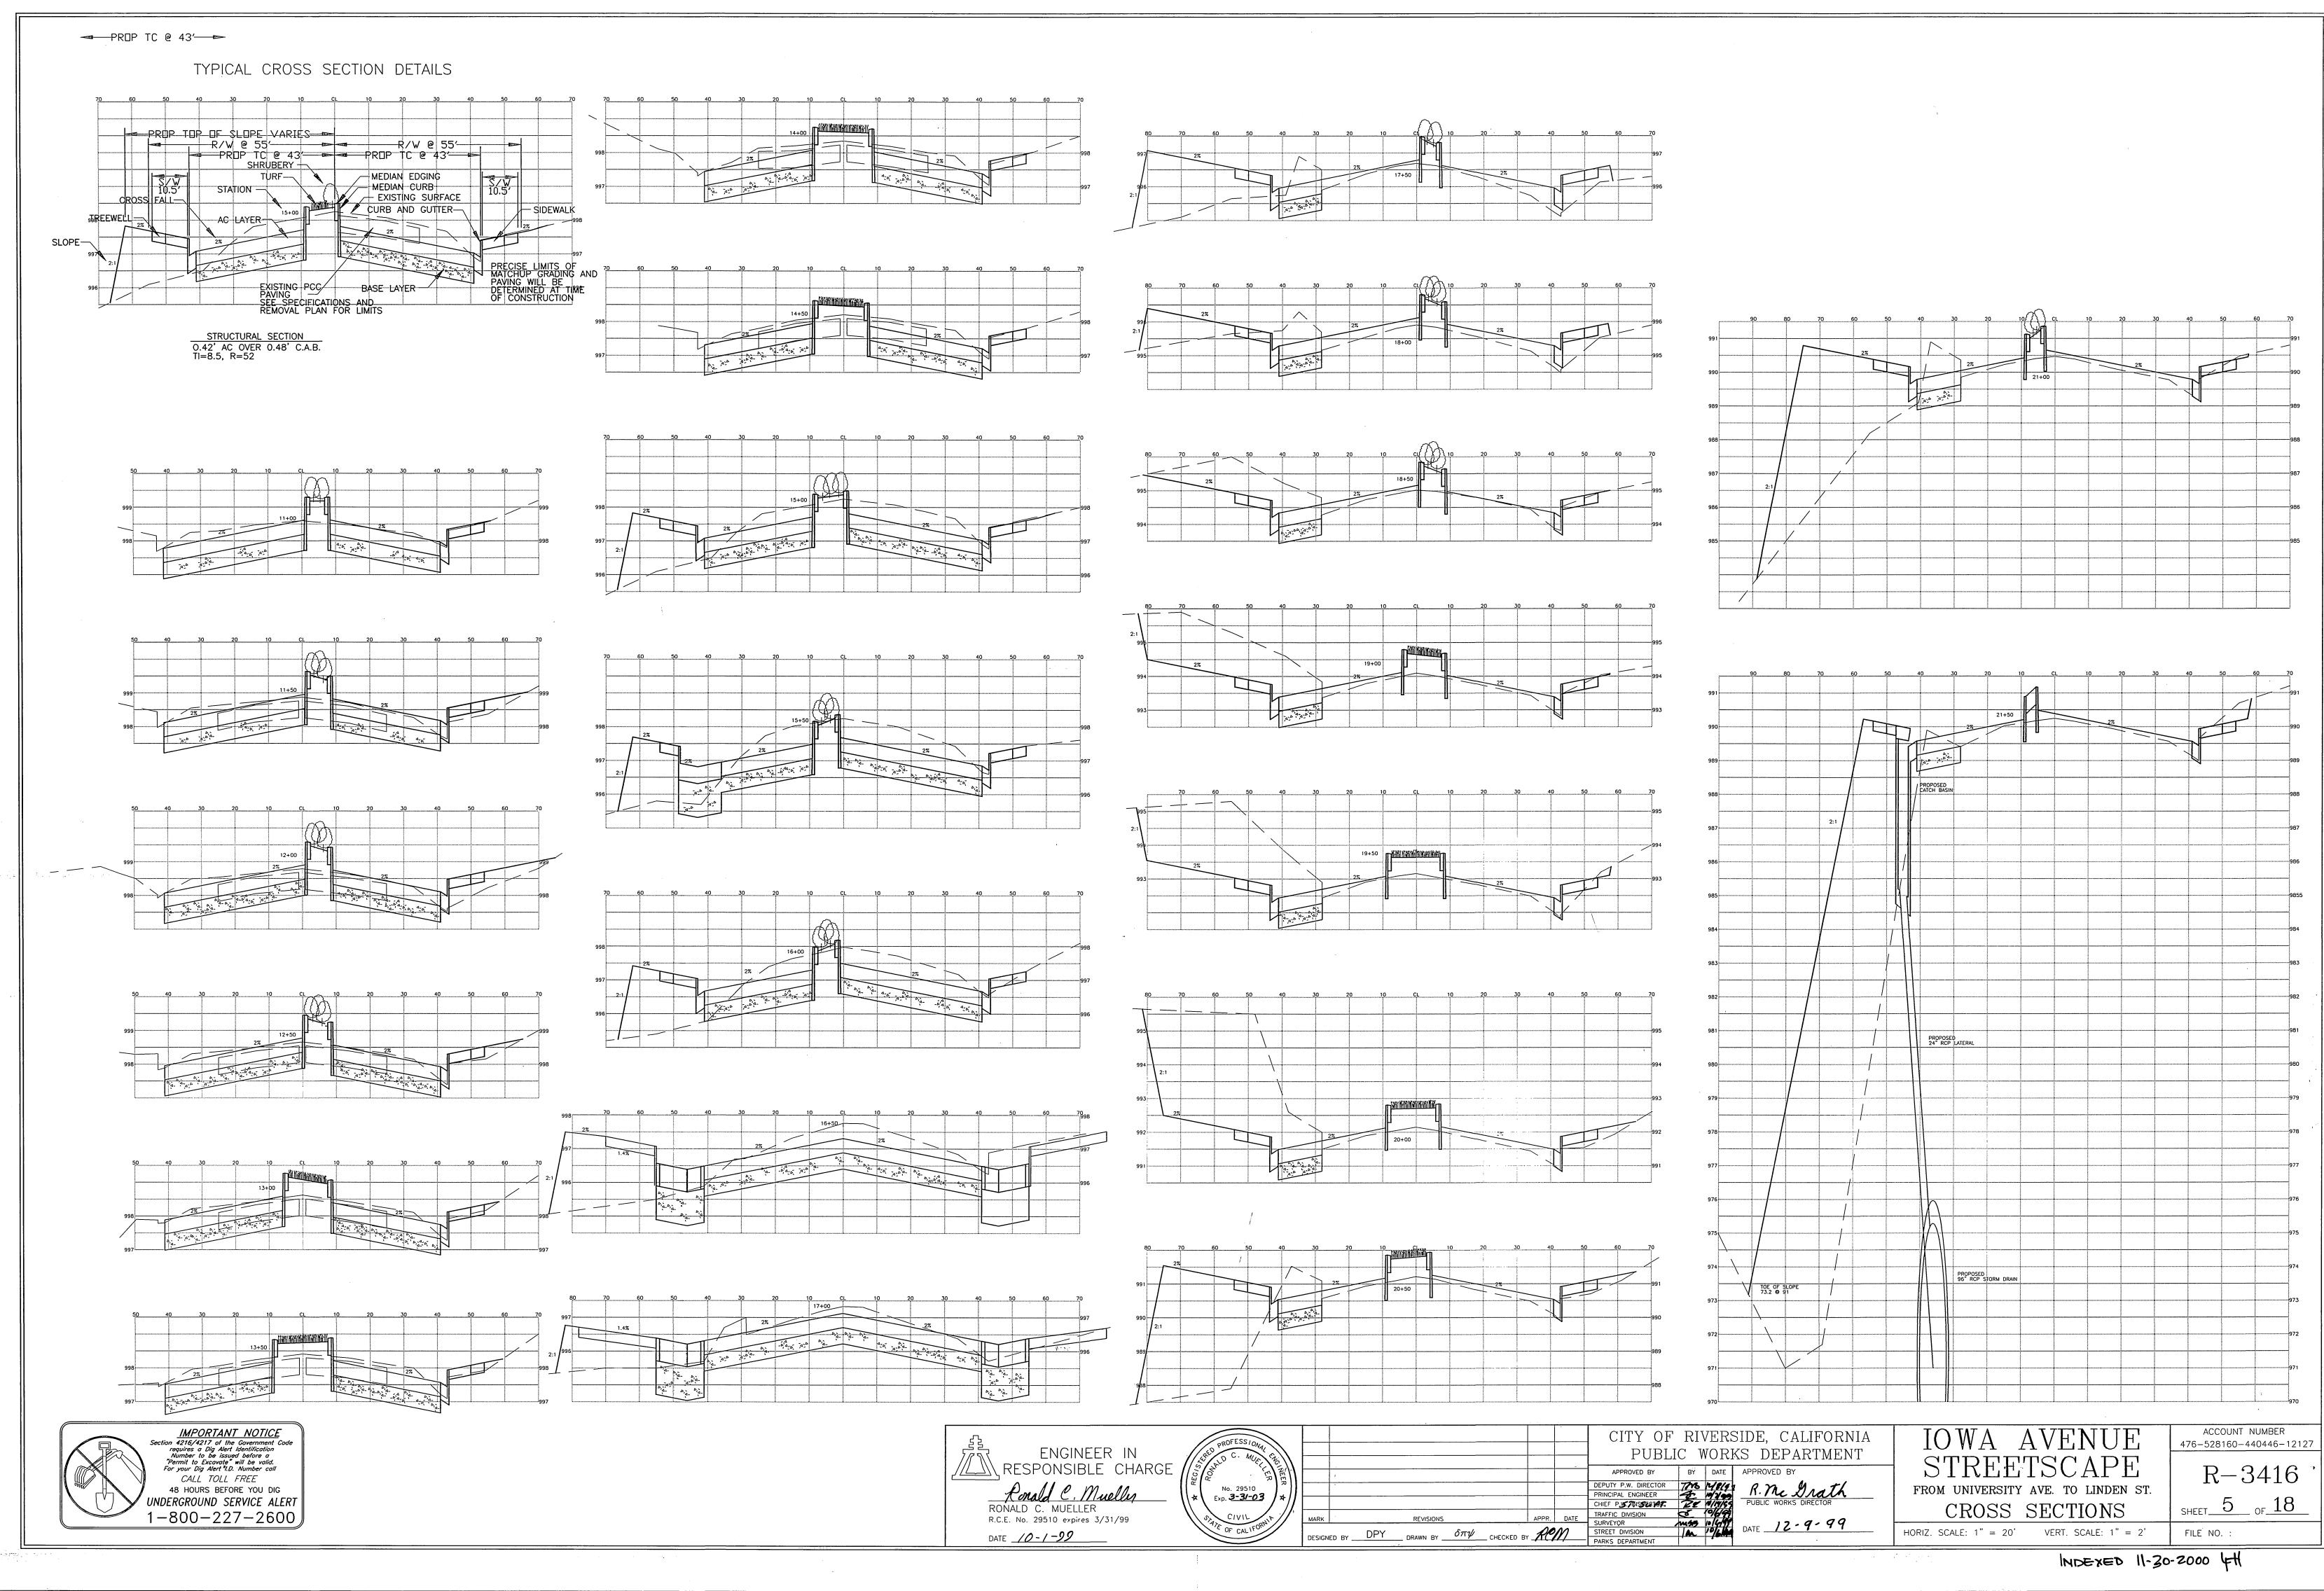
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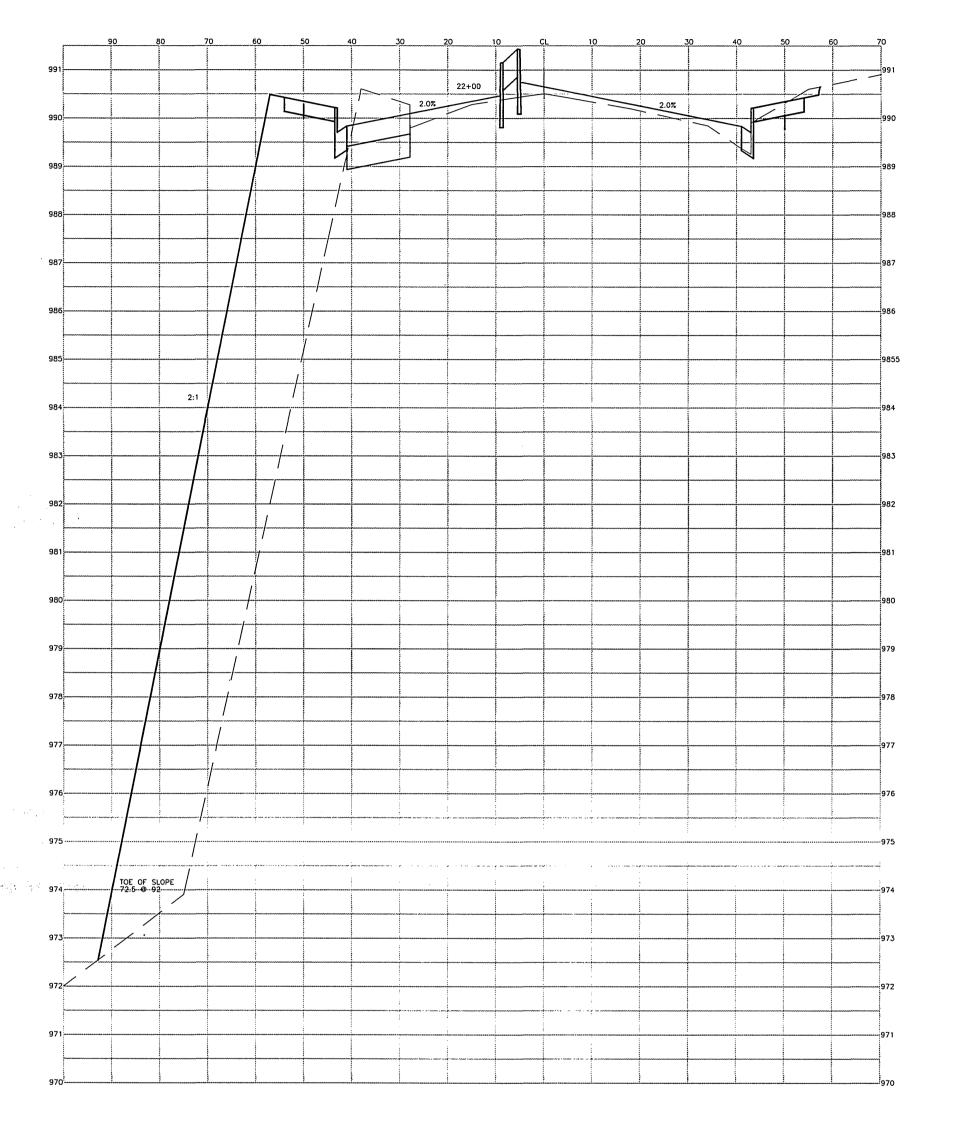
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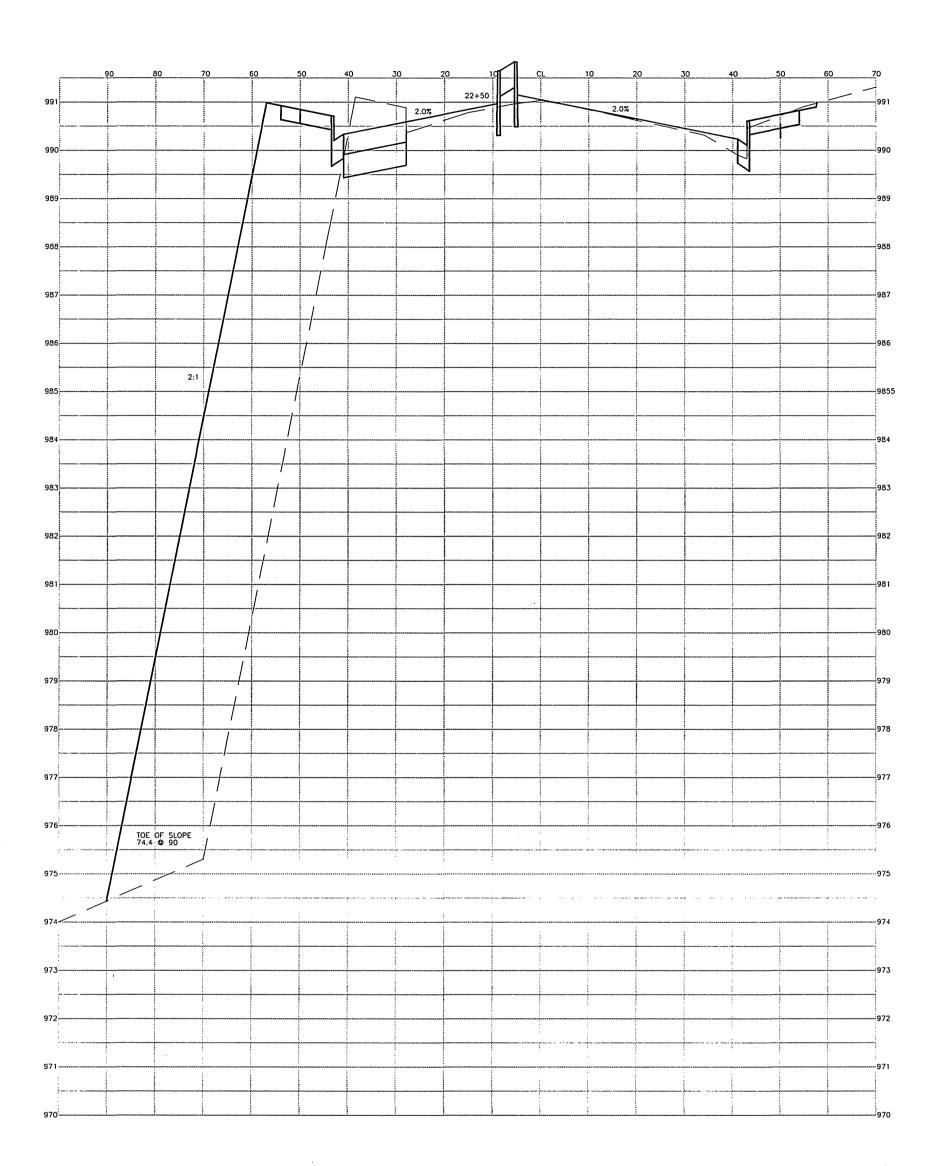











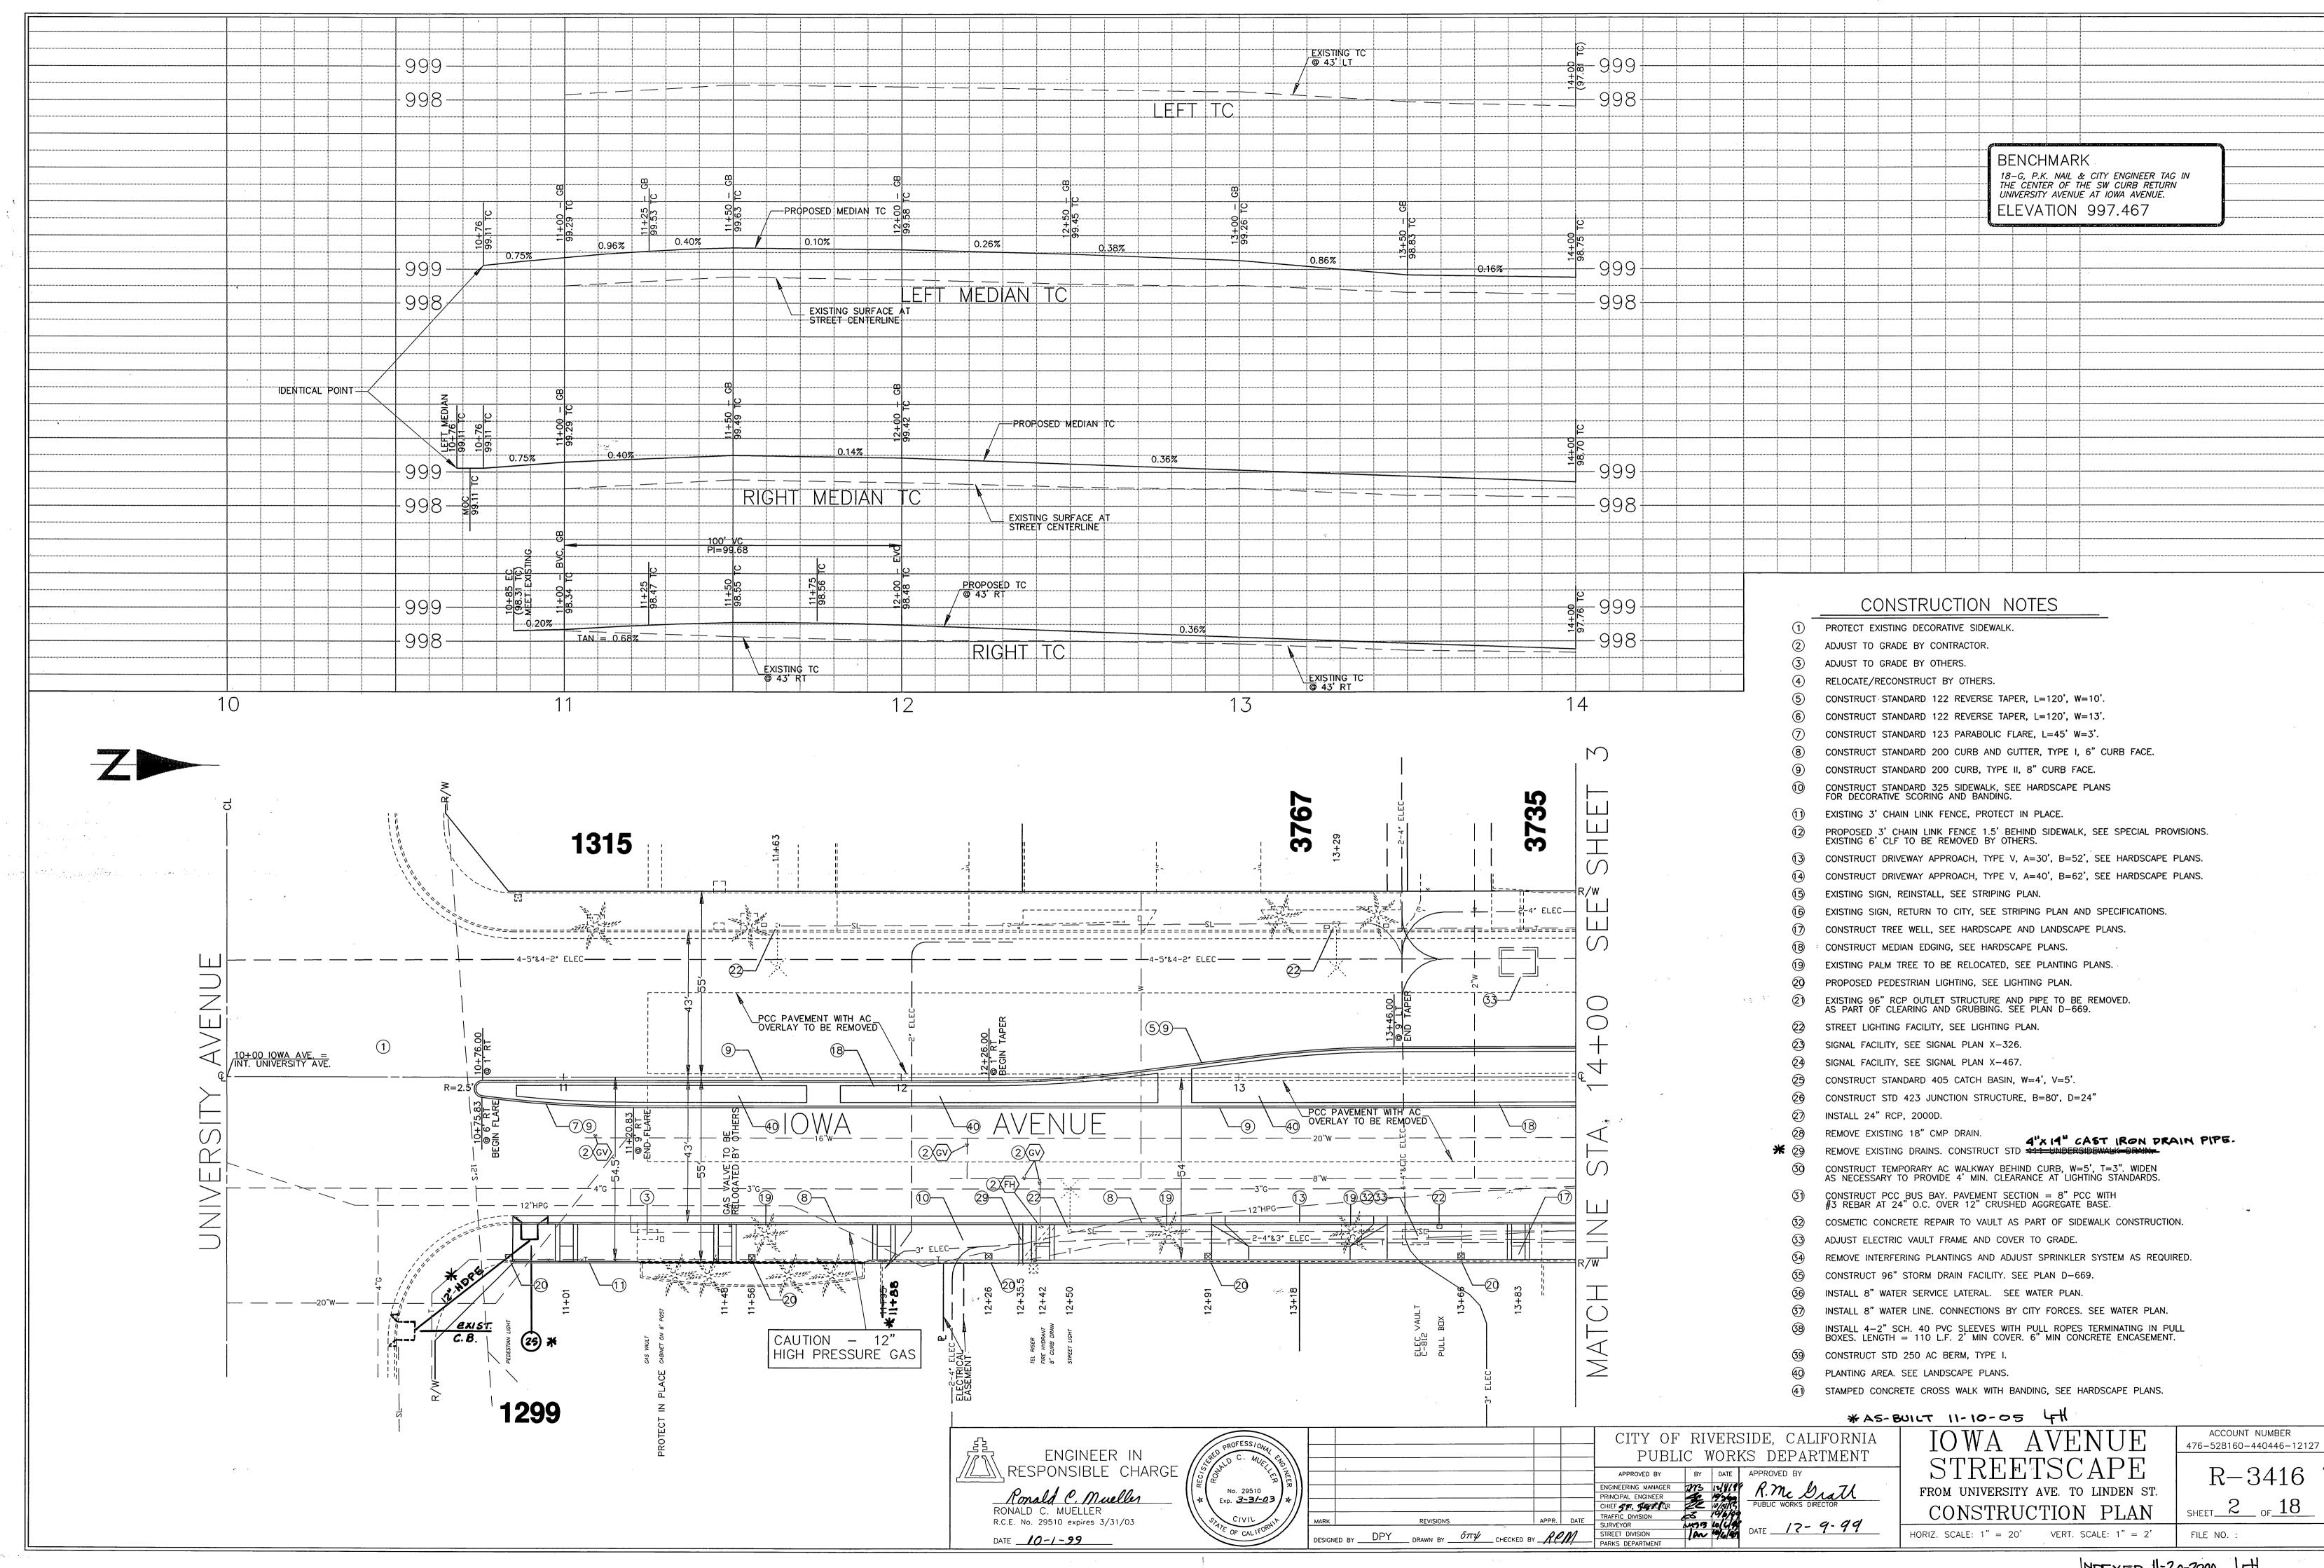

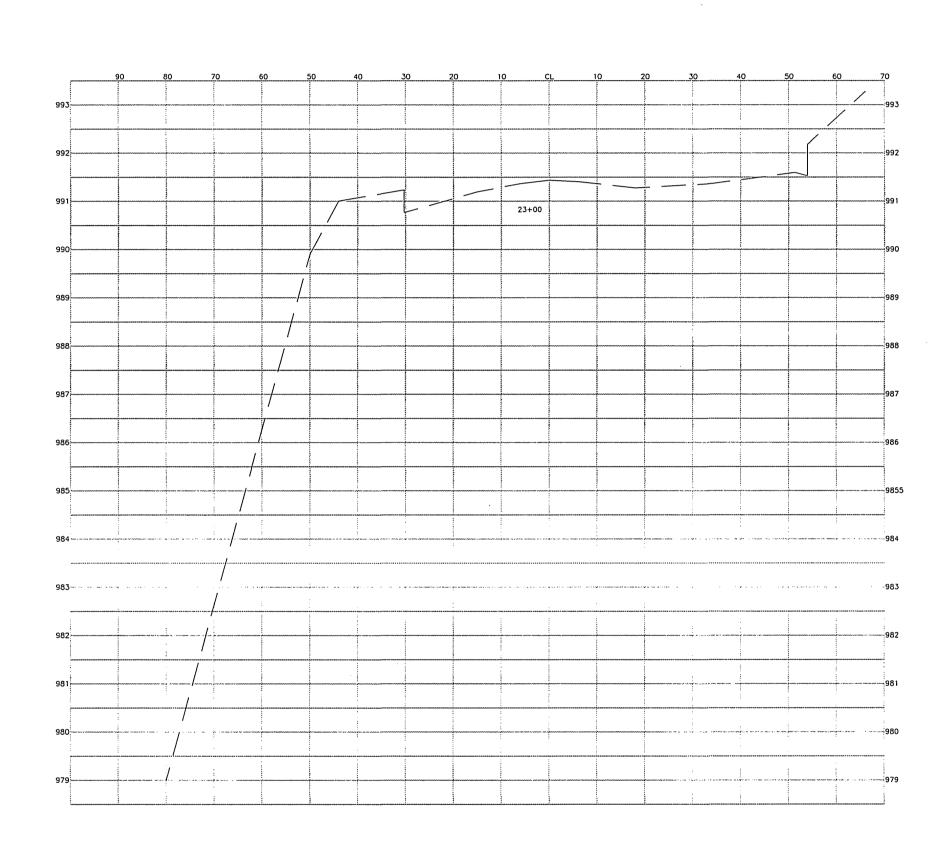




ENGINEER IN
RESPONSIBLE CHARGE

RONALD C. MUELLER
R.C.E. No. 29510 expires 3/31/99

DATE <u>/0-/-99</u>



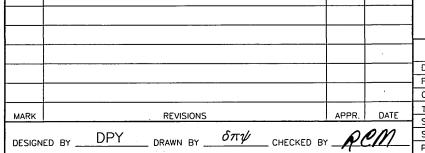

CITY OF RIVERSIDE, CALIFORNIA

PUBLIC WORKS DEPARTMENT

APPROVED BY

BY

DATE

APPROVED BY

APPROVED BY

PUTY P.W. DIRECTOR

NCIPAL ENGINEER

BEFORE DIVISION

APPROVED BY

PUBLIC WORKS DIRECTOR

PUBLIC WORKS DIRECTOR

*AS-BUILT 11-10-05 4H

IOWA AVENUE
STREETSCAPE
FROM UNIVERSITY AVE. TO LINDEN ST.

ACCOUNT NUMBER 476-528160-440446-12127 $R\!-\!3416$

CROSS SECTIONS

SHEET 6 OF 18

HORIZ. SCALE: 1" = 20' VERT. SCALE: 1" = 2' FILE NO. :

GENERAL NOTES FOR PUBLIC LANDSCAPING:

- 1. ALL RELATED WORK SHALL CONFORM TO THE CITY OF RIVERSIDE PARK AND RECREATION DEPARTMENT STANDARDS AND SPECIFICATIONS FOR PLANTING AND IRRIGATION WORK. (SPECIFICATION SECTIONS 02441 AND 02480).
- 2. WHEN CALLING FOR INSPECTIONS, CONTACT THE PARK PROJECTS INSPECTOR A MINIMUM OF 48 HOURS IN ADVANCE AT (909) 715-3469 TO SCHEDULE AN INSPECTION. A FIELD NOTICE WILL BE ISSUED AS WRITTEN APPROVAL FOR EACH STAGE OF INSPECTION. A VERBAL APPROVAL WILL NOT BE ACCEPTABLE. INSPECTIONS ARE REQUIRED PER THE SPECIFICATIONS, AND INCLUDE BUT ARE NOT NECESSARILY LIMITED TO THE FOLLOWING:
 - A. AFTER COMPLETION OF ROUGH GRADING OF THE PROJECT SITE WHEN ALL UTILITY SERVICES AND SEWER LATERALS HAVE BEEN MARKED. BUT PRIOR TO INITIATING ANY TREE RELOCATION OR LANDSCAPE WORK WITHIN
 - THE PUBLIC RIGHT OF WAY. B. AT TIME OF INSTALLATION OF IRRIGATION SLEEVES AND CONSTANT PRESSURE MAINLINES, BUT PRIOR TO BACKFILL OF TRENCHES FOR SAME (NOTE: MAINLINES MUST BE PRESSURE TESTED IN THE PRESENCE OF THE PARKS PROJECTS INSPECTOR).
 - C. AT TIME OF INSTALLATION OF IRRIGATION VALVES, LATERALS AND HEADS. D. FOR SPOTTING OF ALL TREES PRIOR TO DIGGING PLANT PITS.
 - E. WHILE DIGGING PLANT PITS AND PLANTING/RELOCATING TREES. F. AFTER PLANTING AND ALL OTHER INDICATED OR SPECIFIED WORK HAS BEEN COMPLETED, FOR START OF MAINTENANCE.
 - G. AT SUBSTANTIAL COMPLETION OF THE PROJECT FOR CITY'S ACCEPTANCE TO START THE REQUIRED MAINTENANCE PERIOD. H. AT THE END OF THE MAINTENANCE PERIOD, THE CONTRACTOR SHALL CALL THE PARK PROJECTS INSPECTOR FOR A FINAL ACCEPTANCE INSPECTION IN ORDER TO BE RELEASED FROM MAINTENANCE. BONDS WILL NOT BE RELEASED UNTIL AFTER RECEIPT OF WRITTEN NOTIFICATION FROM THE CITY THAT THE PROJECT HAS PASSED FINAL INSPECTION AND
- 3. THE CONTRACTOR SHALL BE RESPONSIBLE TO ACCEPTABLY MAINTAIN ALL PLANTINGS FOR A PERIOD OF ONE YEAR. FOR TREES AND 90 DAYS FOR TURF AND SHRUBS.

THE PARK AND RECREATION DEPARTMENT IS ASSUMING MAINTENANCE

4. ALL LANDSCAPE AREAS TO BE PUBLICLY MAINTAINED SHALL BE AUTOMATICALLY IRRIGATED. *NOTE: IN THE INTEREST OF PUBLIC SAFETY AND MAINTENANCE, THE PARK PROJECTS INSPECTOR SHALL HAVE THE AUTHORITY TO REVISE THE TREE QUANTITIES AND LOCATIONS SHOWN ON APPROVED PLANS BASED UPON FIELD CONDITIONS FOUND AT THE TIME OF INSTALLATION OF THE TREES.

LANDSCAPE	SYMBOL
	•

SEE DETAIL NUMBER ON PLANTING PLAN SHEET 9 OF 18	
	- LP3

RESPONSIBILITIES.

TREE	LEGEN
•	


Lagerstroemia indica 'Tuscarora' Crepe Myrtle Box, multi-trunk 4 required

Maytenus boaria Mavten Tree " Box, Standard

required

Koelreuteria bipinnata Chinese Flame Tree " Box, Matched Standard

Relocated palm tree in tree well See Palm Tree Relocation Table 3 required

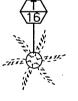


Existing Palm Tree (WF/WR) (Washingtonia filifera and/or Washingtonia robusta) to be relocated on lowa Avenue See Palm Tree Relocation Table ID # in lower half of hexagon. Existing Palm Trees to be relocated offsite will be to an existing City park site or other City maintained public landscape area as designated by the Park and Recreation Départment Urban Forestor.



Existing Palm Tree to remain

MEDIAN ISLAND PLANTINGS

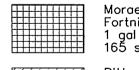

Fortnight Lily 1 gal at 18" o.c. 165 sq. ft., 84 required Pittosporum tobira 'Wheeler's Dwarf'



Wheeler's Dwarf Pittosporum 1 gal at 30" o.c. 322 sq. ft., 59 required Raphiolepis indica 'Pink Cloud' India Hawthorne 5 gal at 24" o.c. 215 sq. ft., 62 required




Carissa m. 'Boxwood Beauty' Dwarf Natal Plum 1 gal at 24" o.c. 245 sq. ft., 70 required Hydroseeded Turf per Specification 02480 1601 sq. ft.



IOWA AVENUE STREETSCAPE PLANTING SUMMARY TABLE						
BOTANICAL NAME	AME COMMON NAME SIZE					
Moraea bicolor	Fortnight Lily	1 gal.	337 ea.			
Pittosporum tobira 'Wheeler's Dwarf'	Wheeler's Dwarf Pittosporum	1 gal.	171 ea.			
Raphiolepis indica 'Pink Cloud'	India Hawthorne	5 gal.	124 ea.			
Raphiolepis indica 'Pink Cloud'	India Hawthorne	1 gal.	56 ea.			
Carissa m. 'Boxwood Beauty'	Dwarf Natal Plum	1 gal.	204 ea.			
Lagerstroemia indica 'Tuscarora'	Crepe Myrtle	36" box, multitrunk	12 ea.			
Koelreuteria bipinnata	Chinese Flame Tree	36" box	25 ea.			
Maytenus boaria	Mayten Tree	36" box	10 ea.			
Hydroseeded Turf	Seed Mix per Specifications		4700 sq. ft.			
Palm Tree, Relocate Onsite			18 ea.			
Palm Tree, Relocate Offsite			. 3 ea.			

PALM TREE RELOCATION TABLE						
TREE ID #	RELOCATE TO STA 15+01	APPROXIMATE HEIGHT				
1 23 4 5 6 7 8 9 10 11 12 14 15 16 17 19 20 21	15+01 14+77 15+95 15+72.5 20+18 22+16 21+13.5 19+24 18+33 OFFSITE 11+95 13+83 11+01 22+39 21+35 17+62.5 19+47 18+53 OFFSITE 20+42.5 OFFSITE	40'-50' 40'-50' 40'-50' 40'-50' 40'-50' 40'-50' 40'-50' 40'-50' 40'-50' 15'-20' 50'-60' 50'-60' 20'-30' 20'-30' 20'-30' 10'-15' 20'-30'				

SHRUB PLANTING TABLE FOR SIDEWALK TREEWELLS					
RIGHT SIDE				LEFT SIDE	
TREE SHRUB STATION TYPE	QUANTITY AND SIZE		TREE STATION	SHRUB TYPE	QUANTITY AND SIZE
11+01 11+48 11+95 12+42 13+83 14+30 14+77 15+24 15+72.5 17+62.5 18+07 18+53 19+00 19+47 20+42.5 20+89 21+35 21+82 22+39 Moraea Carissa Raphiolepis Moraea Raphiolepis Carissa Raphiolepis Carissa Raphiolepis Moraea Raphiolepis Moraea Raphiolepis Moraea Raphiolepis	8 ea, 1 gal 6 ea, 1 gal 8 ea, 1 gal 6 ea, 1 gal		15+01 15+95 17+90.5 18+33 18+75.5 19+24 19+71 20+18 20+65 21+13.5 21+59 22+16 22+63	Raphiolepis Raphiolepis None None None None None None None Carissa Raphiolepis Carissa	4 ea, 1 gal 4 ea, 1 gal 6 ea, 1 gal 6 ea, 1 gal 6 ea, 1 gal

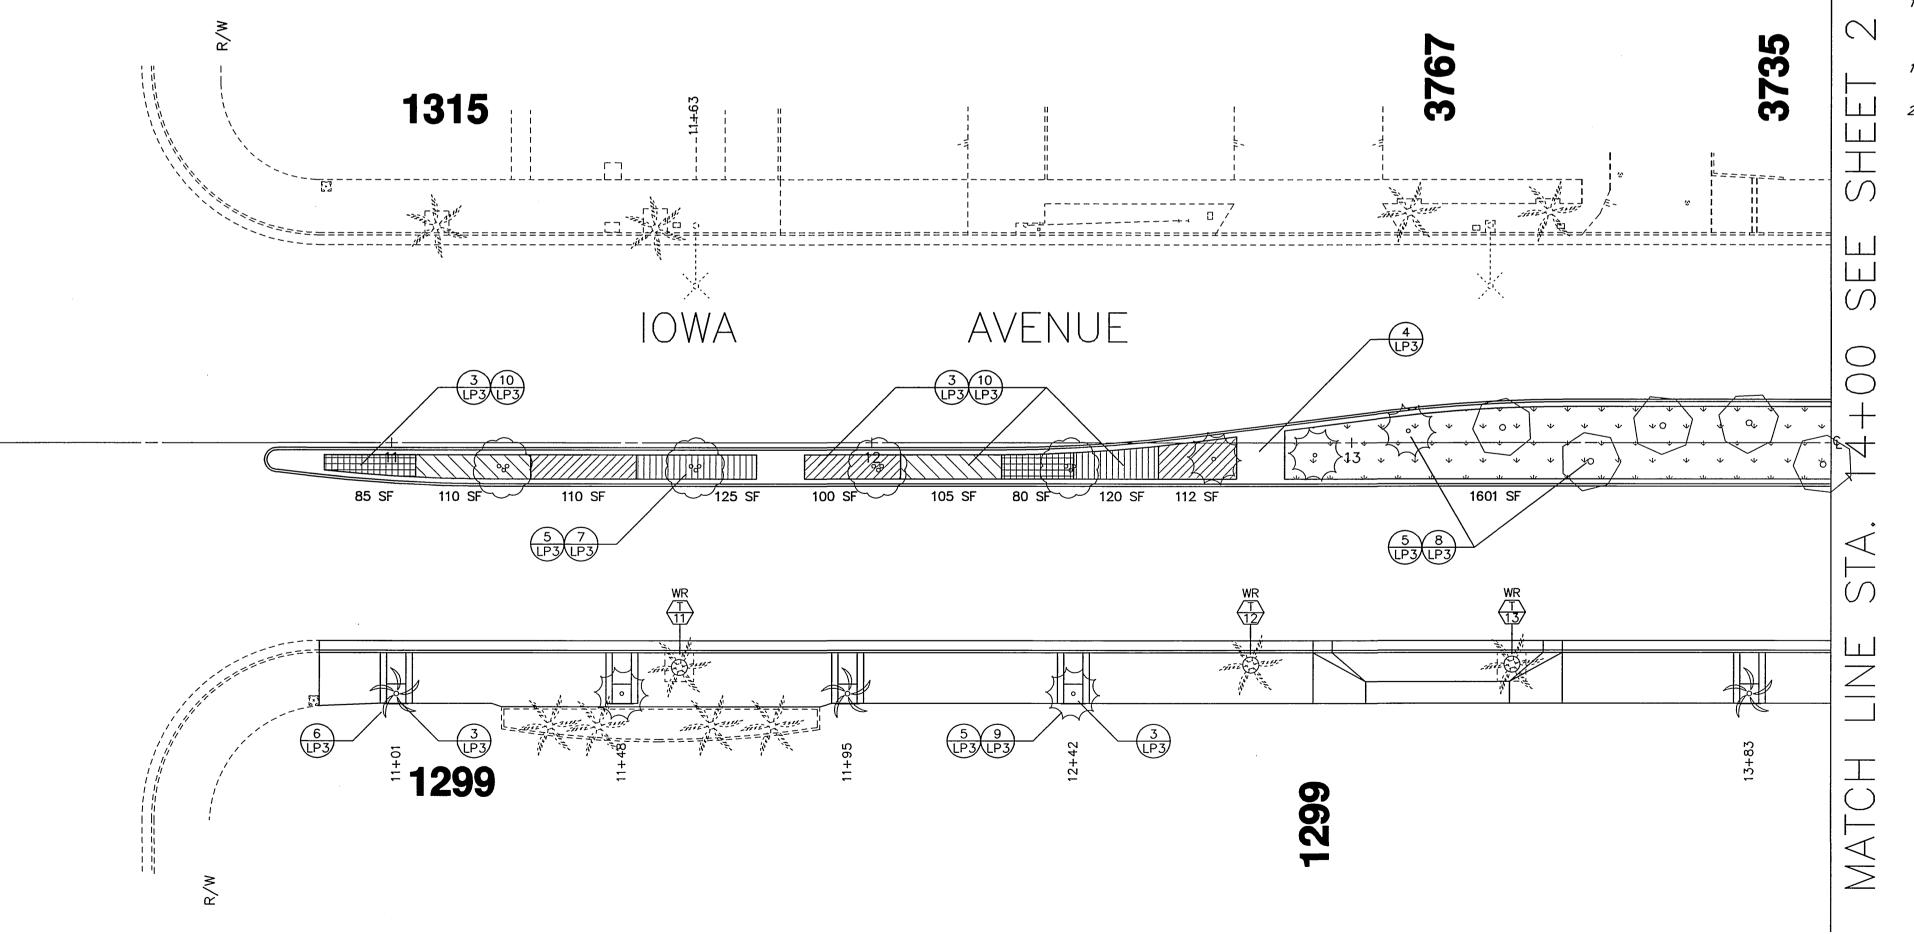

No. 29510

Exp. 3-3/-03

ENGINEER IN

RESPONSIBLE CHARGE

Ronald C. Mueller

R.C.E. No. 29510 expires 3/31/03

RONALD C. MUELLER

DATE <u>/0-/-99</u>

PLANTING NOTES:

- 1. PLANS-DESIGN-IS DIAGRAMMATIC AND SHALL NOT TAKE PLACE WHERE UNFORESEEN SITE CONDITIONS PREVENT EXECUTION OF THE DESIGNERS INTENT. WHEN UNEXPECTED SITE CONDITIONS CAUSE UNREASONABLE DEVIATIONS IN THE INTENDED PLANTING SCHEME THE CONTRACTOR SHALL IMMEDIATELY INFORM THE ENGINEER.
- 2. MAINTENANCE PERIOD SHALL BL 90 DAYS FROM DATE OF ACCEPTANCE. TREE PLANTING SHALL BE GUARANTEED FOR ONE YEAR. MAINTENANCE SHALL INCLUDE BI-WEEKLY WEED AND RODENT ABATEMENT PROCEDURES INCLUDING 4 FOLIAR APPLICATIONS OF CHELATED IRON AND TRACE MINERALS 90 DAYS APART.
- 3. REPLACEMENT OF DAMAGED OR DESTROYED ITEMS SHALL TAKE PLACE WITHIN 48 HOURS OF NOTIFICATION BY THE CITY'S REPRESENTATIVE, OR SAID REPLACEMENT ITEMS SHALL BE DEDUCTED FROM THE CONTRACTOR'S FINAL BILLING.
- 4. REPLACEMENT ITEMS SHALL BE EXACT DUPLICATE OF ORIGINAL WORK OR PLANTS, UNLESS OTHERWISE APPROVED BY THE ENGINEER OR CITY'S REPRESENTATIVE.
- 5. TREES AND SHRUBS SHALL BE PLANTED AFTER CONCRETE PLACEMENT, BUT NOT BEFORE IRRIGATION COVERAGE HAS BEEN APPROVED.
- 6. PLACE TREES BETWEEN SPRAY HEADS WHEREVER POSSIBLE.
- 7. AREAS TO BE PLANTED WITH GROUND COVER SHALL HAVE THE FOLLOWING TILLED INTO THE TOP 6" OF SOIL PER 1,000 SQ. FT.: 4 CU. YDS. NITROLIZED WOOD SHAVINGS
 - 20 LBS. 12-12-12 COMMERCIAL FERTILIZER (BEST PRODUCTS OR EQUAL) 100 LBS. AG. GYPSUM 10 LBS SOIL SULFUR 20 LBS. IRON SULFATE
- PRIOR TO PLANTING OF GROUND COVER FLATS, A GRANULAR PRE-EMERGENT, NON-SELECTIVE HERBICIDE SHALL BE APPLIED ACCORDING TO MANUFACTURER'S RECOMMENDATION.
- 8. TREE BACKFILL MIX SHALL CONSIST OF THE FOLLOWING PER CU. YD.:
 - 2/3 YD. SCREENED SITE SOIL 1/3 YD. NITROLIZED WOOD SHAVINGS
 - 1 LB. 12-12-12 COMMERCIAL FERTILIZER 10 LBS. AG GYPSUM
 - *1 LBS. SOIL SULFUR*
 - 2 LBS. IRON SULFATE
- 9. IRRIGATION SYSTEM SHALL BE INSTALLED PRIOR TO PLANT MATERIAL.
- 10. CLEAN—UP SHALL TAKE PLACE ON A DAILY BASIS UNLESS OTHERWISE APPROVED BY THE CITY'S REPRESENTATIVE.
- 11. CONTACT THE PARK PROJECTS INSPECTOR AT 715-3469 TWO WORKING DAYS (48 HOURS) PRIOR TO INSTALLING ANY PLANT MATERIAL.
- 12. WATERING BASINS MAY BE REMOVED AFTER THE MAINTENANCE PERIOD.
- 13. FOR STAKING INFORMATION AS APPLICABLE, REFER TO STAKING DETAIL.
- 14. FOR GUYING INFORMATION AS APPLICABLE, REFER TO GUYING DETAIL.

2 TABLETS

- 15. FOR SPECIFICATION INFORMATION, REFER TO CITY OF RIVERSIDE PARK AND RECREATION DEPARTMENT STANDARD SPECIFICATIONS, SECTION 02480 PLANTING.
- 16. PROVIDE FERTILIZER TABLETS AS FOLLOWS: 1 GALLON PLANT 2 TABLETS 5 GALLON PLANT 3 TABLETS 15 GALLON PLANT 5 TABLETS

24" BOX PLANT

- 17. TREE HEIGHTS LISTED IN THE PALM TREE RELOCATION TABLE ARE FOR INFORMATIONAL PURPOSES ONLY. CONTRACTOR SHALL EVALUATE TREES TO BE RELOCATED AND SHALL ASSUME RESPONSIBILITY FOR TREE HEIGHT DETERMINATION.
- 18. ADJACENT TO EACH HATCHED AREA ON THE PLAN SHOWING PLANT TYPE IS THE APPROXIMATE SQUARE FOOTAGE AREA OF THAT TYPE OF PLANT. THESE PLANS ARE INTENDED TO BE DIAGRAMMATIC IN NATURE AND ADJUSTMENTS MAY BE MADE IN THE FIELD BY THE INSPECTOR.
- 19. ALL AREAS WITHIN THE MEDIANS SHALL BE BACKFILLED WITH CLASS "A" TOPSOIL TO A MINIMUM THICKNESS OF 12".
- 20. ALL SHRUB AREAS WITHIN THE MEDIAN NOSES SHALL BE RECEIVE A 2" LAYER OF MULCH.

*AS-BUILT 11-10-05 41

HORIZ. SCALE: 1" = 20'


CITY OF RIVERSIDE, CALIFORNIA


PUBLIC WORKS DEPARTMENT

ACCOUNT NUMBER 476-528160-440446-12127 R - 3416SHEET 7 OF 18 PLANTING PLAN - LP1

INDEXED 11-30-2000 4H

VERT. SCALE: 1" = 4'

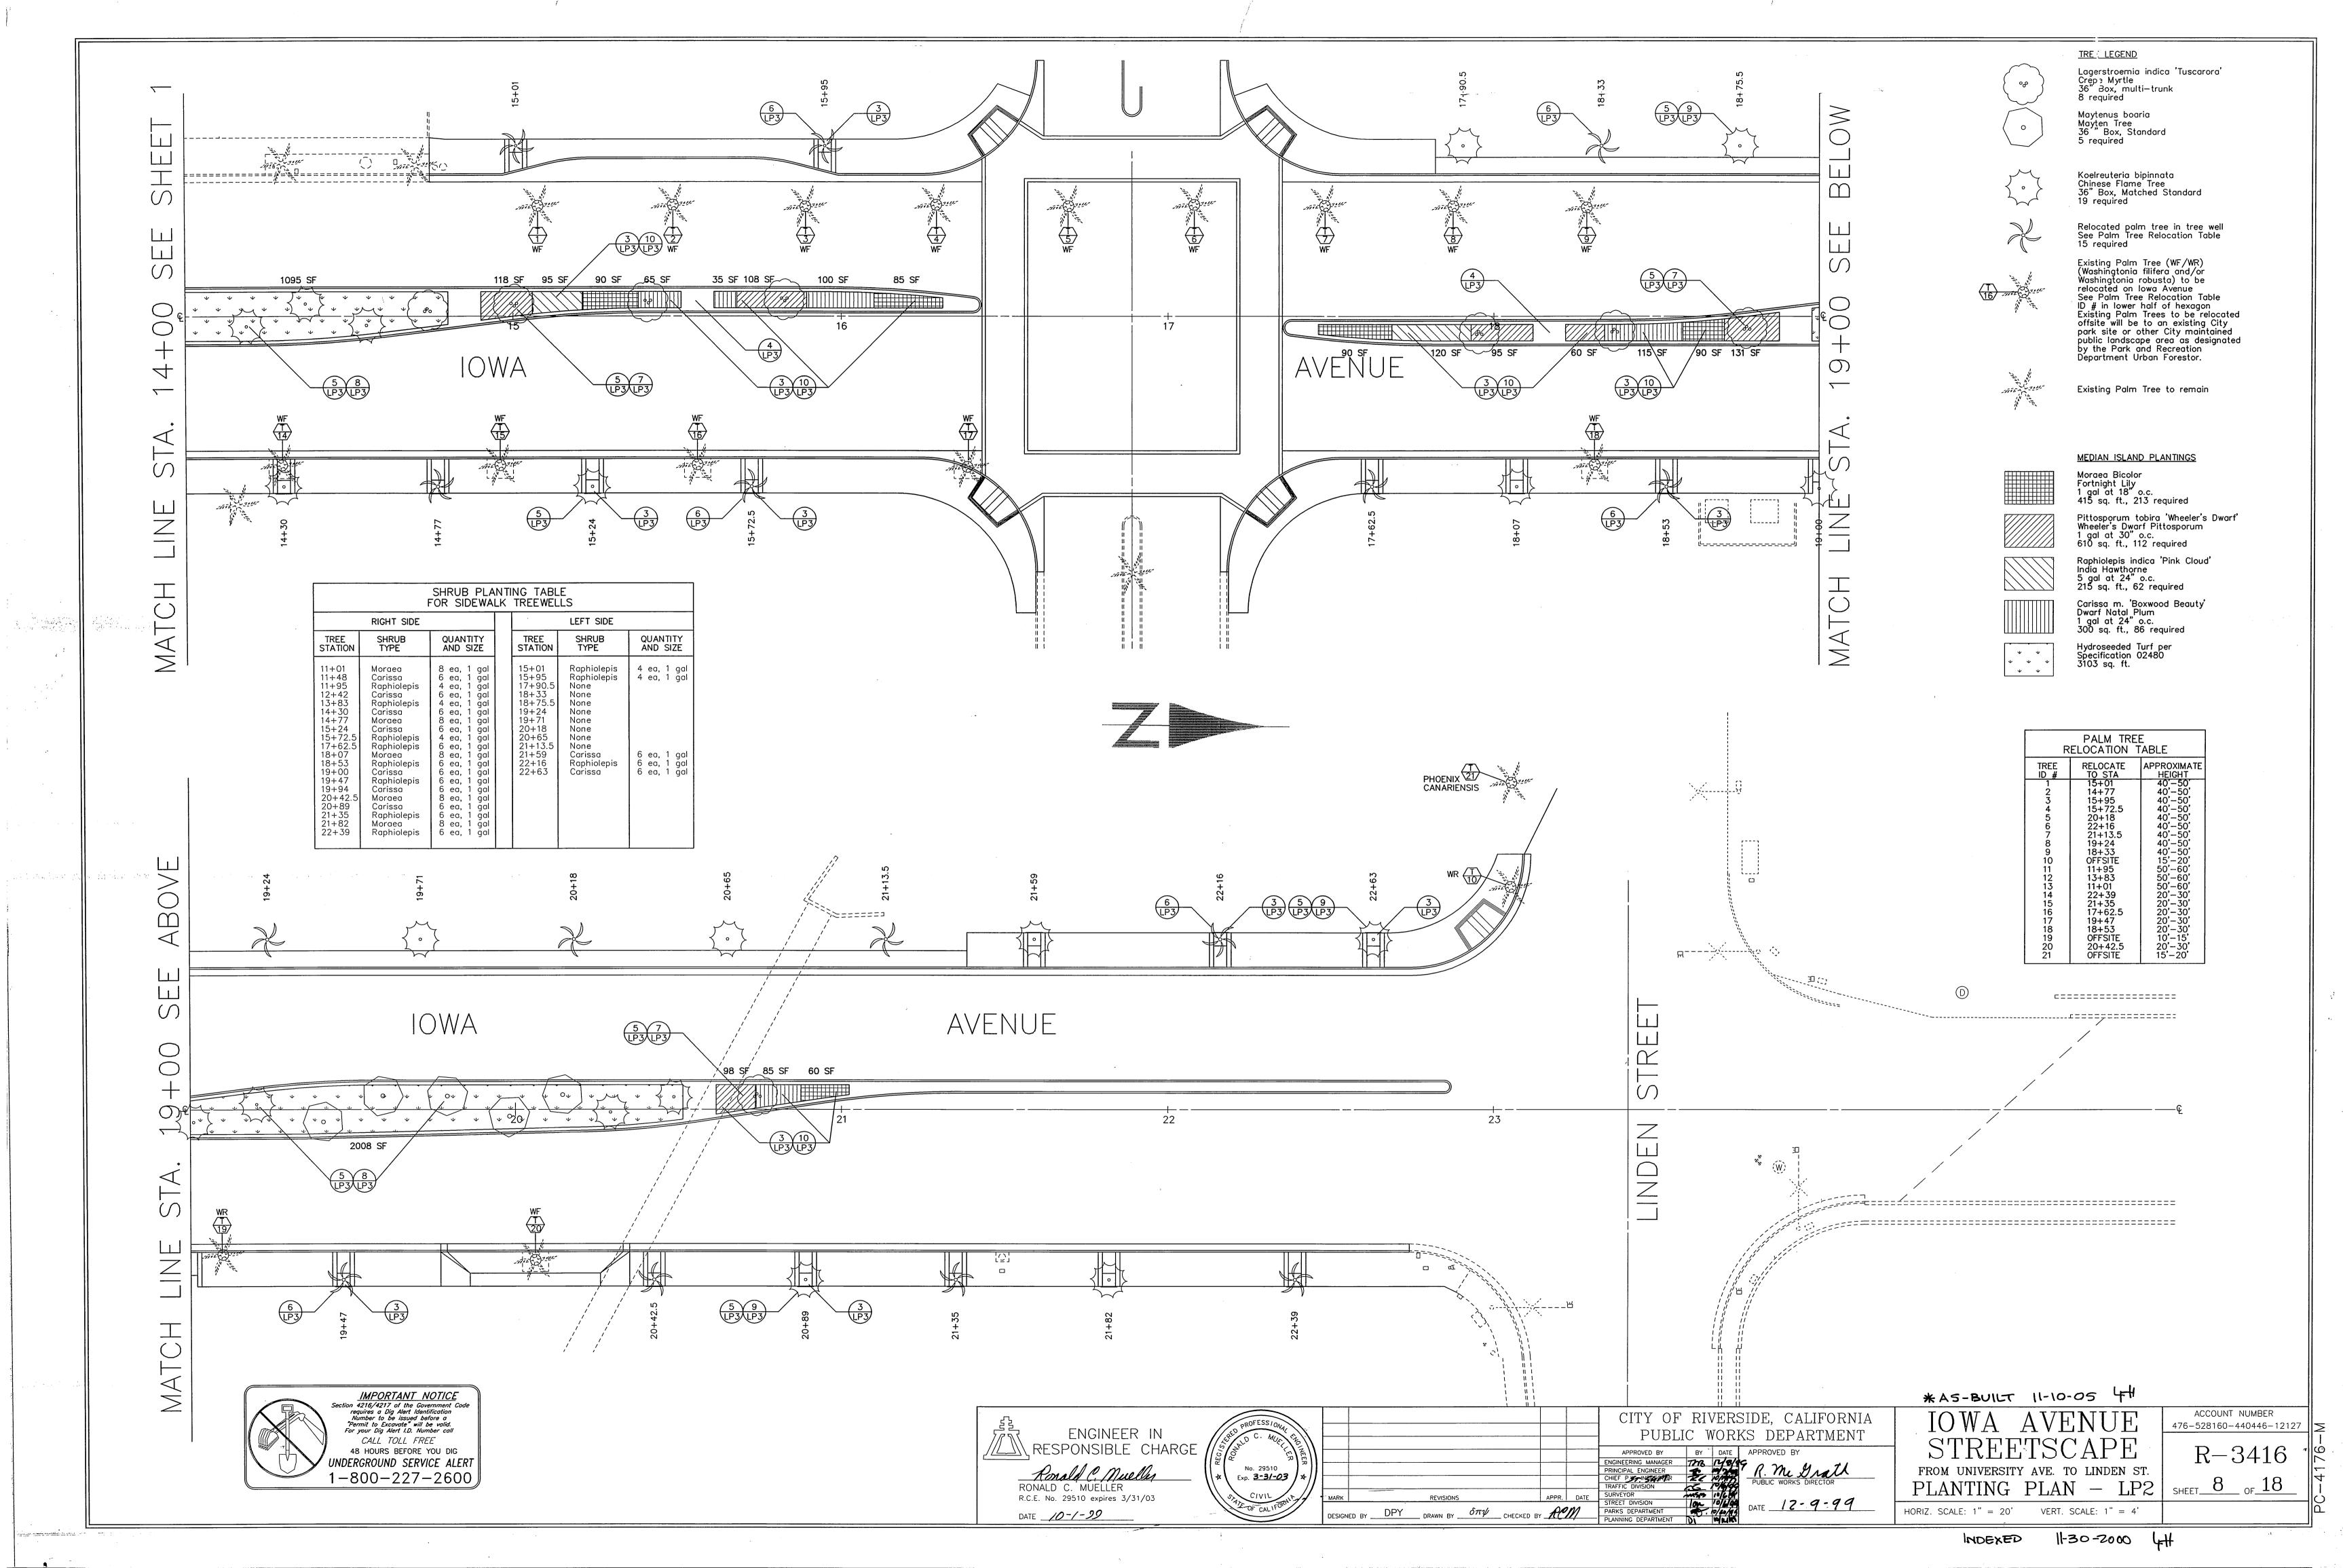

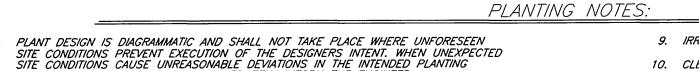

- SCHEME THE CONTRACTOR SHALL IMMEDIATELY INFORM THE ENGINEER. MAINTENANCE PERIOD SHALL BE 360 DAYS FROM DATE OF ACCEPTANCE.
 PLANTING SHALL BE GUARANTEED FOR ONE YEAR. MAINTENANCE SHALL INCLUDE
 BI-WEEKLY WEED AND RODENT ABATEMENT PROCEDURES INCLUDING 4 FOLIAR
- APPLICATIONS OF CHELATED IRON AND TRACE MINERALS 90 DAYS APART. REPLACEMENT OF DAMAGED OR DESTROYED ITEMS SHALL TAKE PLACE WITHIN 48 HOURS OF NOTIFICATION BY THE CITY'S REPRESENTATIVE, OR SAID REPLACEMENT
- ITEMS SHALL BE DEDUCTED FROM THE CONTRACTOR'S FINAL BILLING.
- REPLACEMENT ITEMS SHALL BE EXACT DUPLICATE OF ORIGINAL WORK OR PLANTS, UNLESS OTHERWISE APPROVED BY THE ENGINEER OR CITY'S REPRESENTATIVE. 5. TREES AND SHRUBS SHALL BE PLANTED AFTER CONCRETE PLACEMENT, BUT NOT
- BEFORE IRRIGATION COVERAGE HAS BEEN APPROVED. 6. PLACE TREES BETWEEN SPRAY HEADS WHEREVER POSSIBLE.
- 7. AREAS TO BE PLANTED WITH GROUND COVER SHALL HAVE THE FOLLOWING TILLED INTO THE TOP 6" OF SOIL PER 1,000 SQ. FT.:
 - 4 CU. YDS. NITROLIZED WOOD SHAVINGS 20 LBS. 12-12-12 COMMERCIAL FERTILIZER (BEST PRODUCTS OR EQUAL)
 100 LBS. AG. GYPSUM
 10 LBS SOIL SULFUR
- PRIOR TO PLANTING OF GROUND COVER FLATS, A GRANULAR PRE-EMERGENT, NON-SELECTIVE HERBICIDE SHALL BE APPLIED ACCORDING TO MANUFACTURER'S
- 8. TREE BACKFILL MIX SHALL CONSIST OF THE FOLLOWING PER CU. YD.: 2/3 YD. SCREENED SITE SOIL 1/3 YD. NITROLIZED WOOD SHAVINGS 1 LB. 12-12-12 COMMERCIAL FERTILIZER
 10 LBS. AG GYPSUM 1 LBS. SOIL SULFUR 2 LBS. IRON SULFATE

9. IRRIGATION SYSTEM SHALL BE INSTALLED PRIOR TO PLANT MATERIAL.

- 10. CLEAN-UP SHALL TAKE PLACE ON A DAILY BASIS UNLESS OTHERWISE APPROVED BY THE CITY'S REPRESENTATIVE.

RECREATION DEPARTMENT STANDARD SPECIFICATIONS, SECTION 02480 PLANTING.

- 11. CONTACT THE PARK PROJECTS INSPECTOR AT 715-3469 TWO WORKING DAYS (48 HOURS) PRIOR TO INSTALLING ANY PLANT MATERIAL.
- 12. WATERING BASINS MAY BE REMOVED AFTER THE MAINTENANCE PERIOD.
- 13. FOR STAKING INFORMATION AS APPLICABLE, REFER TO STAKING DETAIL.
- 14. FOR GUYING INFORMATION AS APPLICABLE, REFER TO GUYING DETAIL. 15. FOR SPECIFICATION INFORMATION, REFER TO CITY OF RIVERSIDE PARK AND

2 TABLETS

PROVIDE FERTILIZER TABLETS AS FOLLOWS: 2 TABLETS 3 TABLETS 1 GALLON PLANT 5 GALLON PLANT 15 GALLON PLANT 5 TABLETS


24" BOX PLANT


- 17. TREE HEIGHTS LISTED IN THE PALM TREE RELOCATION TABLE ARE FOR INFORMATIONAL PURPOSES ONLY. CONTRACTOR SHALL EVALUATE TREES TO BE RELOCATED AND SHALL ASSUME RESPONSIBILITY FOR TREE HEIGHT DETERMINATION.
- 18. ADJACENT TO EACH HATCHED AREA ON THE PLAN SHOWING PLANT TYPE IS THE APPROXIMATE SOUARE FOOTAGE AREA OF THAT TYPE OF PLANT. THESE PLANS ARE INTENDED TO BE DIAGRAMMATIC IN NATURE AND ADJUSTMENTS MAY BE MADE IN THE FIELD BY THE INSPECTOR.
- 19. ALL AREAS WITHIN THE MEDIANS SHALL BE BACKFILLED WITH CLASS "A" TOPSOIL TO A MINIMUM THICKNESS OF 12".
- 20. ALL SHRUB AREAS WITHIN THE MEDIAN NOSES SHALL RECEIVE A 2" LAYER

GENERAL NOTES FOR PUBLIC LANDSCAPING:


- 1. ALL RELATED WORK SHALL CONFORM TO THE CITY OF RIVERSIDE PARK AND RECREATION DEPARIMENT SIANDARDS AND SPECIFICATIONS FOR PLANTING AND IRRIGATION TORKS (SPECIFICATION SECTIONS 02441 AND 02480).
- 2. WHEN CALLING FOR INSPECTIONS, CONTACT THE PARK PROJECTS INSPECTOR A MINIMUM OF 48 HOURS IN ADVANCE AT (909) 715-3469 TO SCHEDULE AN INSPECTION. A FIELD NOTICE WILL BE ISSUED AS WRITTEN APPROVAL FOR EACH STAGE OF INSPECTION. A VERBAL APPROVAL WILL NOT BE ACCEPTABLE. INSPECTIONS ARE REQUIRED PER THE SPECIFICATIONS, AND INCLUDE BUT ARE NOT NECESSARILY LIMITED TO THE FOLLOWING:
 - A. AFTER COMPLETION OF ROUGH GRADING OF THE PROJECT SITE WHEN ALL UTILITY SERVICES AND SEWER LATERALS HAVE BEEN MARKED, BUT PRIOR TO INITIATING ANY TREE RELOCATION OR LANDSCAPE WORK WITHIN
 - THE PUBLIC RIGHT OF WAY. B. AT TIME OF INSTALLATION OF IRRIGATION SLEEVES AND CONSTANT PRESSURE MAINLINES, BUT PRIOR TO BACKFILL OF TRENCHES FOR SAME (NOTE: MAINLINES MUST BE PRESSURE TESTED IN THE PRESENCE OF THE PARKS PROJECTS INSPECTOR).
 - C. AT TIME OF INSTALLATION OF IRRIGATION VALVES, LATERALS AND HEADS. D. FOR SPOTTING OF ALL TREES PRIOR TO DIGGING PLANT PITS. E. WHILE DIGGING PLANT PITS AND PLANTING/RELOCATING TREES.
 - F. AFTER PLANTING AND ALL OTHER INDICATED OR SPECIFIED WORK HAS BEEN COMPLETED, FOR START OF MAINTENANCE. G. AT SUBSTANTIAL COMPLETION OF THE PROJECT FOR CITY'S
 - ACCEPTANCE TO START THE REQUIRED MAINTENANCE PERIOD. H. AT THE END OF THE MAINTENANCE PERIOD, THE CONTRACTOR SHALL CALL THE PARK PROJECTS INSPECTOR FOR A FINAL ACCEPTANCE INSPECTION IN ORDER TO BE RELEASED FROM MAINTENANCE. BONDS WILL NOT BE RELEASED UNTIL AFTER RECEIPT OF WRITTEN NOTIFICATION FROM THE CITY THAT THE PROJECT HAS PASSED FINAL INSPECTION AND THE PARK AND RECREATION DEPARTMENT IS ASSUMING MAINTENANCE RESPONSIBILITIES.
- 3. THE CONTRACTOR SHALL BE RESPONSIBLE TO ACCEPTABLY MAINTAIN ALL PLANTINGS FOR A PERIOD OF ONE YEAR.
- 4. ALL LANDSCAPE AREAS TO BE PUBLICLY MAINTAINED SHALL BE AUTOMATICALLY

*NOTE: IN THE INTEREST OF PUBLIC SAFETY AND MAINTENANCE. THE PARK PROJECTS INSPECTOR SHALL HAVE THE AUTHORITY TO REVISE THE TREE QUANTITIES AND LOCATIONS SHOWN ON APPROVED PLANS BASED UPON FIELD CONDITIONS FOUND AT THE TIME OF INSTALLATION OF THE TREES.

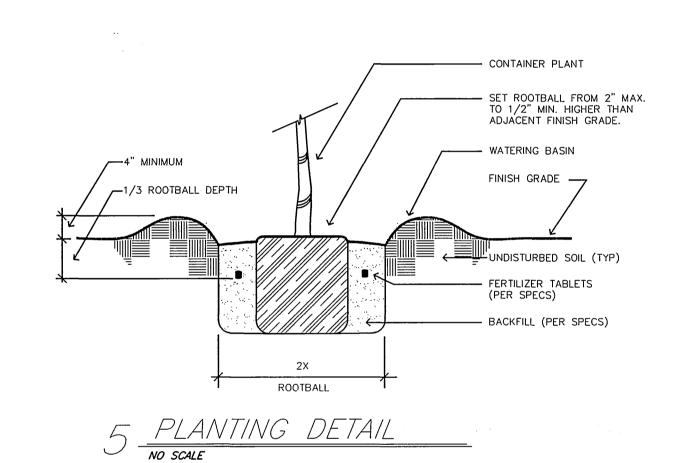

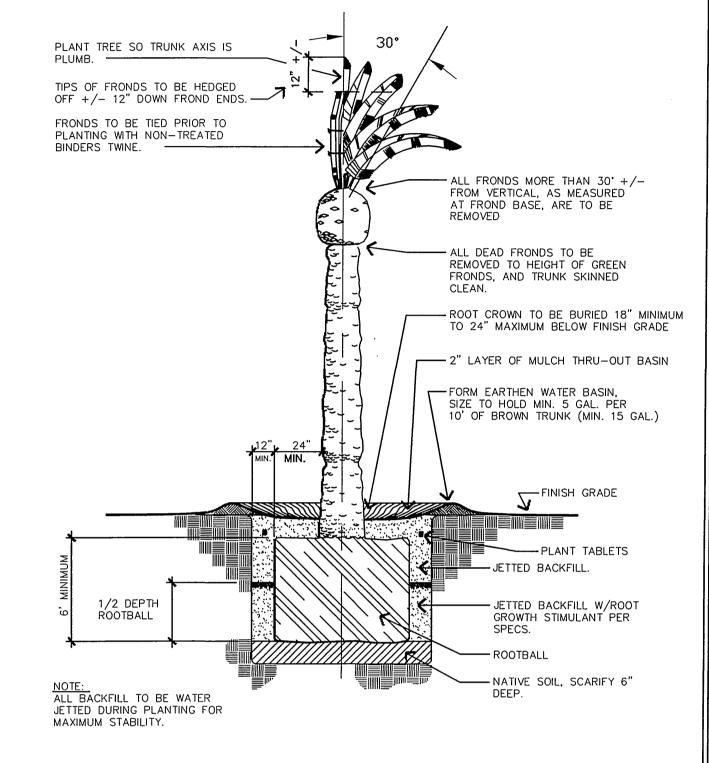


6 PALM TREE RELOCATION PLANTING DETAIL

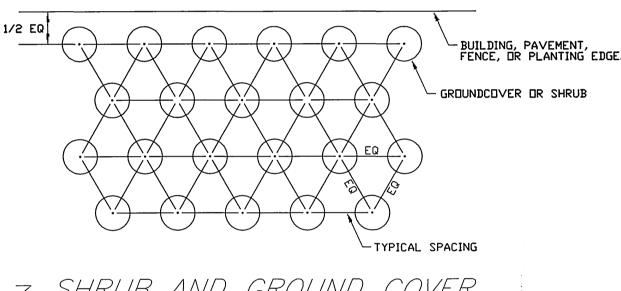



SHRUB AND GROUND COVER NO SCALE


PLACE "GROW POWER" TABS IN PLANT CONTAINER PRIOR TO PLANTING FOR OBSERVATION PURPOSES.

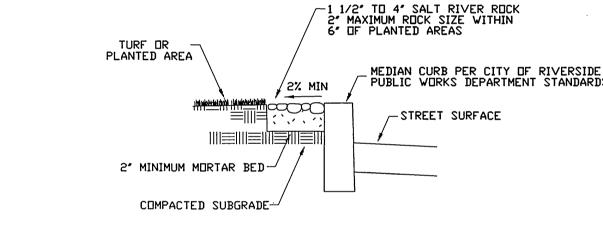



1 RIVER ROCK MEDIAN EDGING DETAIL
NO SCALE

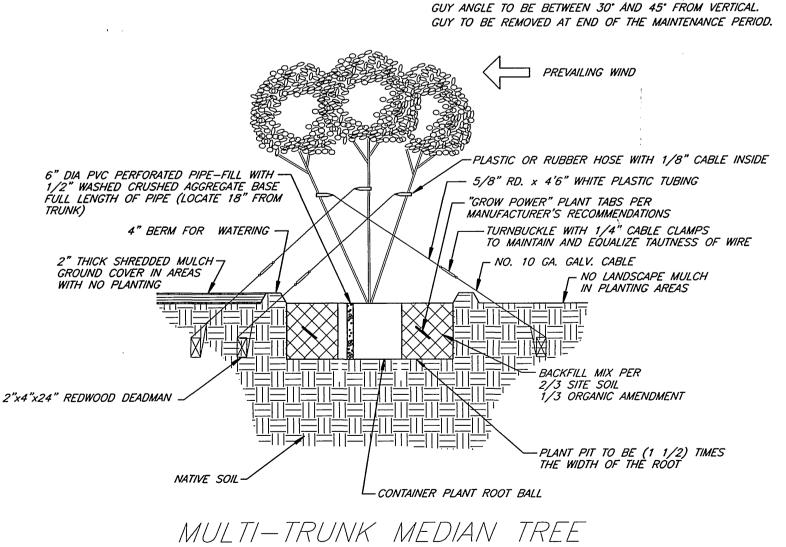

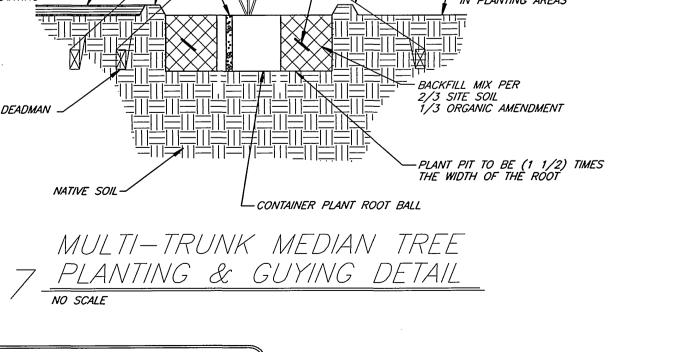

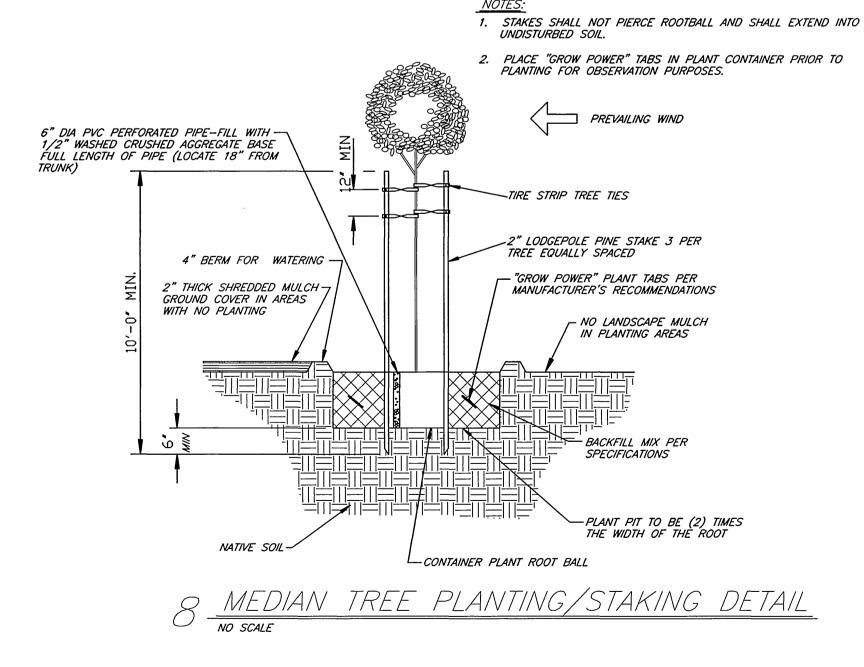


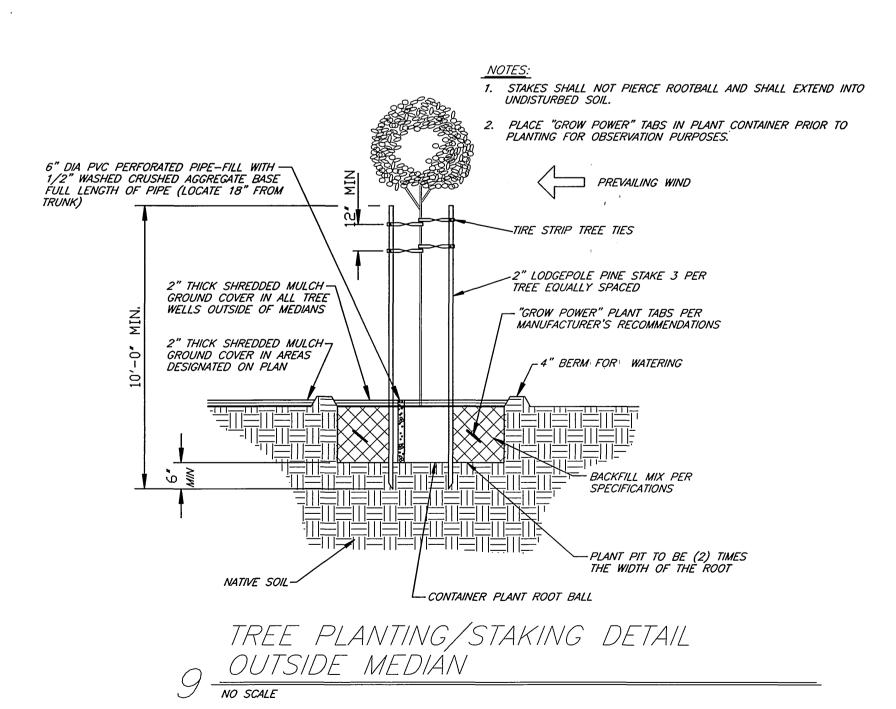


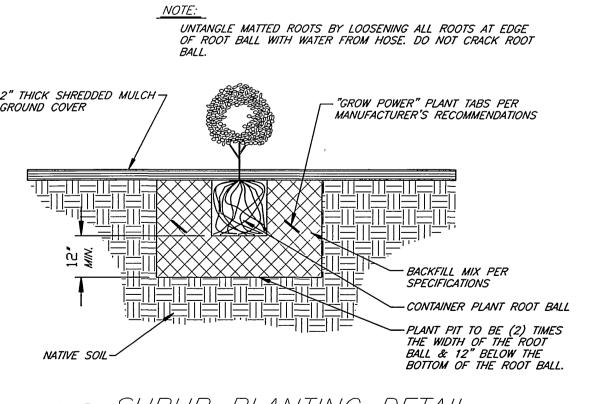


10 SHRUB PLANTING DETAIL



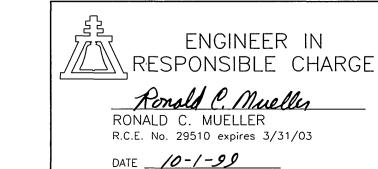

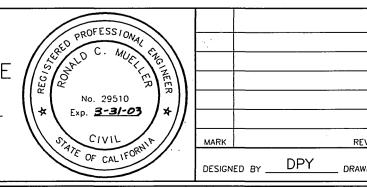

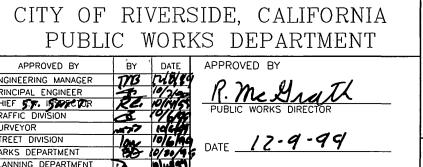

* AS-BUILT 11-10-05 4 PLANTING DETAILS - LP3

HORIZ. SCALE: 1'' = 20' VERT. SCALE: 1'' = 4'

ACCOUNT NUMBER

476-528160-440446-12127

R - 3416

SHEET 9 OF 18

THIS PLAN IS DIAGRAMMATICALLY ACCURATE FOR IRRIGATION FACILITIES ONLY. SEE STREET, HARD SCAPE, PLANTING, LIGHTING, AND SIGNAL PLANS FOR THOSE IMPROVEMENTS. ALL LOCATIONS SHOWN ARE APPROXIMATE. PRECISE LOCATIONS FOR IRRIGATION FACILITIES WILL BE ESTABLISHED IN THE FIELD BY THE ENGINEER.

Janes

ALL FACILITIES INSTALLED BY THE CONTRACTOR SHALL BE INSPECTED AND APPROVED BY THE DEPARTMENT CONSTRUCTION INSPECTOR. ANY CHANGES SHALL BE APPROVED BY THE DEPARTMENT PRIOR TO EXECUTION.

1 INSTALL 1 1/4" PVC MAIN LINE.

maniform in the state of

- ② INSTALL 3/4" PVC IRRIGATION LINE.
- ③ INSTALL 3" PVC SLEEVE UNDER HARDSCAPE AND PAVING FOR IRRIGATION LINES.
- 4 INSTALL 2" PVC SLEEVE UNDER HARDSCAPE AND PAVING FOR CONTROL WIRE.
- (5) INSTALL QUICK CONNECT COUPLERS PER DETAIL IN 1 1/4" MAIN LINE. MAXIMUM SPACING TO BE 75' BETWEEN COUPLERS.
- 6 ELECTRICAL CONNECTION FOR CONTROLLER PER DETAIL. CITY FORCES TO MAKE FINAL SERVICE CONNECTION. CONTRACTOR SHALL NOT MAKE SERVICE CONNECTION.
- 16 STATION CONTROLLER AND CABINET PER DETAIL AND SPECIFICATIONS.
- (8) INSTALL TREE WELL IRRIGATION PER DETAIL.
- MEDIAN PLANTING AREA IRRIGATION PER DETAILS AND SPECIFICATIONS. INSTALL ADDITIONAL EMITTERS AS NECESSARY TO OBTAIN COMPLETE COVERAGE.
- 10 INSTALL IRRIGATION CONTROL WIRE ADJACENT TO MAIN LINE. WIRE IS NOT SHOWN ON PLANS. SEPERATE PVC SLEEVE REQUIRED UNDER PAVING AND HARDSCAPE.
- 1 INSTALL 12" x 18" VALVE BOX PER SPECIFICATIONS.
- (2) 3/4" WATER SERVICE AND METER, INSTALLED BY CITY FORCES.


- QUICK CONNECT COUPLER IN MAIN LINE PER DETAIL. MAXIMUM 75' SPACING.
- REMOTE CONTROL VALVE PER DETAIL APPROVED BY THE DEPARTMENT PRIOR TO EXECUTION.
- 1 1/4" PVC MAIN LINE. CONTROL WIRE WHERE REQUIRED.
- = = 3" PVC SLEEVE UNDER HARDSCAPE AND PAVING FOR IRRIGATION LINES. 2" PVC UNDER HARDSCAPE AND PAVING FOR CONTROL WIRE.

——— 3/4" PVC IRRIGATION SUPPLY AND RETURN HEADERS PER DETAIL.

12.0 IRRIGATION CONTROL VALVE. STATION DESIGNATION LISTED ON TOP HALF. VALVE SIZE LISTED ON BOTTOM HALF. FLOWRATE LISTED AT RIGHT. P# INDICATES PARKWAY VALVE NUMBER.
T# INDICATES TURF AREA VALVE NUMBER S# INDICATES SHRUB AREA VALVE NUMBER..


IRRIGATION LEGEND							
SYMBOL	DESCRIPTION	DETAIL	REMARKS	SYMBOL	DESCRIPTION		REMARKS
•	GRISWOLD 2000 REMOTE CONTROL VALVE - SIZE PER PLAN		SIZE PER PLAN		RAINBIRD 1402 BUBBLER	0.50 GPM	FLOOD BUBBLER, 2 PER TREE
•	TORO PRV15025 PRESSURE REGULATOR 7-40 GPM - 25 PSI		SIZE PER PLAN	1 1	PANDIRD T-12-FC-T30-1.3 ROTOR SPRINKLER	22'R 1.20 GPM	FULL CIRCLE
▶◀	NIBCO 7-580 BALL VALVE		LINE STRED	1 14	RAINBURD T-12-C-130-1.3 ROTOR SPRINKLER		
A	RAINBIRD RCM-12B CONTROLLER (12 STATION)				RAINBIRG I 2-PC-T30-1.3 ROTOR SPRINKLER	22'R 1.20 GPM	PART CIRCLE, ADJUSTED TO 90°
•	RAINBIRD 44LRC 1" QUICK COUPLER			11 41	RAINBIRD 1812-MPR-10F-LA SPRAY SPRINKLER	8'R 1.44 GPM	
	PRESSURE MAINLINE PVC SCH 40 - SIZE PER PLAN		SZA PAR PAM	112	RAINBIRD 1812-MPR-10H-LA SPRAY SPRINKLER	8'R 0.72 GPM	
	NON-PRESSURE LATERAL LINE PVC CL200	7	SIZA REPLAN	Ф	RAINBIRD 1812-MPR-10Q-LA SPRAY SPRINKLER	8'R 0.36 GPM	
= =	PVC PIPE & WIRE SLEEVE - SIZE PER PLAN OR 2X PIPE DIA	1) L		0	RAINBIRD 1812-MPR-12F SPRAY SPRINKLER	12'R 2.60 GPM	
NOT SHOWN	UF DIRECT BURIAL CONTROL WIRE, SOLID COPPER		SIZE PER PLAN		RAINBIRD 1812-MPR-12H SPRAY SPRINKLER	12'R 1.30 GPM	
\blacksquare	FEBCO 825Y R.P. BACKFLOW PREVENTER W/WILKENS 500 YBSR PRESSURE REGULATOR/STRAINER		SIZE PER PLAN	7	RAINBIRD 1812-MPR-12Q SPRAY SPRINKLER	12'R 0.65 GPM	

THIS IRRIGATION PLAN IS CONCEPTUAL IN NATURE. CONTRACTOR SHALL PREPARE SIGNED AND STAMPED CONSTRUCTION PLANS BY QUALIFIED PERSONNEL FOR SUBMITTAL TO THE CITY FOR APPROVAL. SEE SPECIAL PROVISIONS FOR ADDITIONAL INFORMATION

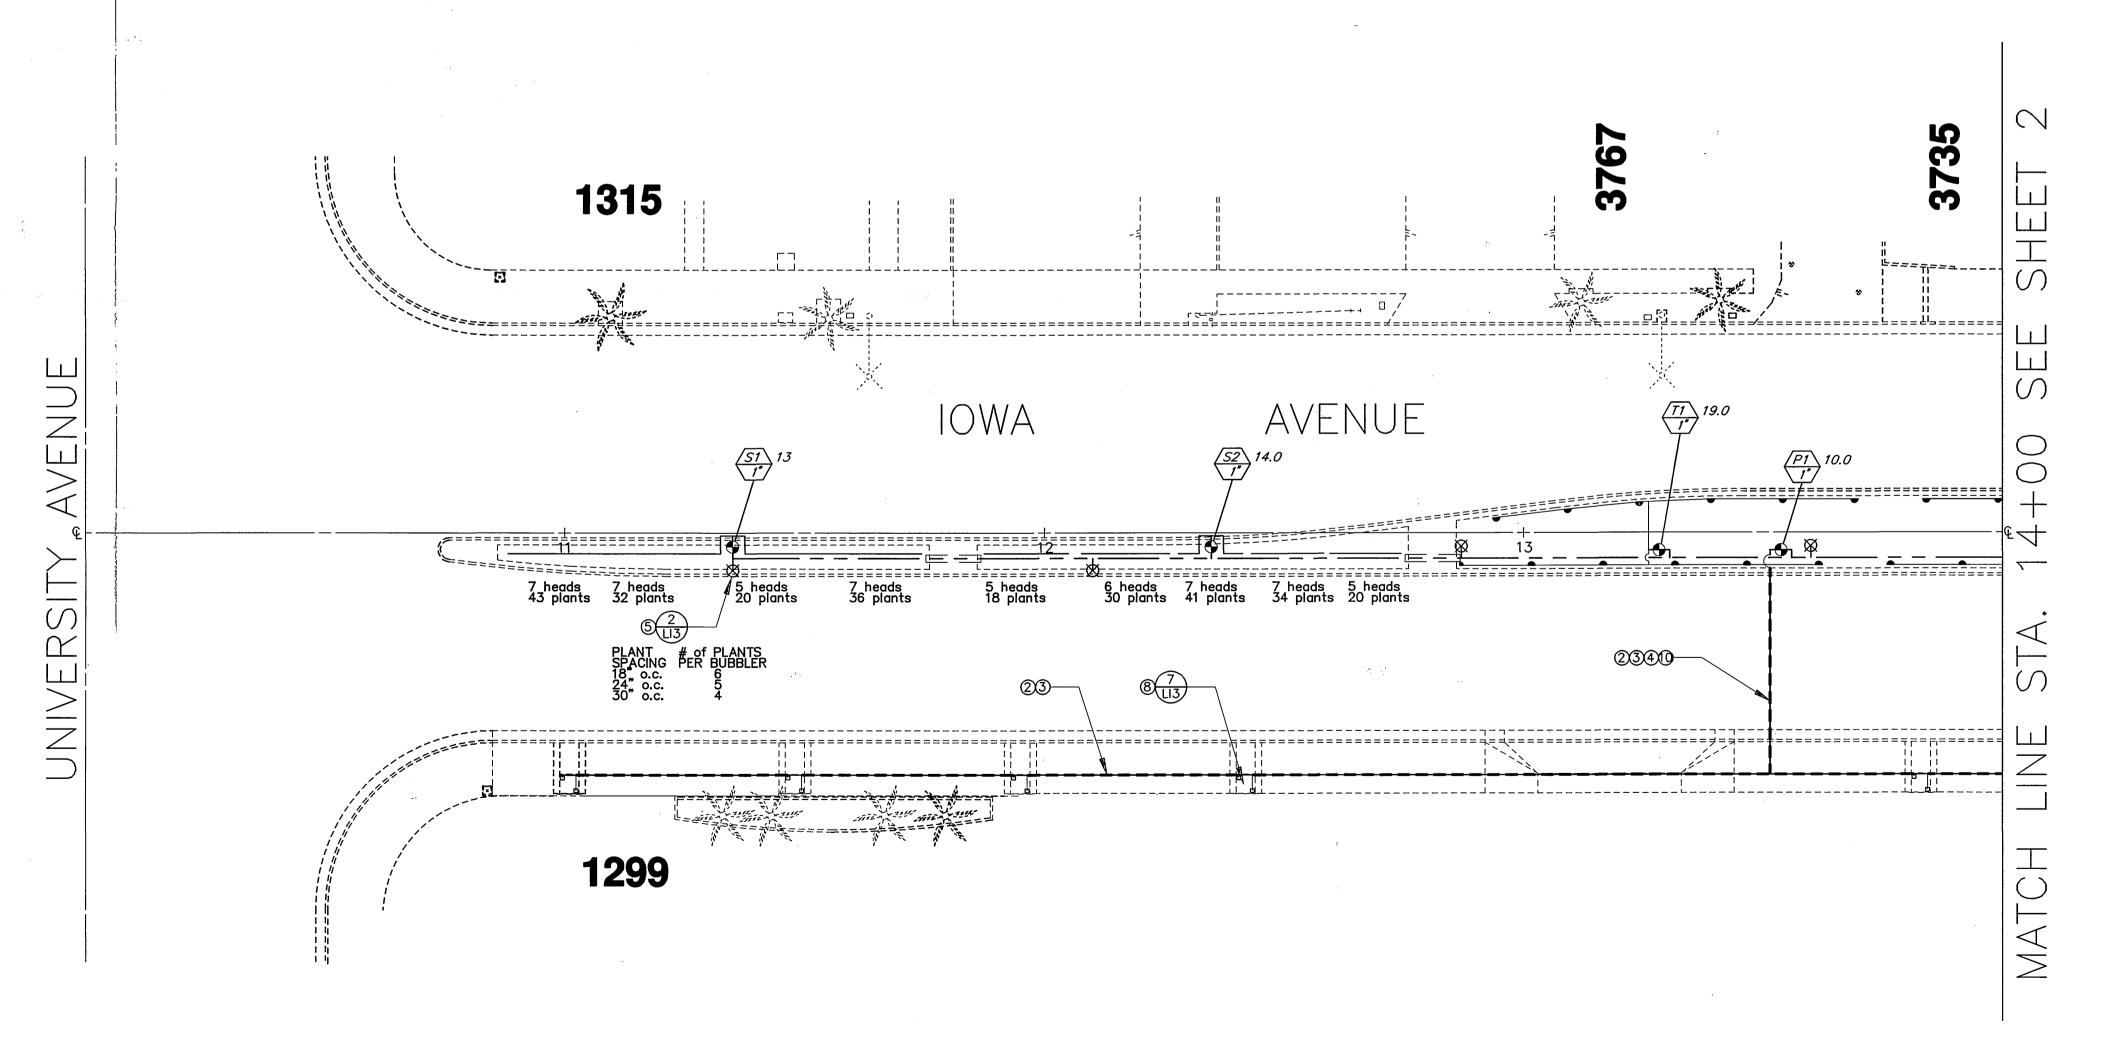

<u>IMPORTANT NOTICE</u> CALL TOLL FREE 48 HOURS BEFORE YOU DIG UNDERGROUND SERVICE ALERT 1-800-227-2600

ENGINEER IN RESPONSIBLE CHARGE RONALD C. MUELLER R.C.E. No. 29510 expires 3/31/03

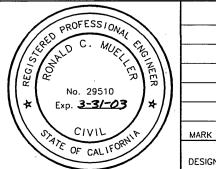

CITY OF RIVERSIDE, CALIFORNIA PUBLIC WORKS DEPARTMENT


* AS-BUILT 11-10-05 4H FROM UNIVERSITY AVE. TO LINDEN ST.


IRRIGATION PLAN - LI1 SHEET 10 OF 18

HORIZ. SCALE: 1" = 20'


ACCOUNT NUMBER 476-528160-440446-12127 R - 3416


INDEXED 11-30-2000 4H

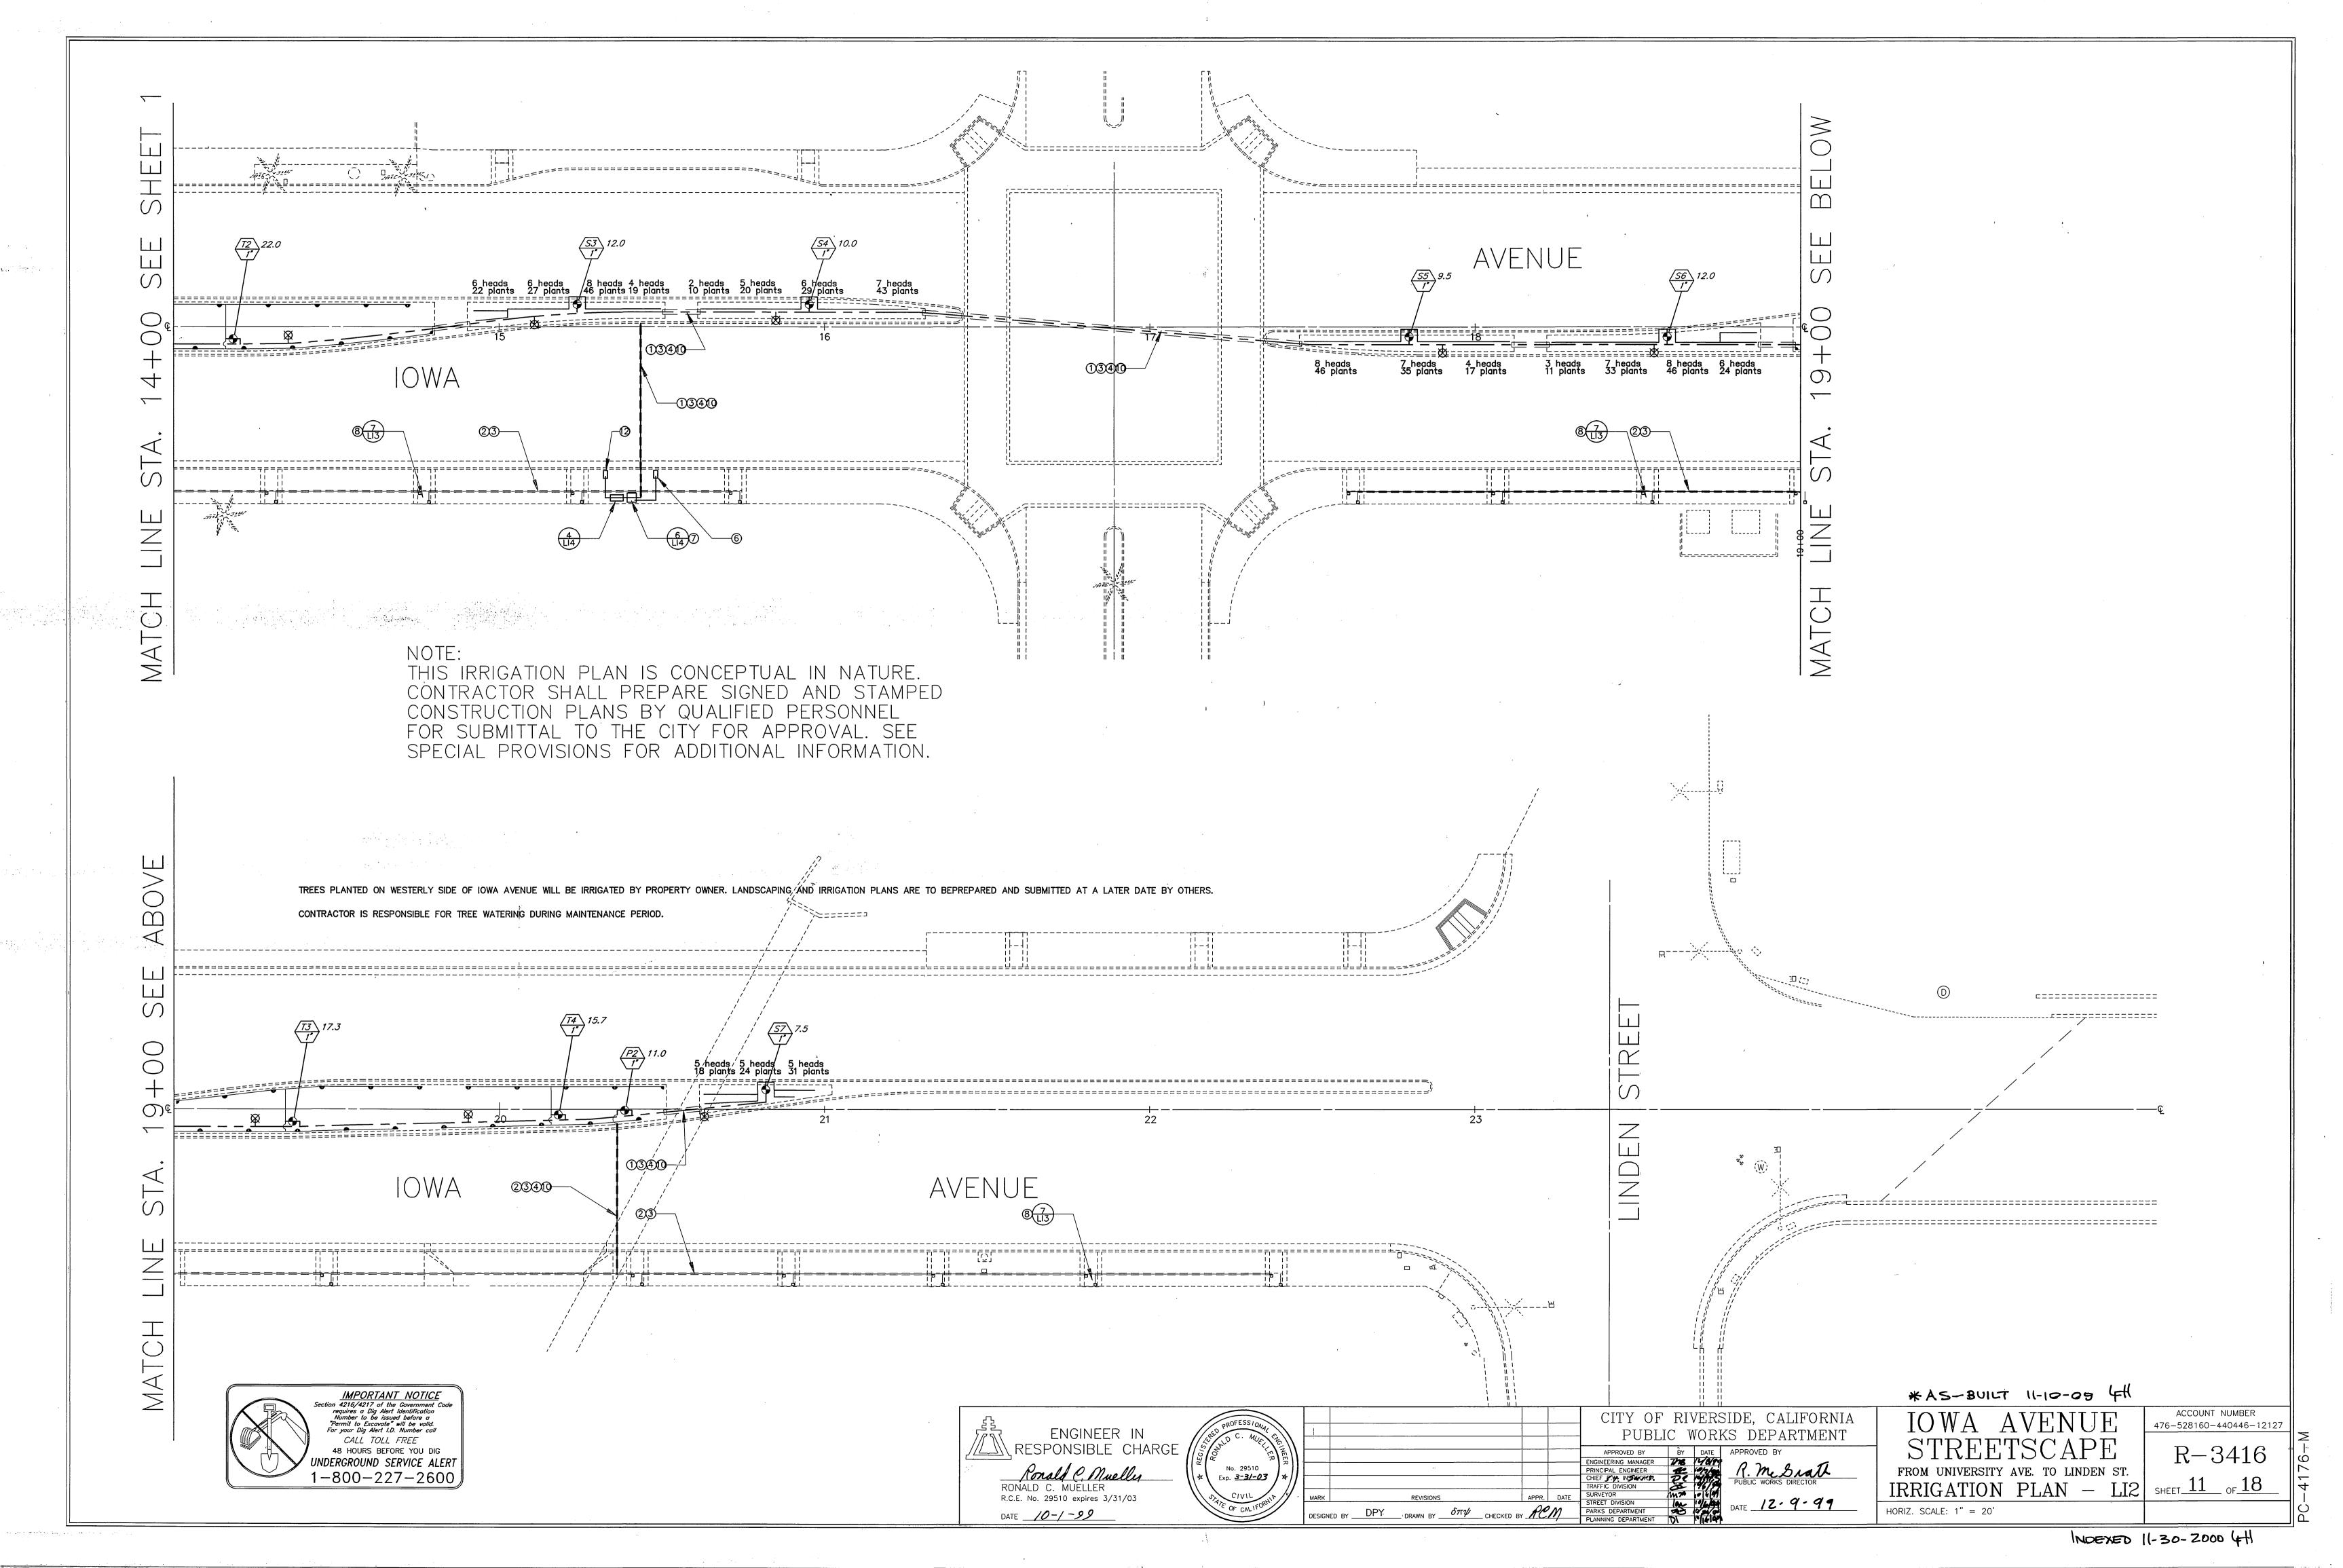

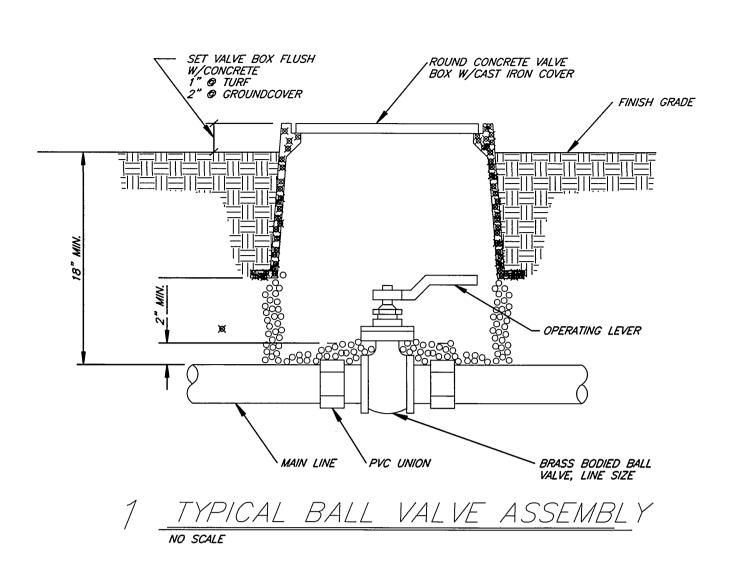

And the second s

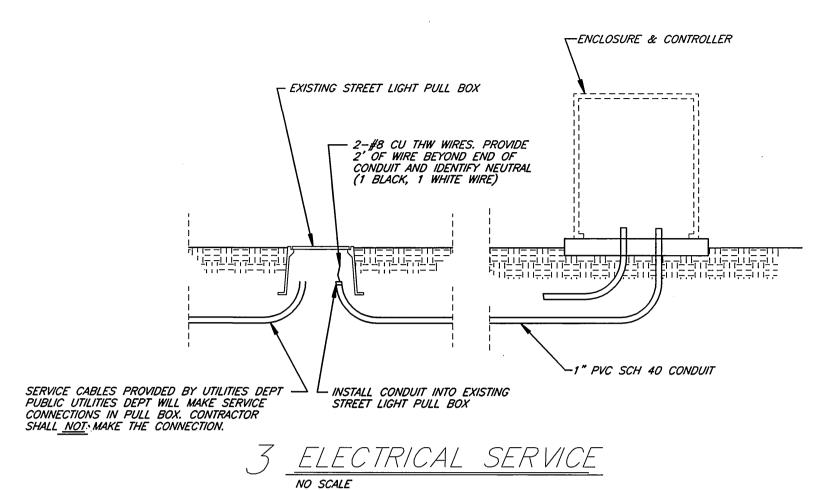


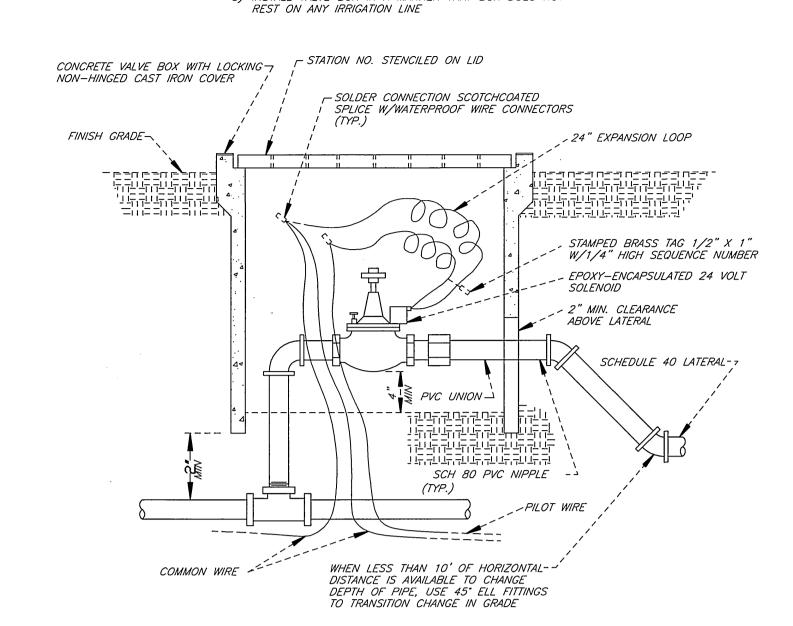

1) EACH VALVE SHALL HAVE ITS OWN TEE OR ELL CONNECTION


2) PROVIDE MINIMUM 3' CLEAR DISTANCE BETWEEN VALVES 3) INSTALL VALVE BOX IN A MANNER THAT BOX DOES NOT


TO THE MAINLINE. NO MANIFOLD CONNECTIONS

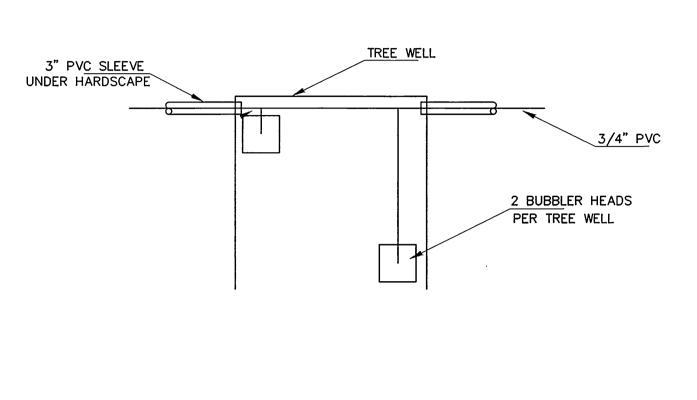

5 TYPICAL AUTOMATIC VALVE

5 TYPICAL TREE WELL IRRIGATION

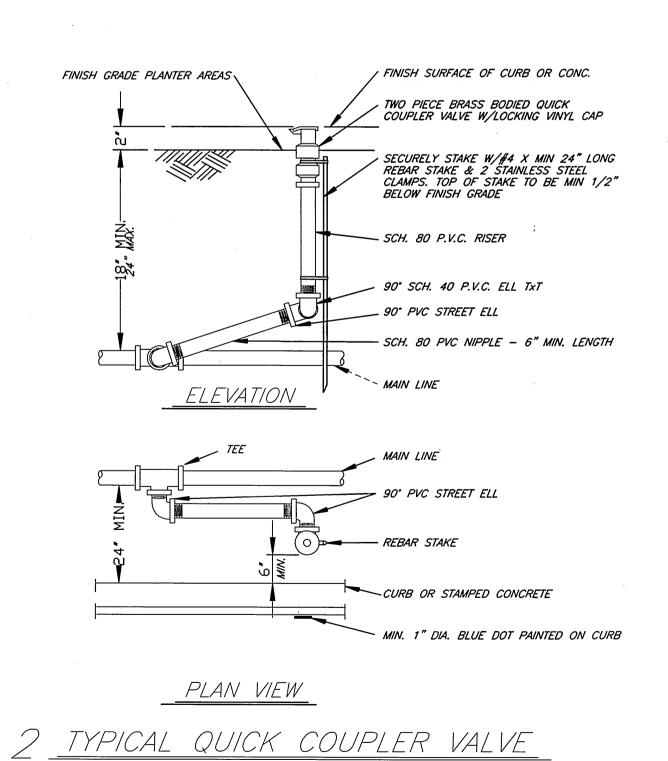

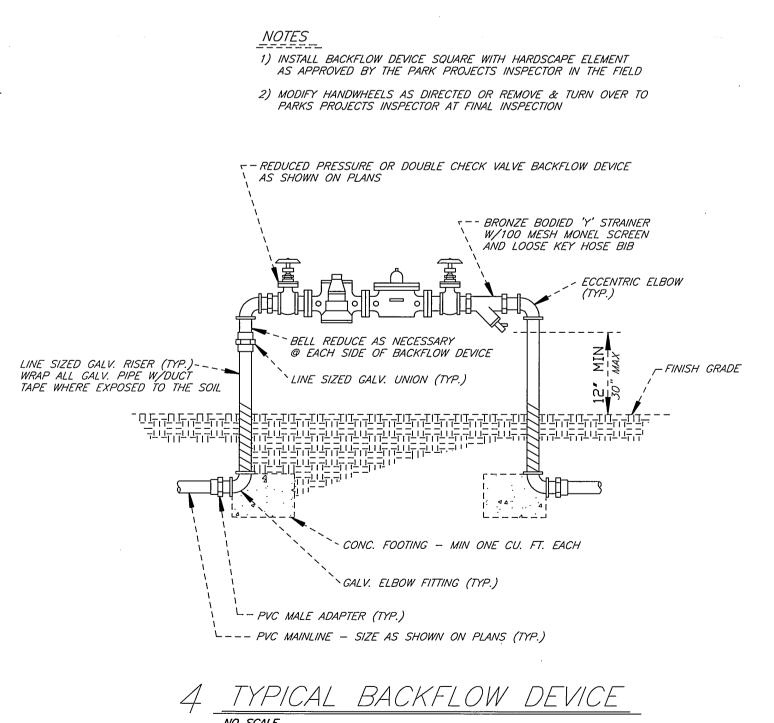

ENGINEER IN


RESPONSIBLE CHARGE


_{Ехр.} 3-3/-03

Ronald C. Mueller

RONALD C. MUELLER R.C.E. No. 29510 expires 3/31/03

10-1-99

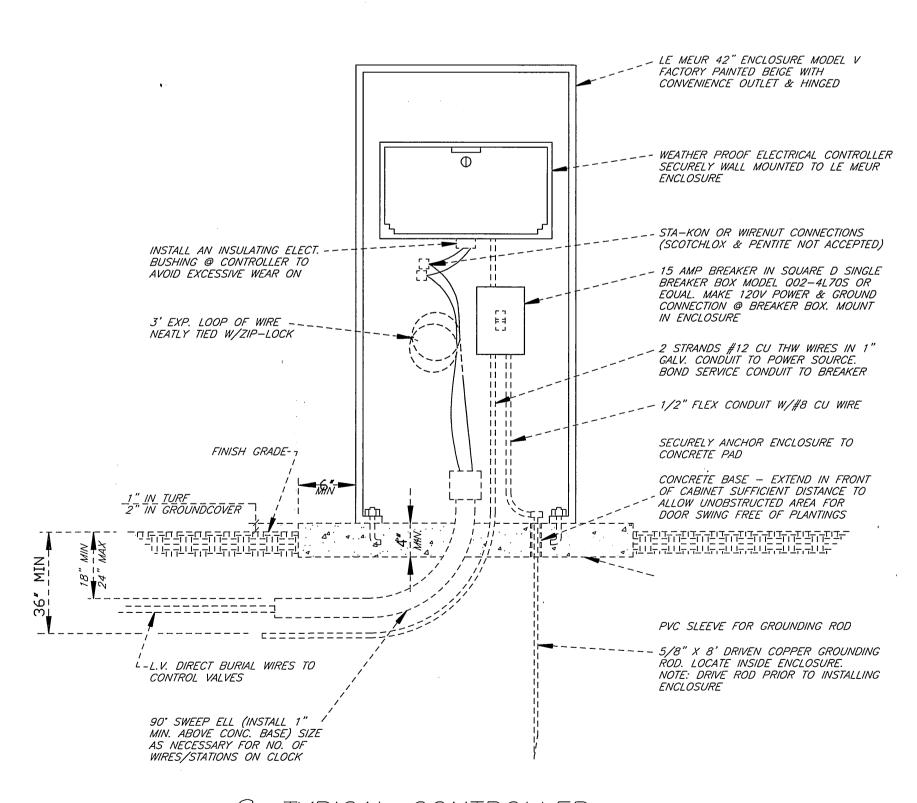


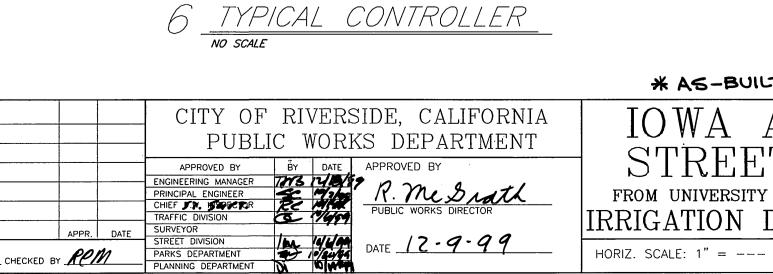



* AS-BUILT 11-10-05 4H FROM UNIVERSITY AVE. TO LINDEN ST.

ACCOUNT NUMBER 476-528160-440446-12127 R - 3416IRRIGATION DETAILS - LI4 SHEET 12 OF 18


INDEXED 11-30-2000 4H

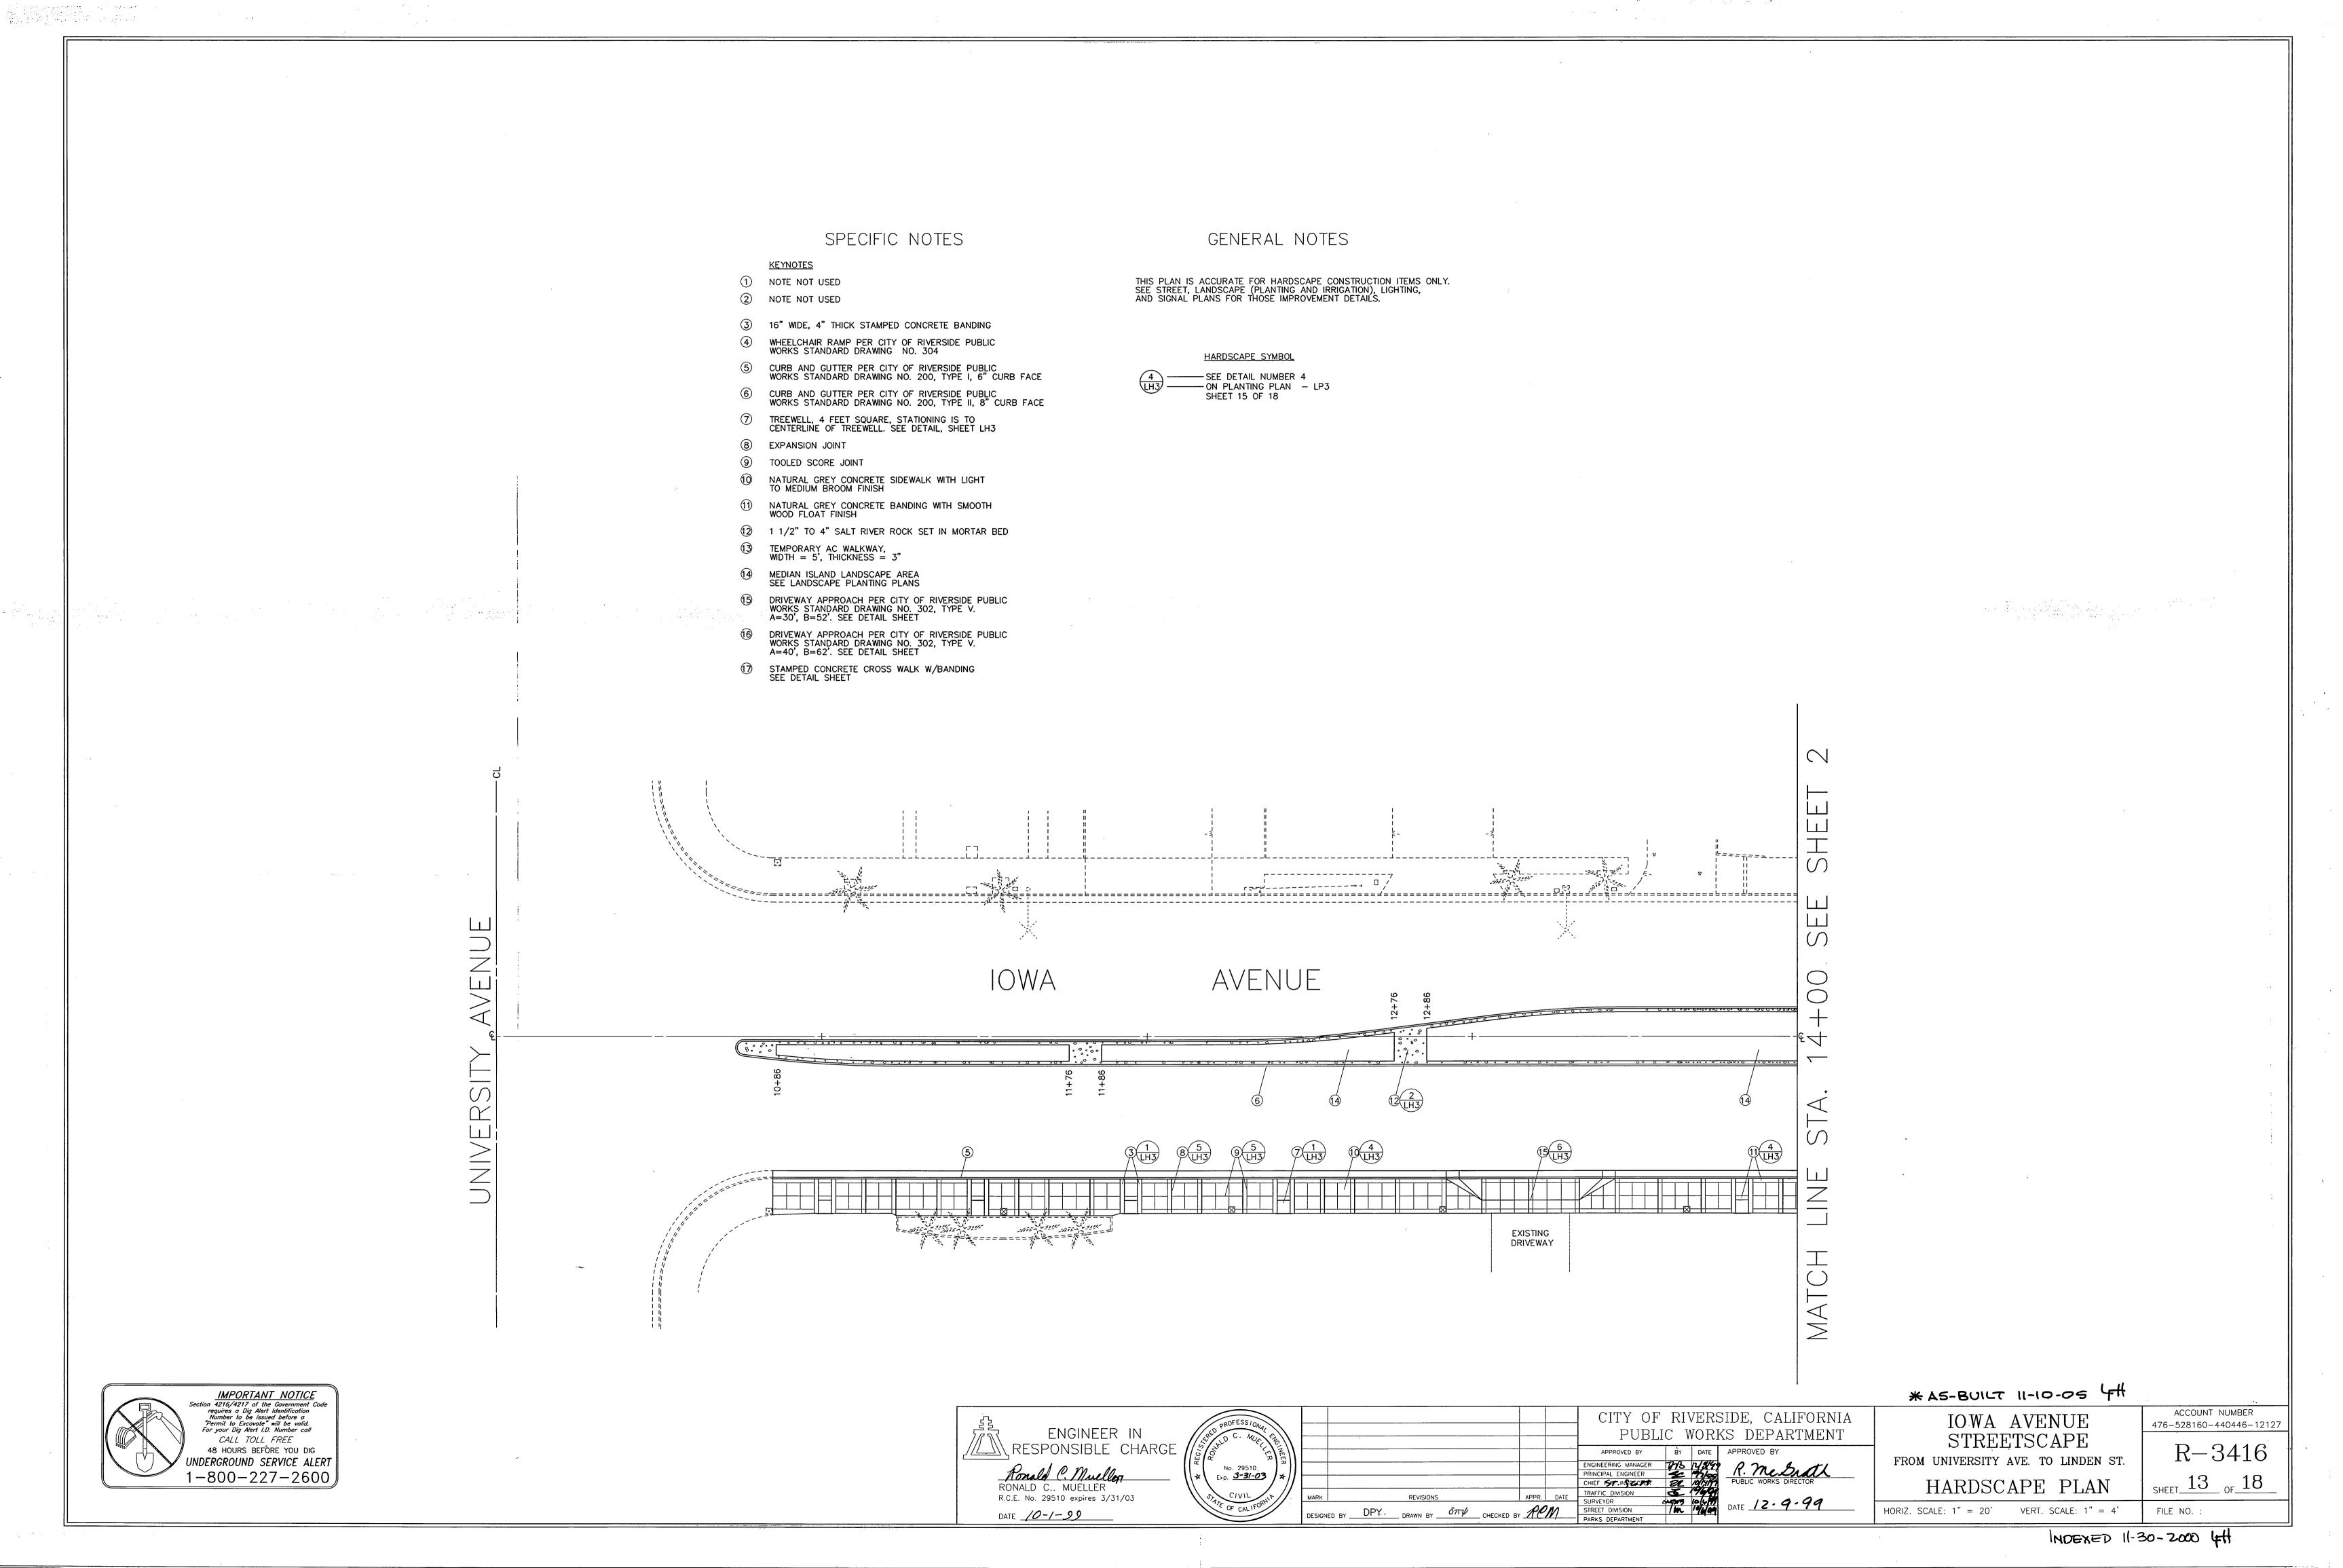


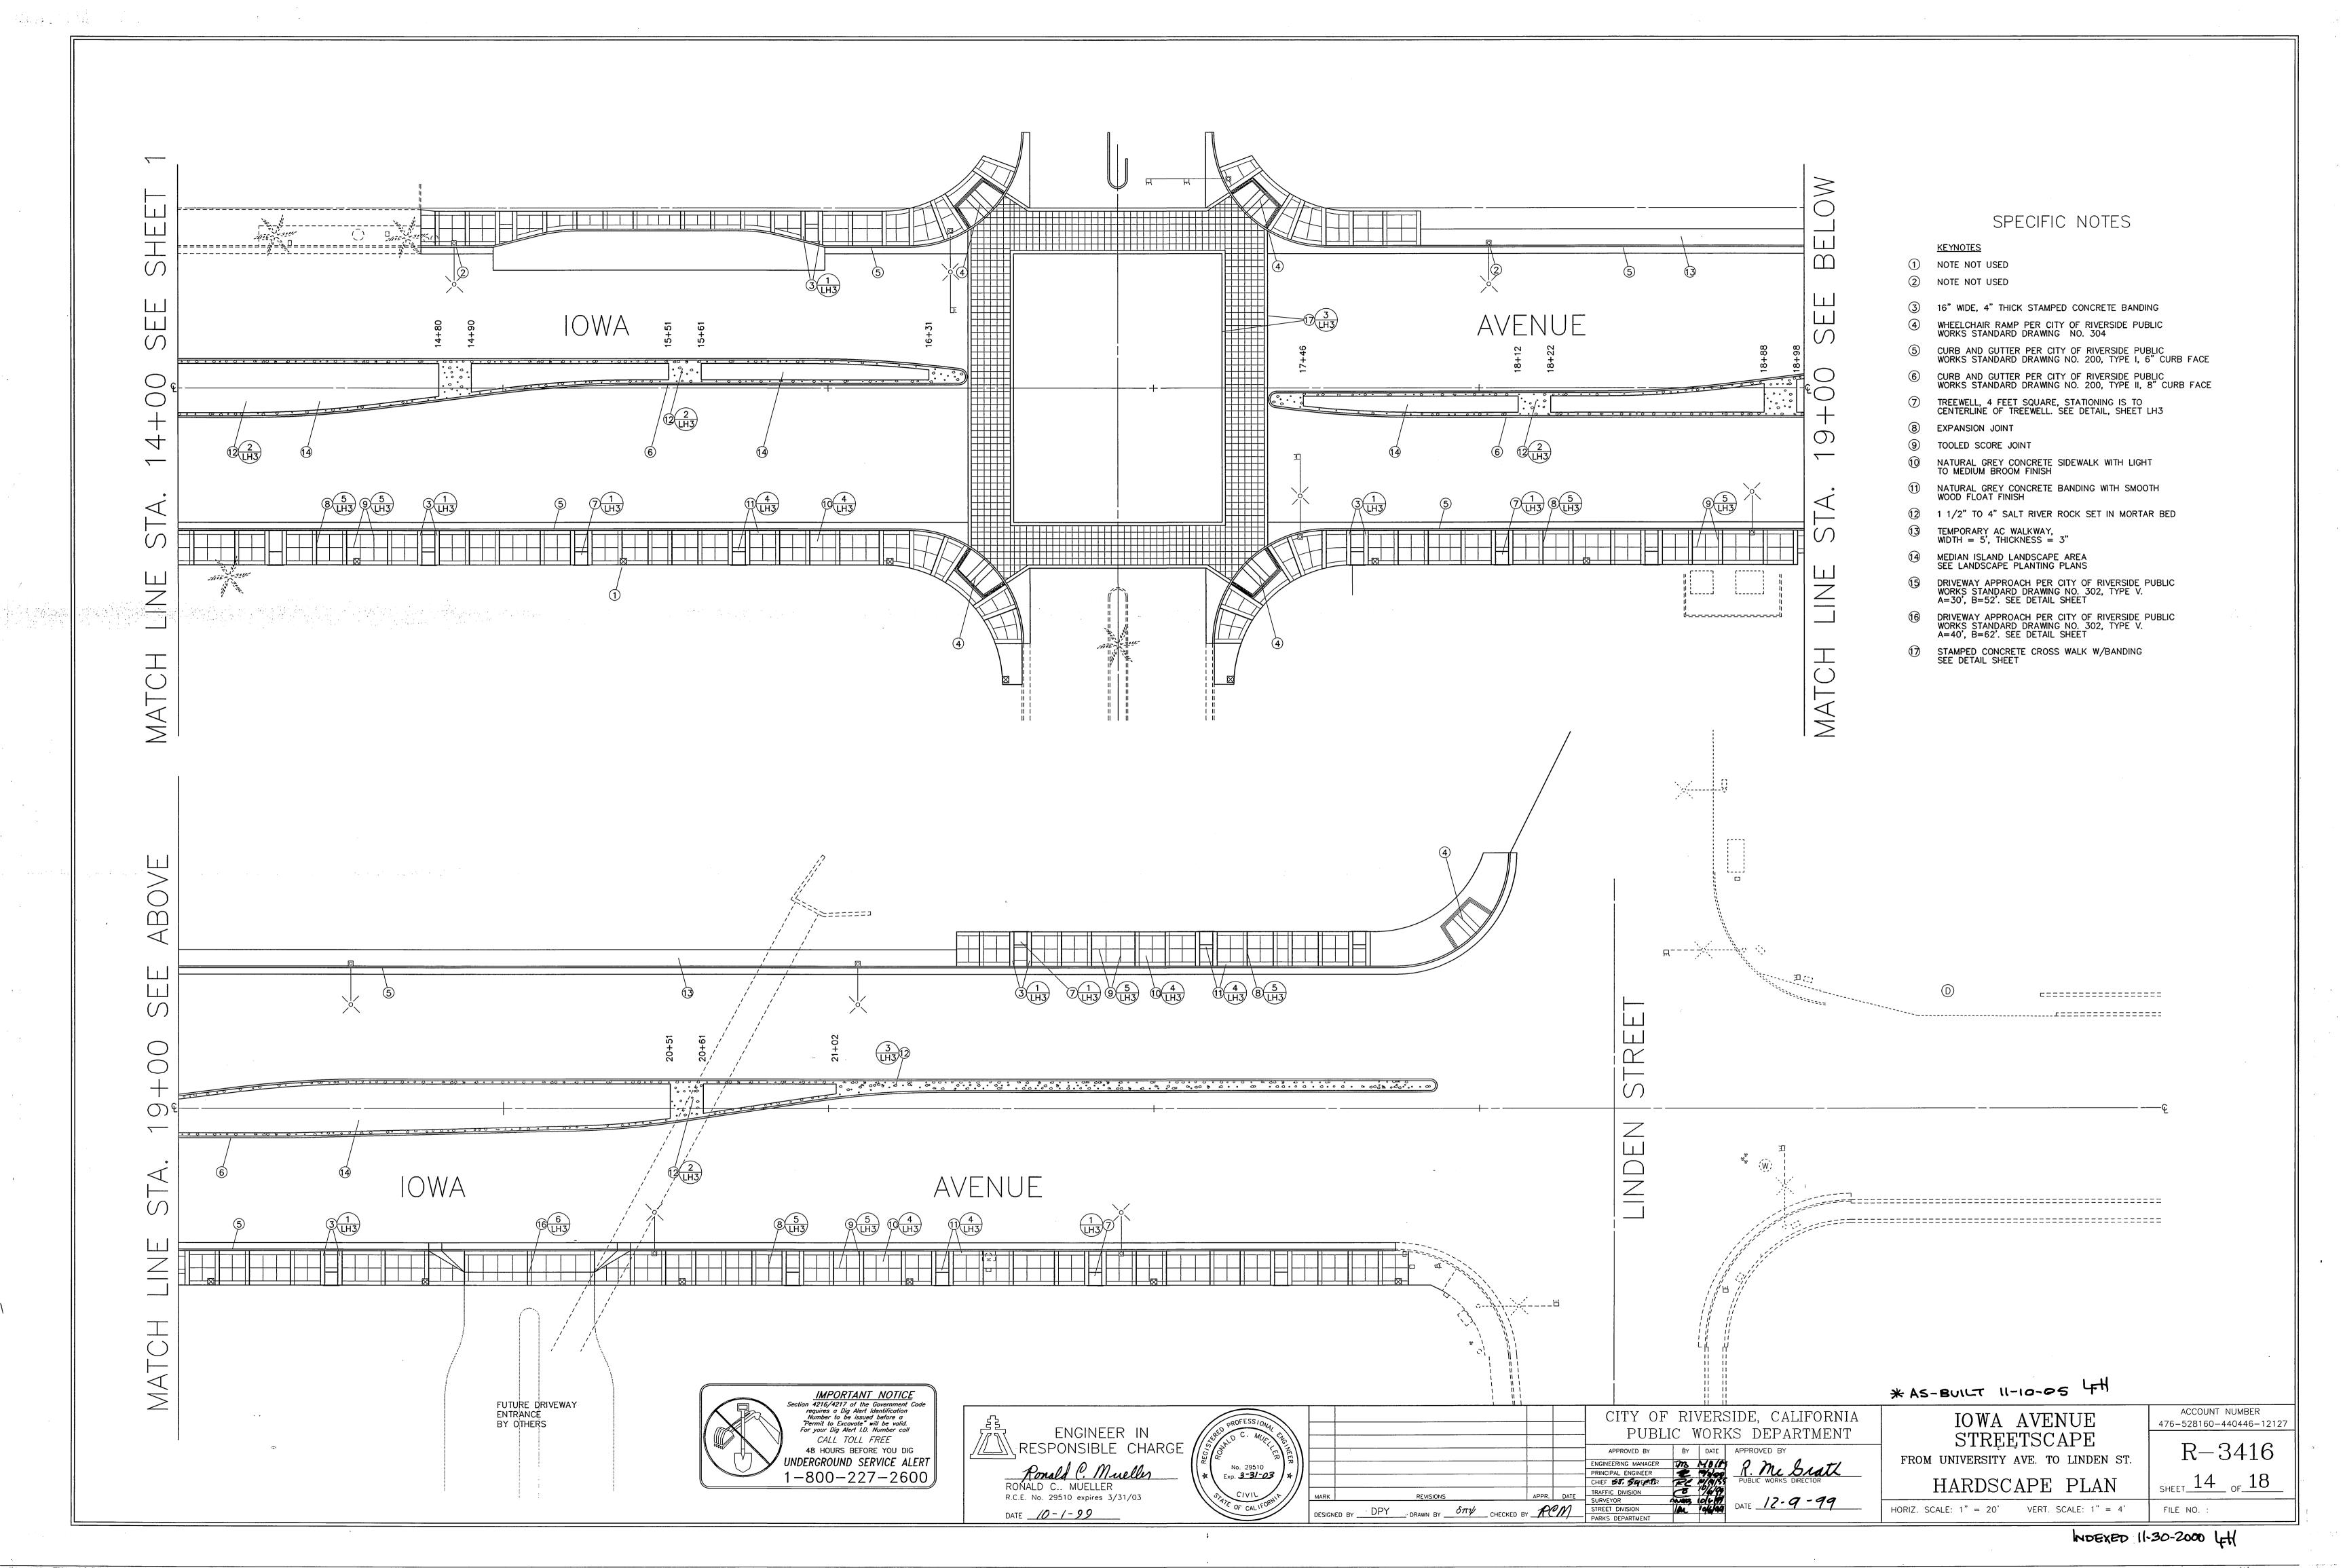

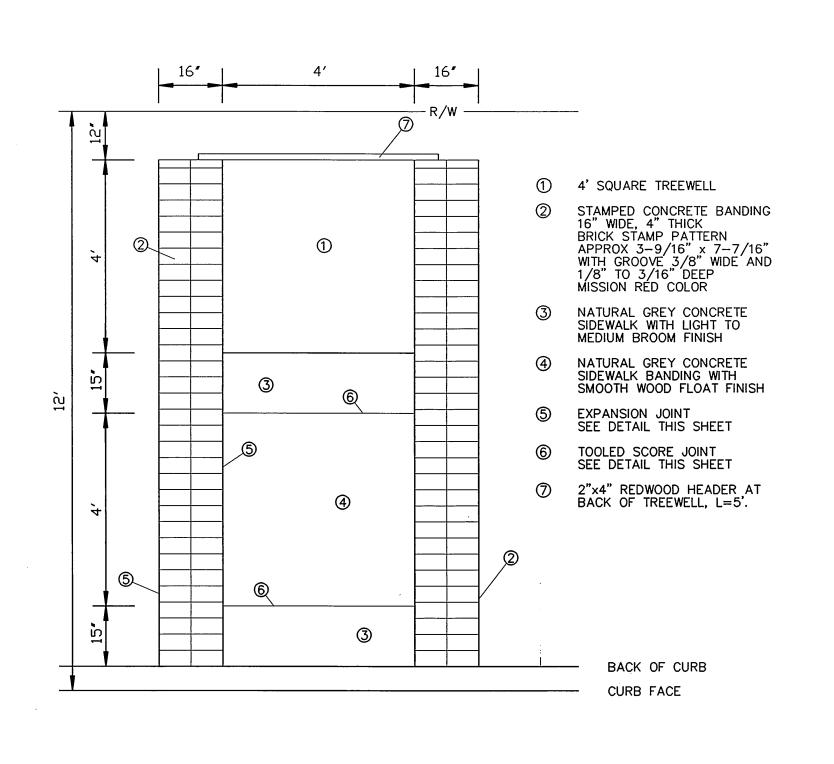


TREEWELL WITH CONCRETE BANDING

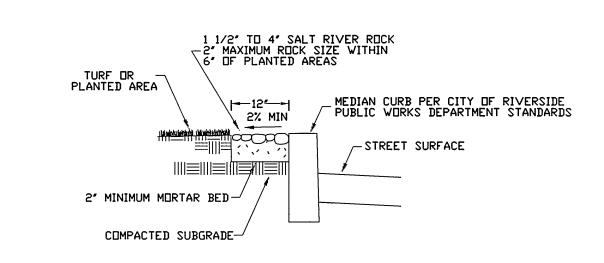


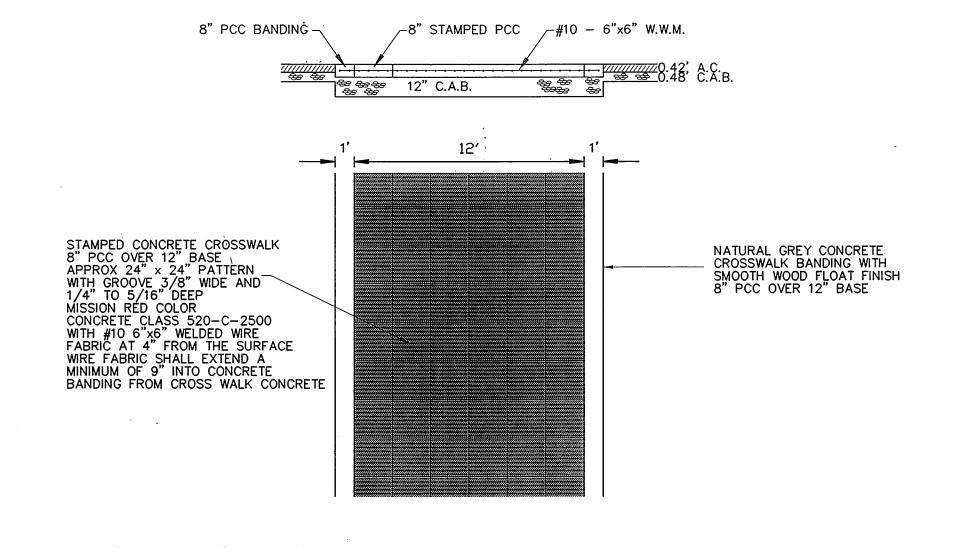


2 RIVER ROCK MEDIAN EDGING DETAIL

3 STAMPED CONCRETE CROSS WALK W/BANDING

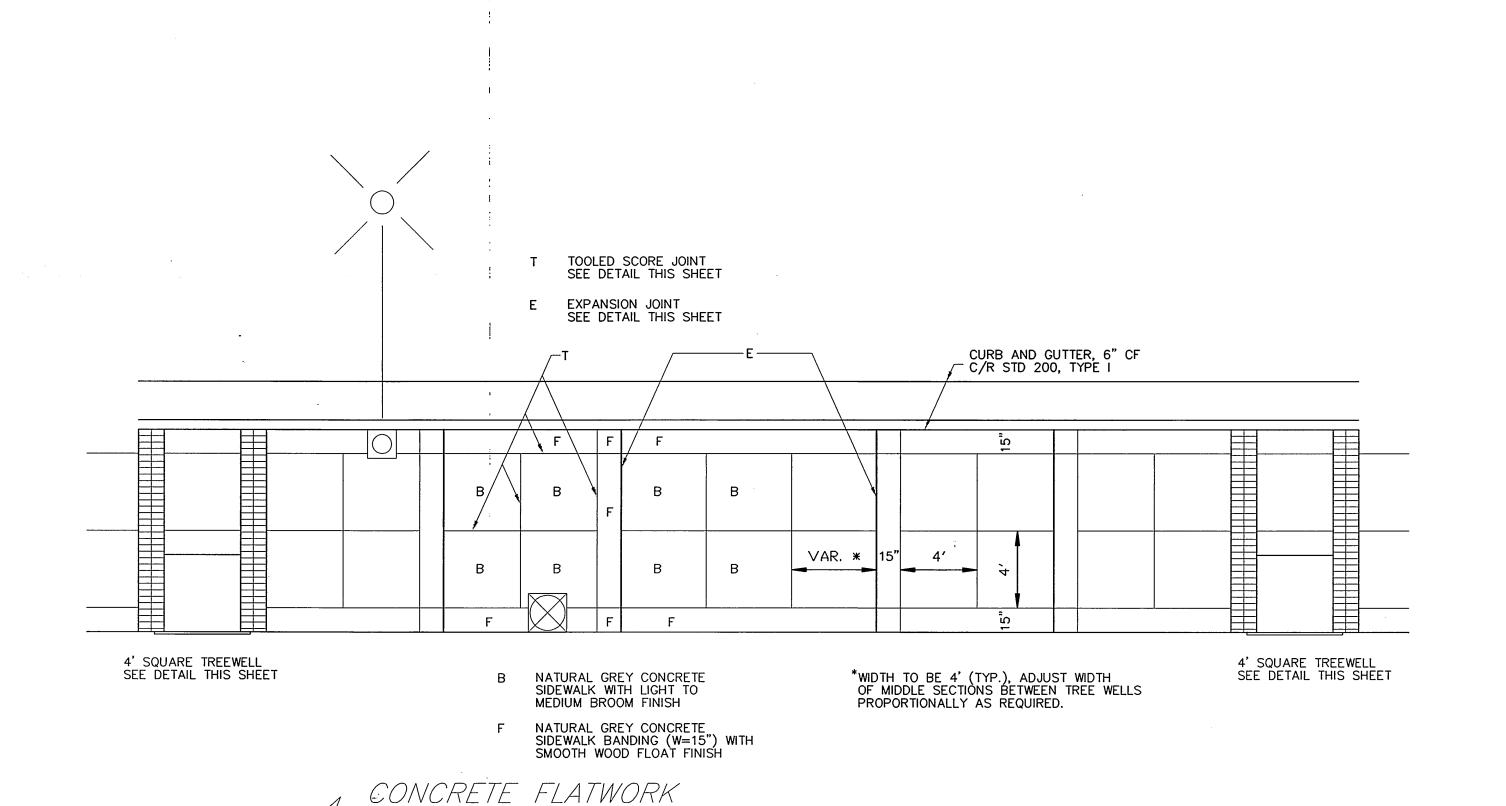

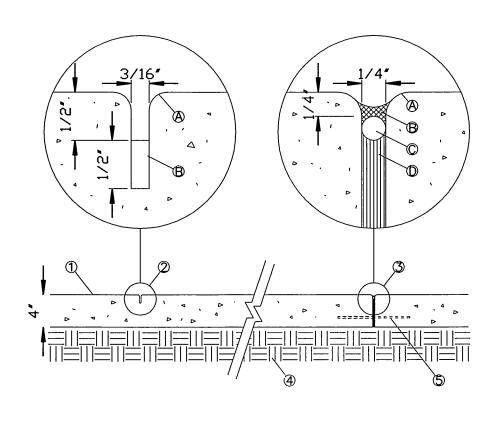


① CONCRETE PAVING, COLOR, SCORING/JOINT PATTERN AND FINISH PER SITE PLAN, DETAILS HEREON.
② SCORE JOINT
A. 3/16" TOOLED RADIUS
B. 1" DEEP SAWCUT — CUT TO BE MADE WITHIN 24 HOURS OF POUR
③ EXPANSION JOINT
A. 1/4" TOOLED RADIUS
B. CAULKING, COLOR TO MATCH NATURAL GREY CONCRETE PAVING. SUBMIT COLOR SAMPLES PRIOR TO INSTALLATION. CONTRACTOR TO SWEEP SAND INTO ALL CAULK JOINTS WHILE CAULKING IS STILL PLIABLE. SAND TO BE APPROVED BY ENGINEER.
C. BACKER ROD.
D. 1/4" FELT EXPANSION FIBER BOARD
④ COMPACTED SUBGRADE
⑤ 18" STEEL DOWEL @ 30" O.C. SLEEVE ONE END.

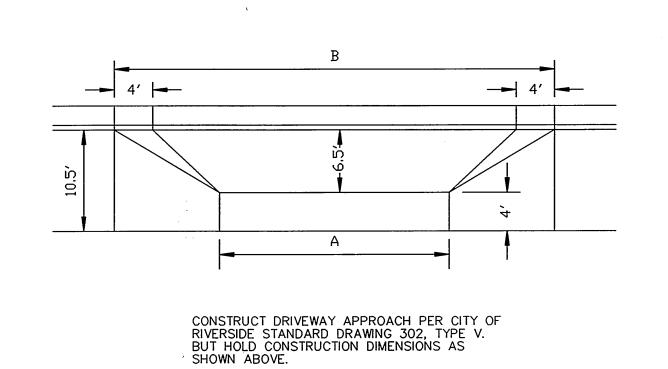

6 DRIVEWAY APPROACH



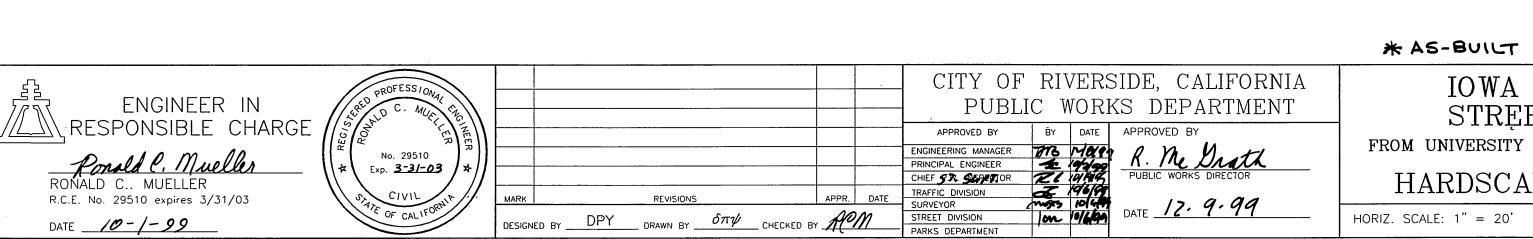

IOWA AVENUE
STREETSCAPE
FROM UNIVERSITY AVE. TO LINDEN ST.
HARDSCAPE DETAILS

**AS-BUILT 11-10-05 FH

ACCOUNT NUMBER 476-528160-440446-12127

**ROUNT NUMBER 476-528160-44046-12127

**ROUNT NUMBER 476-528160-44046-12127


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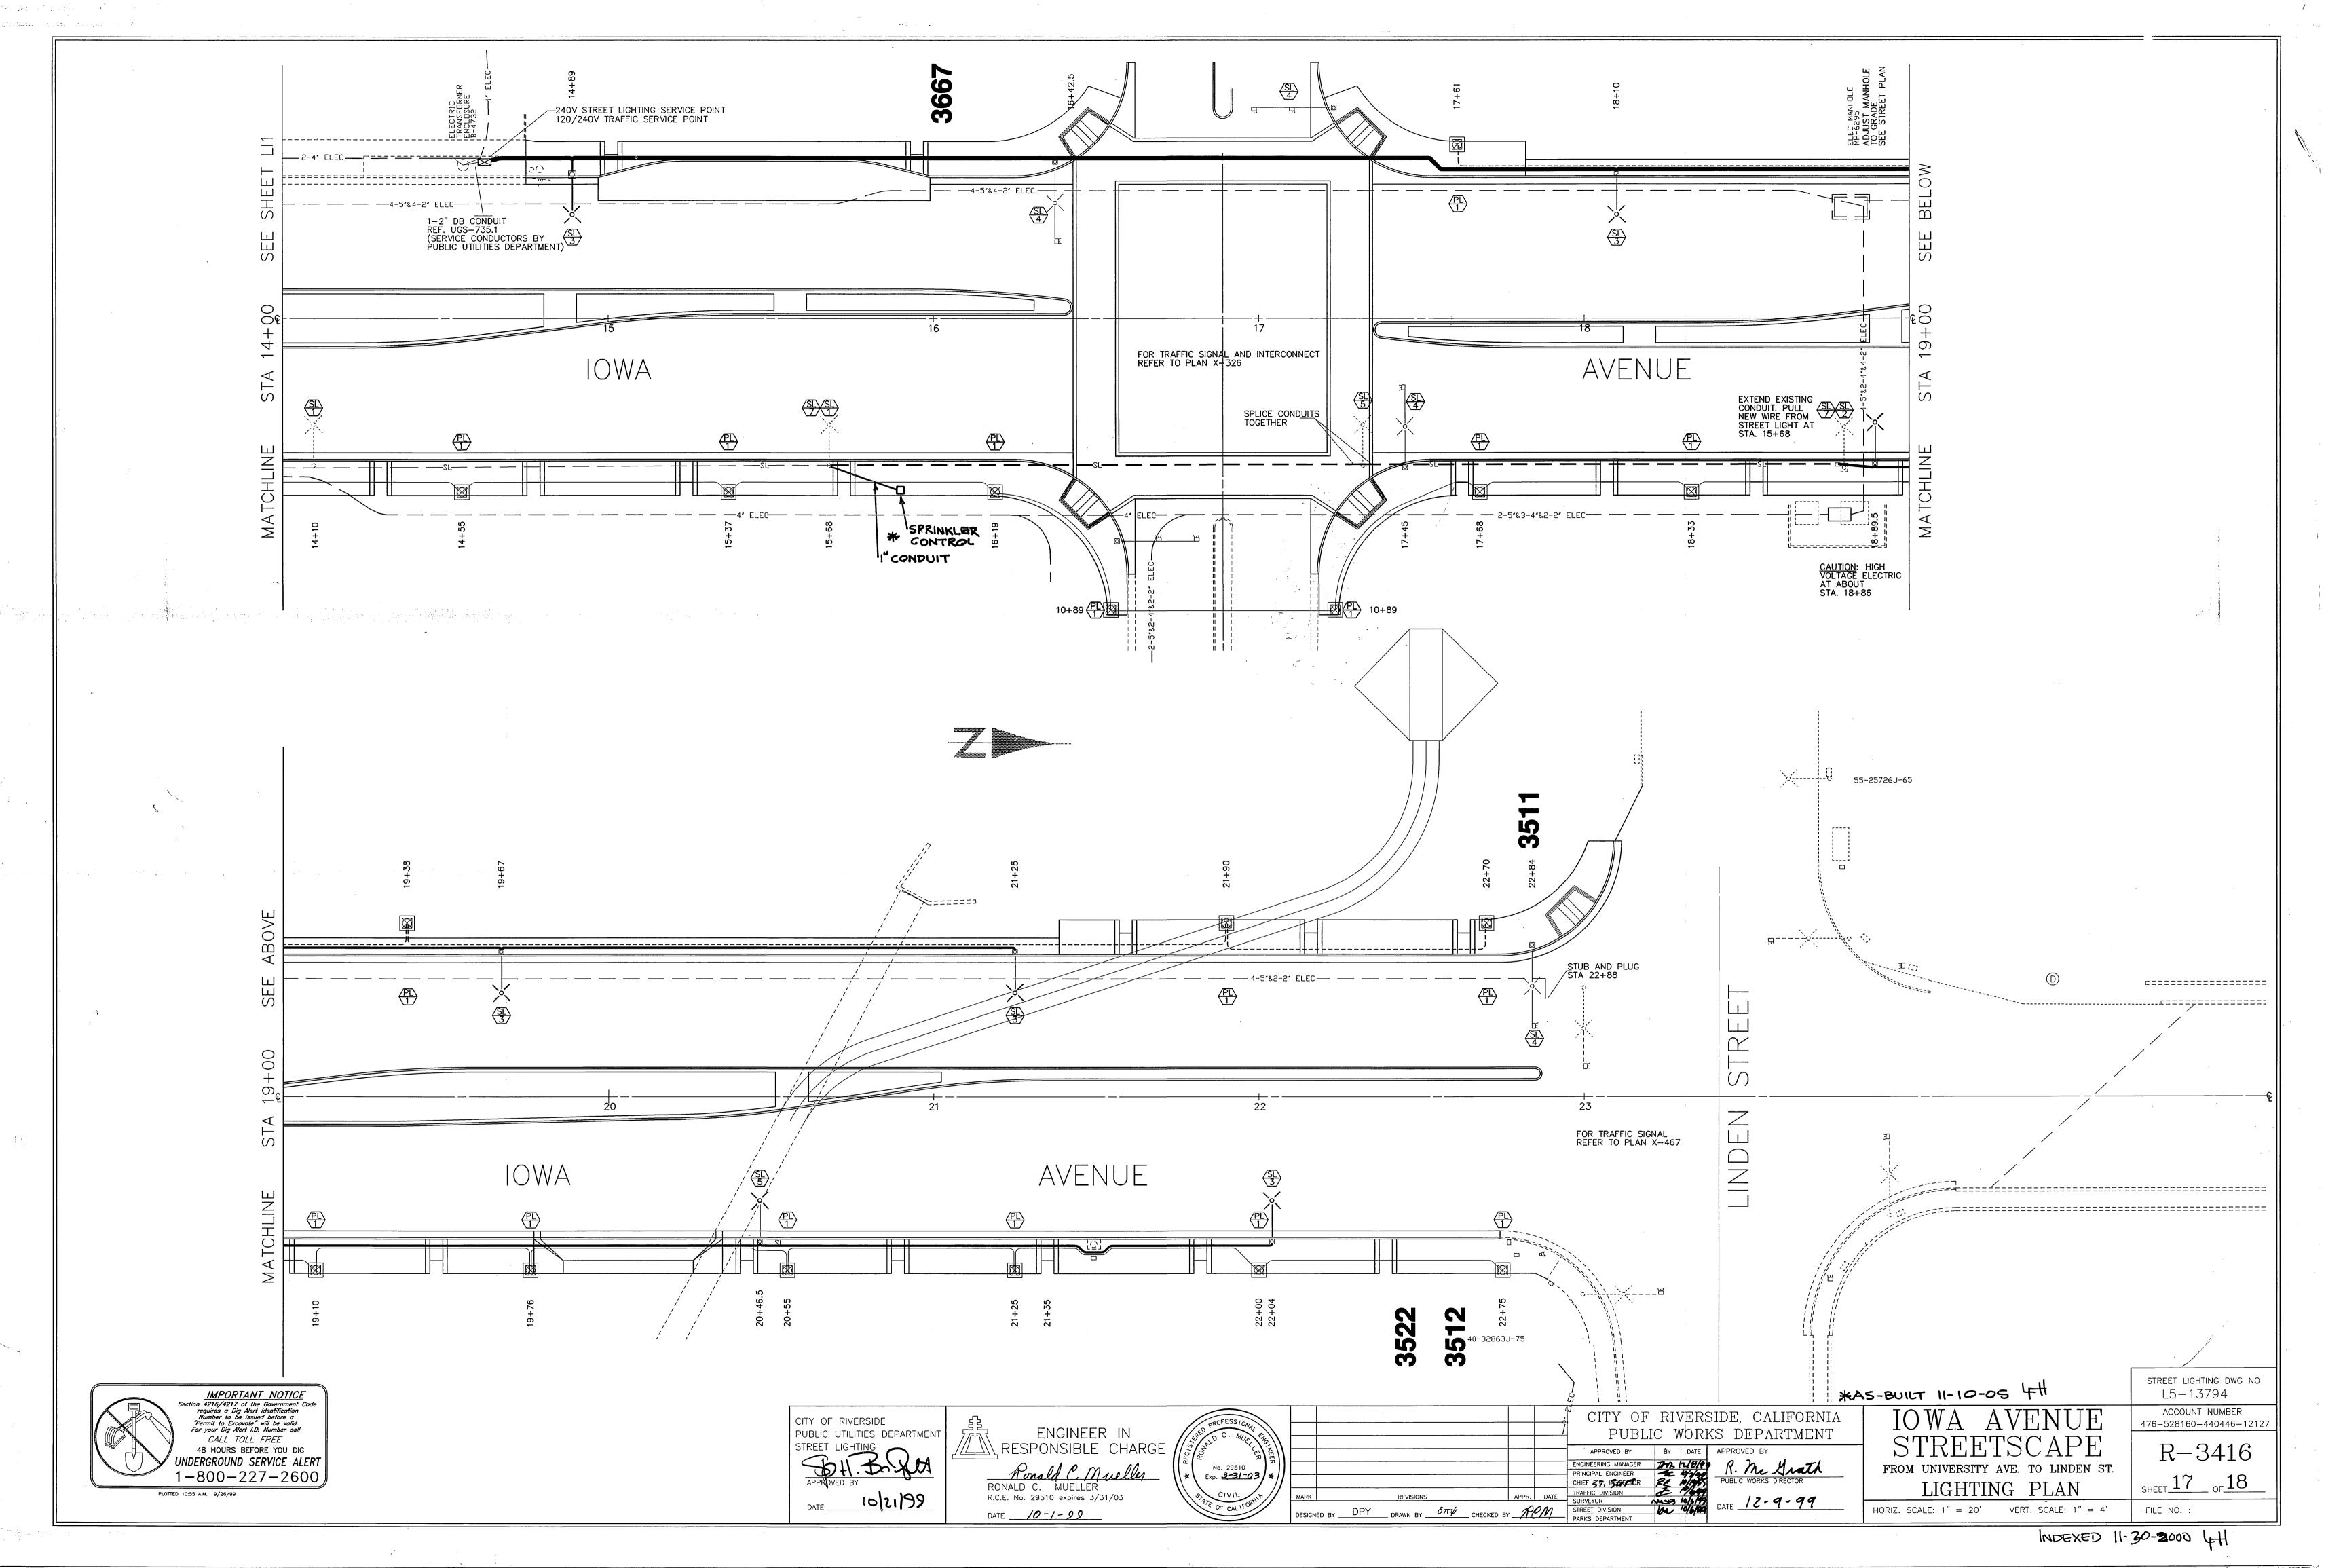
**ROUNT NUMBER 476-528160-44046-12127


**ROUNT NUMBER 476-528160-4406-12127

VERT. SCALE: 1'' = 4'

FILE NO.



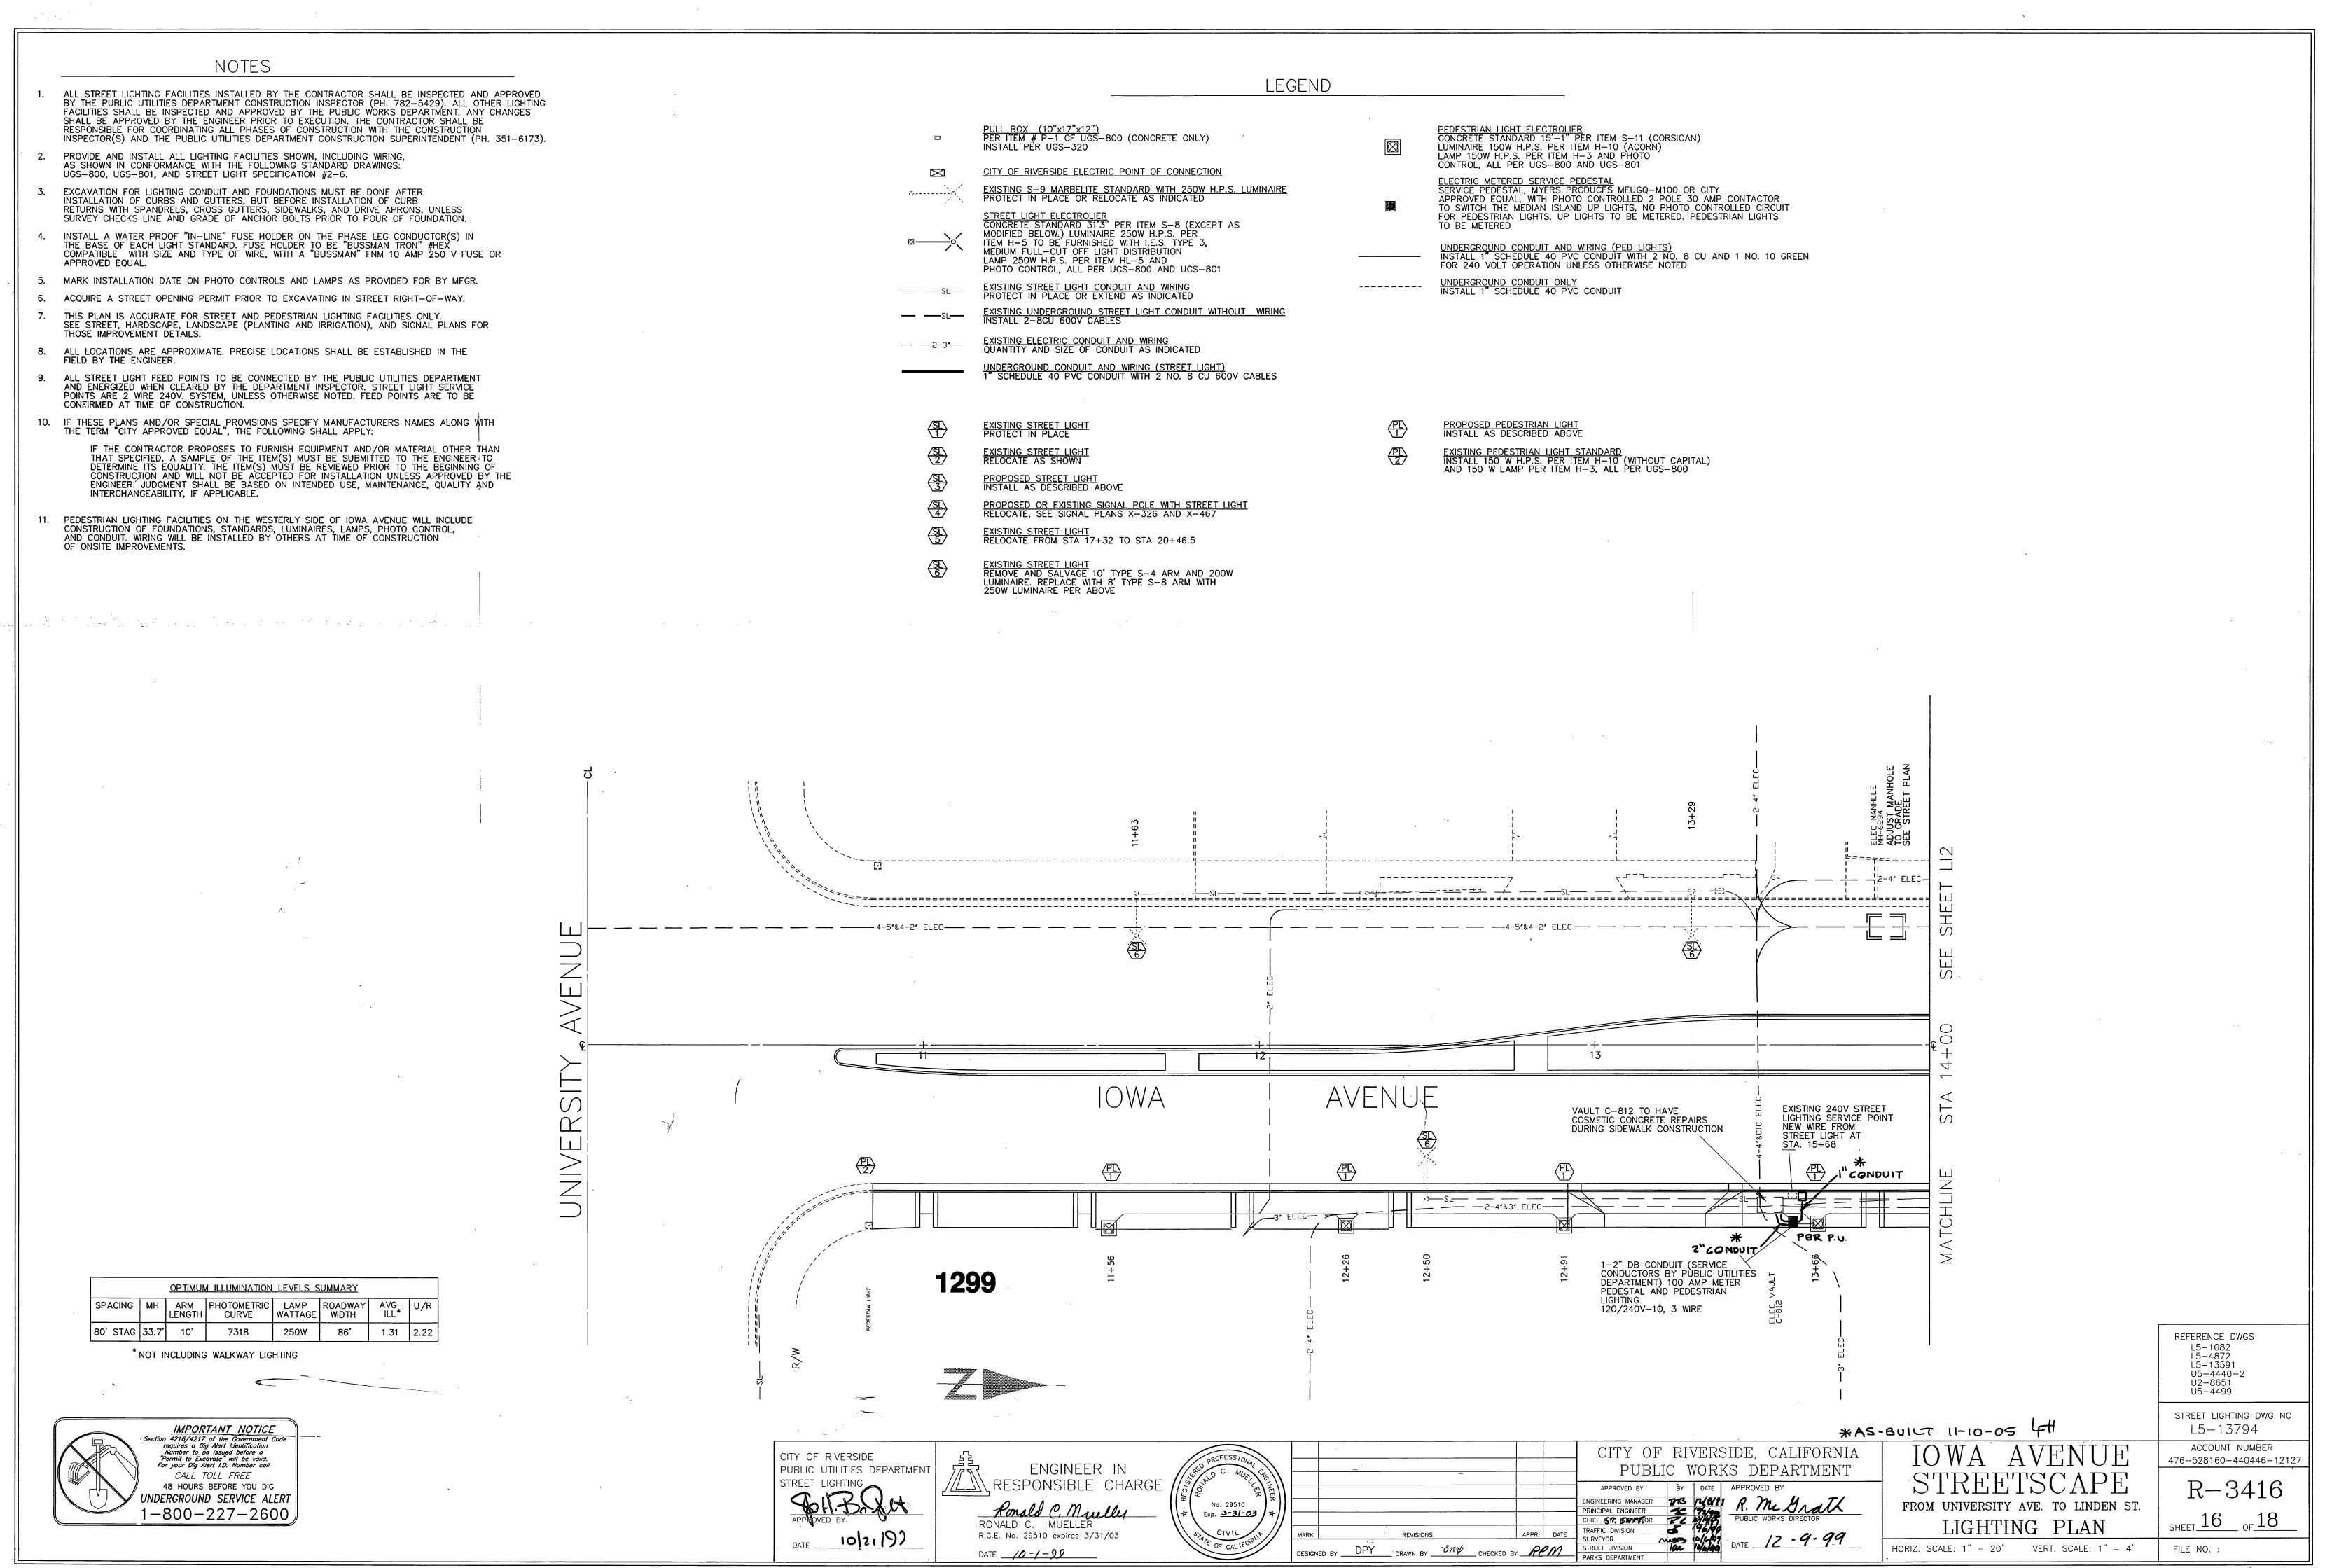

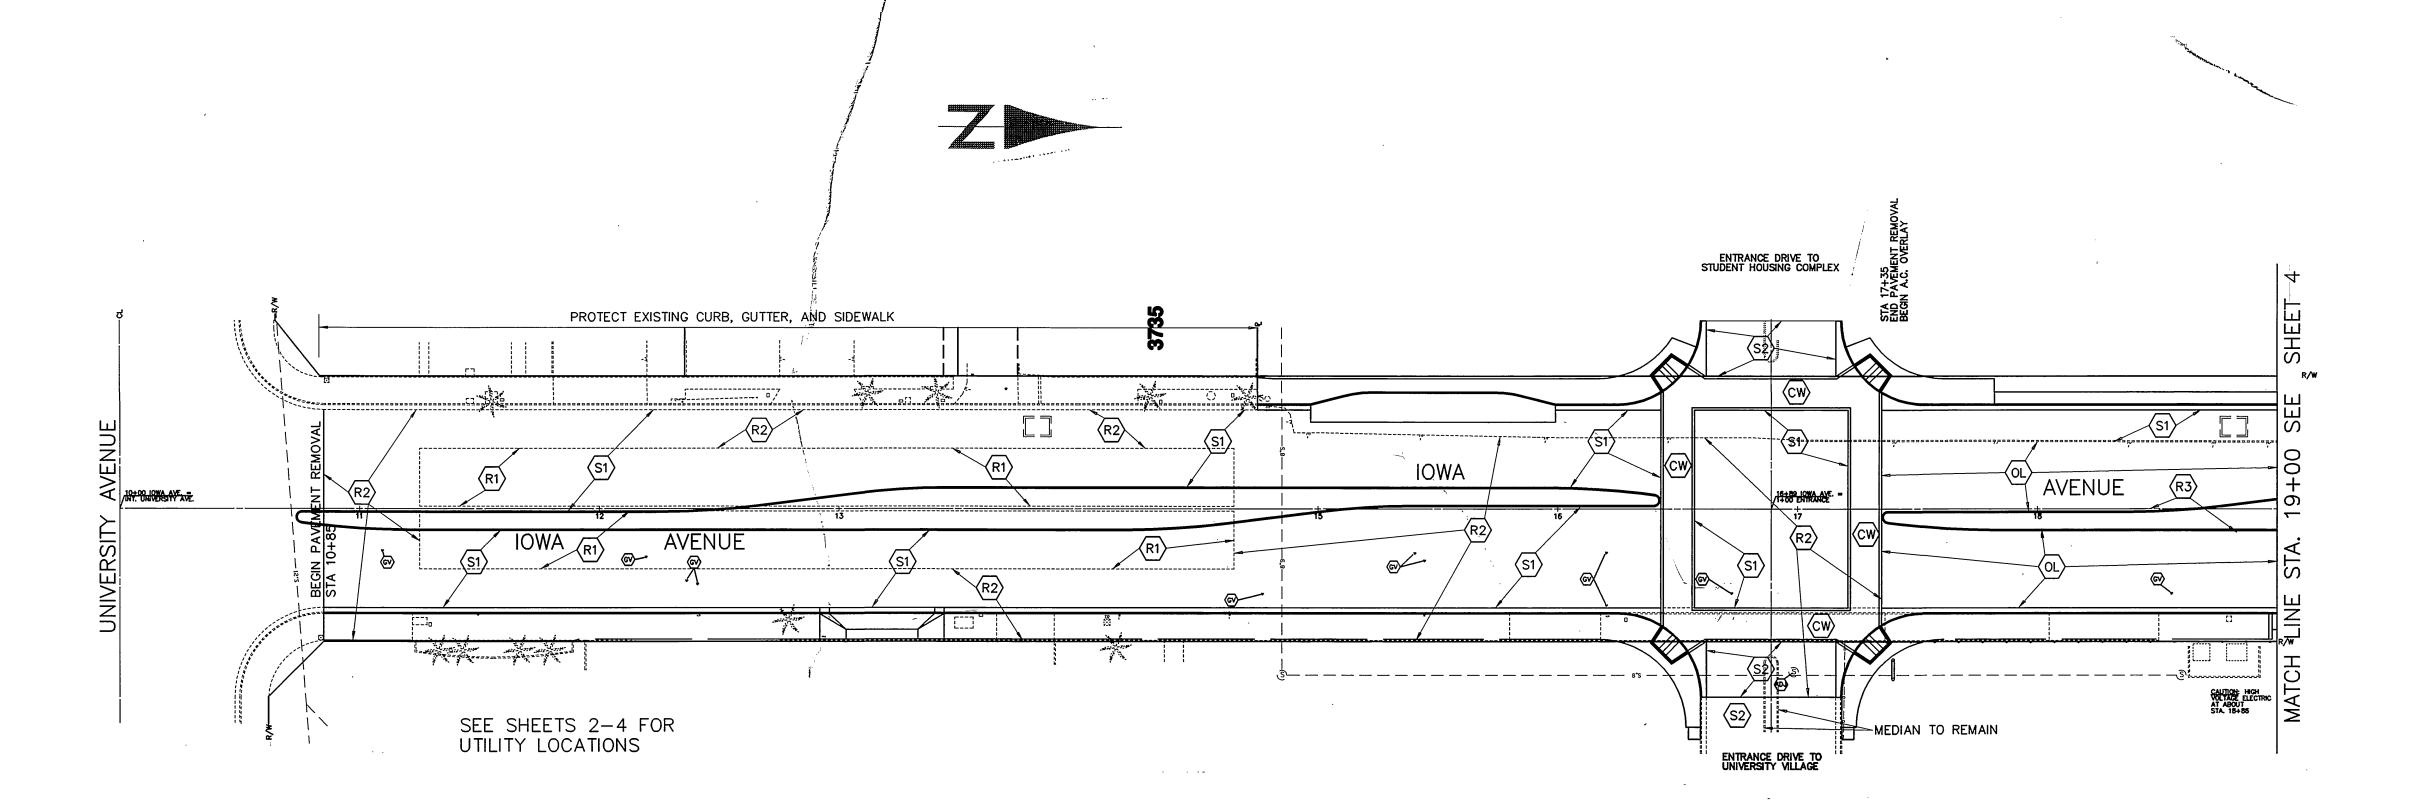


LEGEND

REMOVE EXISTING PCC PAVING WITH AC OVERLAY. APPROX. STA 11+25 TO STA 14+65, W=50'. REMOVE EXISTING AC PAVING, CURB, GUTTER AND SIDEWALK. APPROX. STA 10+85 TO STA 17+35. REMOVE EXISTING AC PAVING FOR MEDIAN CONSTRUCTION. APPROX STA 17+35 TO STA 22+90. CONSTRUCT STRUCTURAL SECTION OF 0.42' DGAC OVER 0.48' C.A.B. CONSTRUCT STRUCTURAL SECTION OF 0.40' DGAC OVER NATIVE.

CONSTRUCT DGAC OVERLAY, VARIABLE THICKNESS. APPROX. STA 17+35 TO STA 22+25.

CONSTRUCT CROSS WALK PER HARDSCAPE PLAN.

WATER VALVE TO BE LOCATED, PROTECTED, AND ADJUSTED TO GRADE.

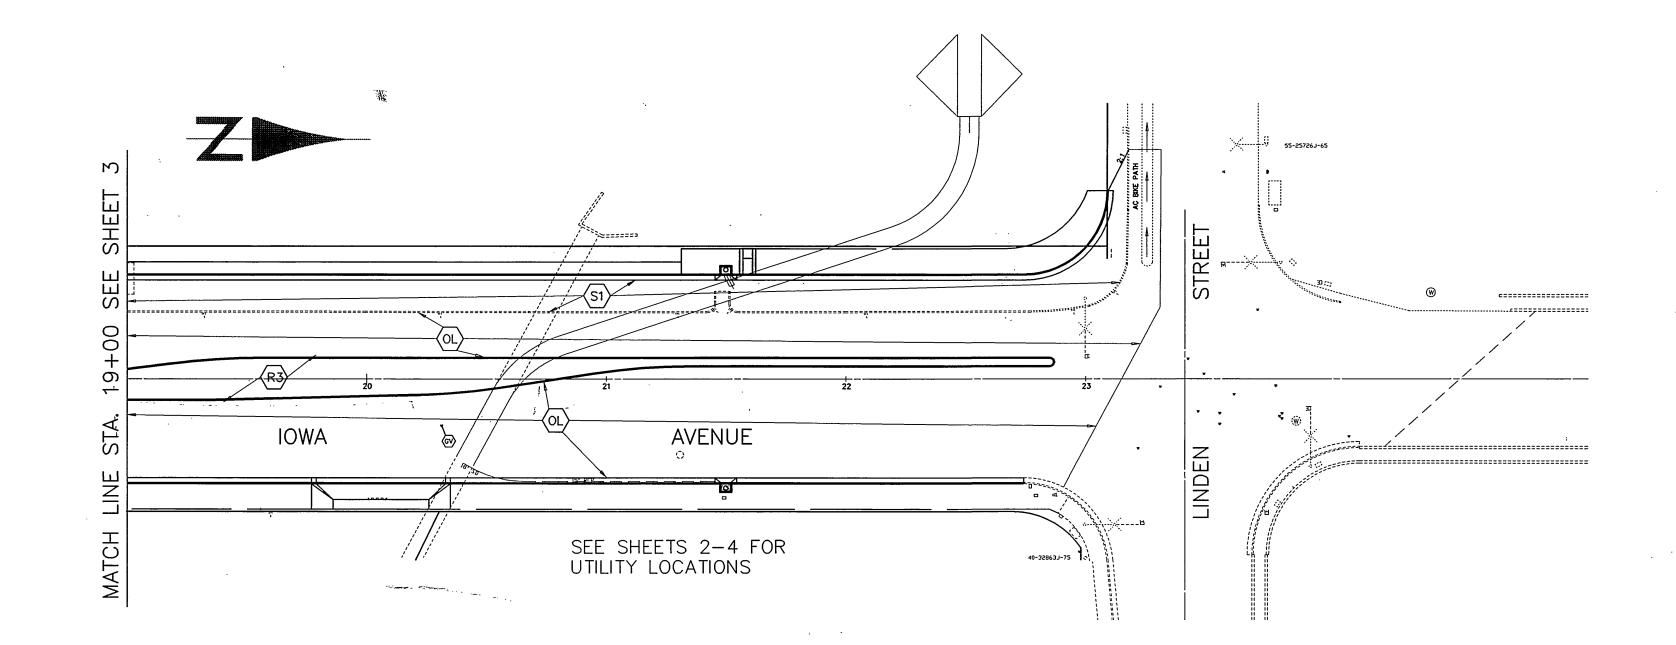

*AS-BUILT 11-10-05 4# CITY OF RIVERSIDE, CALIFORNIA ENGINEER IN RESPONSIBLE CHARGE DEPARI

BY DATE APPROVED BY

PRINCIPAL ENGINEER

CHIEF BY, INSPECIAL, PUBLIC WORKS DIRECTOR

PRESCRIPTION OF TRAFFIC DIVISION
SURVEYOR

STREET DIVISION
PARKS DEPARTMENT

DATE

DATE PUBLIC WORKS DEPARTMENT RONALD C. MUELLER
R.C.E. No. 29510 expires 3/31/03 No. 29510 Exp. **3-3/- 0.3** REMOVAL & PAVING PLAN HORIZ. SCALE: 1" = 40'

FÎLE NO. :

ACCOUNT NUMBER 476-528160-440446-12127

R - 3416

 $_{\text{SHEET}} 18 \quad \text{of} \quad 18$