GENERAL NOTES:

- NO PERSON SHALL PERFORM ANY CONSTRUCTION ACTIVITY OR INSTALL ANY OBJECTS WITHIN THE PUBLIC RIGHTS-OF-WAY OR EASEMENTS OF THE CITY OF RIVERSIDE WITHOUT A VALID CONSTRUCTION PERMIT OR. A STREET OPENING PERMIT OR AN ENCROACHMENT PERMIT ISSUED BY THE CITY'S PUBLIC WORKS DEPARTMENT.
- IT SHALL BE THE RESPONSIBILITY OF THE CONTRACTOR TO CLEAR THE RIGHT-OF-WAY IN ACCORDANCE WITH THE PROVISIONS OF LAW AS IT AFFECTS EACH UTILITY INCLUDING IRRIGATION LINES AND APPURTENANCES AND AT NO COST TO THE CITY.
- CONSTRUCTION SHALL BE IN ACCORDANCE WITH THE CITY OF RIVERSIDE DEPARTMENT OF PUBLIC WORKS, STANDARD DRAWINGS, ITS SUPPLEMENTAL NOTES AND THE STANDARD SPECIFICATIONS FOR PUBLIC WORKS CONSTRUCTION, CURRENT EDITION.
- THE PRIVATE ENGINEER SIGNING THESE PLANS IS RESPONSIBLE FOR ASSURING THE ACCURACY AND ACCEPTABILITY OF THE WORK HEREON. IN THE EVENT OF DISCREPANCIES ARISING DURING CONSTRUCTION, THE PRIVATE ENGINEER SHALL BE RESPONSIBLE FOR DETERMINING AN ACCEPTABLE SOLUTION AND REVISING THE PLANS FOR APPROVAL BY THE
- THE CONTRACTOR SHALL BE RESPONSIBLE FOR PRESERVING OR RE-ESTABLISHING AND REFERENCING SURVEY MONUMENTS DESTROYED, DISTURBED OR BURIED AS A RESULT OF CONSTRUCTION SHOWN HEREON.
- 6. SEE STREET LIGHTING PLANS VOLS-694224 FOR QUANTITY AND LOCATION OF REQUIRED STREET LIGHTS.
- ALL FLAGGED ELEVATIONS SHALL BE STAKED IN THE FIELD BY THE ENGINEER.
- WHERE NEW PAVEMENT IS TO JOIN THE EXISTING PAVEMENT, THE EDGE OF THE EXISTING PAVEMENT SHALL BE TRIMMED IN A SMOOTH AND STRAIGHT LINE. CONSTRUCT MATCH-UP PAVING AS SHOWN ON THE PLANS AND OVERLAY PAVING AS DIRECTED IN THE FIELD TO PRODUCE A SMOOTH SECTION.
- ANY TRAFFIC CONTROL STRIPING OBLITERATED AND/OR BADLY WORN DURING CONSTRUCTION SHALL BE RESTORED BY THE CONTRACTOR WITHIN FIVE DAYS AFTER NOTIFICATION FROM THE CITY INSPECTORS.
- 10. THE CONTRACTOR SHALL CALL IN A LOCATION REQUEST TO UNDERGROUND SERVICE ALERT (USA). PHONE # 1-800-227-2600. TWO WORKING DAYS BEFORE DIGGING. NO CONSTRUCTION PERMIT WILL BE ISSUED BY THE PUBLIC WORKS DEPARTMENT INVOLVING EXCAVATION FOR UNDERGROUND FACILITIES UNLESS THE APPLICANT HAS BEEN PROVIDED AN INQUIRY IDENTIFICATION NUMBER BY U.S.A.
- IN PAVEMENT OVERLAY AREAS, ANY DISTRESSED EXISTING PAVEMENT SHALL BE REMOVED AND REPLACED AS DIRECTED BY THE ENGINEER PRIOR TO OVERLAYING WITH A.C. PAVING.
- 12. ANY TRAFFIC CONTROL STRIPING OBLITERATED AND / OR BADLY WORN DURING CONSTRUCTION SHALL BE RESTORED BY THE CONTRACTOR WITHIN FIVE DAYS AFTER NOTIFICATION FROM THE CITY INSPECTORS.

CONSTRUCTION NOTES

- (1) CONSTRUCT STANDARD DWG. # 200 CURB AND GUTTER-6" CURB FACE TYPE I
- (2) CONSTRUCT STANDARD DWG. # 200 CURB AND GUTTER-8" CURB FACE TYPE I
- (3) CONSTRUCT STANDARD DWG. # 220, CROSS GUTTER (WIDTH = 6 FT.)
- CONSTRUCT 0.25' A.C. PAVING 1.05' CRUSHED AGGREGATE BASE
- PER S.R. 222, R-VALUE= 8.
- (5) CONSTRUCT 0.5' A.C. PAVING 1.70' CRUSHED AGGREGATE BASE PER S.R. 222, R-VALUE= 8.
- (6) NOT USED
- (7) CONSTRUCT STANDARD DWG. # 325, PROPERTY LINE SIDEWALK.
- (7A) CONSTRUCT STANDARD DWG. # 325, CURBLINE SIDEWALK.
- CONSTRUCT STANDARD DWG. # 304, WHEELCHAIR RAMP, TYPE AS SHOWN ON PLAN.
- CONSTRUCT PARKWAY DRAIN PER APWA STD. PLAN
- CONSTRUCT STANDARD DWG. # 302, DRIVEWAY APPROACH, TYPE II, A & B AS SHOWN.
- (11) ADJUST SEWER MANHOLE TO GRADE.
- (12) REMOVE WATER METER, BY CITY FORCES
- (13) RELOCATE WATER METER, BY CITY FORCES, IF REQUIRED
- (14) RELOCATE GAS METER, BY OTHERS.
- (15) REMOVE GAS METER, BY OTHERS.
- RELOCATE STREET LIGHT, AND CONDUIT PER CITY DWG. # VOL5-694324
- (17) EXTEND EXIST. WATER METER,
- (18) REMOVE TELEPHONE POLE, BY OTHERS.
- (19) RELOCATE STOP AND STREET NAME SIGN PER STANDARD DWG. # 662.
- (20) INSTALL F1 DELINEATOR
- (21) CONSTRUCT VARIABLE THICKNESS AC OVERLAY (0.10 FT. MIN.)
- (22) ADJUST WATER VALVE BOX TO GRADE BY CONTRACTOR
- (23) RELOCATE IRRIGATION VALVE BOX

WATER DEPARTMENT NOTE:

PEVELOPER TO GIVE CITY WATER DIVISION FIVE (5) WORKING DAYS WRITTEN NOTICE PRIOR TO START OF CONSTRUCTION AND TO ALLOW CITY TEN (10) WORKING DAYS FOR COMPLETION OF WORK. (909) 351-6368

NOTICE TO CONTRACTOR:

THE EXISTENCE AND LOCATIONS OF ALL UNDERGROUND UTILITIES (UTILITY PIPES, STRUCTURES, ETC.) SHOWN ON THESE PLANS (MAIN LINES ONLY - NO SERVICE LATERALS) WERE ASCERTAINED BY A REVIEW OF RECORDS PROVIDED BY THESE MEMBER AGENCIES AND ARE APPROXIMATE. NEITHER THE OWNER NOR THE ENGINEER ASSUMES ANY RESPONSIBILITY FOR UTILITIES NOT SHOWN OR NOT IN THE LOCATION SHOWN.

T & TA CITY OF RIVERSIDE SOUTHERN CALIFORNIA GAS CO. PACIFIC BELL CHARTER COMMUNICATIONS

THE CONTRACTOR IS REQUIRED TO TAKE DUE PRECAUTIONARY MEASURES TO PROTECT ALL UTILITIES SHOWN ON THESE PLANS AND/OR ANY OTHER UNDERGROUND UTILITIES NOT OF RECORD OR NOT SHOWN ON THESE PLANS.

THE CONTRACTOR IS RESPONSIBLE TO INSURE THAT ALL SIDEWALKS, RAMPS, RAILS, CLEARANCES TAND APPURTENANCES MEET OR EXCEED THE MOST STRINGENT REQUIREMENTS OF CITY, STATE OR FEDERAL GOVERNMENT FOR ACCESSIBILITY.

PARKS DEPARTMENT NOTES:

- 1. ALL RELATED WORK SHALL CONFORM TO THE CITY OF RIVERSIDE PARK AND RECREATION DEPARTMENT STANDARDS.
- 2. CONTACT THE ENGINEER A MINIMUM OF 2 WORKING DAYS IN ADVANCE TO SCHEDULE INSPECTIONS. INSPECTIONS SHALL BE REQUIRED:
- A. WHEN PLANT LOCATIONS HAVE BEEN SPOTTED IN THE FIELD PRIOR TO DIGGING PLANT PITS. B. WHILE DIGGING PLANT PITS AND PLANTING/RELOCATING TREES.
- BEEN COMPLETED FOR START OF MAINTENANCE. D. AT END OF MAINTENANCE/FINAL ACCEPTANCE (CONTRACTOR/DEVELOPER WILL BE RELEASED FROM MAINTENANCE ONLY UPON RECEIPT OF WRITTEN NOTIFICATION FROM THE CITY THAT THE PARK AND RECREATION

DEPARTMENT IS ASSUMING MAINTENANCE RESPONSIBILITIES).

AFTER PLANTING AND ALL OTHER INDICATED OR SPECIFIED WORK HAS

- THE CONTRACTOR SHALL MAINTAIN ALL PLANTINGS FOR A MINIMUM PERIOD OF ONE (1) YEAR.
- PARK AND RECREATION DEPARTMENT AND PUBLIC WORKS DEPARTMENT PERMITS ARE REGUIRED PRIOR TO COMMENCEMENT OF TREE RELOCATION AND/OR REMOVAL WORK. FOR ALL TREES WITHIN THE ULTIMATE PAVEMENT AREA. BACKFILL OF ALL HOLES IS TO BE INSPECTED BY THE CITY FOR PROPER COMPACTION.
- 5. STREET TREE PLANTING SHALL BE AS FOLLOWS:

BOTANICAL NAME APPROX. COMMON NAME SIZE SPACING REQ'D. MAGNOLIA AVE. EX. PALM TREES (PROTECT IN PLACE) 2 EA. EX. BROADLEAF TREES (PROTECT IN PLACE) 3 EA EX. MAGNOLIA TREE (TO BEREMOVED) 1 EA MAGNOLIA 9. "MAJESTIC BEAUTY / GOUTHERN

24" BOX 45'O.C. 3 EA. MAGNOLIA LAGERSTROEMIA INDICA MCCRAY ST. CATAWBA/CRAPE MYRTLE 24"BOX 46'O.C. GEA


6 NOTE: IN THE INTEREST OF PUBLIC SAFETY AND MAINTENANCE, THE ENGINEER SHALL HAVE THE AUTHORITY TO REVISE THE STREET TREE QUANTITIES AND LOCATIONS SHOWN ON THE APPROVED PLANS BASED UPON FIELD CONDITIONS FOUND AT THE TIME OF INSTALLATION OF THE TREES.

7. ALL STREET TREES ARE TO BE AUTOMATICALLY IKRIGATED.

Construction Notes (continued)

(24) CONSTRUCT CURB TRANSITION PER STD. DWG. 210.

1 (25) INSTALL 4" DIA. CAST IRON CURB DRAIN AND CONNECT TO EXISTING STUB AT RIGHT- OF WAY

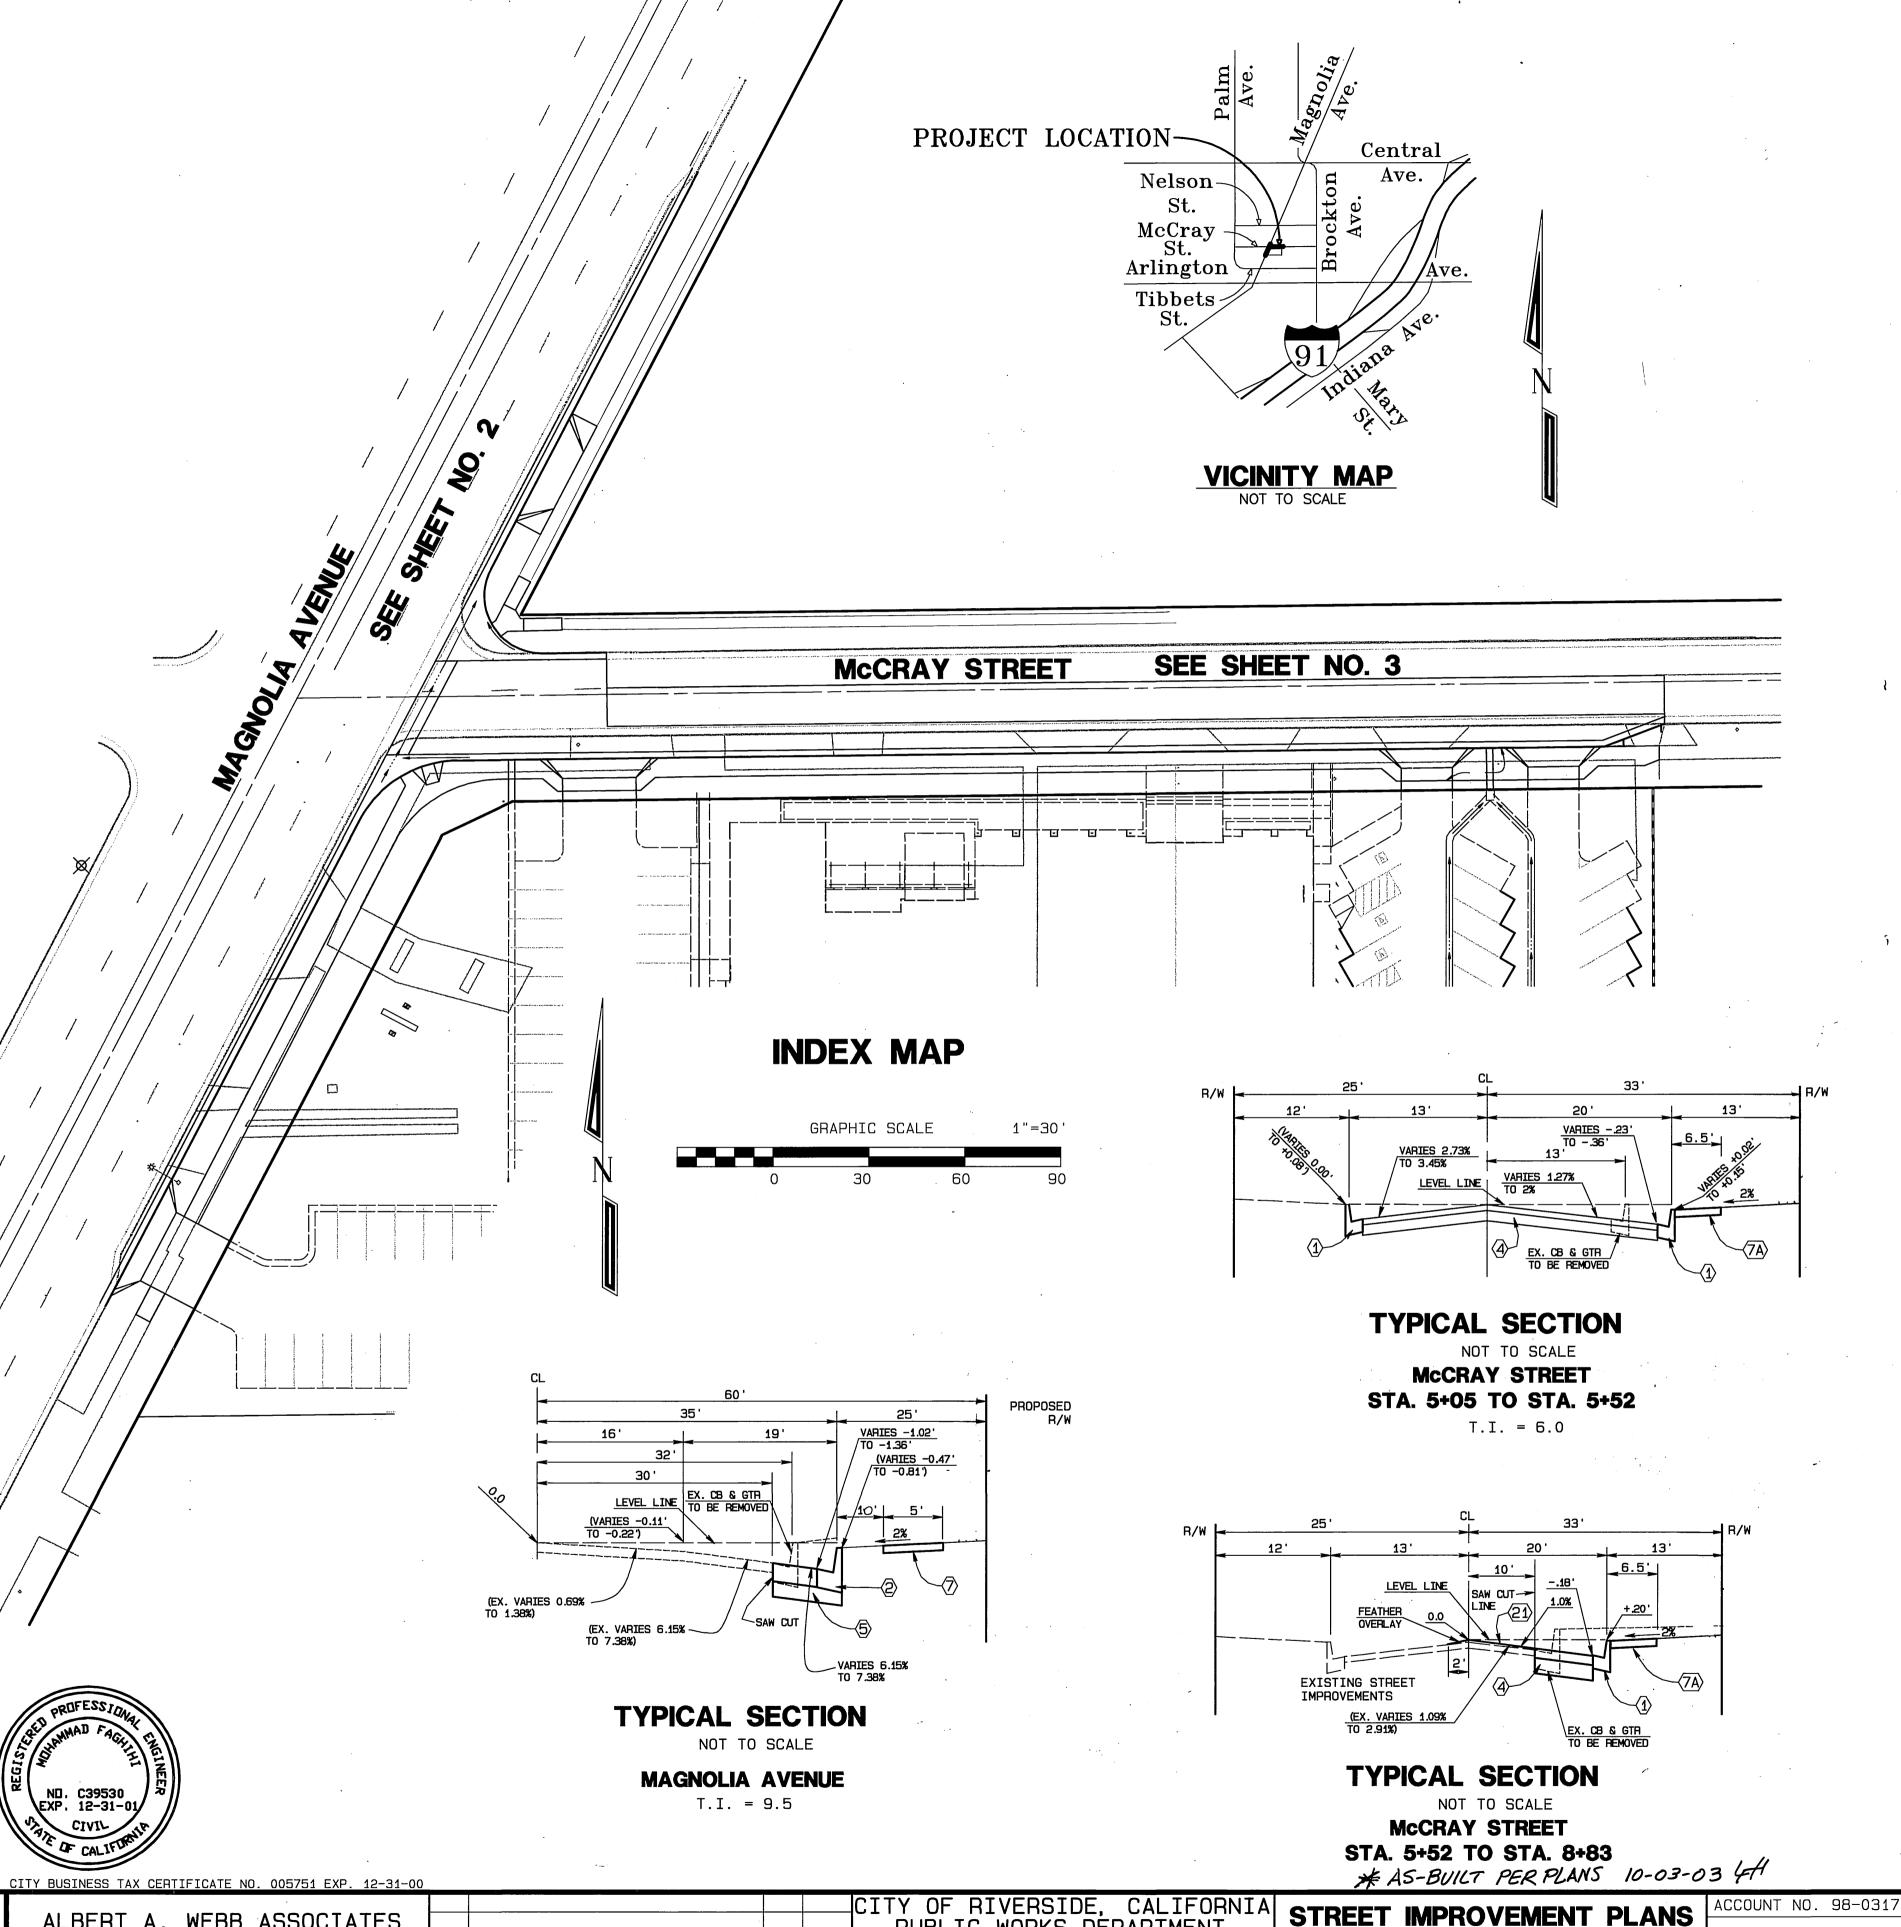

BENCH MARK: ELEV.: 845.155

CITY OF RIVERSIDE BENCH MARK G5-L2 P.K. NAIL AND CITY ENGINEER TAG IN THE SOUTHERLY WING OF A CATCH BASIN ON THE WEST SIDE OF BROCKTON AVENUE 79 FEET SOUTHERLY OF ARLINGTON AVENUE.



ALBERT A. WEBB ASSOCIATES CIVIL ENGINEERS 3788 McCRAY STREET RIVERSIDE, CA 92506 (909) 686-1070 W.O. 98-0317 FOR: CITY OF RIVERSIDE

PUBLIC WORKS DEPARTMENT APPROVED BY BY DATE APPROVED BY RINCIPAL ENGINEER 🚣 🛣 add Const. notes 24 \$ 25 2/20/01 aight ADDD DATE REVISIONS DEP. P.W. DIR-ENGR DB Hoye DATE 11-28-2000 DESIGNED BY: 90 CHECKED BY PLN CHK REF 10/8/98

MAGNOLIA AVENUE WIDENING AT McCRAY STREET

SCALE: AS SHOWN

DRAWING NUMBER R-3556 SHEET 1 OF 3

98-317

