
- 1. NO PERSON SHALL PERFORM ANY CONSTRUCTION ACTIVITY OR INSTALL ANY OBJECTS WITHIN THE PUBLIC-RIGHTS-OF-WAY OR EASEMENTS OF THE CITY OF RIVERSIDE WITHOUT A VALID CONSTRUCTION PERMIT, STREET OPENING PERMIT, OR AN ENCROACHMENT PERMIT ISSUED BY THE CITY'S PUBLIC WORKS DEPARTMENT.
- 2. IT SHALL BE THE RESPONSIBILITY OF THE CONTRACTOR TO CLEAR THE RIGHT OF WAY IN ACCORDANCE WITH THE PROVISIONS OF LAW AS IT AFFECTS EACH UTILITY INCLUDING IRRIGATION LINES AND APPURTENANCES AND AT NO COST TO THE CITY.
- 3. CONSTRUCTION SHALL BE IN ACCORDANCE WITH THE CITY OF RIVERSIDE DEPARTMENT OF PUBLIC WORKS, STANDARD DRAWINGS, ITS SUPPLEMENTAL NOTES AND THE STANDARD SPECIFICATIONS FOR PUBLIC WORKS CONSTRUCTION, CURRENT
- 4. THE PRIVATE ENGINEER SIGNING THESE PLANS IS RESPONSIBLE FOR ASSURING THE ACCURACY AND ACCEPTABILITY OF THE WORK HEREON. IN THE EVENT OF DISCREPANCIES ARISING DURING CONSTRUCTION, THE PRIVATE ENGINEER SHALL BE RESPONSIBLE FOR DETERMINING AN ACCEPTABLE SOLUTION AND REVISING THE PLANS FOR APPROVAL BY THE CITY.
- 5. QUANTITIES SHOWN ARE FOR INFORMATION ONLY AND THE CITY OF RIVERSIDE IS NOT RESPONSIBLE FOR THEIR ACCURACY.
- 6. THE DEVELOPER SHALL BE RESPONSIBLE FOR PRESERVING OR RE-ESTABLISHING AND REFERENCING SURVEY MONUMENTS DESTROYED, DISTURBED OR BURIED AS A RESULT OF CONSTRUCTION SHOWN HEREON.
- 7. SEE "STREET LIGHTING PLANS" FOR QUANTITY AND LOCATION OF REQUIRED STREET LIGHTS.
- 8. ALL FLAGGED ELEVATIONS SHALL BE STAKED IN THE FIELD BY THE PRIVATE ENGINEER.
- 9. WHERE NEW PAVEMENT IS TO JOIN THE EXISTING PAVEMENT, THE EDGE OF THE EXISTING PAVEMENT SHALL BE TRIMMED IN A SMOOTH AND STRAIGHT LINE. CONSTRUCT MATCH-UP PAVING AS SHOWN ON THE PLANS AND OVERLAY PAVING AS DIRECTED IN THE FIELD TO PRODUCE A SMOOTH SECTION.
- 10. CONSTRUCT DRIVEWAY APPROACHES PER STANDARD DRAWING 302. EXACT SIZE AND LOCATION TO BE STAKED BY THE PRIVATE ENGINEER PRIOR TO CONSTRUCTION OF THE CURB AND GUTTER.
- 11. THE SUBDIVIDER SHALL ARRANGE FOR A SOIL TEST TO BE MADE BY A SOILS ENGINEER AFTER THE STREETS HAVE BEEN PREPARED TO ROUGH GRADE AND PRIOR TO CURB AND GUTTER CONSTRUCTION. DEPTH OF BASE MATERIAL AND A.C. PAVING SHALL BE DETERMINED BY THE CITY OF RIVERSIDE DESIGN STANDARDS AND TEST PROCEDURES.
- 12. ALL OVERHANGING TREE LIMBS THAT ARE LESS THAN 14' ABOVE THE STREET GRADE SHALL BE TRIMMED BACK.
- 13. ON ALL AREAS WITHIN PUBLIC RIGHT OF WAY WHERE THE FILL IS ONE (1) FOOT OR GREATER, A LETTER WILL BE REQUIRED FROM THE SOILS ENGINEER, CERTIFYING THE COMPACTION OF THE FILL BELOW SUBGRADE, PRIOR TO ISSUANCE OF THE CONSTRUCTION PERMIT/CUT SHEETS.
- 14. STREET OPENING PERMIT FOR CONSTRUCTION AND/OR MODIFICATION OF TRAFFIC SIGNAL FACILITIES IS REQUIRED.
- 15. ALL TRAFFIC SIGNS SHALL BE INSTALLED PRIOR TO OPENING THE STREETS TO TRAFFIC.
- 16. ANY TRAFFIC CONTROL STRIPING OBLITERATED AND/OR BADLY WORN DURING CONSTRUCTION SHALL BE RESTORED BY THE CONTRACTOR WITHIN FIVE DAYS AFTER NOTIFICATION FROM THE CITY INSPECTORS.
- 17. STREET IMPROVEMENT WORK THAT WILL CAUSE DAMAGE TO THE DETECTOR LOOP(S) SHALL NOT BE PERFORMED UNTIL TRAFFIC SIGNAL MAINTENANCE PERSONNEL HAVE BEEN NOTIFIED AND THE NECESSARY TIMING ADJUSTMENTS ARE MADE TO SIGNAL OPERATION.
- 18. FINAL STRIPING FOR TRAFFIC CONTROL AND/OR PAVEMENT MARKING TO BE THE RESPONSIBILITY OF THE DEVELOPER.
- 19. THE CONTRACTOR SHALL CALL IN A LOCATION REQUEST TO UNDERGROUND SERVICE ALERT (U.S.A.), PHONE #1-800-227-2600, TWO WORKING DAYS BEFORE DIGGING. NO CONSTRUCTION PERMIT WILL BE ISSUED BY THE PUBLIC WORKS DEPARTMENT INVOLVING EXCAVATION FOR UNDERGROUND FACILITIES UNLESS THE APPLICANT HAS BEEN PROVIDED AN INQUIRY IDENTIFICATION NUMBER BY U.S.A.
- 20. THE SEWER CONTRACTOR SHALL ADJUST MANHOLES TO FINAL GRADE AFTER PAVING IS COMPLETED.
- 21. IN PAVEMENT OVERLAY AREAS, ANY DISTRESSED EXISTING PAVEMENT SHALL BE REMOVED AND REPLACED AS DIRECTED BY THE INSPECTOR PRIOR TO OVERLAYING WITH A.C. PAVING.
- 22. THE CONTRACTOR SHALL COORDINATE TRENCHING FOR CABLE TELEVISION WITH OTHER TRENCHING WITHIN THE SUBDIVISION.

IN THE CITY OF RIVERSIDE, CALIFORNIA

MISSION SQUARE

ADAMS STREET IMPROVEMENT PLANS

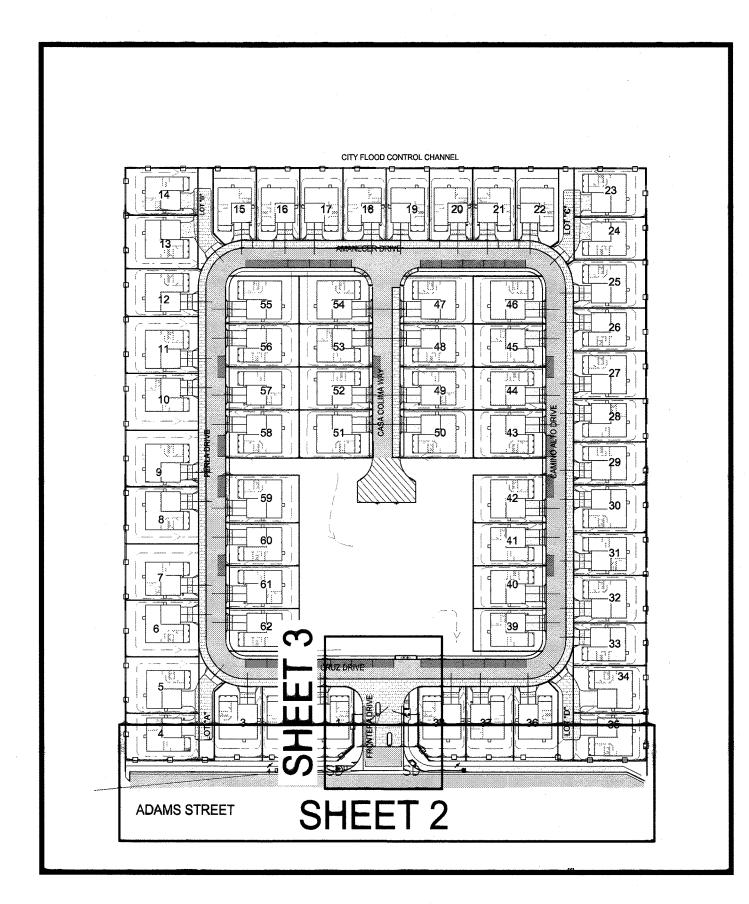

OWNER / DEVELOPER

FRONTIER COMMUNITIES ATTN: JUSTIN FRANK 8300 UTICA AVENUE, SUITE 300 RANCHO CUCAMONGA, CA 91730 PHONE: (909) 354-8011

ENGINEER

PSOMAS 2010 IOWA AVE SUITE 101 RIVERSIDE CA 92507 PHONE: (951)787-8421 FAX: (951) 682-3379

SOURCE OF TOPOGRAPHY TMR ASSOCIATES 155 W. HOSPITALITY LN. STE. 122 SAN BERNARDINO, CA 92408 PHONE: (909) 890-3730 FAX: (909) 890-3740

BASIS OF BEARING ADAM'S STREET CENTERLINE: N33'59'02"W





STREET SIGN SCHEDULE						
(A)	ADAMS STREET	BLOCK 4300				
	FRONTERA DRIVE	BLOCK 8200				
B	STOP SIGN	1 EA				
0	NO PARKING SIGN	1 EA				


SHEET INDEX								
SHEET NUMBER	SHEET TITLE							
1	COVER SHEET							
2	ADAMS STREET PLAN & PROFILE							
3	FRONTERA DRIVE PLAN & PROFILE							

SCALE: 1" = 100'



REVISION DESCRIPTION

CONSTRUCTION QUANTITY ESTIMATE	<u> </u>	
CONST. NOTES	QUANTITIES	
1 AC PAVEMENT OVER BASE MATERIAL	4,732 SF	
2 PERVIOUS PAVERS	3,095 SF	
3 RELOCATE EXISTING POWER POLE	2 EA	
4 RELOCATE EXISTING SIGN	1 EA	
20 CUT AND PLUG EXISTING WATER SERVICE	6 EA	
(200) 6-INCH TYPE-II MODIFIED CURB	769 LF	
SOZA ADA RAMP	З̀EA	
(325) 4-FOOT WIDE SIDEWALK	547 LF	
(405) CATCH BASIN	2 EA	
21" RCP STORM DRAIN PIPE	9± LF _.	
18" RCP STORM DRAIN PIPE	182± LF	
WEDGIDE DUDING HELLERING DIVERGIDE DUDING HE		

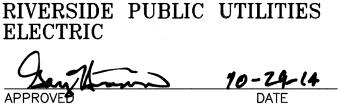

CALL TOLL FREE NDERGROUND SERVICE ALERT -800-227-2600

RIVERSIDE PUBLIC UTILITIES

Suite 210 Riverside, CA 92507 (951) 787-8421 Fax(951) 682-3379 4FR0010200 ENGINEER NAME BENCHMARK: (PT. ID. G4-H3) R.C.E. NO. 42393 ELEV (1988): 766.664; P.K. NAIL & CITY ENGINEER TAG IN CONCRETE BASE OF DATE 8/28/2014 PEDESTRIAN SIGNAL AT NORTHERLY CORNER OF ADAMS STREET & CALIFORNIA AVENUE

PREPARED UNDER THE SUPERVISION OF:

	ABE	BREVIATIONS
	AC	ASPHALT CONCRETE
	BCR	BEGIN CURB RETURN
	BOW	BACK OF SIDEWALK
	BW	BOTTOM OF WALL
	BVCS	BEGIN VERTICAL CURVE STATION
	BVCE	BEGIN VERTICAL CURVE ELEVATION
	CL	CENTERLINE
	ECR	END CURB RETURN
	EG	EXISTING GRADE
	EP	EDGE OF PAVEMENT
	EVCS	END VERTICAL CURVE STATION
	EVCE	END VERTICAL CURVE ELEVATION
	EXIST	EXISTING
	FF	FINISHED FLOOR ELEVATION
	FG	FINISHED GRADE
	GB	GRADE BREAK
	LT	LEFT
	NO	NUMBER
	PC	POINT OF CURVATURE
	PIG	POINT OF INTERSECTING GUTTER
	RT	RIGHT
	S/W	SIDEWALK
	STA	STATION
	TC	TOP BACK OF CURB
	TW	TOP OF WALL
	VERT	VERTICAL
D		

PERMIT

8/28/2014

DRAWN BY:


CHECKED BY:

APPROVED BY:

PLOT DATE:

EXISTING	LEGEND PROPERTY LINE YARD SWALE
- Σ	YARD SWALE
· <u>y</u> <u>y</u> <u>y</u>	
· >	
	WALL
762	MINOR CONTOUR
765	MAJOR CONTOUR
	WATER LINE
sd ——— sd ——	STORM SEWER
s	SANITARY SEWER
	CENTERLINE
	CURB AND GUTTER
(*	FIRE HYDRANT
(M)	WATER METER
wv 	WATER VALVE
	SS CLEANOUT
9	SS MANHOLE
	STORM CURB INLET
	STORM AREA DRAIN
	STORM MANHOLE
,	ELECTRICAL POLE
PROPO!	SED LT PAVING
	PROPO

× ×	PROPOSED LANDSCAPE		PROPOSED PERVIOUS P	PAVERS	,				
		DATE	CITY	OF	RIV	ERS	IDE.	$\overline{\mathbf{C}}$	
	······································						DEP.		
			APPROVE	D BY	BY	DATE	APPROVE	D BY	
			ENGINEERING M	ANACER	GAA	11 4/14			

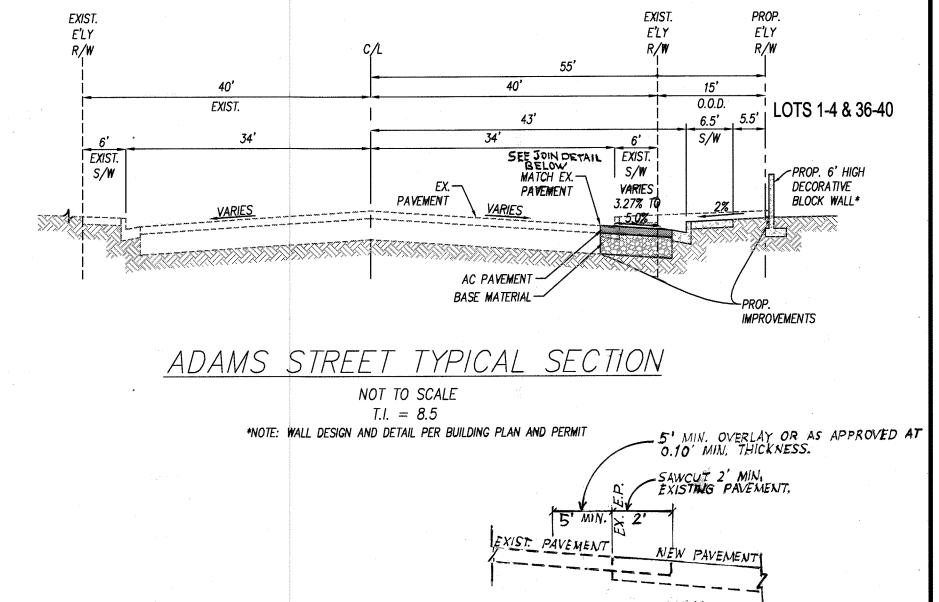


MISSION SQUARE


TRACT MAP 36654 ADAMS STREET IMPROVEMENT PLANS **COVER SHEET**

SHEET 1 OF 4 SCALE AS SHOWN


PW14-0246

INDEXED 9-15-16

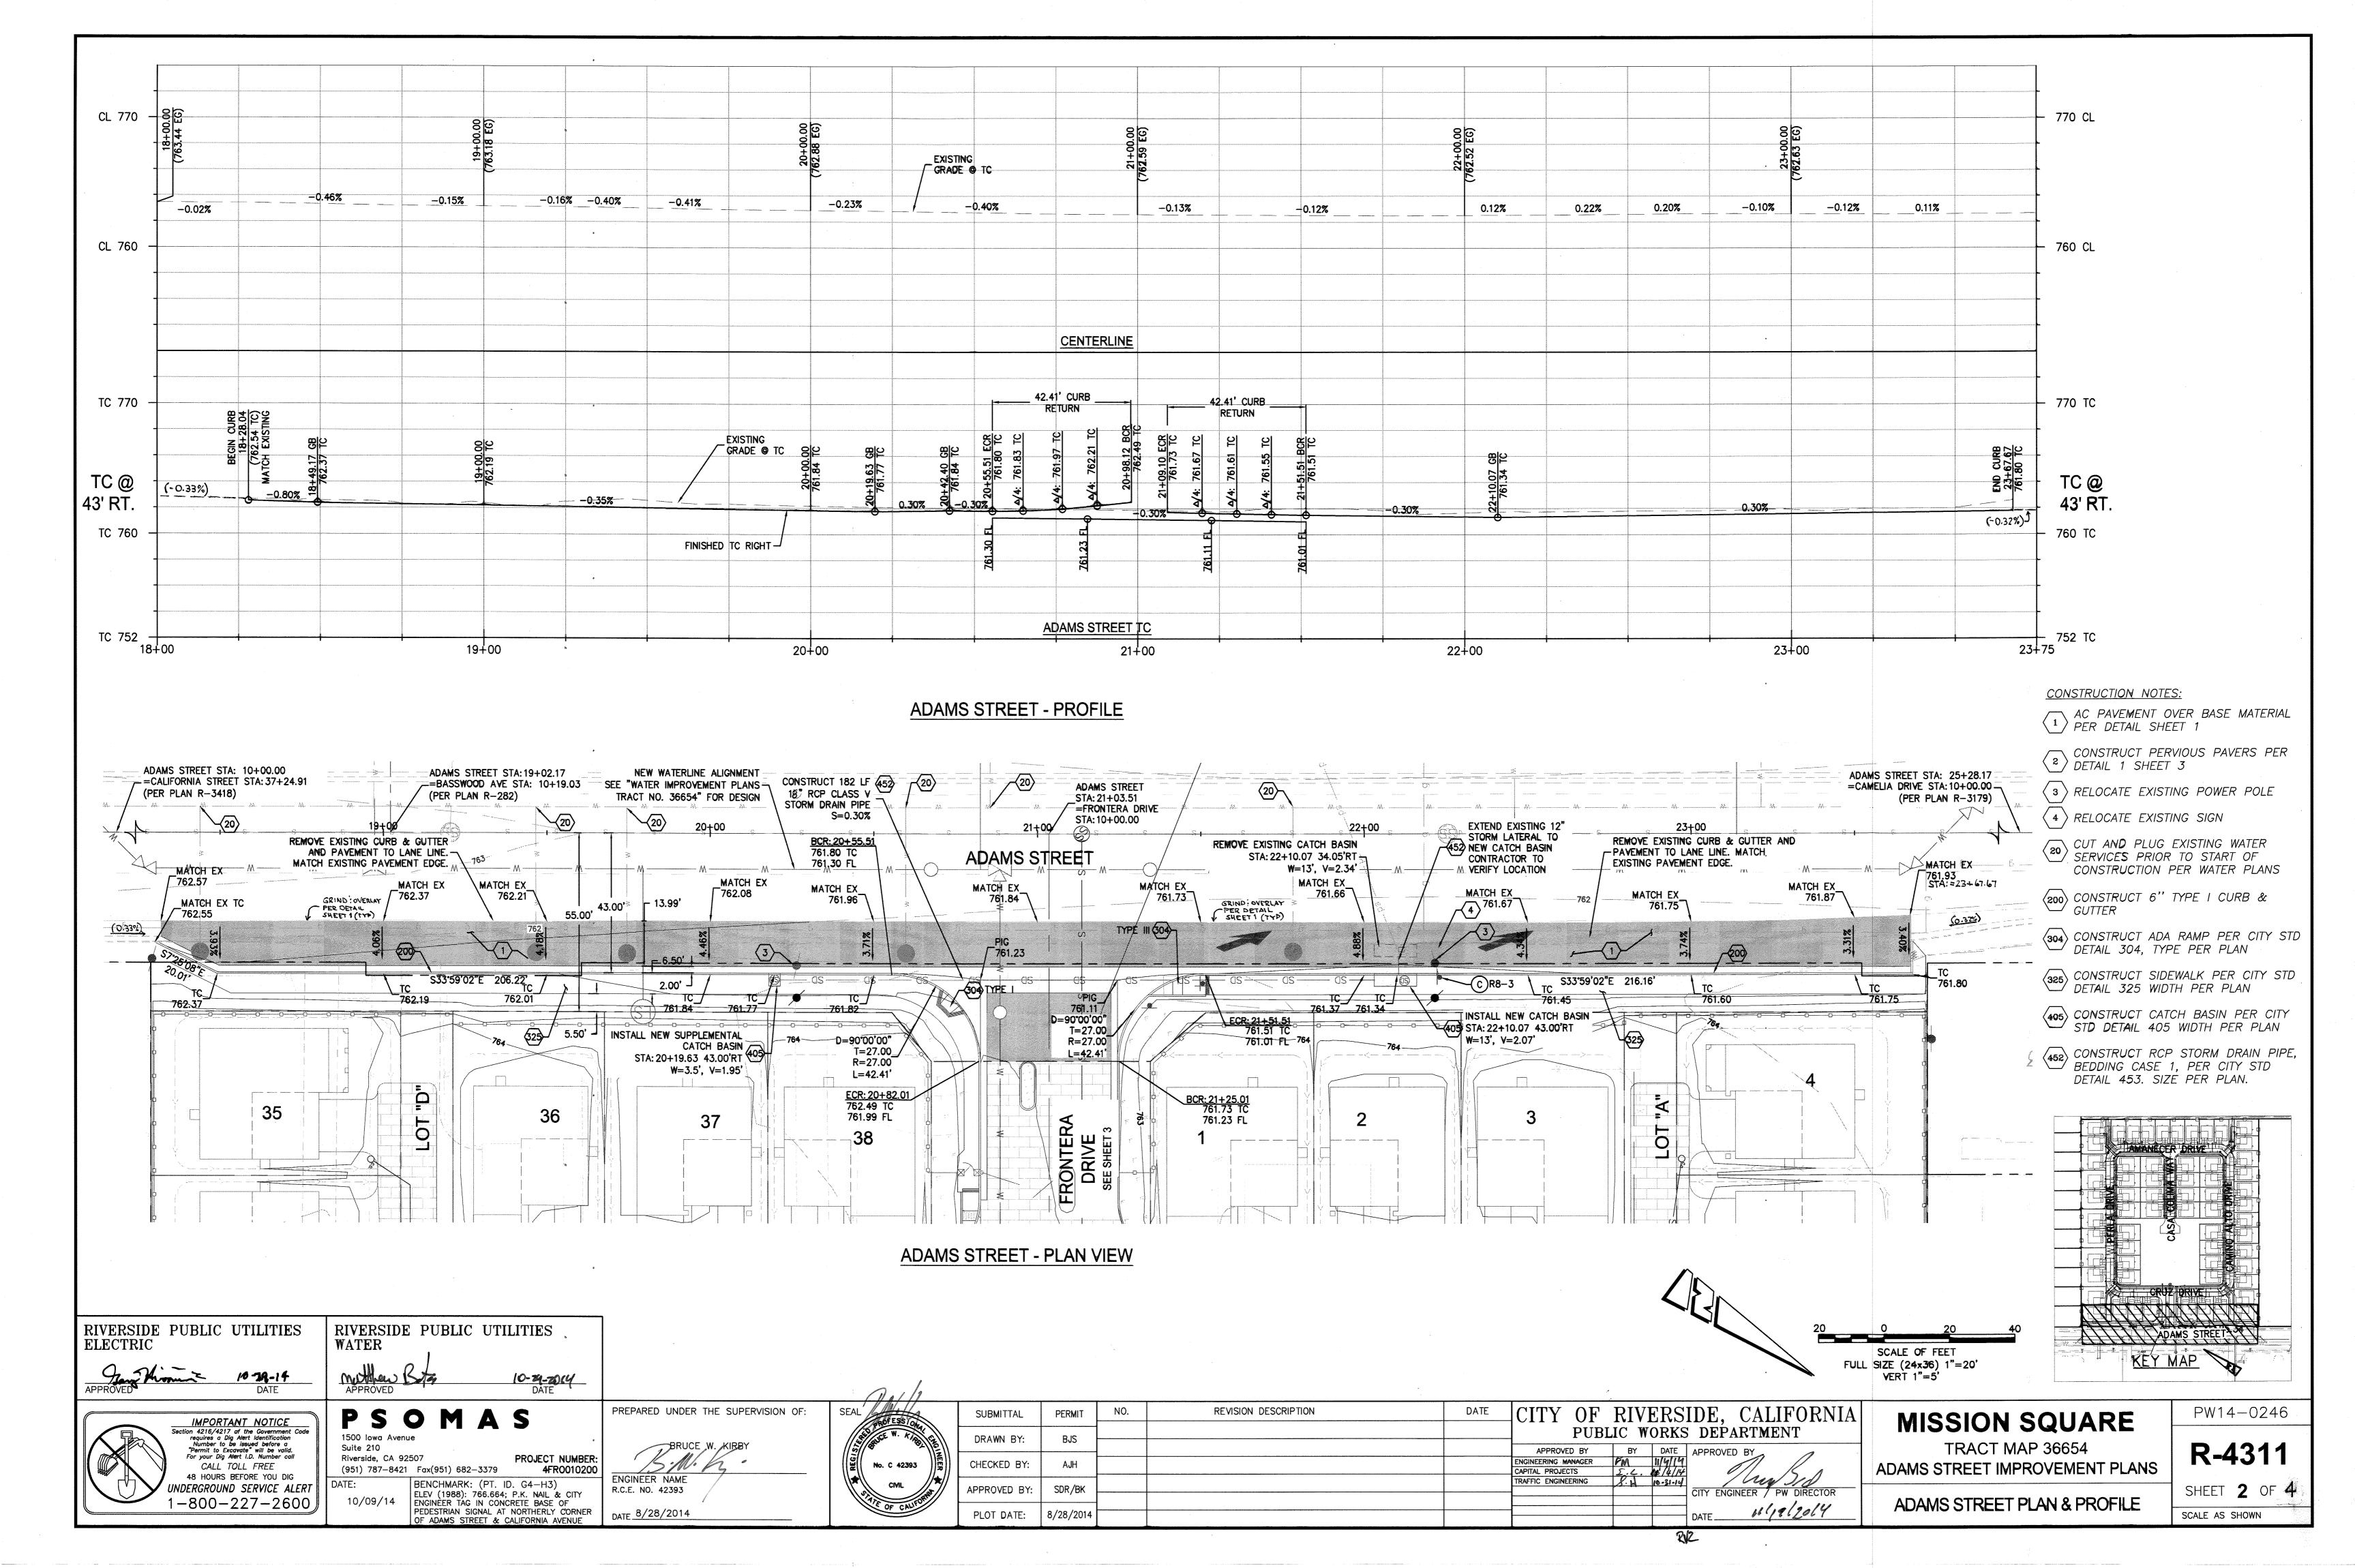

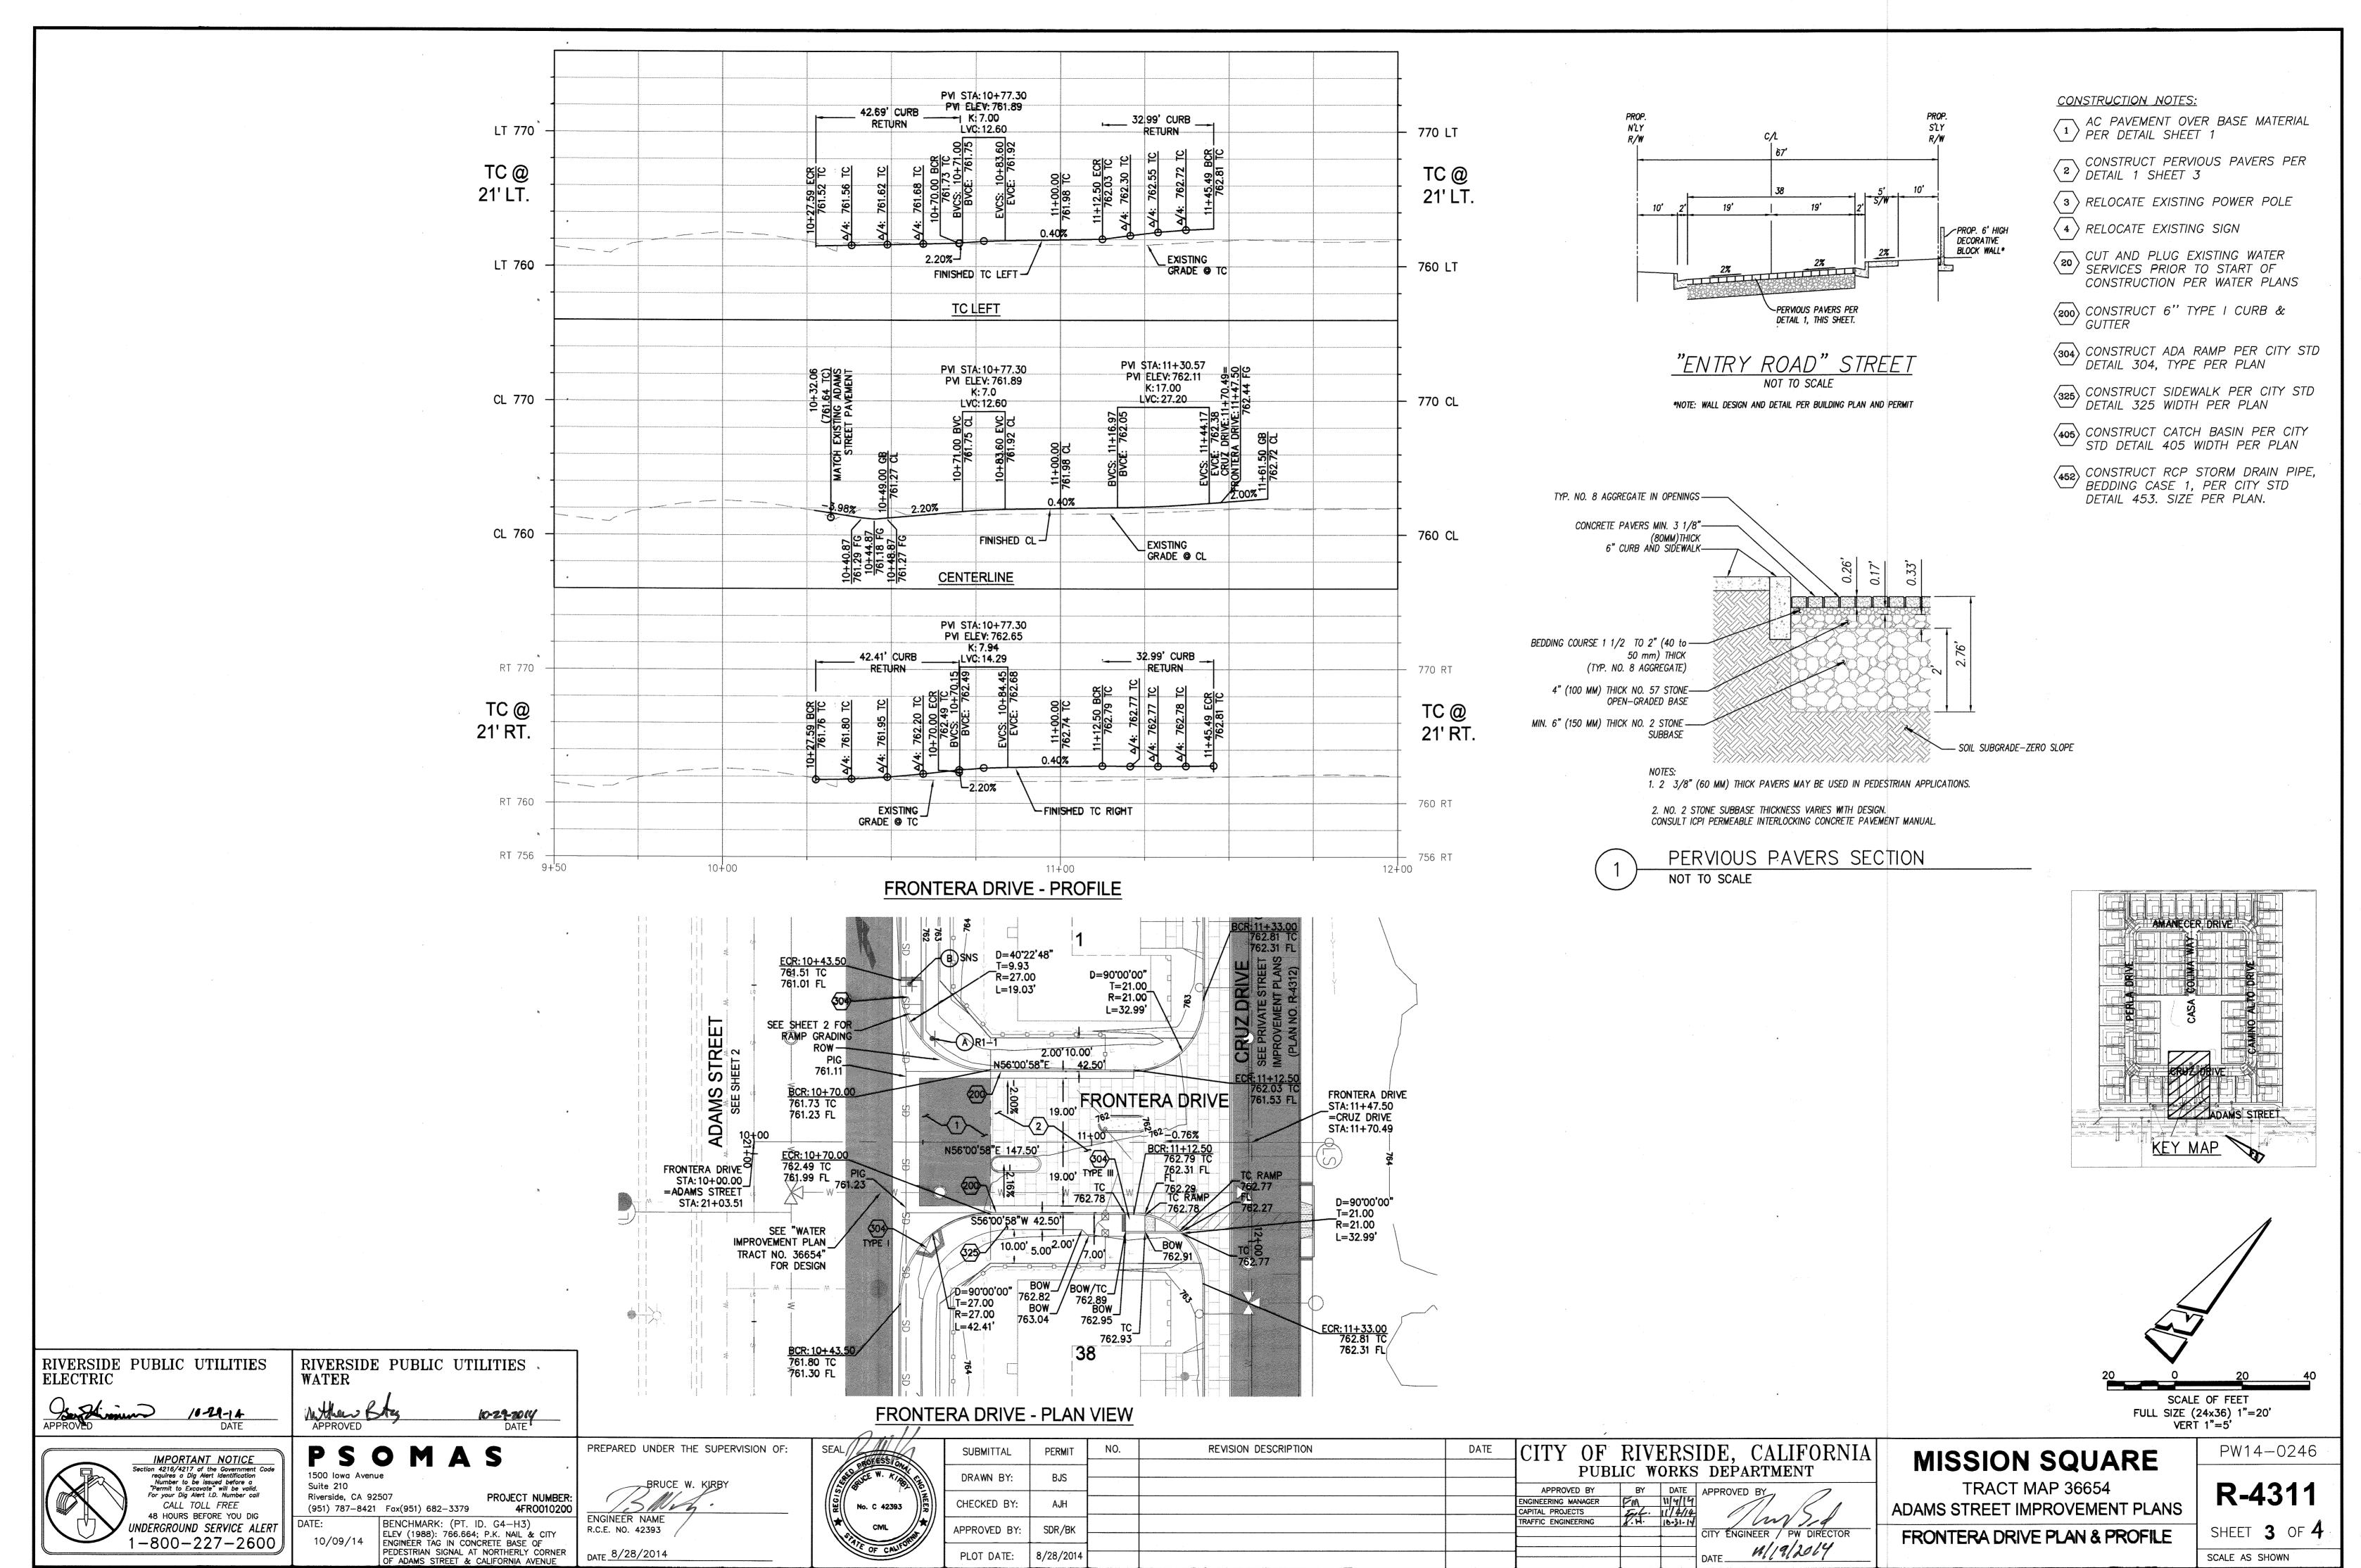

ZV2

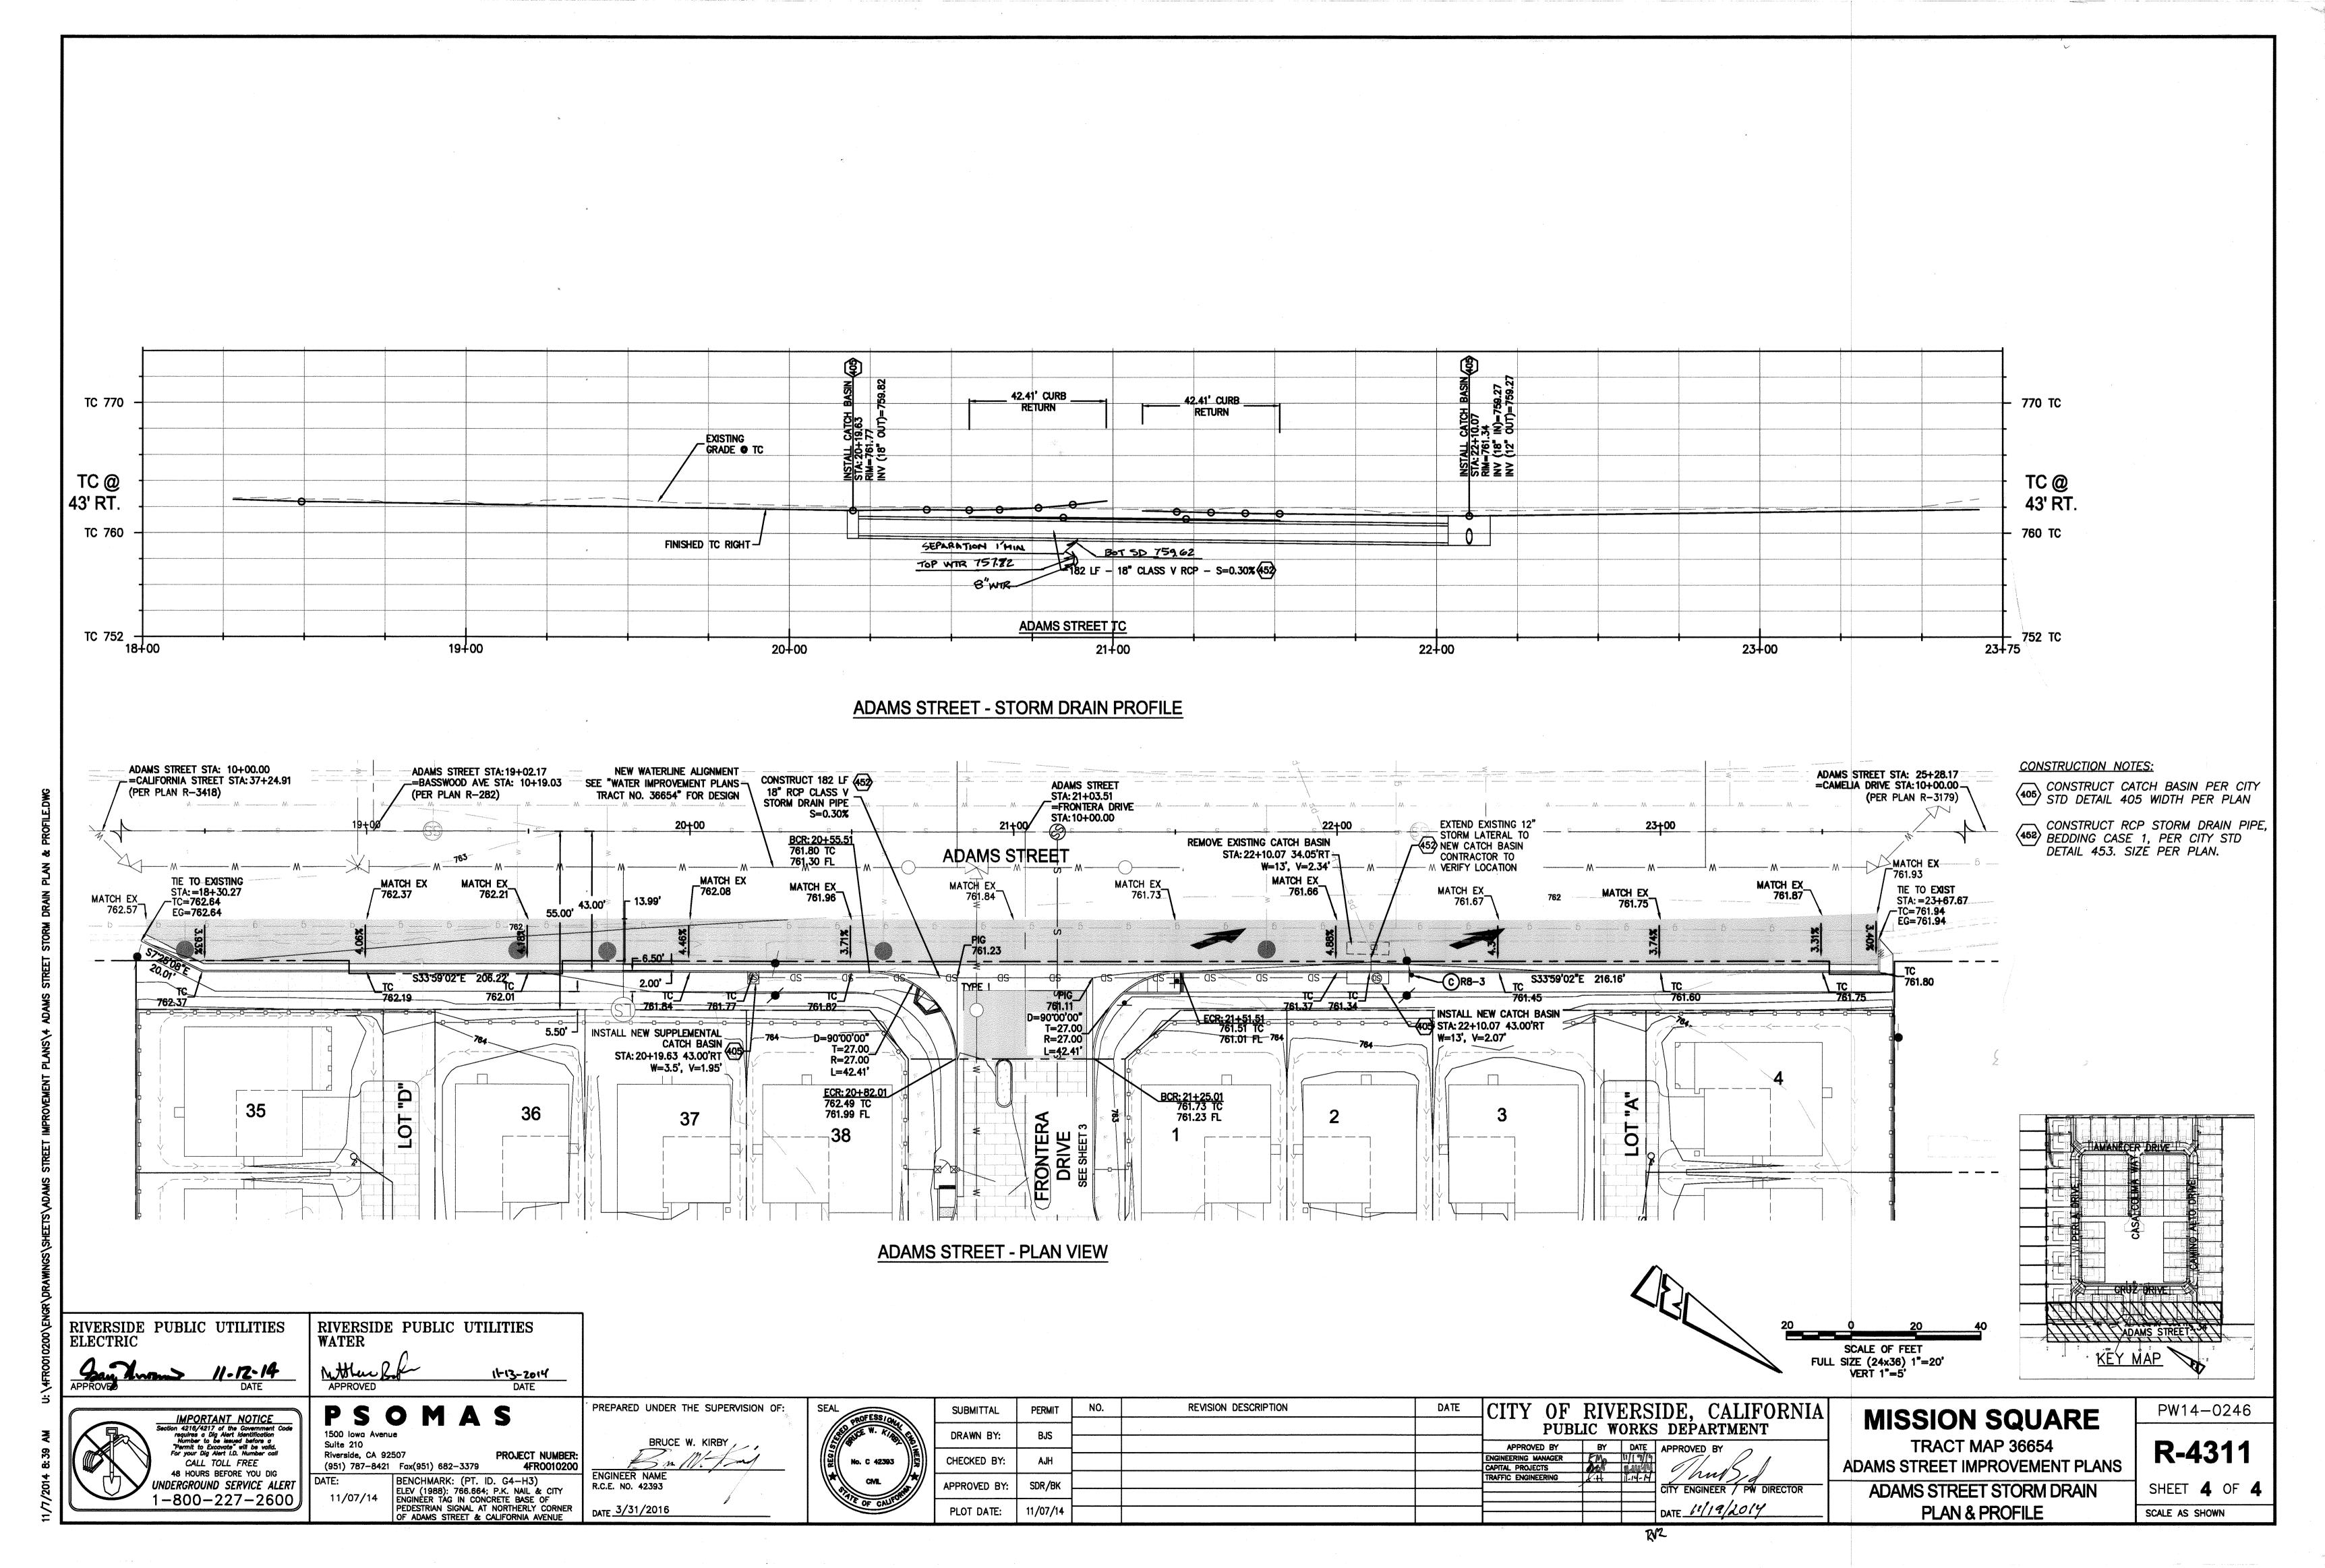


LANDSCAPE ARCHITECTURAL CONSTRUCTION PLANS

TR 36654 "MISSION SQUARE" ADAMS STREET FRONTAGE-HOA MAINTAINED

WITHIN THE CITY OF RIVERSIDE, CA

KEY MAP:

RIVERSIDE PUBLIC UTILITIES- WATER RIVERSIDE PUBLIC UTILITIES-ELECTRIC MM APPROADD

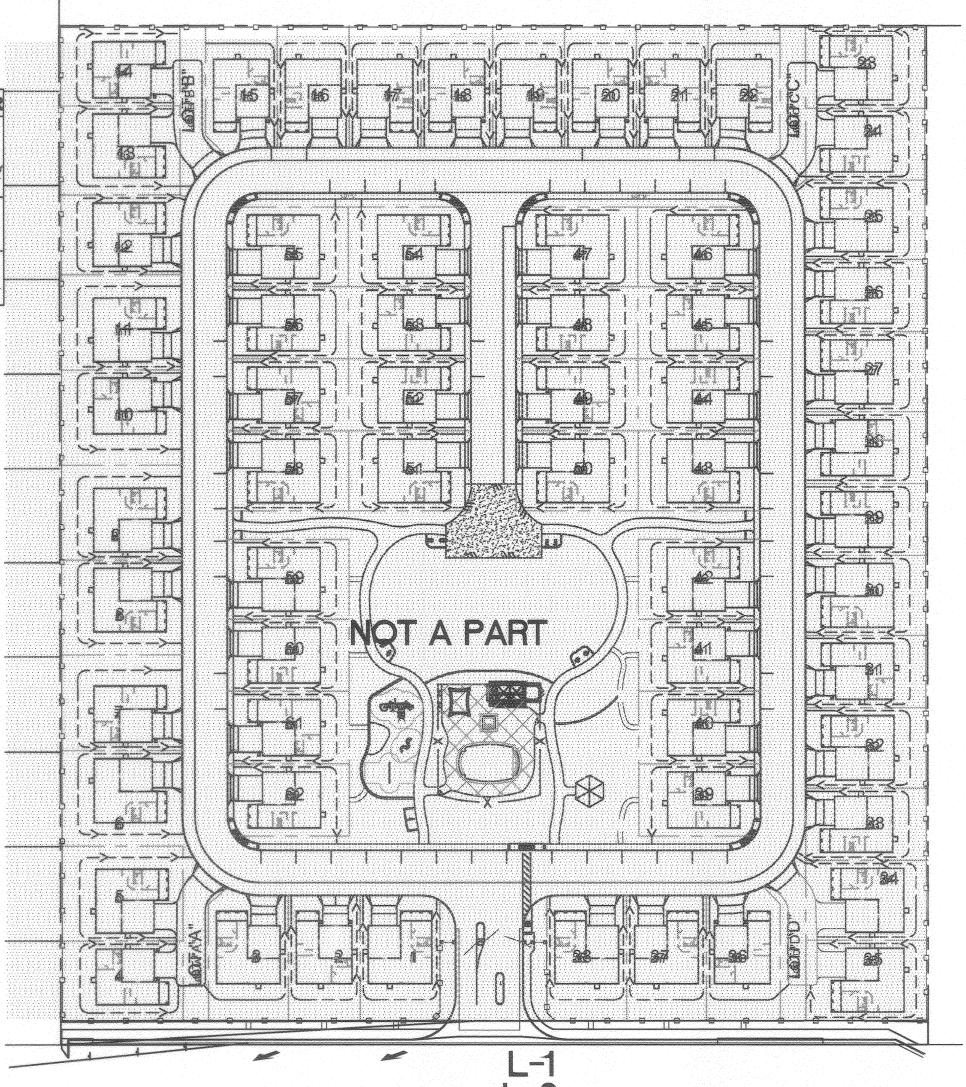

GENERAL NOTES:


- I. BASE INFORMATION INCLUDING THE LOCATION OF PROPERTY LINES, EASEMENTS, BUILDING, ROADS AND CURBS HAVE BEEN TAKEN FROM THE
- 2. REFER TO THE CIVIL ENGINEERS DRAWINGS FOR UTILITY INFORMATION INCLUDING STORM DRAIN, SEWER, WATER, ELECTRICAL, GAS, TELEPHONE
- 3. REFER TO THE CITY AND / OR COUNTY STANDARD PLANS AND SPECIFICATIONS AS
- 4. CONTRACTOR TO VERIFY SITE INFORMATION INCLUDING PROPERTY LINES, TOP AND
- OF SLOPES, ROADWAY CURB AND GUTTERS, UTILITIES AND OTHER INFORMATION
- 5. EXCAVATION IN THE VICINITY OF UTILITIES AND EXISTING MATERIALS SHALL BE UNDERTAKEN WITH GREAT CARE. THE CONTRACTOR BEARS FULL RESPONSIBILITY FOR THIS WORK. ANY DAMAGE CAUSED BY ANY PERSON, VEHICLE, EQUIPMENT, OR TOOL RELATED TO THE EXECUTION OF THE CONTRACT SHALL BE REPAIRED IMMEDIATELY AT NO EXPENSE TO THE OWNER.
- 6. CONTRACTOR SHALL BE RESPONSIBLE FOR ANY COORDINATION WITH SUBCONTRACTORS AS REQUIRED TO ACCOMPLISH ALL CONSTRUCTION OPERATIONS. ALL PIPING, CONDUIT, SLEEVES, ETC., SHALL BE SET IN PLACE PRIOR TO INSTALLATION OF CONSTRUCTION ITEMS.
- 7. CONTRACTOR SHALL NOT WILLFULLY PROCEED WITH CONSTRUCTION AS DESIGNED WHEN IT IS OBVIOUS THAT UNKNOWN OBSTRUCTIONS, AREA DISCREPANCIES AND / OR GRADE DIFFERENCES EXIST THAT MAY NOT HAVE BEEN KNOWN DURING DESIGN. SUCH CONDITIONS SHALL BE IMMEDIATELY BROUGHT TO THE ATTENTION OF THE OWNER'S AUTHORIZED REPRESENTATIVE.
- THE CONTRACTOR SHALL ASSUME FULL RESPONSIBILITY FOR ALL NECESSARY REVISIONS DUE TO FAILURE TO GIVE SUCH NOTIFICATIONS.
- 8. ALL ELECTRICAL JUNCTION BOXES FOR LIGHTS SHALL BE IN PLANTING AREAS. STAKE LOCATION PRIOR TO INSTALLATION.

9. SEE CIVIL ENGINEER'S DRAWINGS FOR CURBS AND A/C PAVING.

10. CONTRACTOR SHALL VERIFY ALL CONDITIONS AND DIMENSIONS AT THE JOB SITE AND NOTIFY ARCHITECT OF ANY DIMENSIONAL ERRORS, OMISSIONS OR DISCREPANCIES BEFORE BEGINNING OR FABRICATING ANY WORK. DO NOT SCALE DRAWINGS.

TOTAL LANDSCAPE AREA= 2,783 S.F. TOTAL IRRIGATED AREA= 2,783 S.F. TOTAL LENGTH OF MOW CURB= N/A **TOTAL STREET TREES=**

VICINTY MAP:

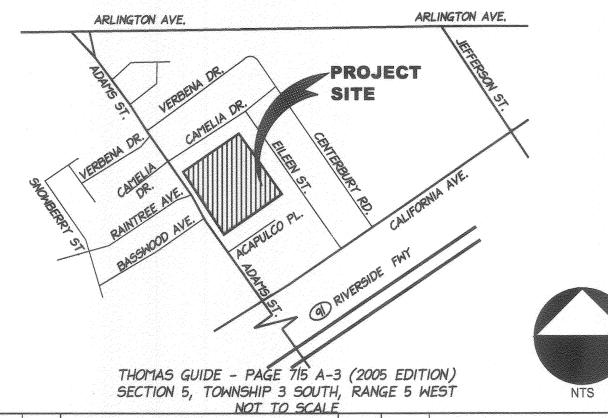

DESIGNED BY CG DRAWN BY CG CHECKED BY CGG

SHEET INDEX:

T-1 TITLE SHEET IRRIGATION PLAN


IRRIGATION DETAILS

PLANTING PLAN

PLANTING DETAILS

L-5 PLAN SPECIFICATIONS AND WATER CALCULATIONS



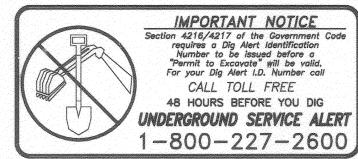

PUBLIC WORKS DEPARTMENT BY DATE APPROVED BY APPROVED BY

PW Trees

·H 10.31.14


TITLE SHEET HORIZONTAL SCALE: AS SHOWN

T-1SHEET 1 OF 6


PW 14-0248


R-4311-I

CITY OF RIVERSIDE, CALIFORNIA TR 36654; MISSION SQUARE ADAMS ST. FRONTAGE

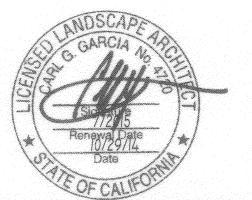


LANDSCAPE ARCHITECTURE / SITE PLANNING 5225 CANYON CREST DRIVE, STE 71, PMB 281. RIVERSIDE, CA 92507 PHONE: 951.788.0277 FAX: 951.788.0288 www.gdalandarch.com

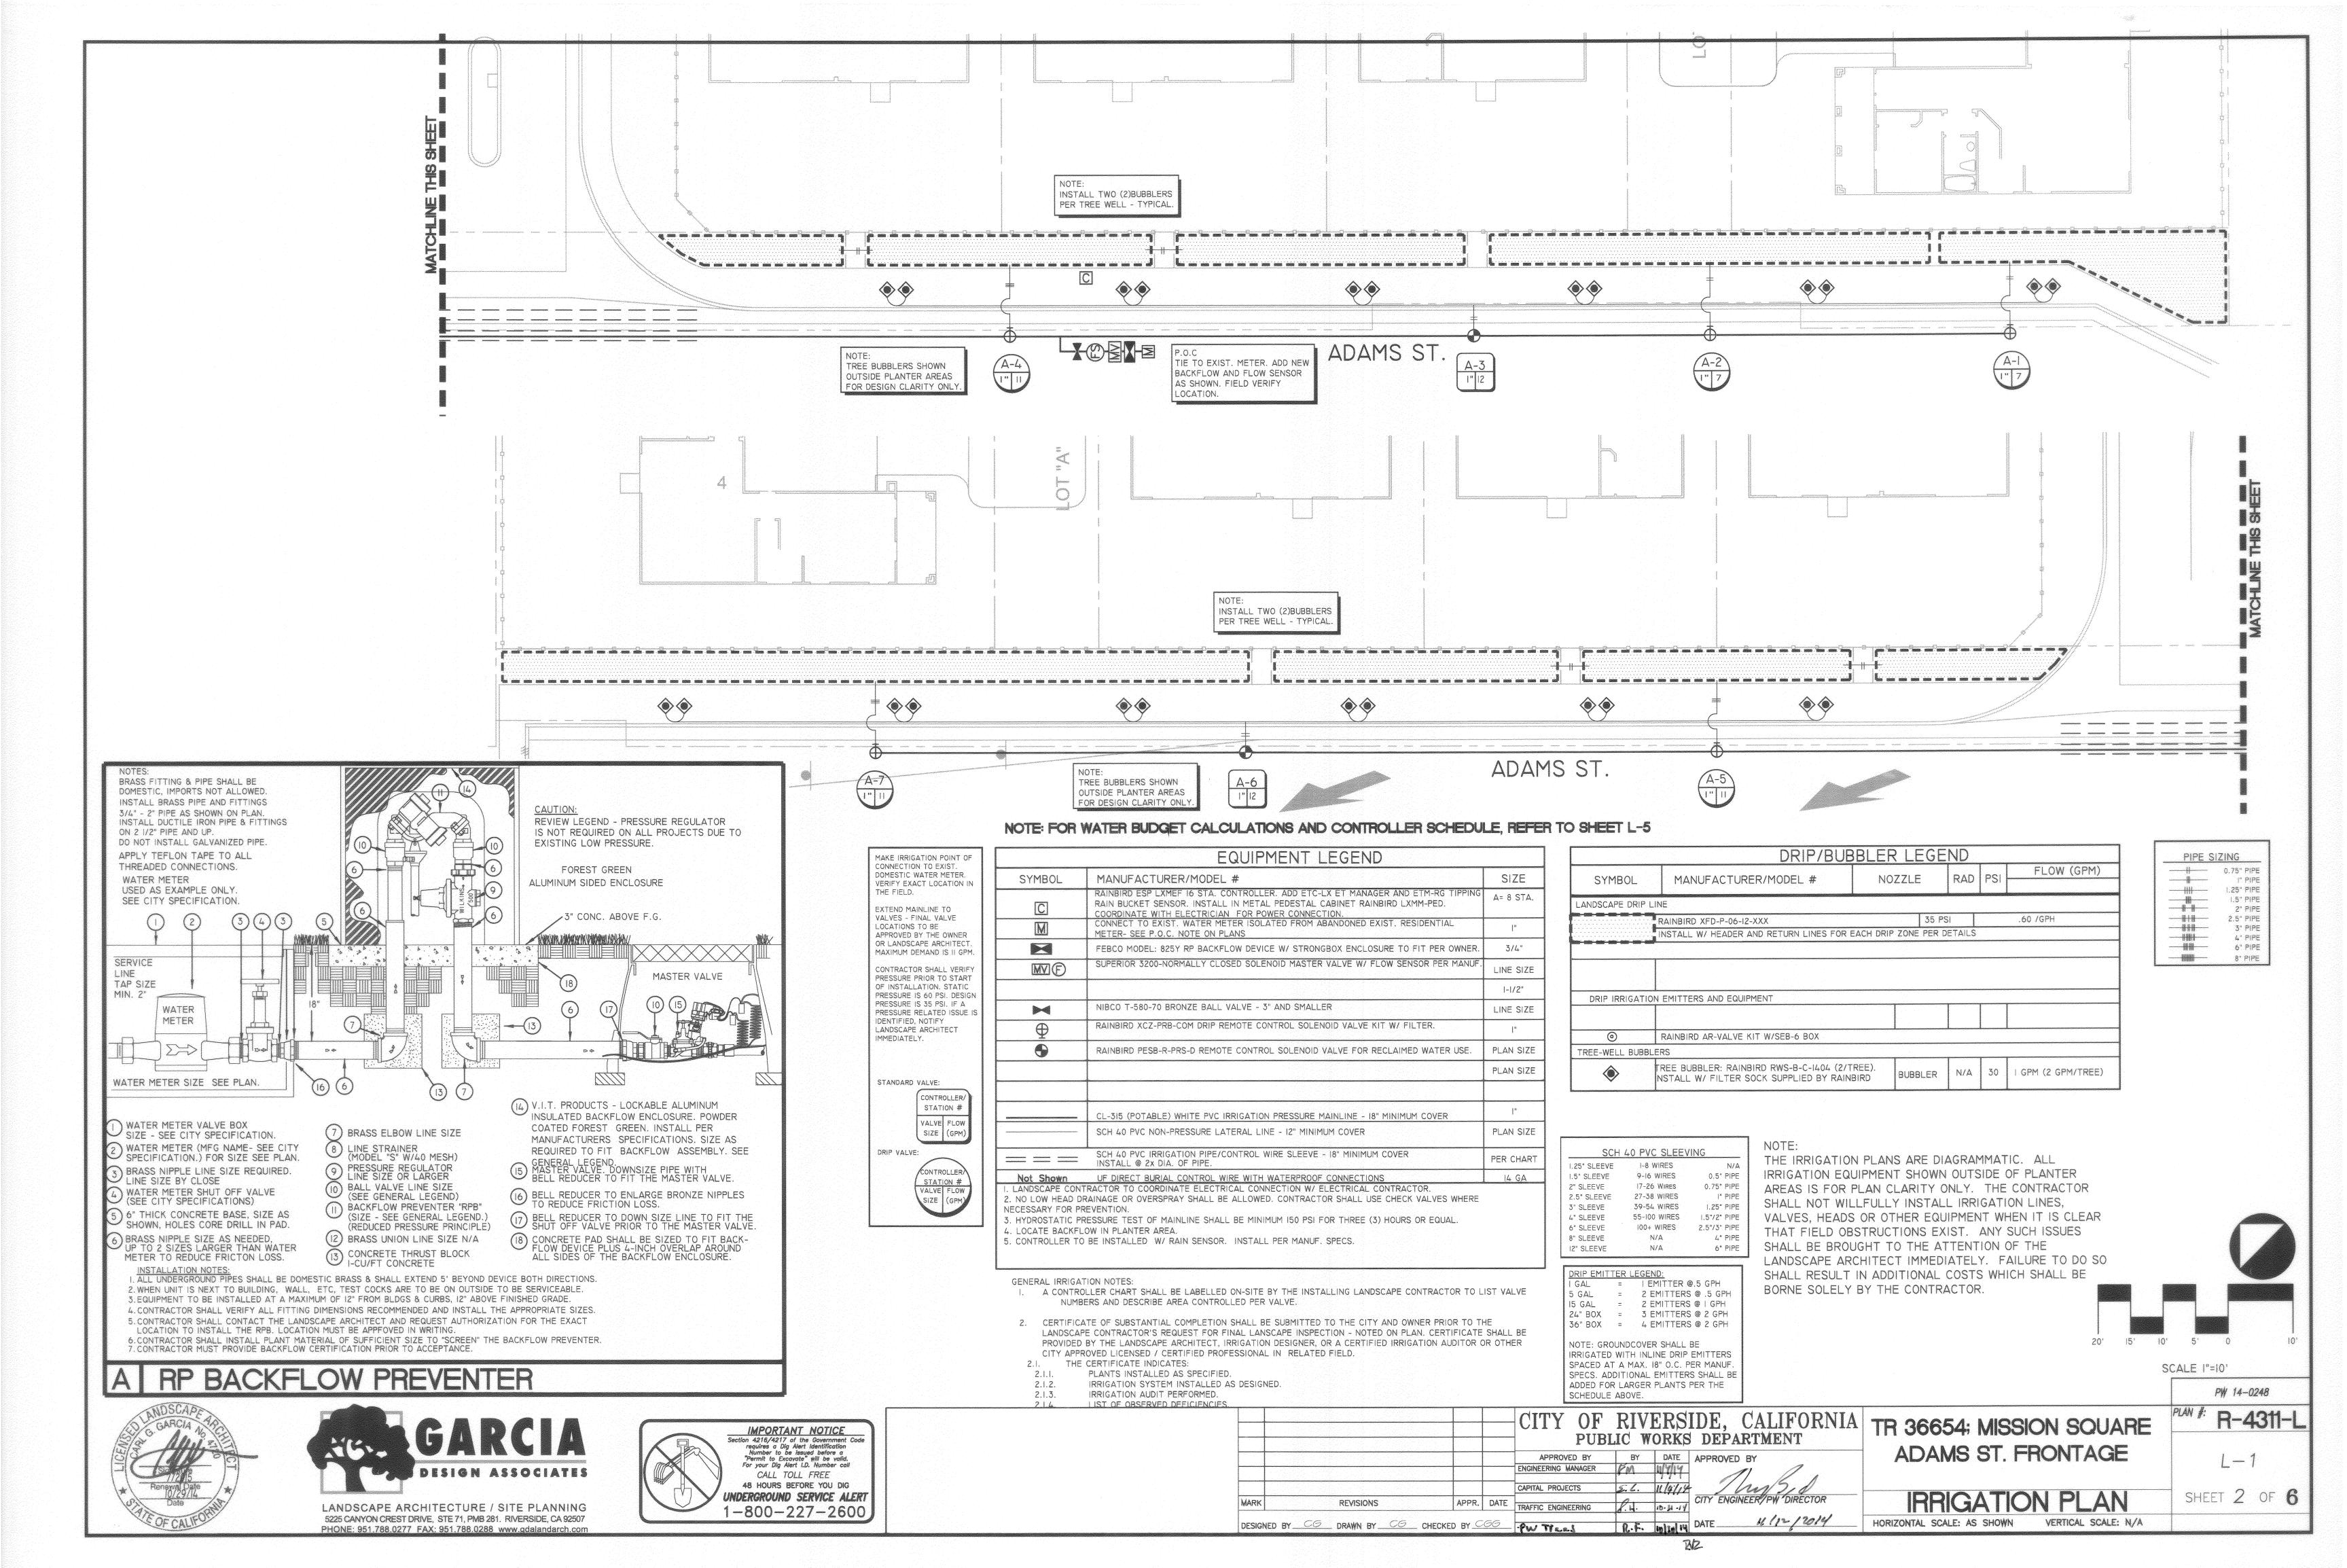

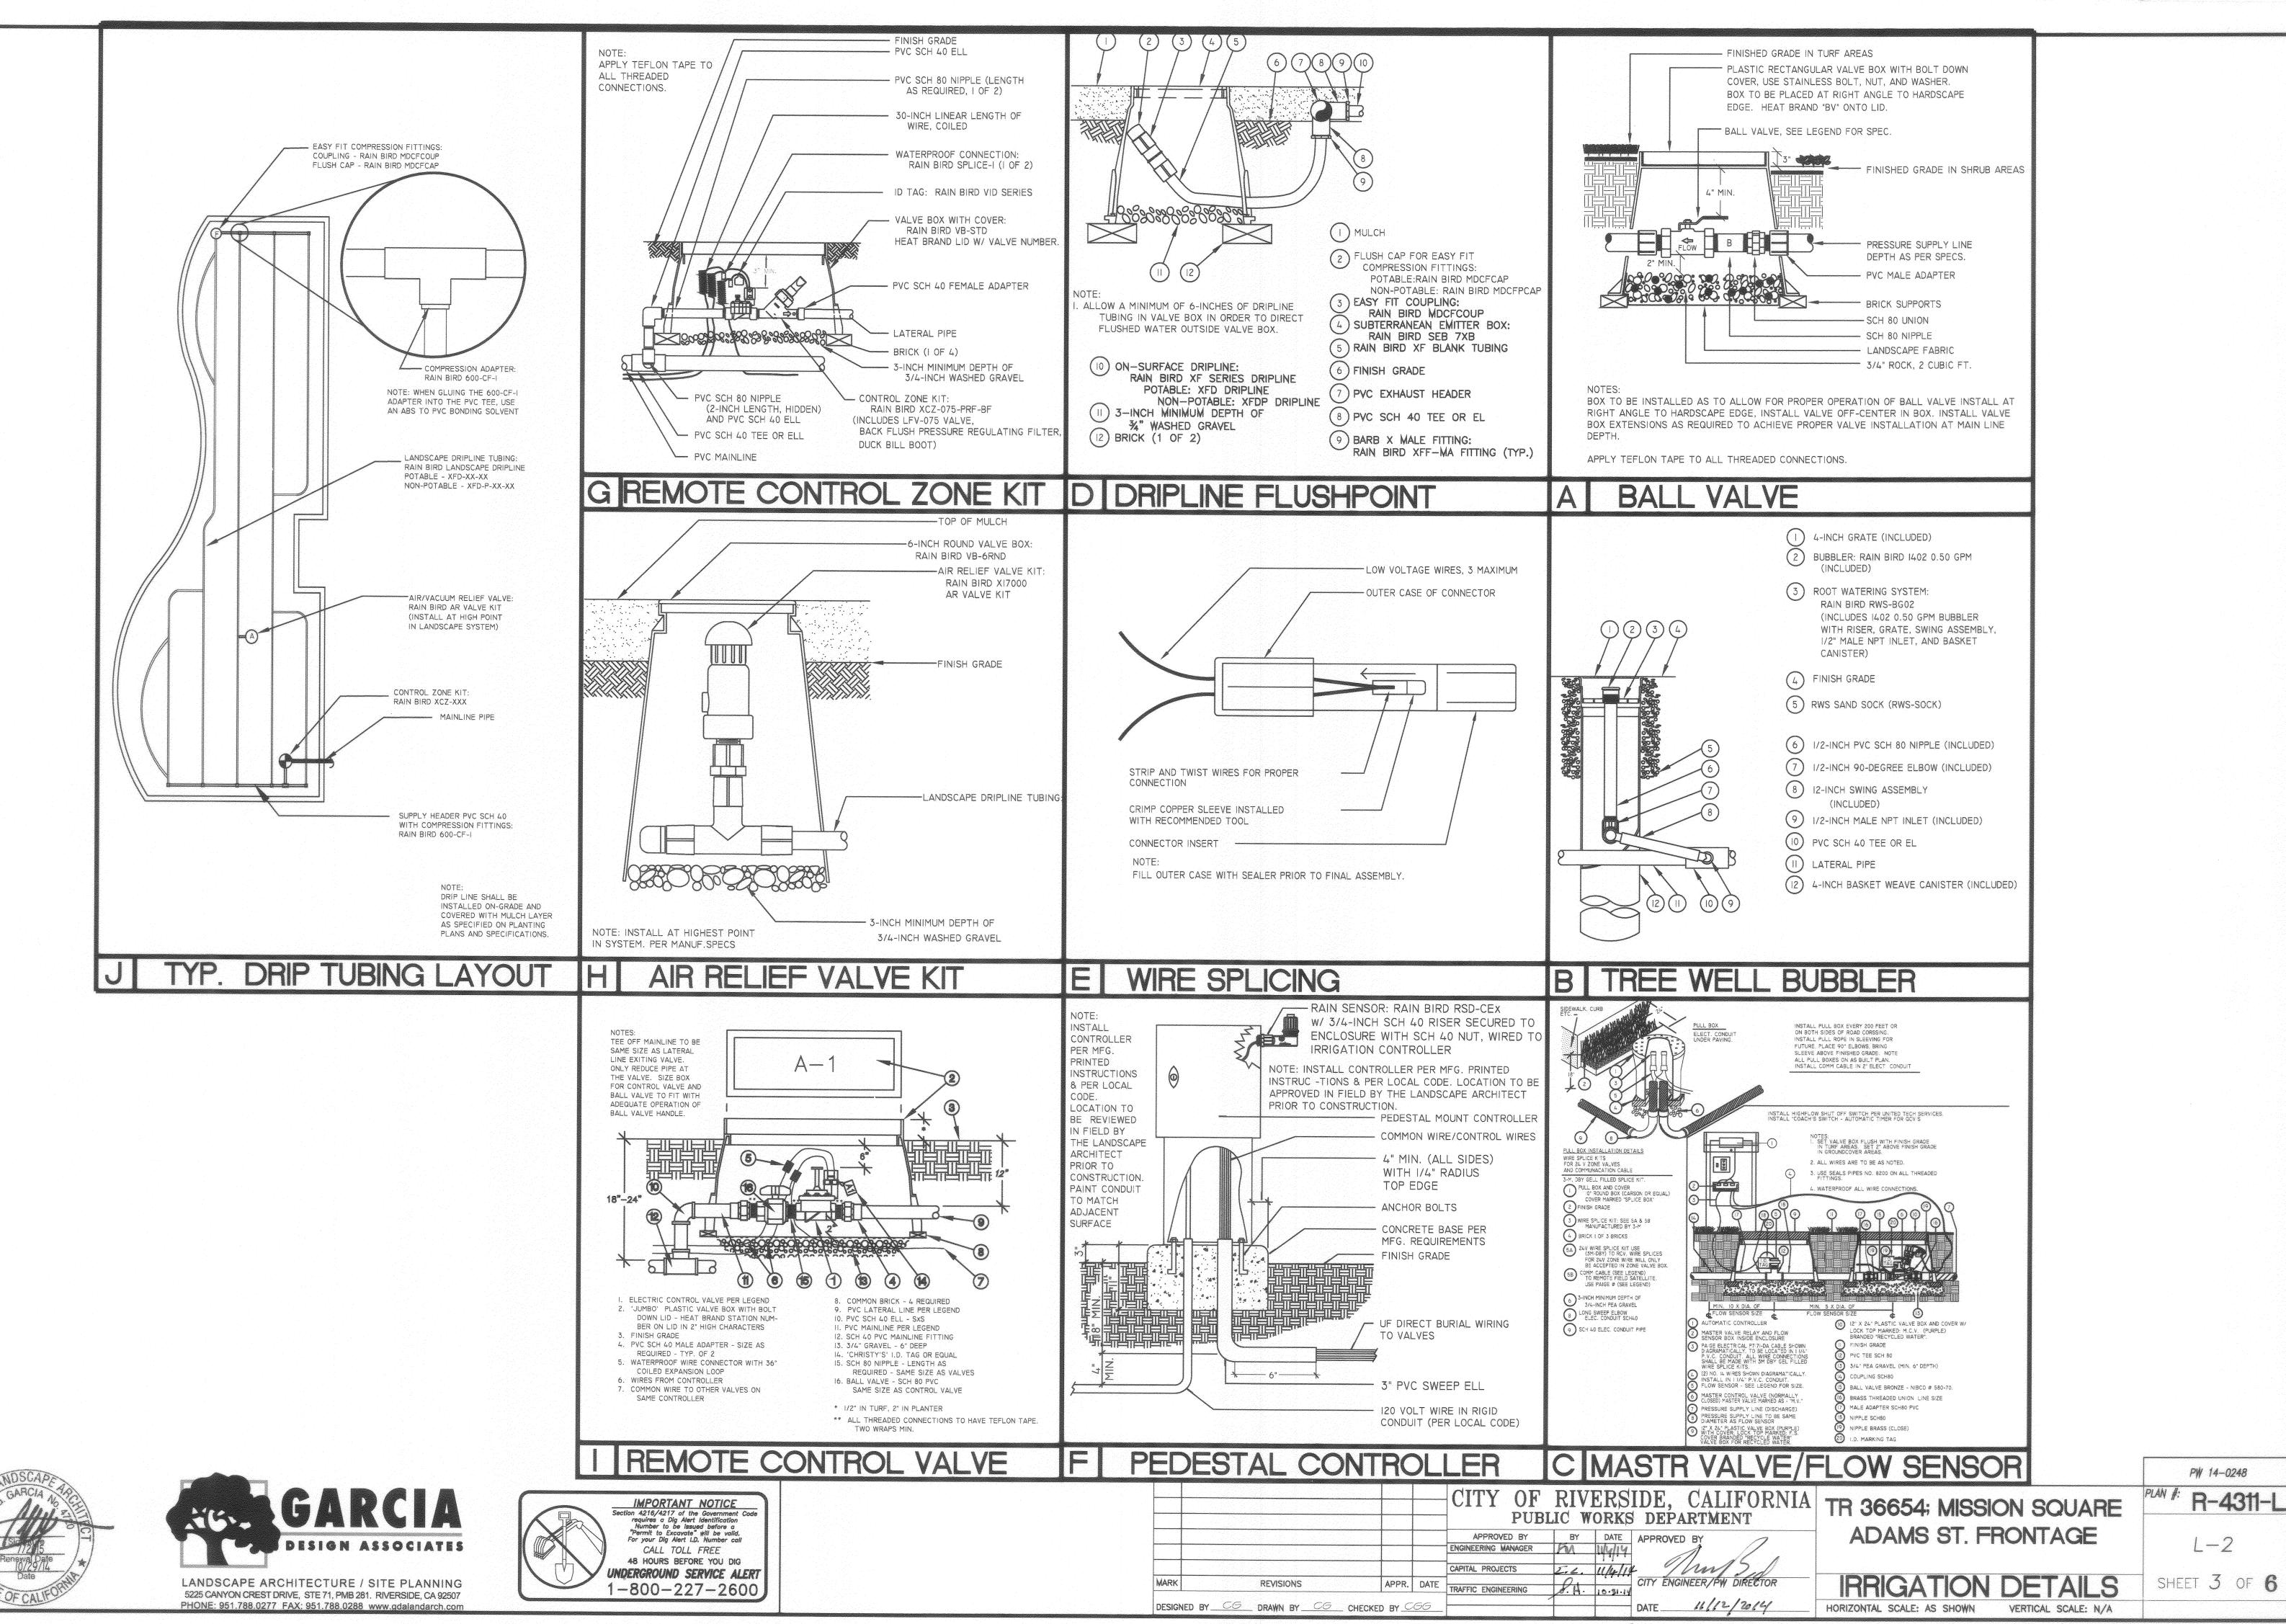



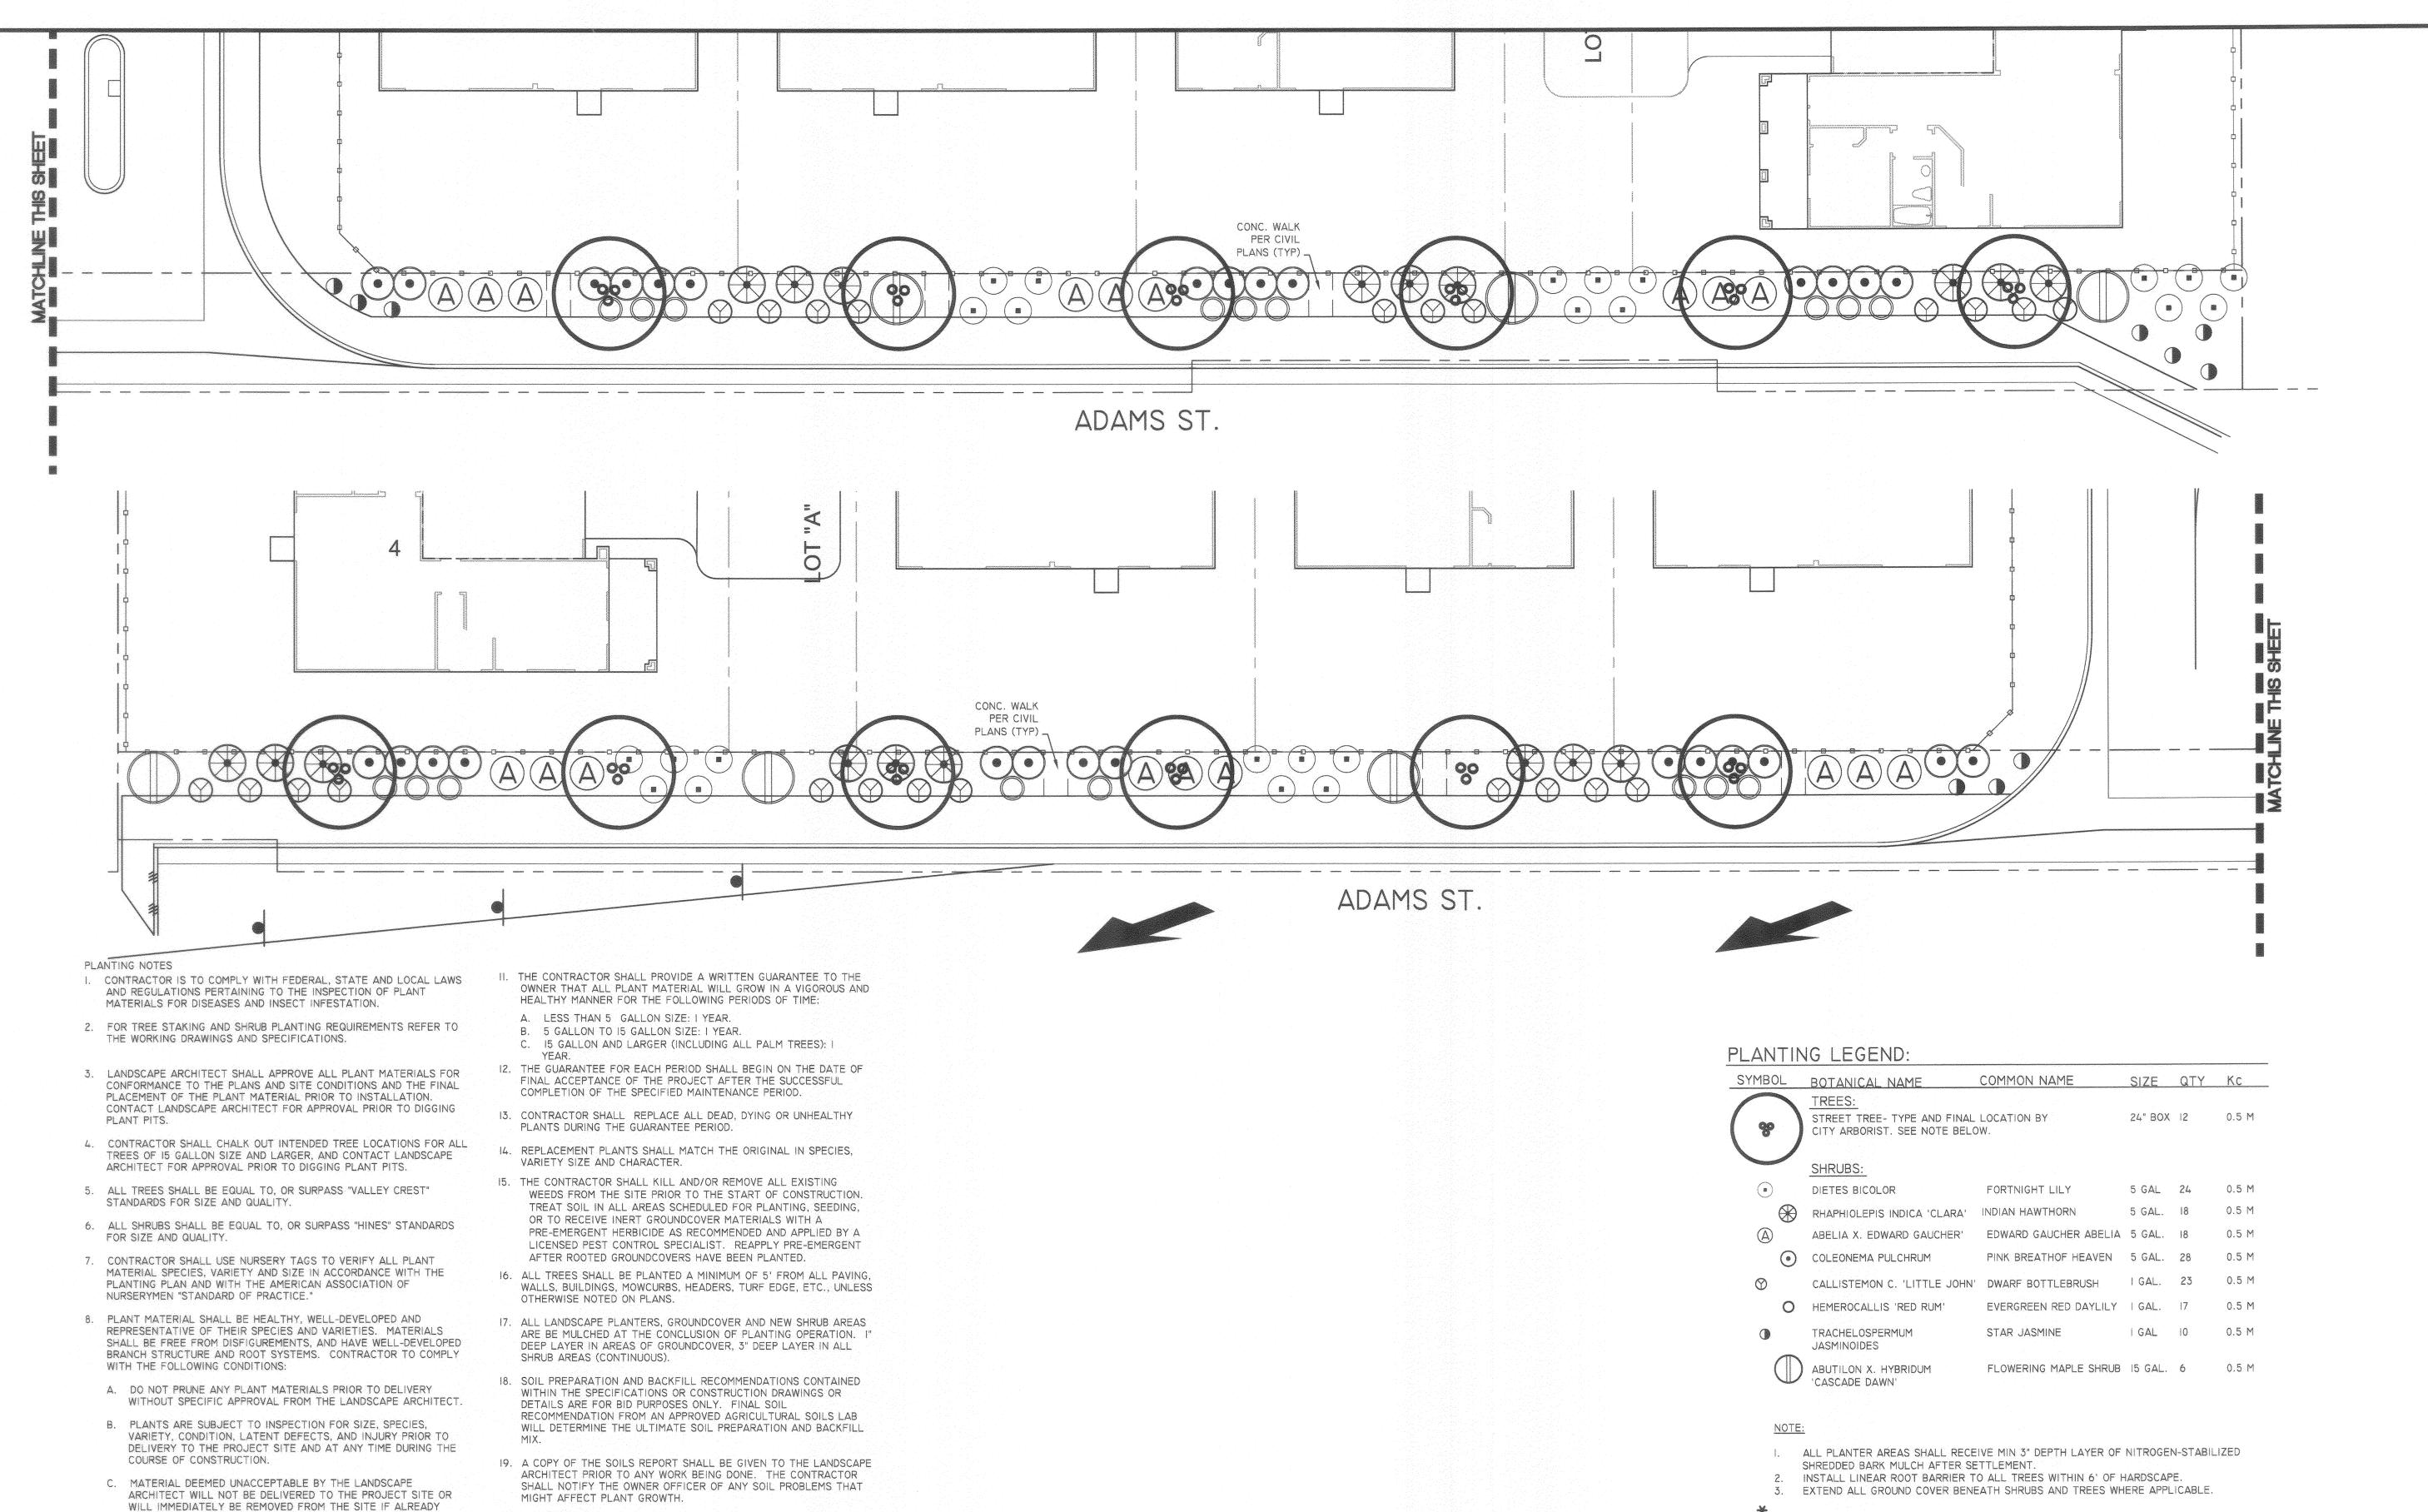

20' 15' 10' 5' 0

SCALE I"=10'

PW 14-0248

PLAN #: R-4311-I

SHEET 4 OF 6

PLANTING PLAN VERTICAL SCALE: N/A

ADAMS ST. FRONTAGE

LANDSCAPE ARCHITECTURE / SITE PLANNING

5225 CANYON CREST DRIVE, STE 71, PMB 281. RIVERSIDE, CA 92507

PHONE: 951.788.0277 FAX: 951.788.0288 www.gdalandarch.com

IMPORTANT NOTICE CALL TOLL FREE 48 HOURS BEFORE YOU DIG 1-800-227-2600

BUT BEFORE PLANTING HOLES ARE EXCAVATED. WHEN PLANTING AND ALL OTHER INDICATED OR SPECIFIED 10. IF A SPECIFIED PLANT SPECIES OR VARIETY IS NOT OBTAINABLE, THE WORK HAS BEEN COMPLECTED.

A. INSPECTIONS WILL BE REQUIRED.

SOIL PREPARATION WORK.

20. INSPECTIONS:

4. AT START OF PLANT ESTABLISHMENT PERIOD. 5. AT END OF PLANT ESTABLISHMENT PERIOD, PRIOR TO FINAL ACCEPTANCE OF THE PROJECT FOR MAINTENANCE.

B. THE CONTRACTOR SHALL CONTACT THE LANDSCAPE ARCHITECT


AT LEAST 48 HOURS (2 WORKING DAYS) IN ADVANCE OF AN

I. AT COMPLETION OF FINISH GRADING WORK FOLLOWING

2. WHEN CONTAINER PLANTS ARE SPOTTED FOR PLANTING.

ANTICIPATED INSPECTIONS REQUIRED AT EACH OF THE STEPS

Section 4216/4217 of the Government Code requires a Dig Alert Identification Number to be issued before a "Permit to Excayate" will be valid, For your Dig Alert I.D. Number call UNDERGROUND SERVICE ALERT

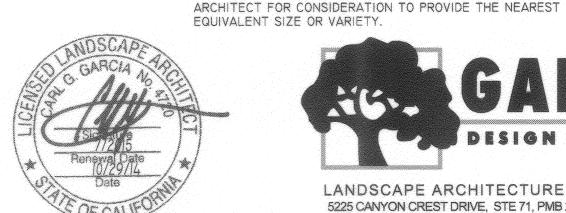

DELIVERED.

LANDSCAPE ARCHITECT.

ARCHITECT'S PRIOR WRITTEN APPROVAL.

D. CONTRACTOR SHALL BE PREPARED TO SHOW THAT PLANT

3. LANDSCAPE ARCHITECT RESERVES THE RIGHT TO TAG ALL PLANT MATERIALS AT THE NURSERY CHOSEN FOR USE ON THE PROJECT.

9. SUBSTITUTIONS WILL NOT BE PERMITTED WITHOUT THE LANDSCAPE

CONTRACTOR MAY SUBMIT A PROPOSAL TO THE LANDSCAPE

MATERIAL IS NOT ROOT BOUND TO THE SATISFACTION OF THE



REVISIONS

DESIGNED BY CG DRAWN BY CG CHECKED BY CGG

PUBLIC WORKS DEPARTMENT BY DATE APPROVED BY APPROVED BY [PA 11/4/14 E.L. 111/114 CITY ENGINEER/PW DIRECTOR APPR. DATE TRAFFIC ENGINEERING 8.4. 10.31.14

METHOD OF CONTACT) GTANAKA@RIVERSIDECA.GOV

I. FINAL STREET TREE SELECTION AND LOCATION SHALL BE PER THE CITY ARBORIST.


CONTACT THE STREET TREE DIVISION, GUY TANAKA (951) 351-6313 (EMAIL IS BEST


CITY OF RIVERSIDE, CALIFORNIA TR 36654; MISSION SQUARE

STREET TREE NOTE:

PWTFALL

HORIZONTAL SCALE: AS SHOWN

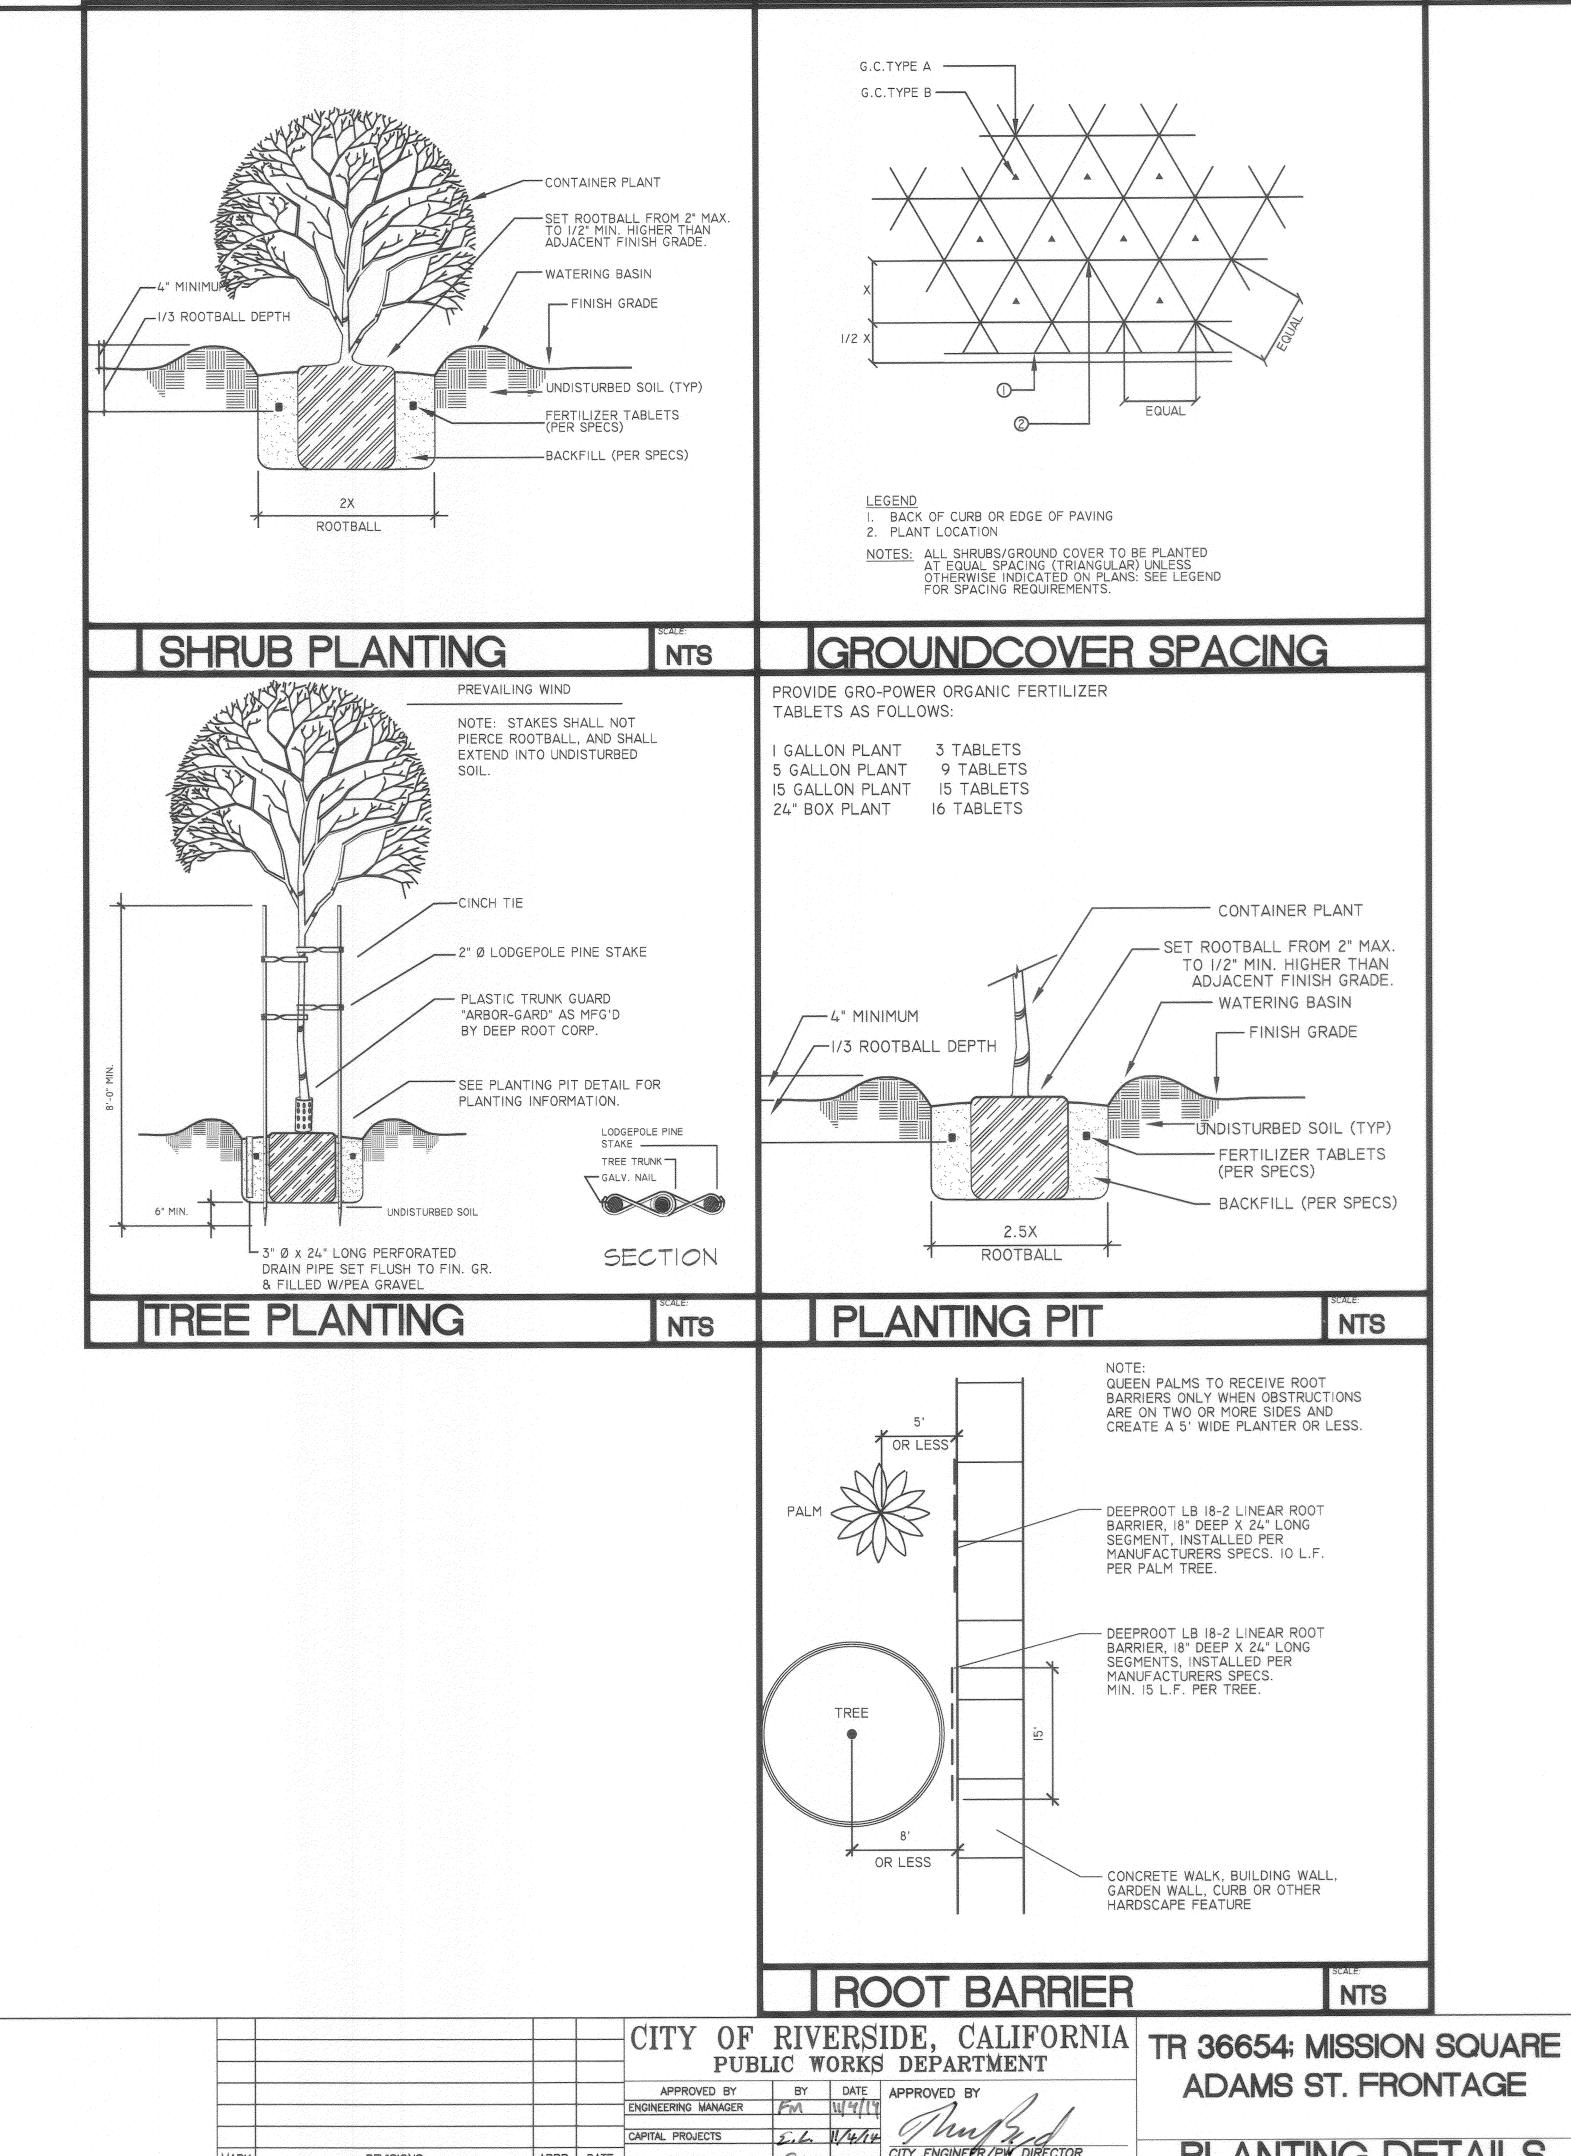

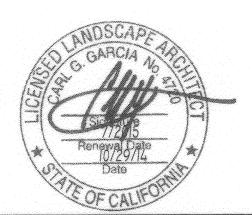



5225 CANYON CREST DRIVE, STE 71, PMB 281. RIVERSIDE, CA 92507

PHONE: 951.788.0277 FAX: 951.788.0288 www.gdalandarch.com



NED BY CG DRAWN BY CG CH	IFOUED BY	66	PW Trees	-	 1	DATE 1:11 4/2014
REVISIONS	APPR.	DATE	TRAFFIC ENGINEERING	J2H	18-31-14	
			CAPITAL PROJECTS	2.6.	11/4/14	CITY ENGINEER/PW DIRECTOR
			ENGINEERING MANAGER	PM		Ma de l
			APPROVED BY	BY	DATE	APPROVED BY
			PUB	LIC W	DEPARIMENT	
			CITY OF	KIV	EKS	IDE, CALIFORNIA
				PUB APPROVED BY ENGINEERING MANAGER CAPITAL PROJECTS REVISIONS APPR. DATE TRAFFIC ENGINEERING	PUBLIC W APPROVED BY BY ENGINEERING MANAGER FM CAPITAL PROJECTS 2.6. REVISIONS APPR. DATE TRAFFIC ENCINEERING DIL	REVISIONS ENGINEERING MANAGER CAPITAL PROJECTS E.L. 11/4/14 TRAFFIC ENGINEERING REVISIONS TRAFFIC ENGINEERING

L-4

PLANTING DETAILS

SHEET 5 OF 6

PW 14-0248

PLAN #: R-4311-L

WATER BUDGET CALCS

TR 36654 ADAMS ST. FRONTAGE

Eto	56.65		(Riverside)
Conv. Factor (Gals)	0.62		
ET Adjustment	0.70		
TLA	2,783	sf	
Special Land Area	0.00		x .3 (SLA adjustment)

Hydrozone #1	FRONT PLN	IR .	
Eto	56.65	atengget entit få sene sen speri sinne sen	andianaplian pappana
Conversion factor	0.62		
Crop Coefficient	0.50		
Hydrozone Area	2,783		
Irrigation Efficiency	0.90		
Special Land Area	0.00		
ETWU=	54,304		
TOTAL FOR ALL H	YDROZONE	S:	e din en mangen mei var van e malemannen en en period de din en malemannen en
Hydrozone #1	54,304		

INITIAL IRRIGATION SCHEDULE BY STATION

Controller Identification: A

Station 1 Program: A	JAN	==== FEB	MAR	==== APR	==== MAY	JUN	==== JUL	==== AUG	==== SEP	==== OCT	NOV	=== DE(
Minutes Per Cycle: Cycles Per Day:	1	5 1	1	9	10	11 1	12 1	11 1	9	1	5 1	
Days To Skip: Available Days Per Week:	7	7	7	7	7	7	7	7	7	7	7	
Precipitation Rate: 0.64												
		±=====================================	==== :	===:	=====	====:	=====	====			ania dalima impatra salamin sa Managaran aniana panasa in	and place should
Station 2 Program: A	JAN	FEB	MAR	APR	MAY	JUN	JUL	AUG	SEP	OCT	NOV	DE(
Minutes Per Cycle:	4	5	7	9	10	11	12	11	9	7	5	
Cycles Per Day: Days To Skip:	1.	上	1	1	1	1	1	1	1	1	1	
Available Days Per Week:	7	7	7	- 7	7	7	7	7	7	7	7	
Precipitation Rate: 0.64												
Station 3 Program: A												
	JAN	FEB	MAR	APR	MAY	JUN 	JUL 	AUG	SEP	OCT	NOV	DE
Minutes Per Cycle:	5 1	6 1	8	11	12 1	13 1	14	14 1	11 1	8 1	6 1	
Cycles Per Day: Days To Skip:	Ī	.	1	1	•				1	1	1	
Available Days Per Week:	7	7	7	7	7	7	7	7	7	7	7	
Precipitation Rate: 0.60		prince making majakan spinasa sa	entique material principa, deligible material histograph proposal histograph	minima spinning specific spinjene spinj	Salaring species, register, observe, a	opposit Jampson Statuter distalace	position, militaries representa superator, se propriora respositare representa antiquanta per	islando salarem lagrada, sipopo se manga lagrada jangka, nganam ja	alaine median sanjan sahana	ining sector proper visions	charle minister invested manager to	nejmin samutai menana alauta salautai pilinine
Station 4 Program: A	JAN	FEB	MAR	APR	MAY	JUN	JUL	AUG	SEP	OCT	NOV	DE
Minutes Der Cycles				9	 10	 11	12	 11		 7	 5	
Minutes Per Cycle: Cycles Per Day: Days To Skip:	1	1	1	1	1	1	1	1	1	1	1	
Available Days Per Week:	7	7	7	7	7	7	7	7	7	7	7	
Precipitation Rate: 0.64				منجند معتدر والمعادر والمعادر والمعادر								wing wide state
Station 5 Program: A		-	Account and the second second	and the same country								
	JAN	FEB	MAR	APR	MAY	JUN 	JUL 	AUG	SEP	OCT	NOV	DE
Minutes Per Cycle:	4			9	10	11	12	11	9	7	5	
Cycles Per Day: Days To Skip:	1	1	1	1	1	Ţ	1	1	1	1	1	
Available Days Per Week:	7.	7	7	7	7	7	7	7	7	7	7	
Precipitation Rate: 0.64												
Station 6 Program: A												
	JAN	FEB	MAR 	APR 	MAY	UUU 	JUL 	AUG 	SEP 	OCT	NOV	DE
Minutes Per Cycle:	5	6 1		11 1	12 1	13	14 1	14 1	11 1		6 1	
Cycles Per Day: Days To Skip:												
Available Days Per Week:	7	7	7	7	7	7	7	7	7	7	7	
Precipitation Rate: 0.60	D. AND THE CONTROL OF T	popular anno de la compania antigo de la compania del compania de la compania del compania de la compania del compania de la compania del compania de la compania del compania	Alberta Street, Street,	consigler ministeria constante speciment megistrati, scoppina, sectoralis, subsenia,					ingini angkar garang, nakari			
Station 7 Program: A	JAN	FEB	MAR	APR	MAY	JUN	JUL	AUG	SEP	OCT	NOV	DE
Minutes Per Cycle:	4	 5	-	 9	 10	 11	12	 11	a	 7	 5	
Cycles Per Day:		1			1		1			1	1	
Days To Skip: Available Days Per Week:	7	7	7	7	7	7	7	7	7	7	7	
Precipitation Rate: 0.64												

NOTE: THIS IRRIGATION SCHEDULE IS MEANT TO BE USED AS A GUIDELINE ONLY, AND DOES NOT TAKE THE PLACE OF PROPER, ONGOING SYSTEM MANAGEMENT. DIFFERING SITE AND CLIMATIC CONDITIONS MAY REQUIRE ADJUSTMENTS NOT REFLECTED IN THIS SCHEDULE.

01000 GENERAL REQUIREMENTS

A. CONTRACTOR'S DUTIES: I. EXCEPT AS SPECIFICALLY NOTED, PROVIDE AND PAY FOR: A. LABOR, MATERIALS AND EQUIPMENT.

B. TOOLS, CONSTRUCTION EQUIPMENT AND MACHINERY. C. WATER, HEAT, AND UTILITIES REQUIRED FOR CONSTRUCTION. D. OTHER FACILITIES AND SERVICES NECESSARY FOR PROPER EXECUTION AND COMPLETION OF WORK.

3. SECURE AND PAY FOR, AS NECESSARY FOR PROPER EXECUTION AND COMPLETION OF WORK, AND AS APPLICABLE AT TIME OF RECEIPT OF BIDS: A. PERMITS.

2. PAY LEGALLY REQUIRED SALES, CONSUMER, AND USE

B. GOVERNMENT FEES. c. LICENSES. 4. GIVE REQUIRED NOTICES.

02441 LANDSCAPE IRRIGATION SYSTEM

A. DUE TO THE SCALE OF THE DRAWINGS, IT IS NOT POSSIBLE TO INDICATE ALL OFFSETS, FITTINGS, SLEEVES AND OTHER COMPONENTS WHICH MAY BE REQUIRED. CAREFULLY INVESTIGATE THE STRUCTURAL AND FINISHED CONDITIONS AFFECTING THE WORK AND PLAN ACCORDINGLY. FURNISH SUCH FITTINGS AND COMPONENTS AS MAY BE REQUIRED TO MEET SUCH CONDITIONS. DRAWINGS ARE GENERALLY DIAGRAMMATIC AND INDICATIVE OF THE WORK TO BE INSTALLED. INSTALL THE WORK IN SUCH A MANNER AS TO AVOID CONFLICTS BETWEEN IRRIGATION SYSTEM, PLANTING, AND ARCHITECTURAL FEATURES. EQUIPMENT SHOWN IN PAVED AREAS IS FOR DESIGN CLARIFICATION ONLY. INSTALL SUCH EQUIPMENT WITHIN PLANTED AREAS WHEREVER POSSIBLE.

B. DO NOT WILLFULLY INSTALL THE IRRIGATION SYSTEM AS SHOWN ON THE DRAWINGS WHEN IT IS OBVIOUS IN THE FIELD THAT UNKNOWN OBSTRUCTIONS, GRADE DIFFERENCES OR DISCREPANCIES IN AREA DIMENSIONS EXIST THAT MIGHT NOT HAVE BEEN CONSIDERED DURING ENGINEERING.

C. RECORD AND AS-BUILT DRAWINGS: PROVIDE OWNER WITH REPRODUCIBLE SET OF "AS-BUILT DRAWINGS."

D. GUARANTEE: GUARANTEE THE LANDSCAPE IRRIGATION SYSTEM FOR A PERIOD OF ONE YEAR. PROVIDE A WRITTEN GUARANTEE IN THE FORM AS STIPULATED IN THE GENERAL CONDITIONS.

*NOTE- ALL PVC TO BE NON-POTABLE "PURPLE PIPE" 1. INSTALL PVC PLASTIC PIPE AND FITTINGS BELOW GRADE.

2. PVC PIPE: NSF-APPROVED TYPE I, GRADE I COMPOUND CONFORMING TO ASTM D 1784. 3. PVC SCHEDULE 40 AND SCHEDULE 80 PIPE: ASTM D 1785 AND ASTM D 2466.

4. PVC CLASS 160, CLASS 200, AND CLASS 315 SOLVENT WELD AND RING-TIGHT PIPE: ASTM D 2241. 5. PVC SOLVENT CEMENT: ASTM D 2564.

6. PVC CONSTANT PRESSURE MAIN LINE PIPING TWO INCHES AND LARGER: RUBBER-RING JOINT, OR SOLVENT WELD JOINT, PVC CLASS 315. 7. PVC CONSTANT PRESSURE MAIN LINE PIPING 1-1/2

SCHEDULE 40. 8. PVC INTERMITTENT PRESSURE LATERAL LINE PIPING: SOLVENT WELD, JOINT, PVC CLASS 200, SCHEDULE 40.

INCHES AND SMALLER: SOLVENT WELD JOINT, PVC

9. PVC FITTINGS: PVC SCHEDULE 40 SOLVENT WELD AND FACTORY MANUFACTURED, OF SCHEDULE 40 WITH RUBBER-RING JOINT.

G. BACKFLOW PREVENTION: 1. USE TYPE AS INDICATED ON THE DRAWINGS. 2. ALL PIPING BETWEEN POINT OF CONNECTION AND BACKFLOW PREVENTION UNIT TO BE OF MATERIAL AS

REQUIRED BY LOCAL CODE.

H. CONTROL WIRING: I. USE DIRECT BURIAL COPPER WIRE UWG-U.F. 600 VOLT FOR CONNECTIONS BETWEEN THE AUTOMATIC CONTROLLER AND THE ELECTRIC CONTROL VALVES. NO WIRE SIZE LESS THAN #14. USE BLACK COLOR WIRE FOR PILOT,

WHITE FOR COMMON. 2. INSTALL WIRING ALONG SAME ROUTE AS PRESSURE MAINLINE SUPPLY OR LATERAL LINES WHENEVER

3. WHERE MORE THAN ONE WIRE IS PLACED IN A TRENCH, TAPE WIRING TOGETHER AT TEN FOOT INTERVALS. 4. PROVIDE AN EXPANSION CURL WITHIN THREE FEET OF EACH WIRE CONNECTION.

5. Make splices with Scotch-Lok #3577 Connector SEALING PACKS OR PEN-TITE WIRE CONNECTORS. USE ONE SPLICE PER CONNECTOR SEALING PACKS OR PEN-TITE WIRE CONNECTORS. USE ONE SPLICE PER CONNECTOR SEALING PACK. FIELD SPLICES WILL NOT BE PERMITTED.

I. SPRINKLER HEAD: I. USE SPRINKLER HEADS OF THE SAME SIZE, TYPE AND SAME RATE OF PRECIPITATION WITH THE DIAMETER (OR RADIUS) OF THROW, PRESSURE, AND DISCHARGE AS SHOWN ON THE DRAWINGS.

2. ALL SPRINKLER HEADS OF THE SAME TYPE TO BE OF THE SAME MANUFACTURER.

J. WATER SUPPLY: I. SYSTEM DESIGN IS BASED ON MINIMUM OPERATING PRESSURE SHOWN AT EACH POINT OF CONNECTION. MAXIMUM GPM DEMAND SPECIFIED. VERIFY ALL PRESSURES ON SITE PRIOR TO CONSTRUCTION. CONTACT THE CITY LANDSCAPE ARCHITECT W/ THE PRESSURE READING AR THE PRE-CONSTRUCTION MEETING.

K. ELECTRICAL SUPPLY: 1. 120 VOLT ELECTRICAL POWER OUTLET FOR AUTOMATIC CONTROLLER TO BE PROVIDED BY OTHERS. MAKE REQUIRED ELECTRICAL CONNECTION OF AUTOMATIC CONTROLLER TO OUTLET.

L. INSTALLATION: 1. PROVIDE A MINIMUM OF EIGHTEEN INCHES COVER FOR ALL PRESSURE SUPPLY LINES.

2. PROVIDE A MINIMUM OF TWELVE INCHES COVER FOR ALL INTERMITTENT PRESSURE LATERAL LINES. 3. PROVIDE A MINIMUM OF EIGHTEEN INCHES COVER FOR ALL CONTROL WIRING.

4. ALL PIPE UNDER PAVED AREAS TO BE PVC SCHEDULE 40 INSTALLED PRIOR TO PAVING.

5. IN ADDITION TO CONTROL WIRE SLEEVES SHOWN ON THE DRAWINGS, INSTALL WIRE SLEEVES OF SUFFICIENT SIZE UNDER ALL PAVED AREAS PRIOR TO PAVING.

6. FINAL LOCATIONS OF AUTOMATIC CONTROLLER SHALL BE DETERMINED BY THE OWNER AND/OR LANDSCAPE ARCHITECT.

7. FLUSH IRRIGATION SYSTEM PIPING PRIOR TO INSTALLATION OF SPRINKLER HEADS.

8. INSTALL THE SPRINKLER HEADS AS DESIGNED ON THE DRAWINGS. DO NOT EXCEED MAXIMUM SPACING OF HEADS INDICATED ON THE DRAWINGS AND IN NO CASE EXCEED THE MAXIMUM RECOMMENDED BY THE MANUFACTURER.

02480 LANDSCAPE PLANTING

A. ON SITE SOIL INSPECTION: I. IN ADDITION TO THESE DOCUMENTS, COMPLY WITH THE RECOMMENDATIONS OF THE SOIL SUITABILITY AND FERTILITY ANALYSIS REPORT, PROVIDED IN THIS SET.

B. SUBMITTALS: 1. SUBMIT DELIVERY SLIPS FOR MATERIAL TO OWNER/ CITY LANDSCAPE ARCHITECT, TO VERIFY SPECIFIED QUANTITIES

OF BULK DELIVERIES OF SOIL AMENDMENTS AND FERTILIZERS. C. PRODUCT DELIVERY, STORAGE AND HANDLING: I. DELIVER FERTILIZER TO SITE IN ORIGINAL UNOPENED

CHEMICAL ANALYSIS, NAME, TRADE MARK, AND CONFORMANCE TO STATE LAW. 2. DELIVER PLANT MATERIAL WITH LEGIBLE IDENTIFICATION LABELS.

CONTAINERS BEARING MANUFACTURER'S GUARANTEED

3. LABEL TREES, EVERGREENS, BUNDLES OR CONTAINERS OF LIKE SHRUBS. OR GROUND COVER PLANTS. 4. PROTECT PLANT MATERIAL DURING DELIVERY TO PREVENT DAMAGE TO ROOT BALL OR DESICCATION OF LEAVES.

5. MAINTAIN AND PROTECT PLANT MATERIAL NOT TO BE

PLANTED WITHIN FOUR HOURS OF DELIVERY.

D. JOB CONDITIONS: I. PERFORM ACTUAL PLANTING ONLY WHEN WEATHER AND SOIL CONDITIONS ARE SUITABLE IN ACCORDANCE WITH LOCALLY ACCEPTED PRACTICE.

E. SUBSTITUTIONS:

I. NONE ALLOWED.

I. GUARANTEE BOXED AND FIELD GROWN TREES TO "LIVE AND GROW" IN AN "ACCEPTABLE, UPRIGHT POSITION" FOR A PERIOD OF ONE YEAR AFTER COMPLETION OF THE SPECIFIED MAINTENANCE PERIOD AND FINAL ACCEPTANCE. DEFINITION OF "LIVE AND GROW" AND "ACCEPTABLE UPRIGHT POSITION" SHALL MEAN THAT THE TREE MUST, DURING THE GUARANTEE PERIOD, SUSTAIN A HEALTHY, VIGOROUS APPEARANCE. IF THE TREE, DURING THE GUARANTEE PERIOD DOES NOT SUSTAIN THIS APPEARANCE, REMOVE AND REPLACE IT WITH A TREE EQUAL TO THE ORIGINAL SPECIFICATION

2. GUARANTEE ALL ROOTED CUTTINGS, SOD, AND CONTAINER PLANT MATERIALS UP TO AND INCLUDING 15-GALLON SIZE AS TO GROWTH AND HEALTH FOR A PERIOD OF | YEAR. AFTER COMPLETION OF THE SPECIFIED MAINTENANCE

PERIOD AND FINAL ACCEPTANCE. 3. REMOVE AND REPLACE ALL GUARANTEED PLANT MATERIAL WHICH FOR ANY REASON FAILS TO MEET THE REQUIREMENTS OF THE GUARANTEE WITHIN 15 DAYS OF WRITTEN NOTIFICATION BY OWNER. REPLACE WITH PLANT MATERIALS ORIGINALLY SPECIFIED AND PROVIDE ORIGINAL GUARANTEE.

G. PLANT ESTABLISHMENT PERIOD: 1. MINIMUM 30 CALENDAR DAYS TO BE COMPLETED BEFORE THE LANDSCAPE ARCHITECT WILL RECOMMEND ACCEPTANCE BY THE OWNER.

H. MAINTENANCE PERIOD: 1. 90 CALENDAR DAYS FROM THE DATE OF ACCEPTANCE.

I. Topsoil:

I. USE NATURAL FRIABLE SOIL OF THE REGION, FREE FROM LUMPS, CLAY, TOXIC SUBSTANCES, STICKS, DEBRIS, VEGETATION, STONES OVER ONE INCH IN MINIMUM DIMENSION, AND CONTAINING NO DECOMPOSED STONE, SALTS, OR ALKALI.

2. SILT PLUS CLAY CONTENT NOT TO EXCEED 15 % BY

WEIGHT 3. BORON CONTENT NOT TO EXCEED I PPM AS MEASURED BY THE SATURATION EXTRACT 4. SODIUM ABSORPTION RATIO (SAR) NOT TO EXCEED 6 AND

THE ELECTRICAL CONDUCTIVITY OR THE SATURATION EXTRACT NOT TO EXCEED 3.0 MILLIMHOS PER CENTIMETER AT 25M C.

5. FREE FROM HERBICIDES. 6. FREE FROM NOXIOUS WEEDS.

J. ORGANIC AMENDMENT:

I NITROGEN STABILIZED A. 0.4 TO 0.6% N BASED ON DRY WEIGHT FOR REDWOOD B. 0.56 TO 0.84 % N BASED ON DRY WEIGHT FOR FIR OR CEDAR SAWDUST. C. 0.8 TO 1.2 % N BASED ON DRY WEIGHT FOR FIR OR

PINE BARK. 2. PARTICLE SIZE:

A. 95-100 % PASSING 6.35 MM (1/4") STANDARD B. 80-100 % PASSING 2.38 MM (No. 8, 8 MESH)

STANDARD SIEVE. c. 0-30 % passing 500 micron (No. 35, 32 mesh) STANDARD SIEVE.

3. SOLUBLE SALTS: A. MAXIMUM 3.5 MILLIMHOS/CENTIMETER @ 25M C. AS DETERMINED BY THE SATURATION EXTRACT METHOD.

K. ORGANIC SOIL CONDITIONER WITH FERTILIZER: I. USE GRO-POWER-PLUS AS MANUFACTURED BY SOUTHERN CALIFORNIA ORGANIC FERTILIZER Co. (909) 393-3744 OR GROPOWERINC@VERIZON.NET OR GROPOWER.COM

M. PLANT MATERIAL: 1. USE PLANTS OF THE VARIETY AND SIZE AS INDICATED ON THE DRAWINGS.

2. TAG ONE EACH OF EACH BUNDLE OR LOT WITH THE PLANT NAME IN ACCORDANCE WITH THE RECOMMENDATIONS OF THE AMERICAN ASSOCIATION OF NURSERYMEN. 3. USE PLANTS THAT HAVE A HABIT OF GROWTH THAT IS NORMAL TO THE SPECIES, ARE SOUND, HEALTHY, VIGOROUS AND FREE FROM INSECT PESTS, PLANT DISEASES, SUN SCALDS, FRESH ABRASIONS OF THE BARK, EXCESSIVE ABRASIONS OF THE BARK, EXCESSIVE ABRASIONS OR OTHER OBJECTIONABLE DISFIGUREMENTS.

N. TREE STAKING MATERIAL: 1. COPPER MAPHTHANATE, GREEN COLOR IMPREGNATED LODGE POLE PINE:

PWTIEL

TREE TRUNKS TO BE STURDY AND WELL HARDENED OFF.

B. 12 FEET LONG FOR 24" BOX AND LARGER TREES.

TREE TIES: A. 2 VERTICAL LOCATIONS, 4 TIES. 5 GAL, I5 GAL AND 24" BOX TREES= DOUBLE STAKE. 36" BOX + = TRIPLE STAKE.

I. FIBER: CELLULOSE FIBER. CONWED HYDRO MULCH OR

I. REFER TO SOILS REPORT, PROVIDED BY CONTRACTOR.

I. VERIFY THAT FINAL GRADES HAVE BEEN ESTABLISHED

2. DO NOT WORK SOIL WHEN MOISTURE CONTENT IS SO GREAT

THAT EXCESSIVE COMPACTION WILL OCCUR NOR WHEN IT

IS SO DRY THAT DUST WILL FORM IN THE AIR OR THAT

CLODS WILL NOT BREAK READILY. APPLY WATER AS

3. REMOVE AND DISPOSE OF ALL WEEDS AND BURIED DEBRIS

4. MAKE ALL SOIL AREAS SMOOTH AND EVEN WITH FINISH

GRADES | INCH BELOW THE SURFACE OF WALKS,

BOXES AND SIMILAR FEATURES.

REQUIRED TO PROVIDE IDEAL MOISTURE FOR FILLING AND

FOUND UPON ANY EXCAVATION TO ANY CONVENIENT LEGAL

WITH CATCH BASINS, MANHOLES, CLEANOUTS, VALVE

5. CULTIVATE ALL AREAS TO BE PLANTED TO A DEPTH OF AT

LEAST 6 INCHES SO THAT THE SOIL IS LOOSE AND

OTHER DELETERIOUS MATTER WHICH MIGHT BE A

HINDERANCE TO PLANTING AND MAINTENANCE.

OF FOUR INCHES BY MEANS OF A ROTOTILLER OR

6. FOR PLANTING AREAS, UNIFORMLY BROADCAST AND

FRIABLE. FOR THE TOP TWO INCHES OF SOIL IN ALL

CULTIVATED AREAS, REMOVE ALL STONES, ROOTS AND

THOROUGHLY INCORPORATE SOIL AMENDMENTS TO A DEPTH

1. PRE-EMERGENCE HERBICIDE: APPLY TO PLANTING AREAS,

EXCEPT LAWNS, IN ACCORDANCE WITH MANUFACTURER'S

2. CONTRACT HERBICIDES: APPLY PER MANUFACTURER'S

TO APPLICATION, MOISTEN AREAS FOR 14 DAYS TO

I. DO NOT COMMENCE PLANTING UNTIL ALL CONSTRUCTION

SYSTEM INSTALLATION HAVE BEEN COMPLETED.

WORK, GRADING, SOIL IMPROVEMENTS AND IRRIGATION

2. WHEN PLANT MATERIAL IS SPACED IN ROWS, VERIFY THE

TOTAL DIMENSION AND SPACE THE PLANTS EQUALLY

SHOWN ON THE DRAWINGS AND AS DIRECTED BY THE

3. DIG PLANT PITS WITH LEVEL BOTTOMS, WIDTH TWICE THE

4. SET PLANTS IN PLANT PITS SO THAT THEY BEAR THE

DID WHEN IN CONTAINER. CENTER PLANT IN PIT.

BACKFILL REMAINDER OF PIT WITH PLANTING SOIL.

FIRM DOWN, ELIMINATING ALL AIR POCKETS. DO NOT

BACKFILL. WATER PLANTS IN IMMEDIATELY AFTER

6. FILL ALL PLANTERS WITH PLANTING SOIL TO WITHIN

THREE INCHES FROM TOP OF PLANTER.

PIT WITH PREPARED SOIL MIX.

2. CONTAINER TREES-DOUBLE STAKE:

DIMENSION.

MAY BE APPLIED.

DETAILS.

Z. MULCH:

MANUFACTURER'S RECOMMENDATIONS.

A. SET TREES IN PLANT PIT, DRIVE ONE LODGEPOLE

B. SECURE TREE TO STAKES WITH "CINCH-TIES" PER

I. INSTALL SHREDED CEDAR BARK MULCH TO A DEPTH

I.I. MAX PARTICLE SIZE NOT TO EXCEED 3" IN ANY

2. LOCAL SUPPLIER: SOCAL MULCH. (951)246-8081 OR

MULCH SHALL BE NITROGEN STABILIZED.

FOR LARGE PLANTER AREAS, HYDRO-MULCH

OF 3" MIN.TO ALL PLANTER AREAS.

PACK. FORM A SHALLOW BASIN AROUND THE PLANT TO

HOLD ENOUGH WATER TO SATURATE THE ROOT BALL AND

A. STAKE TREES DESIGNATED TO BE INSTALLED, AS PER

DETAIL, WITH STAKES OR STAKE ON WINDWARD SIDE OF

B. SET TREES IN PLANT PIT, DRIVE ONE TREE STAKE 30

INCHES TO FIRM SOIL NEXT TO ROOT BALL, BACKFILL

C. SECURE TREE TO STAKE WITH FOUR (4) "CINCH-TIES" PER

TREE STAKE INTO FIRM SOIL NEXT TO THE ROOT BALL ON

EACH SIDE AND BACKFILL PIT WITH PREPARED SOIL MIX.

5. BACKFILL PLANT PIT WITH SPECIFIED SOIL MIX.

DIAMETER OF THE ROOT BALL AND SIX INCHES DEEPER

THAN THE LENGTH OF THE ROOT BALL, UNLESS OTHERWISE

SAME RELATION TO SOIL LEVEL WHEN PLANTED AS THEY

WITHIN THE DESIGNATED AREA. WHERE PLANT MATERIAL

IS SHOWN IN RANDOM PATTERN, SPACE THE MATERIAL AS

ENCOURAGE WEED GERMINATION AND GROWTH. APPLY

CONTACT HERBICIDE BEFORE WEEDS ATTAIN SIX INCHES

IN HEIGHT. REMOVE HIGHER WEED GROWTH MANUALLY.

RECOMMENDATIONS. AFTER APPLICATION, APPLY ONE TO

RECOMMENDATIONS TO AREAS TO RECEIVE LAWN. PRIOR

PAVED AREAS AND CURBS AND SLIGHTLY LESS THAN FLUSH

DUMP OR OFFSIDE LOCATION AT NO EXPERIENCE TO THE

PRIOR TO BEGINNING PLANTING OPERATIONS.

B. DO NOT USE HOSE/WIRE OR TWIST A

R. HYDRAULIC SEEDING MATERIALS:

A. 8-3-2 + 3 % FE.

B. TERRA-TRACK III.

A. ECOLOGY CONTROL M-BINDER.

3. ORGANIC SOIL STABILANT:

S. SOIL PREPARATION MIX:

FOR PLANTING.

ACCEPTED EQUAL.

V. HERBICIDE APPLICATION:

TWO INCHES OF WATER.

LANDSCAPE ARCHITECT.

W. PLANTING:

INDICATED.

PLANTING.

X. STAKING OF TREES:

I. BOXED TREES:

SILVA FIBER.

2. FERTILIZER:

U. PREPARATION:

1.5.

1.6.

1.9.

1.10.

1.12.

AA. MAINTENANCE SCHEDULE:

SCHEDULE TO INCLUDE:

SCHEDULE TO BE PROVIDED TO THE CITY UPON OWNER SELECTION OF MAINTENANCE COMPANY OR AT THE TIME OF SUBSTANTIAL COMPLETION OF PROJECT.

SPECIFIED EQUIPMENT

REPLENISH MULCH.

MAINTAINED TO ENSURE WATER EFFICIENCY.

CHECK, REPAIR AND ADJUST EQUIPMENT.

REPAIRS TO BE MADE WITH ORIGINALLY

FERTILIZATION, PRUNING AND WEEDING.

PALM TREE SKINNING/PRUNING INTERVAL

ANNUAL COLOR REPLACEMENT SCHEDULE.

HEDGE TREATMENT AND SHRUB PRUNING

TECHNIQUE SPECIFIC TO THIS SITE.

RESET CONTROLLER AS REQUIRED.

CLEANING OF DEBRIS AND TRASH.

DISEASE AND PEST CONTROL.

DEAD PLANT REPLACEMENT.

TREE TRIMMING INTERVAL


1.14. SEASONAL TRIMMING SPECIFICS.

SHEET 6 OF 6

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LANDSCAPE ARCHITECTURE / SITE PLANNING 5225 CANYON CREST DRIVE, STE 71, PMB 281. RIVERSIDE, CA 92507 PHONE: 951.788.0277 FAX: 951.788.0288 www.gdalandarch.com



CITY OF RIVERSIDE, CALIFORNIA APPROVED BY APPR. DATE TRAFFIC ENGINEERING

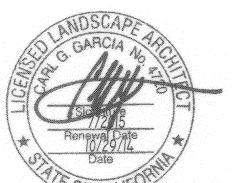DESIGNED BY CG DRAWN BY CG CHECKED BY CGG

TR 36654; MISSION SQUARE

ADAMS ST. FRONTAGE