GENERAL NOTES:


- 1. NO PERSON SHALL PERFORM ANY CONSTRUCTION ACTIVITY OR INSTALL ANY OBJECTS WITHIN THE PUBLIC RIGHTS-OF-WAY OR EASEMENTS OF THE CITY OF RIVERSIDE WITHOUT A VALID CONSTRUCTION PERMIT OR. A STREET OPENING PERMIT OR AN ENCROACHMENT PERMIT ISSUED BY THE CITY'S PUBLIC
- 2. IT SHALL BE THE RESPONSIBILITY OF THE CONTRACTOR TO CLEAR THE RIGHT OF WAY IN ACCORDANCE WITH THE PROVISIONS OF LAW AS IT AFFECTS EACH UTILITY INCLUDING IRRIGATION LINES AND APPURTENANCES
- 3. CONSTRUCTION SHALL BE IN ACCORDANCE WITH THE CITY OF RIVERSIDE DEPARTMENT OF PUBLIC WORKS, STANDARD DRAWINGS, ITS SUPPLEMENTAL NOTES AND THE STANDARD SPECIFICATIONS FOR PUBLIC WORKS CONSTRUCTION, CURRENT EDITION.
- 4. THE PRIVATE ENGINEER SIGNING THESE PLANS IS RESPONSIBLE FOR ASSURING THE ACCURACY AND ACCEPTABILITY OF THE WORK HEREON. IN THE EVENT OF DISCREPANCIES ARISING DURING CONSTRUCTION, THE PRIVATE ENGINEER SHALL BE RESPONSIBLE FOR DETERMINING AN ACCEPTABLE SOLUTION AND REVISING THE PLANS FOR APPROVAL BY THE CITY.
- 5. QUANTITIES SHOWN ARE FOR INFORMATION ONLY AND THE CITY OF RIVERSIDE IS NOT RESPONSIBLE FOR
- 6. THE DEVELOPER SHALL BE RESPONSIBLE FOR PRESERVING OR RE-ESTABLISHING AND REFERENCING SURVEY MONUMENTS DESTROYED, DISTURBED OR BURIED AS A RESULT OF CONSTRUCTION SHOWN
- 7. SEE "STREET LIGHTING PLANS" FOR QUANTITY AND LOCATION OF REQUIRED STREET LIGHTS.
- 8. ALL FLAGGED ELEVATIONS SHALL BE STAKED IN THE FIELD BY THE PRIVATE ENGINEER. 9. WHERE NEW PAVEMENT IS TO JOIN THE EXISTING PAVEMENT. THE EDGE OF THE EXISTING PAVEMENT SHALL BE TRIMMED IN A SMOOTH AND STRAIGHT LINE. CONSTRUCT MATCH-UP PAVING AS SHOWN ON THE PLANS AND OVERLAY PAVING AS DIRECTED IN THE FIELD TO PRODUCE A SMOOTH
- 10. CONSTRUCT DRIVEWAY APPROACHES PER STANDARD DRAWING 302. EXACT SIZE AND LOCATION TO BE STAKED BY THE PRIVATE ENGINEER PRIOR TO CONSTRUCTION OF THE CURB AND GUTTER.
- 11. THE DEVELOPER AND/OR CONTRACTOR SHALL CONTACT THE STREET DIVISION (351-6103) TO PICK UP ANY EXISTING STD. 180 BARRICADES THAT ARE BEING REMOVED. THE CITY'S INSPECTOR WILL MAKE THE FINAL DETERMINATION ON WHETHER A BARRICADE CAN BE RELOCATED.
- 12. ANY TRAFFIC CONTROL STRIPING OBLITERATED AND/OR BADLY WORN DURING CONSTRUCTION SHALL BE RESTORED BY THE CONTRACTOR WITHIN FIVE DAYS AFTER NOTIFICATION FROM THE CITY INSPECTORS.
- BE ISSUED BY THE PUBLIC WORKS DEPARTMENT INVOLVING EXCAVATION FOR UNDERGROUND
- REPLACED AS DIRECTED BY THE INSPECTOR PRIOR TO OVERLAYING WITH A.C. PAVING.


15. IN PAVEMENT OVERLAY AREAS, ANY DISTRESSED EXISTING PAVEMENT SHALL BE REMOVED AND

- 17. SEE TRAFFIC SIGNAL PLAN #X-499B FOR SIGNAL IMPROVEMENTS.
- 18. STREET OPENING PERMIT FOR CONSTRUCTION AND/OR MODIFICATION OF TRAFFIC SIGNAL
- 19. THE DEVELOPER AND/OR CONTRACTOR SHALL ARRANGE FOR A SOIL TEST TO BE MADE BY A SOILS ENGINEER AFTER THE STREET HAVE BEEN PREPARED TO ROUGH GRADE AND PRIOR TO CURB AND GUTTER CONSTRUCTION. DEPTH OF BASE MATERIAL AND A.C. PAVING SHALL BE DETERMINED BY THE CITY OF RIVERSIDE DESIGN STANDARDS AND TEST PROCEDURES
- 20. ON ALL AREAS WITHIN PUBLIC RIGHT OF WAY WHERE THE FILL IS ONE (1) FOOT OR GREATER, A LETTER WILL BE REQUIRED FROM THE SOILS ENGINEER, CERTIFYING THE COMPACTION OF THE FILL BELOW SUB GRADE, PRIOR TO ISSUANCE OF THE CONSTRUCTION PERMIT/CUT SHEETS.
- 21. ALL TRAFFIC SIGNS SHALL BE INSTALLED PRIOR TO OPENING THE STREETS TO TRAFFIC.
- 22. THIS PROJECT IS RESPONSIBLE FOR ALL FINAL PAVEMENT AND CONCRETE REPAIRS AND REPLACEMENT ASSUCIATED WITH THE INSTALLATION OF WATER FACILITIES SHOWN ON CITY OF RIVERSING WATER DEPARTMENT DRAWING DS-1711889.

STREET IMPROVEMENT PLANS

COLUMBIA BUSINESS CENTER PARCEL MAP 36638

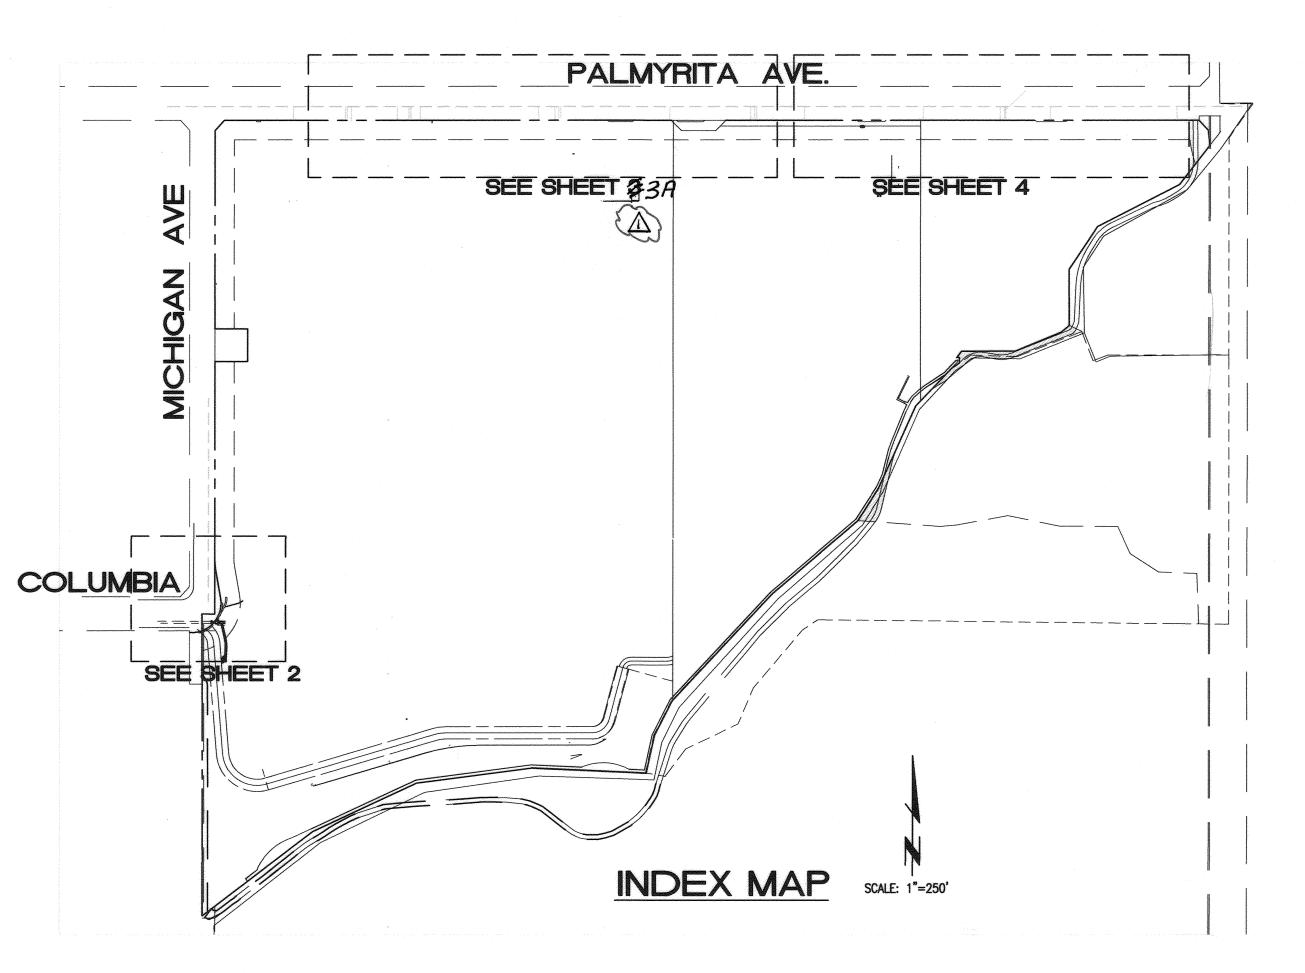

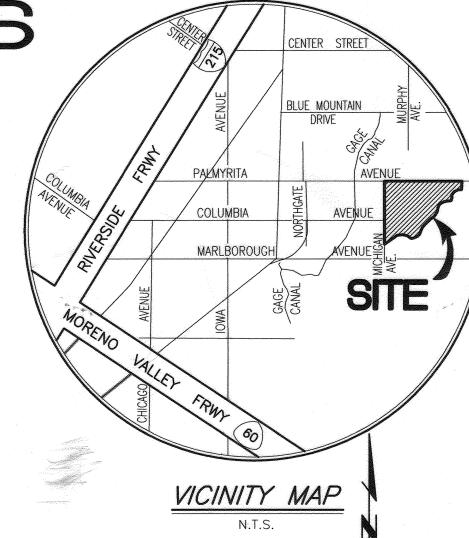

ABBREVIATIONS:

-AGGREGATE BASE -ASPHALT CONCRETE -BEGIN CURB RETURN -BOULEVARD -BEGIN VERTICAL CURVE -CURB FACE -CENTER LINE -CONCRETE -CORRUGATED METAL PIPE -CORRUGATED STEEL PIPE -DRIVEWAY -EXISTING -END CURB RETURN -END VERTICAL CURVE -EDGE OF PAVEMENT -FINISHED SURFACE -GALLON -GRADE BREAK -MINIMUM -- MAXIMUM -MANHOLE -NUMBER -NOT TO SCALE -LENGTH FOOT -ON CENTER —POINT OF INTERSECTION --PROPOSED -PROPERTY LINE -POWER POLE -RADIUS -RATE OF GRADE -RIGHT OF WAY

> -STANDARD -STREET LIGHT -TELEPHONE -TOP OF CURB —TOP OF BERM -TRAFFIC INDEX -TYPICAL


-VERTICAL CURVE

-VERTICAL DEPTH -VERTICAL -WIDTH

-SIZE-WATER

6.5 EXISTING SIDEWALK EXISTING SIDEWALK

TYPICAL STREET SECTION **EXISTING COLUMBIA AVENUE** NOT TO SCALE

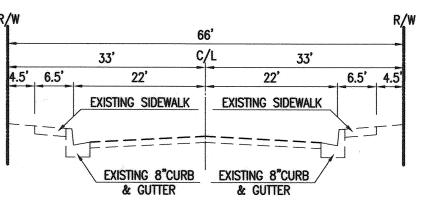

LEGEND

---- CATV---- EXIST. CABLE TV CONDUIT

EXIST. STORM DRAIN

EXIST. GAS LINE

EXIST. EDGE OF A.C. PAVEMENT

EXIST. CURB AND GUTTER

EXIST. TELEPHONE CONDUIT

EXIST. TELEPHONE MANHOLE

REMOVE EXISTING AC PAVEMENT

AC PAVEMENT

- EXIST. CONTOUR

EXIST. MAIL BOX

X 1854.69 EXIST. GRADE ELEVATION

ଅଧାର EXIST. FIRE HYDRANT

EXIST. WATER METER

EXIST. WATER VALVE

EXIST. GAS VALVE

EXIST. POWER POLE

EXIST. TRAFFIC SIGNAL

EXIST. CROSSWALK SIGNAL

STREET LIGHTING BOX

EXIST. STORMDRAIN MANHOLE


EXIST. TRAFFIC SIGNAL BOX

EXIST. SEWER MANHOLE

EXIST. VAULT

- - GUY WIRE/DEADMAN

TYPICAL STREET SECTION **EXISTING MICHIGAN AVENUE**

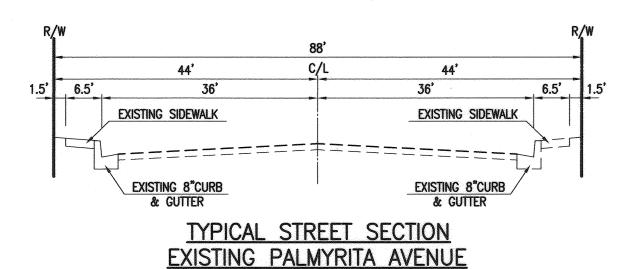

SHEET INDEX TITLE SHEET COLUMBIA AT MICHIGAN AVENUE KNUCKLE PALMYRITA AVENUE SH"3 REPLACEDWITH SH31 PALMYRITA AVENUE

QUANTITY: CONSTRUCTION NOTES

- 750 LF (1) SAWCUT REMOVE EXISTING CURB, GUTTER, AND SIDEWALK
- 3,055 SF (2) SAWCUT REMOVE EXISTING A.C. PAVEMENT
- N/A (3) PROTECT IN PLACE EXISTING
- 9 EA (4) ADJUST TO GRADE EXISTING
- 4 EA (5) EXISTING TO BE REMOVED
- 300 SF (6) EXISTING CONCRETE CROSS GUTTER TO BE REMOVED
- 5 EA (7) EXISTING TO BE RELOCATED
- 2,245 SF 8 SAWCUT REMOVE & RECONSTRUCT EXISTING ASPHALT, CURB, GUTTER AND
- 5,060 SF (11) CONSTRUCT _" AC PAVEMENT OVER _"AB PER SOILS RECOMMENDATION.
- 175 LF (12) CONSTRUCT 8" CURB & GUTTER PER CITY OF RIVERSIDE STD. 200 TYPE
- 2,270 SF (13) CONSTRUCT CONCRETE SIDEWALK PER CITY OF RIVERSIDE STD. 325 5 EA (14) CONSTRUCT DRIVEWAY APPROACH PER CITY OF RIVERSIDE STD. 302 MODIFY PER DETAIL ON SHEET 2.
- 445 LF (15) CONSTRUCT FULL DEPTH A.C. PAVEMENT
- 1,075 SF (16) COLD PLANE AND CONSTRUCT A.C. OVERLAY PER DETAIL SHEET 2.

DATE 8/16/17

- 10 EA (17) JOIN EXISTING CURB, GUTTER AND SIDEWALK
- N/A (18) CURB, GUTTER OR SIDEWALK PER ONSITE IMPROVEMENT

Last Update: 5/22/17 0:\3100-3199\3126\3126b\STREET\3126b ST 01.dwg



WESTERN MUNICIPAL WATER DISTRICT

FOR NON-INTERFERENCE COMPLIANCE

Don't Kamily

INTERIM DIRECTOR OF ENGINEERING

SHEET 1 THROUGH 4

PRIVATE ENGINEERING NOTE

6/22/2017 DATE

ISTRUCTION CONTRACTOR AGREES THAT IN ACCORDANCE WITH GENERALLY CCEPTED CONSTRUCTION PRACTICES, CONSTRUCTION CONTRACTOR WILL BE EQUIRED TO ASSUME SOLE AND COMPLETE RESPONSIBILITY FOR JOB SITE CONDITIONS DURING THE COURSE OF CONSTRUCTION OF THE PROJECT, INCLUDING SAFETY OF ALL PERSONS AND PROPERTY; THAT THIS REQUIREMENT SHALL BE MADE TO APPLY CONTINUOUSLY AND NOT BE LIMITED TO NORMAL WORKING HOURS, AND CONSTRUCTION CONTRACTOR FURTHER AGREES TO DEFEND, INDEMNIFY AND HOLD DESIGN PROFESSIONAL HARMLESS FROM ANY AND ALL LIABILITY, REAL OR ALLEGED, IN CONNECTION WITH THE PERFORMANCE OF WORK ON THIS PROJECT, EXCEPTING LIABILITY ARISING FROM THE SOLE

R.C.E. NO. 43293 Exp. 3-31-18

PREPARED UNDER THE DIRECTION OF: R.C.E. 043293 - EXP. 3/31/18

5726117

10 Thienes Engineering, Inc. CIVIL ENGINEERING . LAND SURVEYING LA MIRADA, CALIFORNIA 90638

PH.(714)521-4811 FAX(714)521-4173 CITY OF RIVERSIDE BENCHMARK NO. "J8-G3"
P.K. NAIL AND CITY ENGINEER TAG IN THE SOUTHEASTERLY CORNER OF A CATCH BASIN ALONG THE EASTERLY CURB OF IOWA AVENUE AT THE (B.M. TRANSFER FROM J8-A3).

VOIDED SH. 3. ADDED SH. 3A REVISED SHEET INDEX


CITY OF RIVERSIDE, CALIFORNIA DEPARTMENT OF PUBLIC WORKS APPROVED BY BY DATE APPROVED E ENGINEERING MANAGER 5.2. 2.15. TRAFFIC DIVISION


STREET IMPROVEMENT PLAN COLUMBIA BUSINESS CENTER TITLE SHEET


R-4396


PM 36638 HORIZ. SCALE: 1"=20' VERT. SCALE: 1"=2"


SOUTHEAST CURB RETURN OF IOWA AVENUE AND MARLBOROUGH AVENUE. Call before you dig. DESIGNED BY SAK DRAWN BY SAK CHECKED BY HIA October, 2016 | ELEVATION = 933.305' (NAVD '88 / 2009 ADJ.)

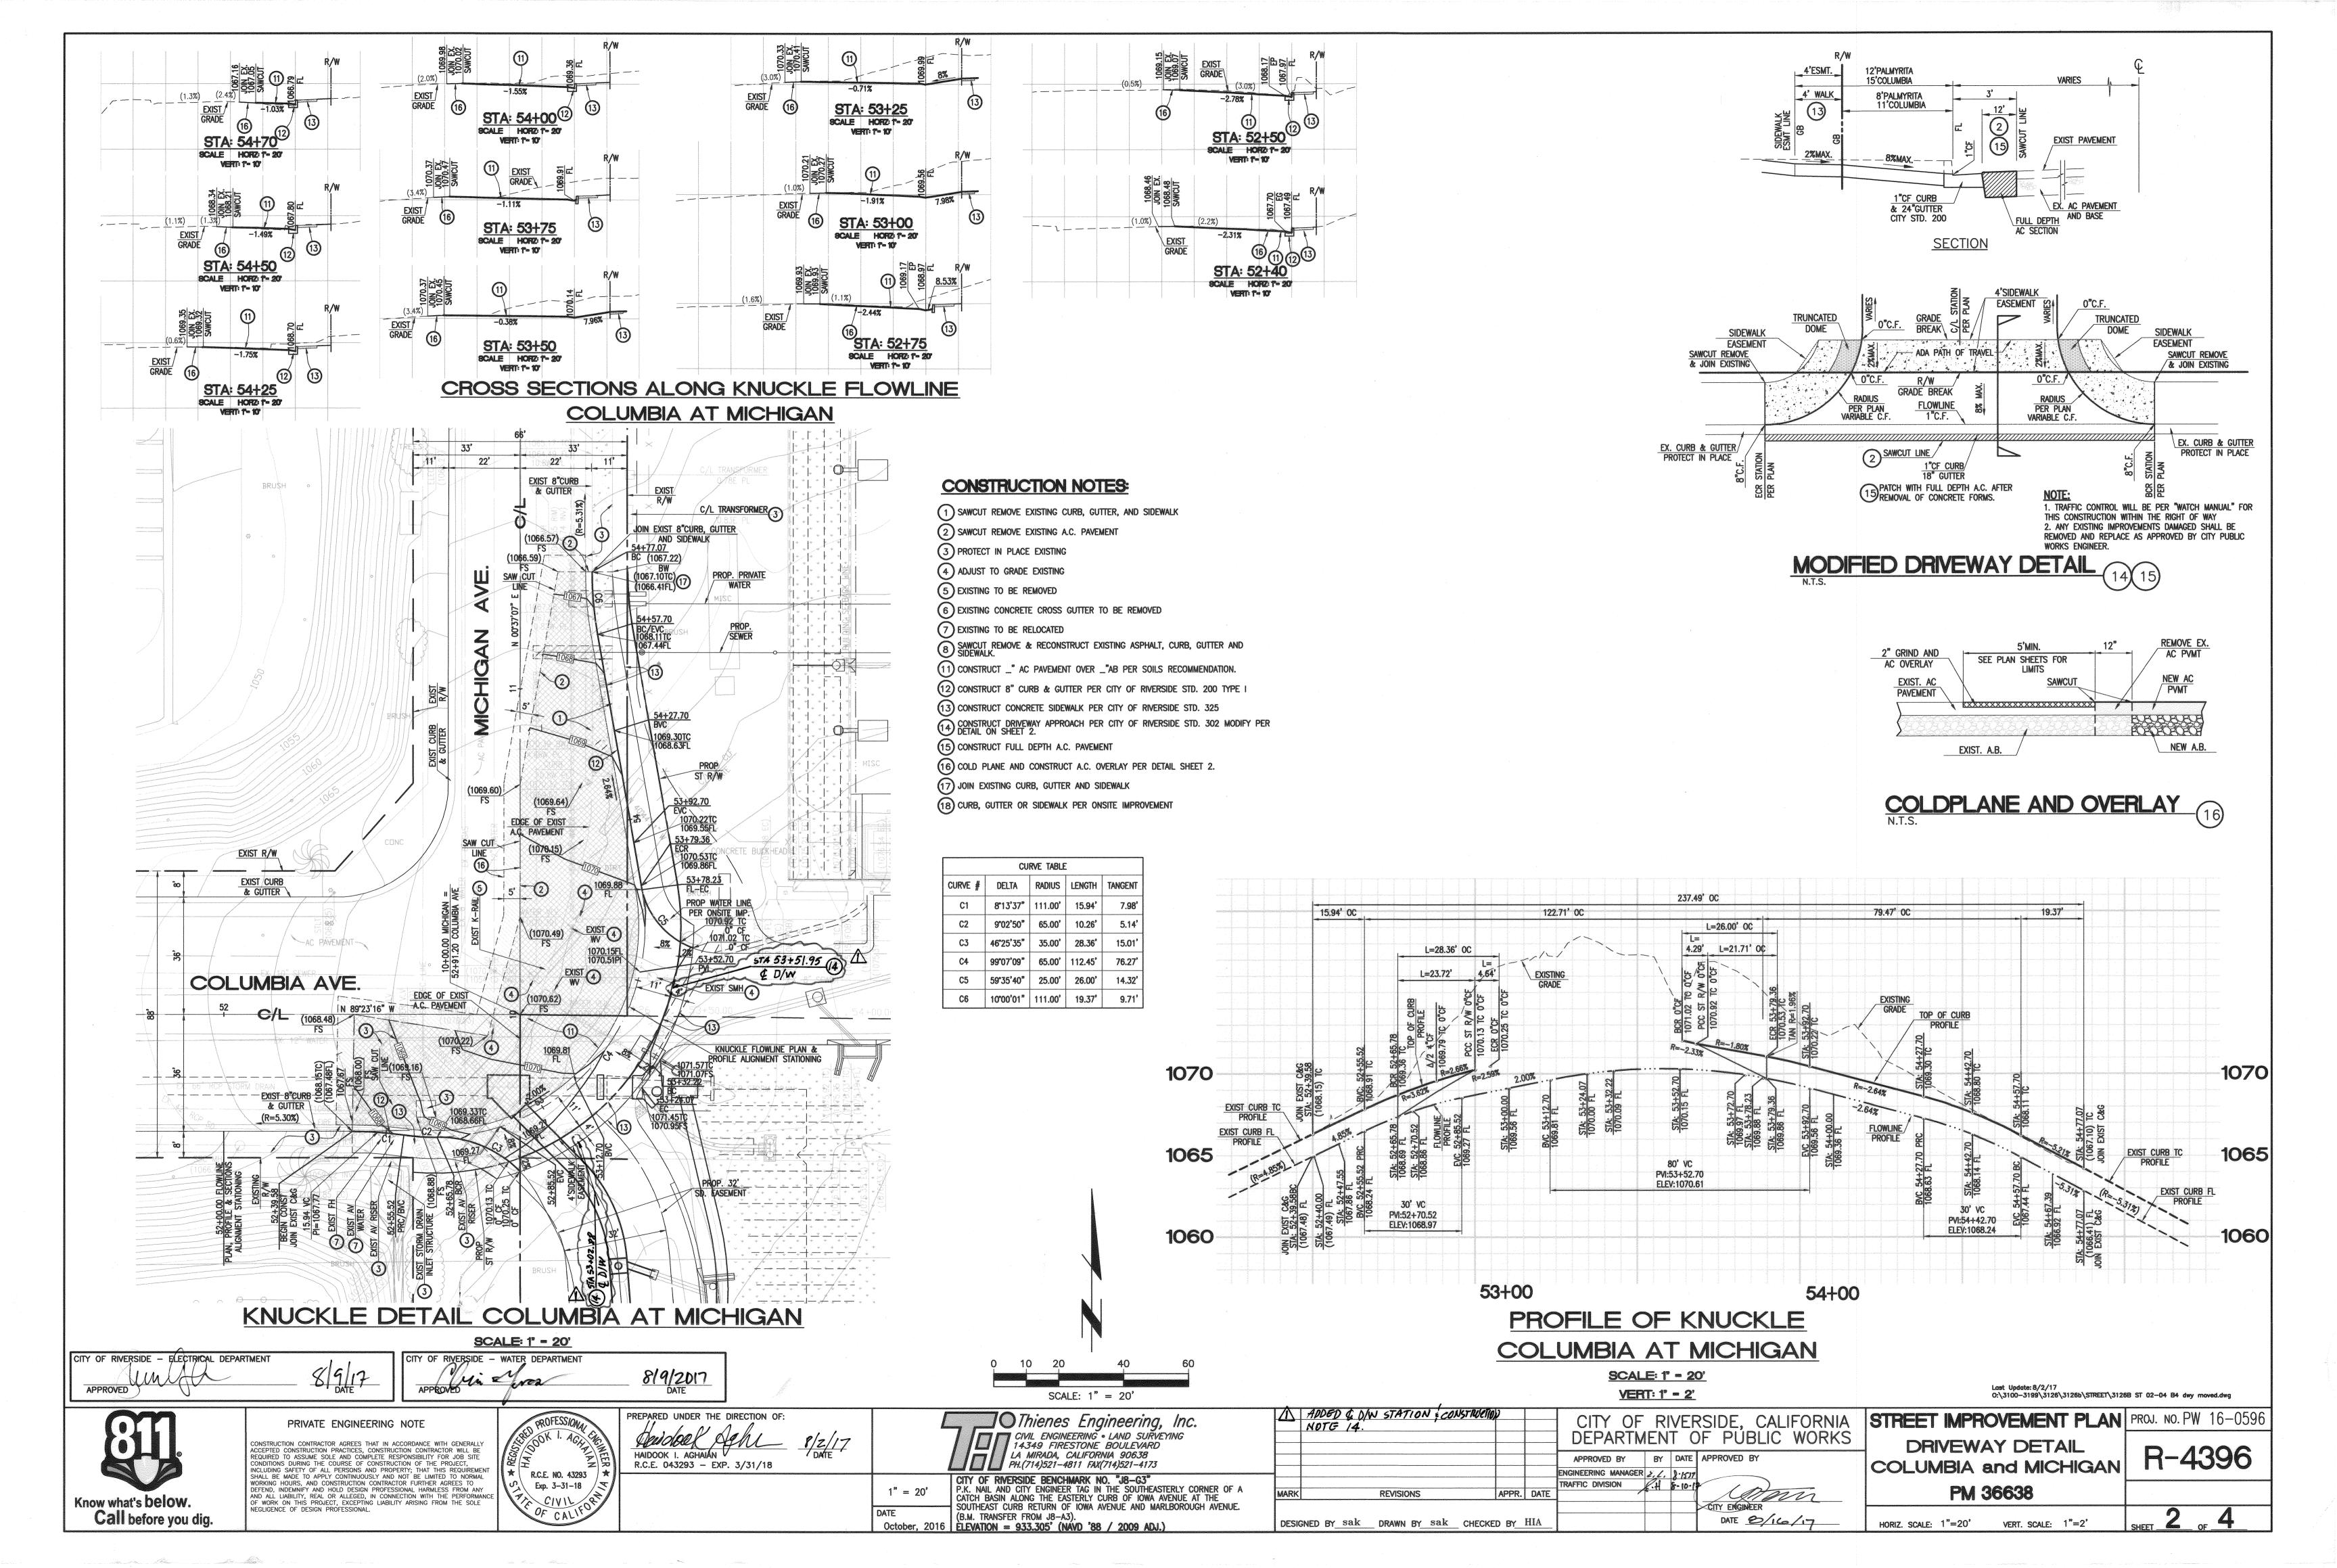

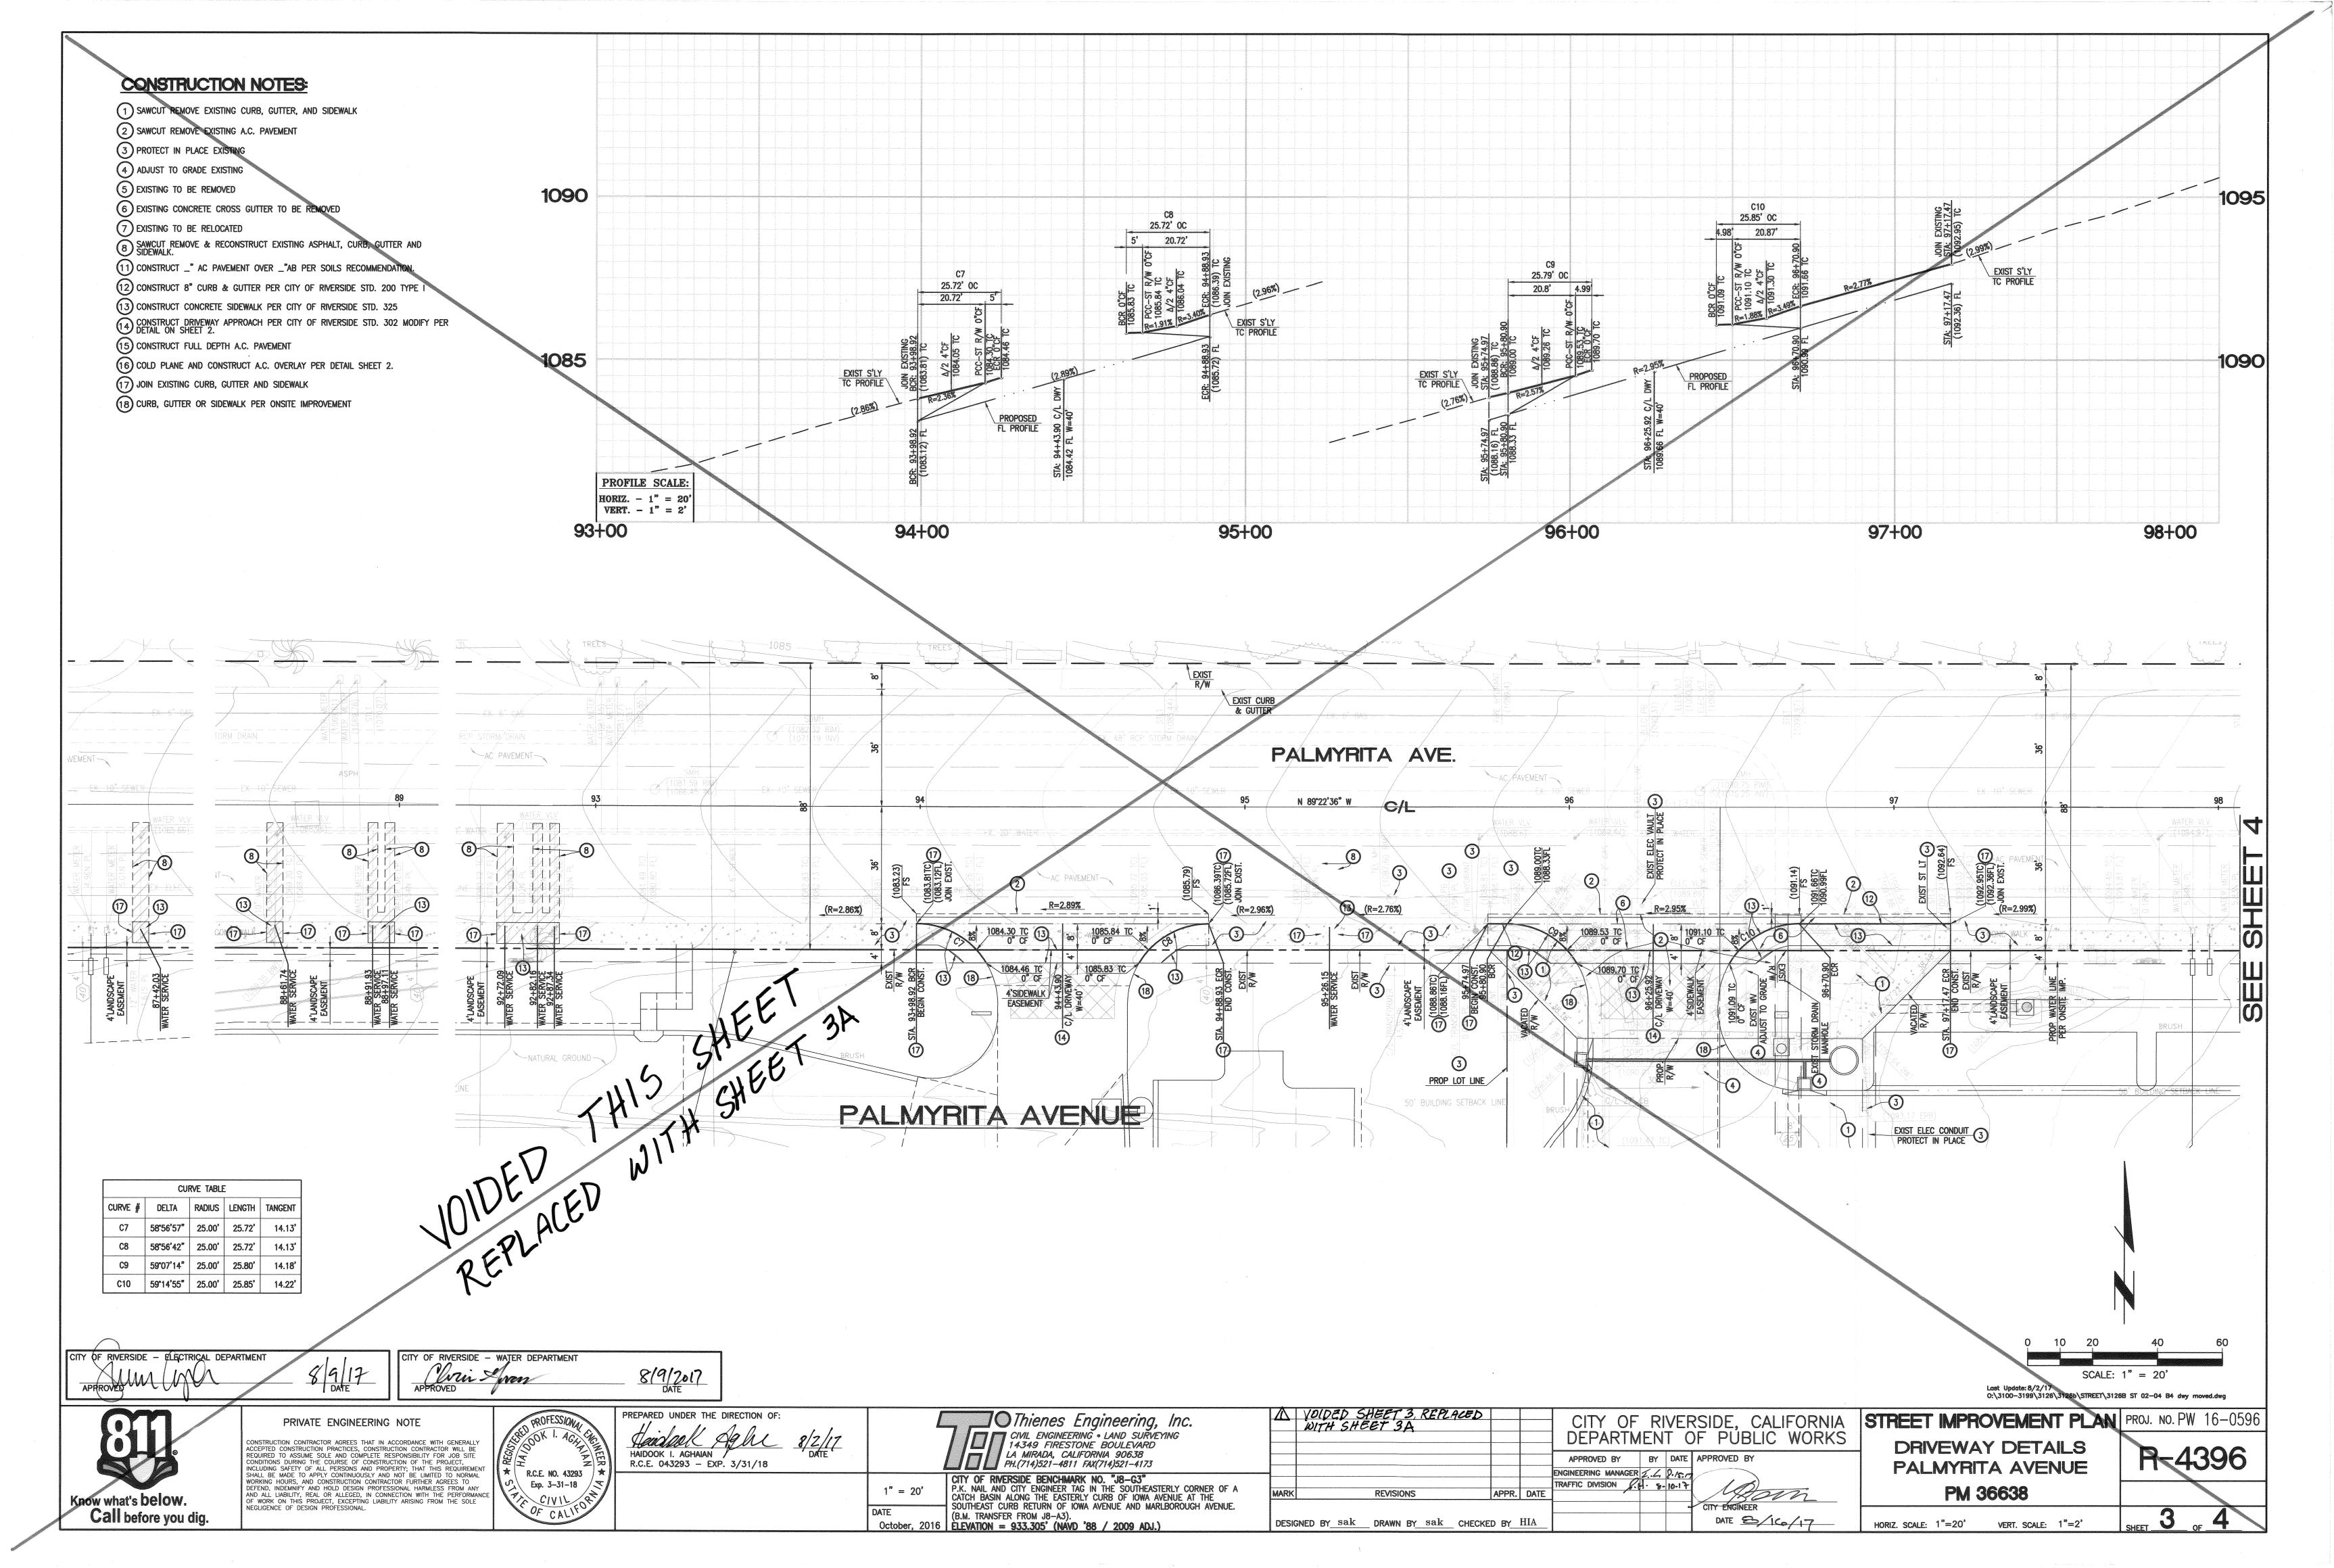

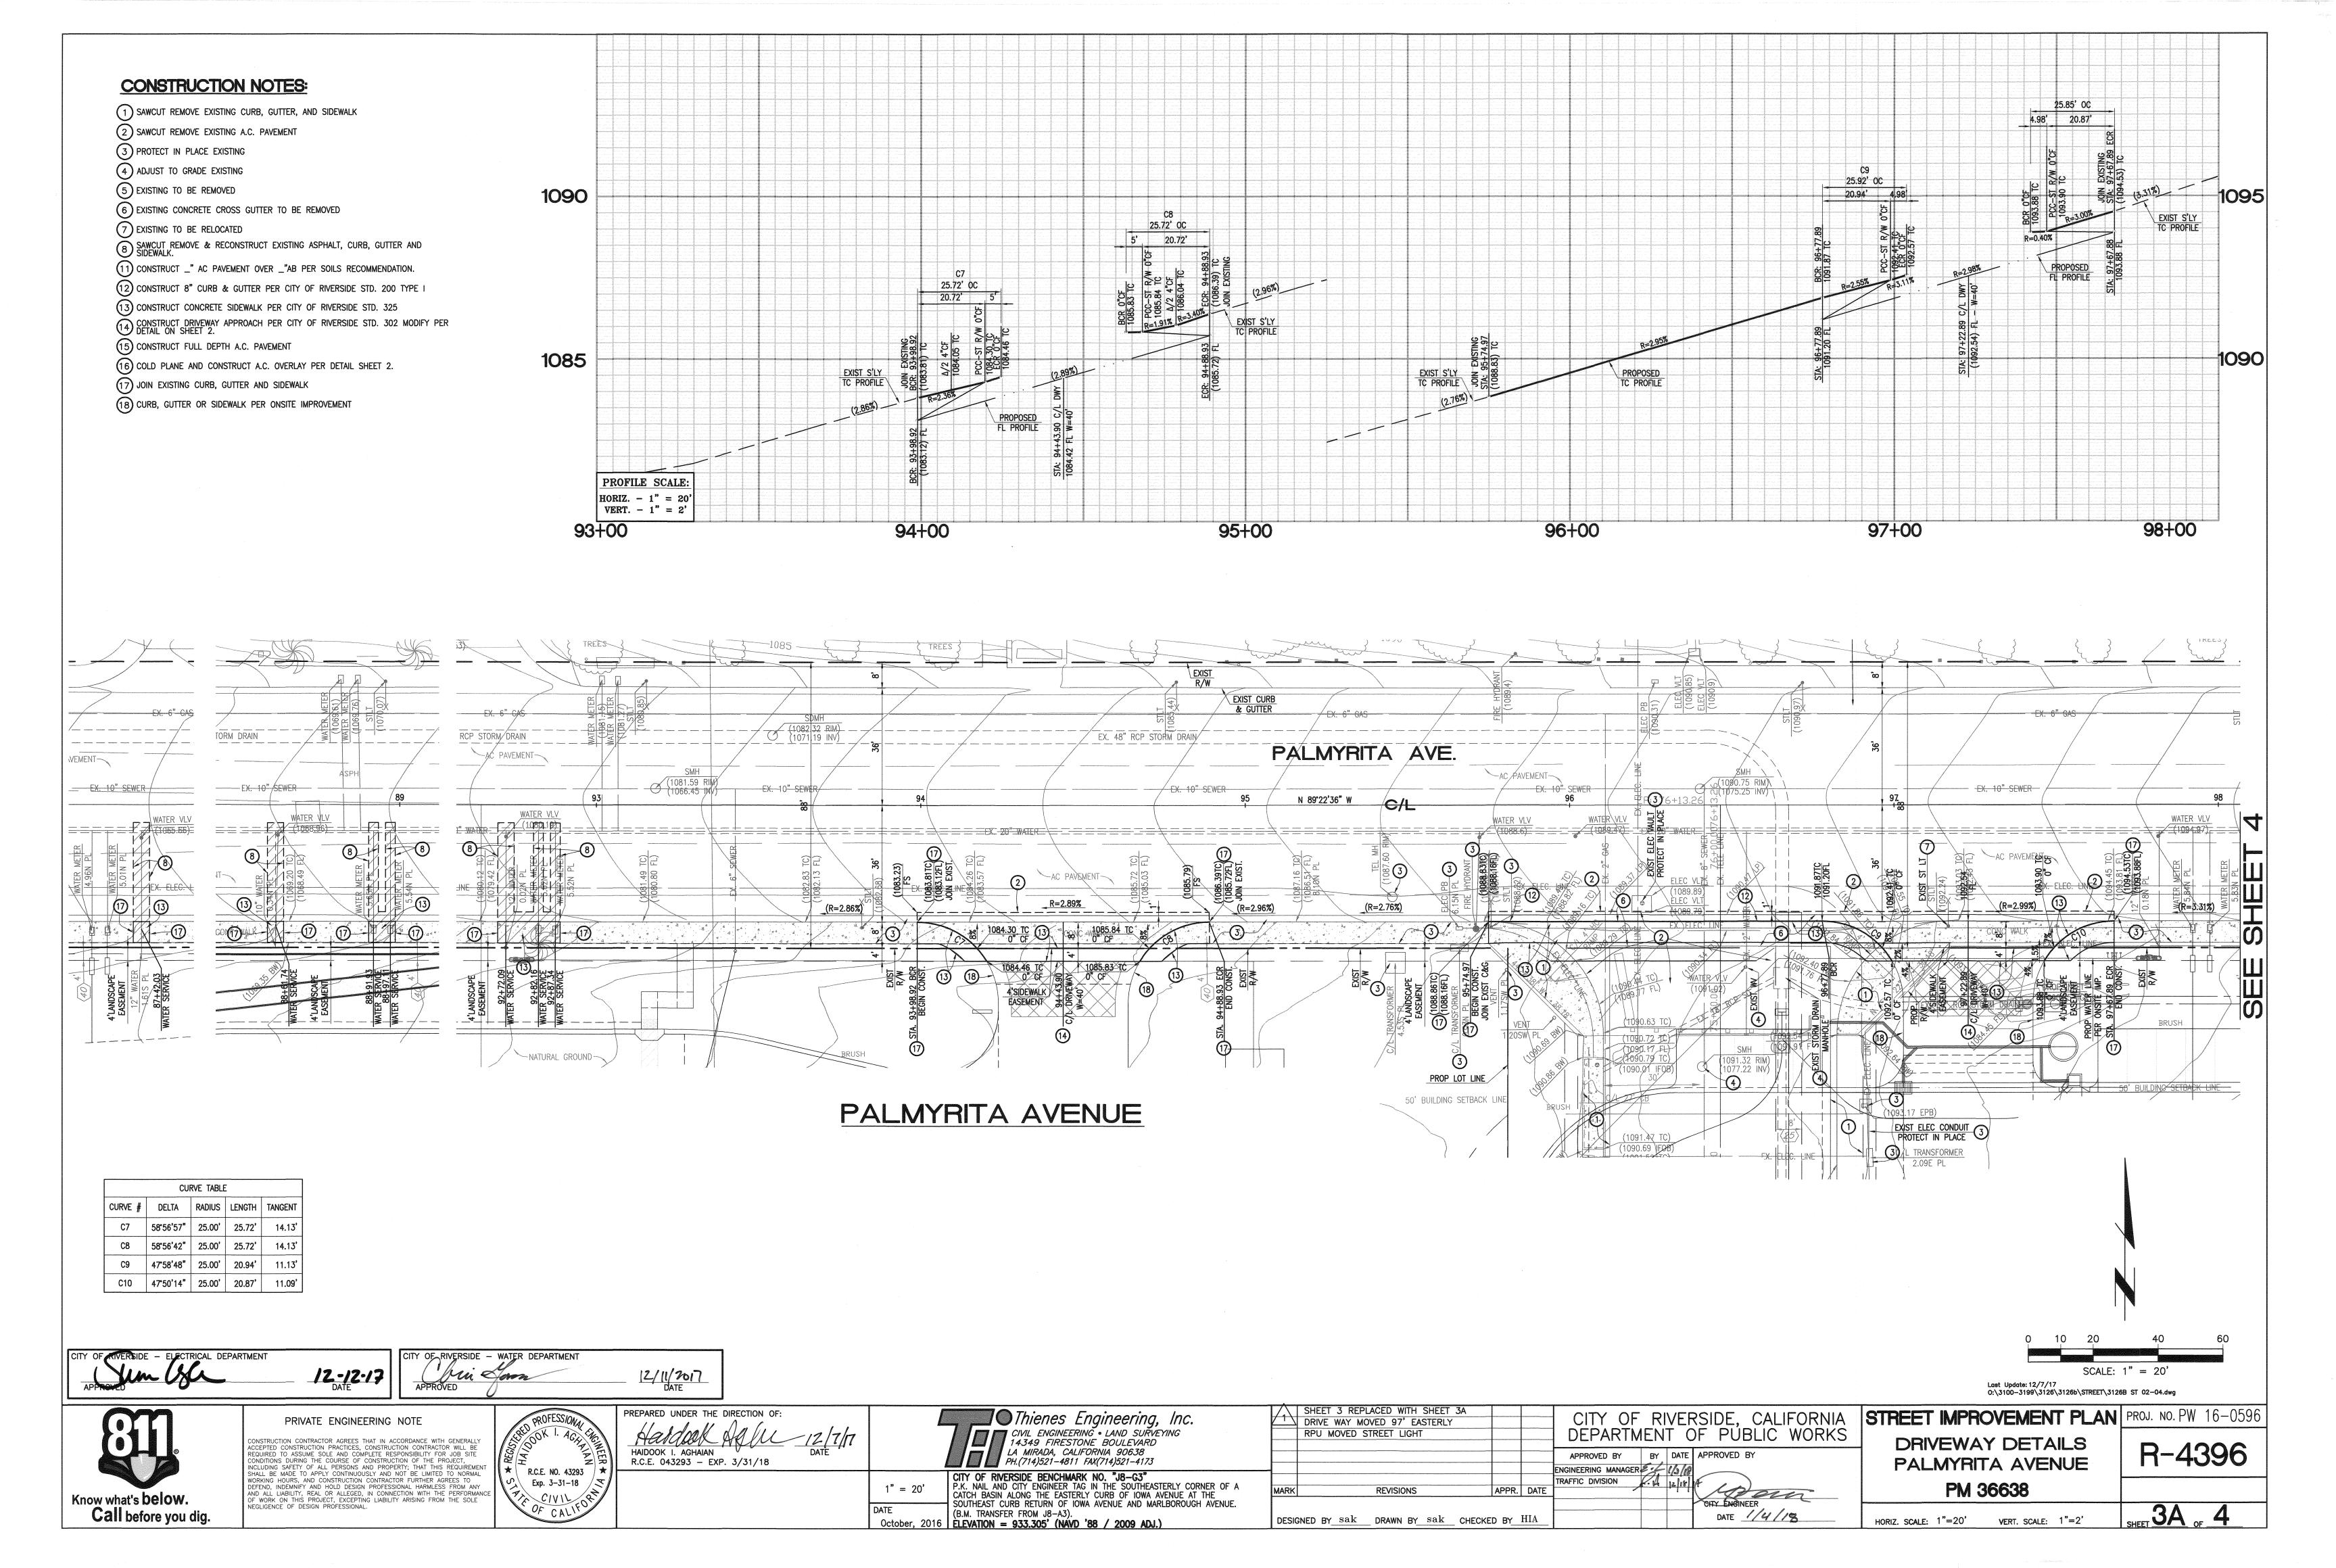

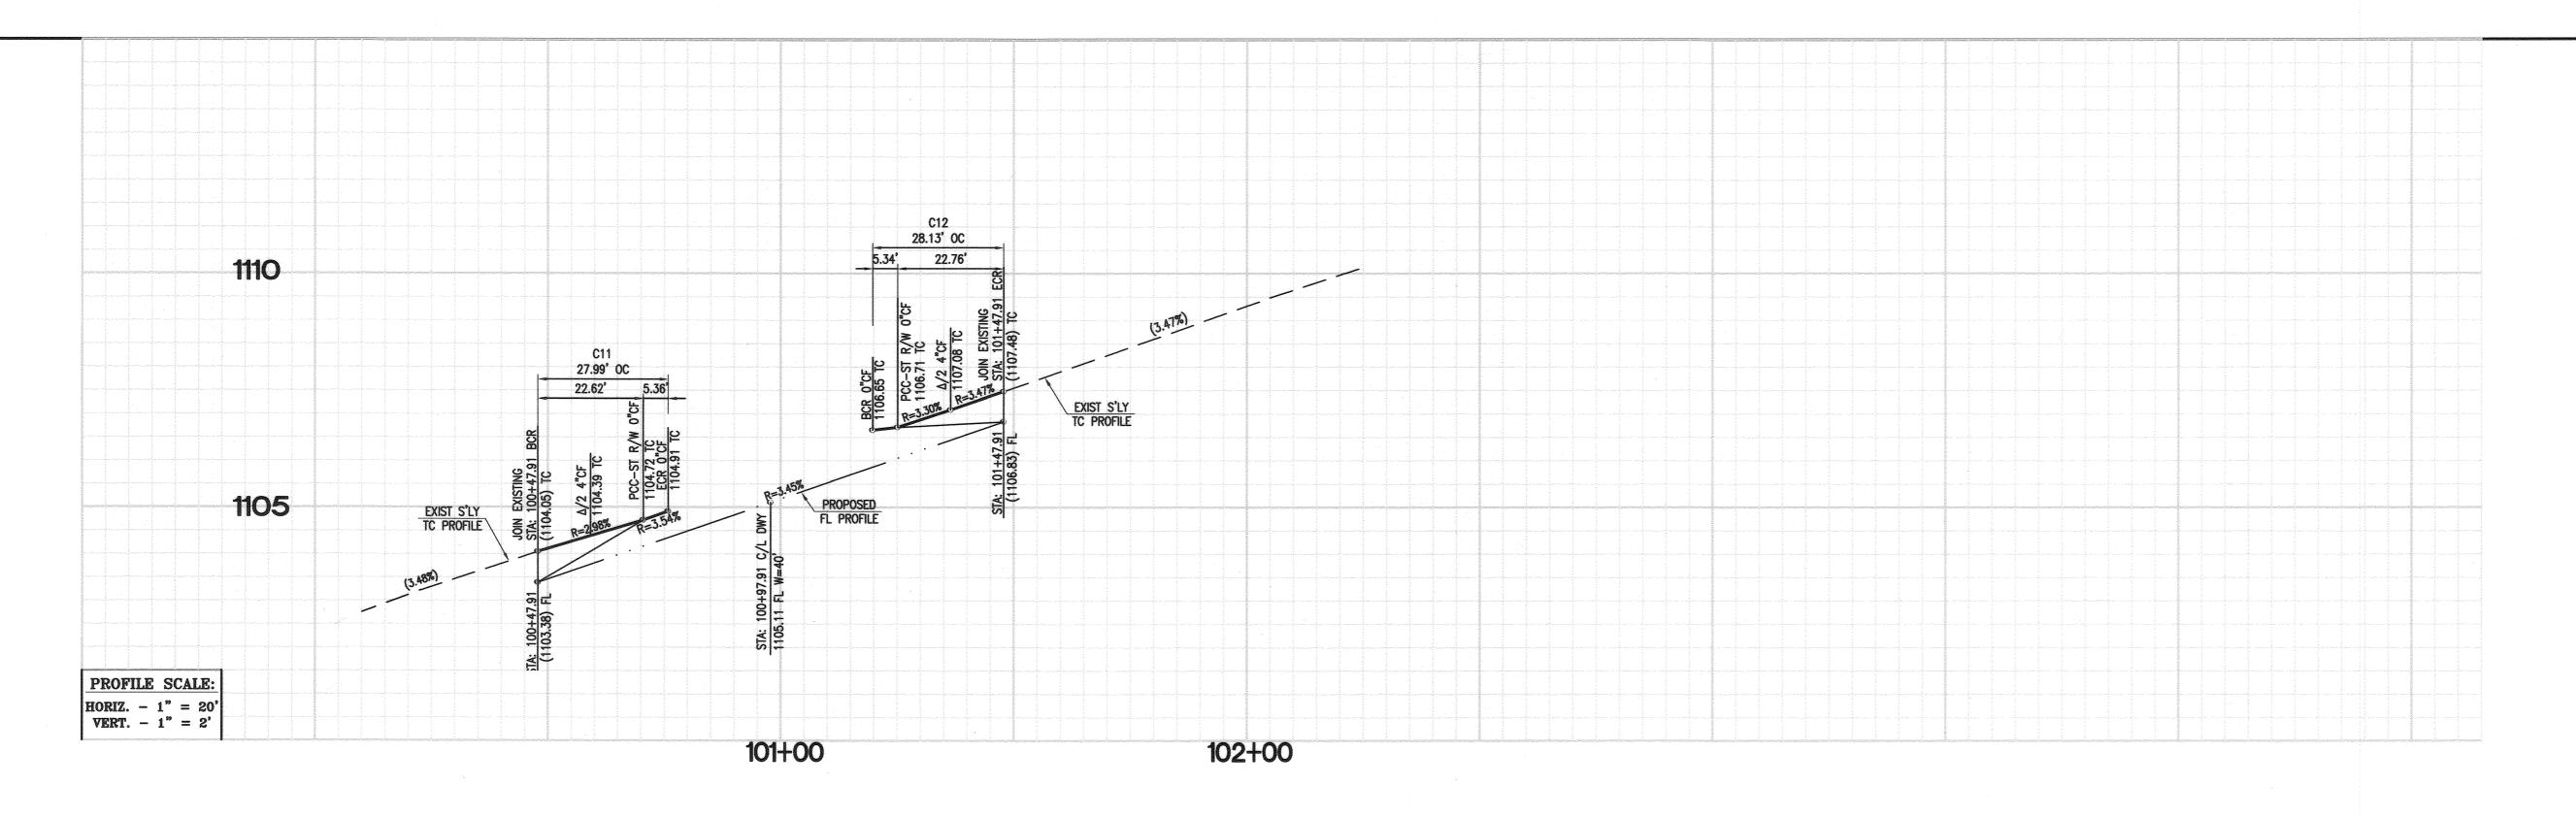

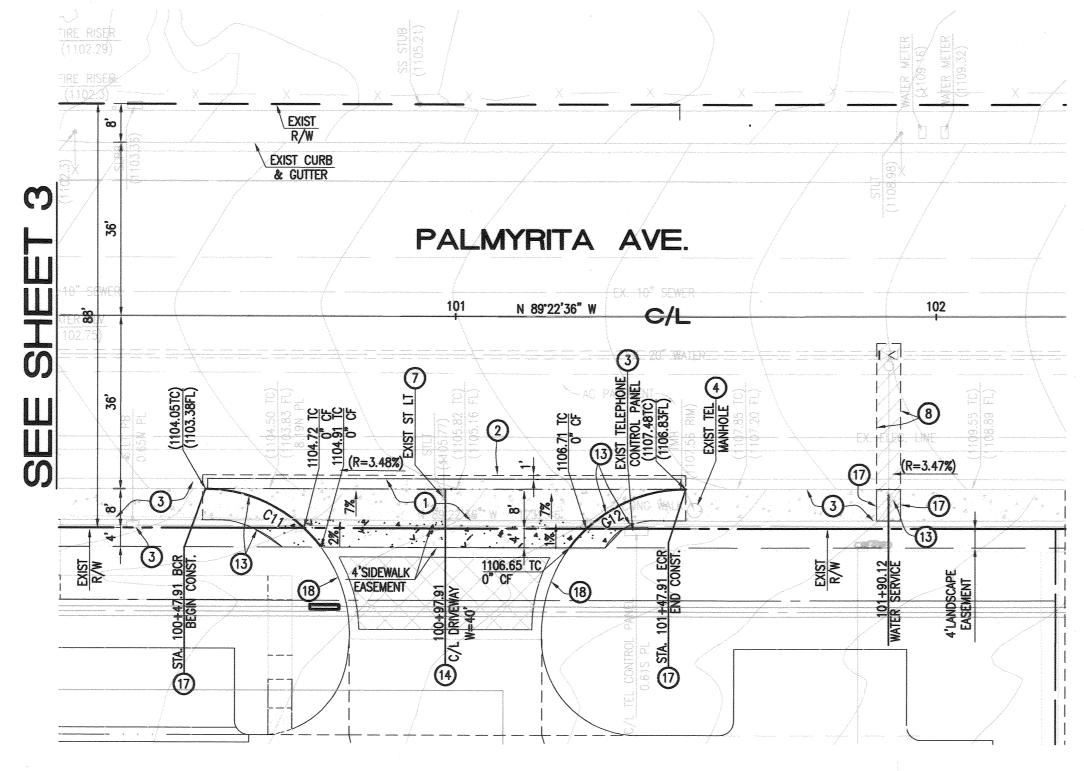

PALMYRITA AVENUE

	CURVE TABLE					
CURVE #	DELTA	RADIUS	LENGTH	TANGENT		
C11	53°26'45"	30.00	27.98'	15.10'		
C12	53°40'03"	30.00'	28.10'	15.18'		

CONSTRUCTION NOTES:

1) SAWCUT REMOVE EXISTING CURB, GUTTER, AND SIDEWALK

2 SAWCUT REMOVE EXISTING A.C. PAVEMENT

3 PROTECT IN PLACE EXISTING

4 ADJUST TO GRADE EXISTING

5 EXISTING TO BE REMOVED

6 EXISTING CONCRETE CROSS GUTTER TO BE REMOVED

7 EXISTING TO BE RELOCATED

8 SAWCUT REMOVE & RECONSTRUCT EXISTING ASPHALT, CURB, GUTTER AND SIDEWALK.

(11) CONSTRUCT _" AC PAVEMENT OVER _"AB PER SOILS RECOMMENDATION.

(12) CONSTRUCT 8" CURB & GUTTER PER CITY OF RIVERSIDE STD. 200 TYPE I

(13) CONSTRUCT CONCRETE SIDEWALK PER CITY OF RIVERSIDE STD. 325 CONSTRUCT DRIVEWAY APPROACH PER CITY OF RIVERSIDE STD. 302 MODIFY PER DETAIL ON SHEET 2.


(15) CONSTRUCT FULL DEPTH A.C. PAVEMENT


(16) COLD PLANE AND CONSTRUCT A.C. OVERLAY PER DETAIL SHEET 2.

17) JOIN EXISTING CURB, GUTTER AND SIDEWALK

18 CURB, GUTTER OR SIDEWALK PER ONSITE IMPROVEMENT



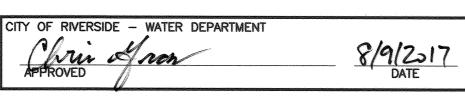

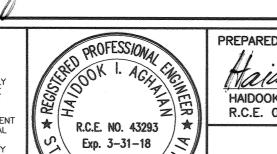

Haidsolf Aplu 8/2/17
HAIDOOK I. AGHAIAN DATE R.C.E. 043293 - EXP. 3/31/18

	Thienes Engineering, Inc. CIVIL ENGINEERING • LAND SURVEYING 14349 FIRESTONE BOULEVARD LA MIRADA, CALIFORNIA 90638 PH.(714)521-4811 FAX(714)521-4173
20'	CITY OF RIVERSIDE BENCHMARK NO. "J8-G3" P.K. NAIL AND CITY ENGINEER TAG IN THE SOUTHEASTERLY CORN

PH.(714)521-4811 FAX(714)521-4173
TY OF RIVERSIDE BENCHMARK NO. "J8-G3"
K. NAIL AND CITY ENGINEER TAG IN THE SOUTHEASTERLY CORNER OF A
ATCH BASIN ALONG THE EASTERLY CURB OF IOWA AVENUE AT THE
OUTHEAST CURB RETURN OF IOWA AVENUE AND MARLBOROUGH AVENUE.
B.M. TRANSFER FROM J8-A3).
EVATION = 933.305' (NÁVD '88 / 2009 ADJ.)

	CITY OF RIVERSIDE, CALIFORNIA DEPARTMENT OF PUBLIC WORKS						
	APPROVED BY	BY	DATE	APPROVED BY			
	ENGINEERING MANAGER	5.4	8.15.				
_	TRAFFIC DIVISION (.)	. 8-11	0-17	12			
_	/		· \	CITY ENGINEER			
	-			DATE COLOR			

0. (0100-0100 (01200 (011LE) (0120	10 31 02-04 by dwy moved.dwg
REET IMPROVEMENT PLAN	PROJ. NO. PW 16-059
DRIVEWAY DETAILS PALMYRITA AVENUE	R-4396
PM 36638	
	ΛΛ

Know what's below. Call before you dig.

PRIVATE ENGINEERING NOTE CONSTRUCTION CONTRACTOR AGREES THAT IN ACCORDANCE WITH GENERALLY ACCEPTED CONSTRUCTION PRACTICES, CONSTRUCTION CONTRACTOR WILL BE REQUIRED TO ASSUME SOLE AND COMPLETE RESPONSIBILITY FOR JOB SITE CONDITIONS DURING THE COURSE OF CONSTRUCTION OF THE PROJECT, INCLUDING SAFETY OF ALL PERSONS AND PROPERTY; THAT THIS REQUIREMENT SHALL BE MADE TO APPLY CONTINUOUSLY AND NOT BE LIMITED TO NORMAL WORKING HOURS, AND CONSTRUCTION CONTRACTOR FURTHER AGREES TO DEFEND, INDEMNIFY AND HOLD DESIGN PROFESSIONAL HARMLESS FROM ANY AND ALL LIABILITY, REAL OR ALLEGED, IN CONNECTION WITH THE PERFORMANCE OF WORK ON THIS PROJECT, EXCEPTING LIABILITY ARISING FROM THE SOLE NEGLIGENCE OF DESIGN PROFESSIONAL.

DESIGNED BY sak DRAWN BY sak CHECKED BY HIA

REVISIONS

DATE 8/16/17

HORIZ. SCALE: 1"=20' VERT. SCALE: 1"=2'